



**MIAMI-DADE COUNTY**  
**BUILDING CODE COMPLIANCE OFFICE (BCCO)**  
**PRODUCT CONTROL DIVISION**

**MIAMI-DADE COUNTY, FLORIDA**  
**METRO-DADE FLAGLER BUILDING**  
**140 WEST FLAGLER STREET, SUITE 1603**  
**MIAMI, FLORIDA 33130-1563**  
 (305) 375-2901 FAX (305) 372-6339

**NOTICE OF ACCEPTANCE (NOA)**

[www.miamidade.gov/buildingcode](http://www.miamidade.gov/buildingcode)

**Pottorff Division of PCI Industries**  
**5101 Blue Mound Road**  
**Fort Worth, TX 76106**

**SCOPE:**

This NOA is being issued under the applicable rules and regulations governing the use of construction materials. The documentation submitted has been reviewed by Miami-Dade County Product Control Division and accepted by the Board of Rules and Appeals (BORA) to be used in Miami Dade County and other areas where allowed by the Authority Having Jurisdiction (AHJ).

This NOA shall not be valid after the expiration date stated below. The Miami-Dade County Product Control Division (In Miami Dade County) and/or the AHJ (in areas other than Miami Dade County) reserve the right to have this product or material tested for quality assurance purposes. If this product or material fails to perform in the accepted manner, the manufacturer will incur the expense of such testing and the AHJ may immediately revoke, modify, or suspend the use of such product or material within their jurisdiction. BORA reserves the right to revoke this acceptance, if it is determined by Miami-Dade County Product Control Division that this product or material fails to meet the requirements of the applicable building code.

This product is approved as described herein, and has been designed to comply with the Florida Building Code, including the High Velocity Hurricane Zone.

**DESCRIPTION: Model EFD-637-MD Aluminum Louver**

**APPROVAL DOCUMENT:** Drawing No. DC-C1, E1 and D1 to D6, titled "Dade County", dated 02/23/04, prepared by Pottorff, signed and sealed by Frank A. Cleaton, Jr., P.E., bearing the Miami-Dade County Product Control renewal stamp with the Notice of Acceptance number and expiration date by the Miami-Dade County Product Control Division.

**MISSILE IMPACT RATING: Large and Small Missile Impact Resistant.**

**LABELING:** Each unit shall bear a permanent label with the manufacturer's name or logo, city, state and following statement: "Miami-Dade County Product Control Approved", unless otherwise noted herein.

**RENEWAL** of this NOA shall be considered after a renewal application has been filed and there has been no change in the applicable building code negatively affecting the performance of this product.

**TERMINATION** of this NOA will occur after the expiration date or if there has been a revision or change in the materials, use, and/or manufacture of the product or process. Misuse of this NOA as an endorsement of any product, for sales, advertising or any other purposes shall automatically terminate this NOA. Failure to comply with any section of this NOA shall be cause for termination and removal of NOA.

**ADVERTISEMENT:** The NOA number preceded by the words Miami-Dade County, Florida, and followed by the expiration date may be displayed in advertising literature. If any portion of the NOA is displayed, then it shall be done in its entirety.

**INSPECTION:** A copy of this entire NOA shall be provided to the user by the manufacturer or its distributors and shall be available for inspection at the job site at the request of the Building Official.

This NOA **renews NOA # 04-0909.01** and consists of this page 1 and evidence page E-1, as well as approval document mentioned above.

The submitted documentation was reviewed by **Carlos M. Utrera, P.E.**



*[Handwritten Signature]*  
 10/19/09

**NOA No. 09-1007.01**  
**Expiration Date: February 19, 2014**  
**Approval Date: November 12, 2009**  
 Page 1

**NOTICE OF ACCEPTANCE: EVIDENCE SUBMITTED**

**A. DRAWINGS**

1. Drawing No. **DC-C1, E1 and D1 to D6**, titled "Dade County", dated 02/23/04, prepared by Pottorff, signed and sealed by Frank A. Cleaton, Jr., P.E.  
**"Submitted under NOA # 03-0925.05"**

**B. TESTS**

1. Test report on Large Missile Impact Test per PA 201, Test, Cyclic Wind Pressure Test per PA 203, Test and Uniform Static Air Pressure Test per PA 202 of "Model 637-EDT-HD Louver", prepared by Architectural Testing Inc, Report No. **01-40871.01**, dated 09/11/02, signed and sealed by A. N. Reeves, P.E.
2. Clarification letter issued by Architectural Testing Inc, on 05/27/03, signed by J. A. Reed, P.E.  
**"Submitted under NOA # 03-0925.05"**

**C. CALCULATIONS**

1. Structural Analysis prepared by Pottorff, dated 08/08/02, pages 1 to 16, signed and sealed by Chander P. Nangia, P.E.  
**"Submitted under NOA # 03-0925.05"**

**D. QUALITY ASSURANCE**

1. Miami Dade Building Code Compliance Office (BCCO).

**E. MATERIAL CERTIFICATIONS**

1. None.

**F. STATEMENTS**


1. Still in business letter issued by Davis & Cleaton Engineering, Inc., dated 09/10/09, signed by Frank A. Cleaton, Jr., P.E.
2. No change letter issued by Pottorff, dated 10/01/09, signed by Brian Redford.
3. Test compliance letter issued by Architectural Testing, Inc., on 09/12/02, signed and sealed by A. N. Reeves, P.E.  
**"Submitted under NOA # 03-0925.05"**



**Carlos M. Utrera, P.E.**  
**Product Control Examiner**  
**NOA No. 09-1007.01**

**Expiration Date: February 19, 2014**  
**Approval Date: November 12, 2009**



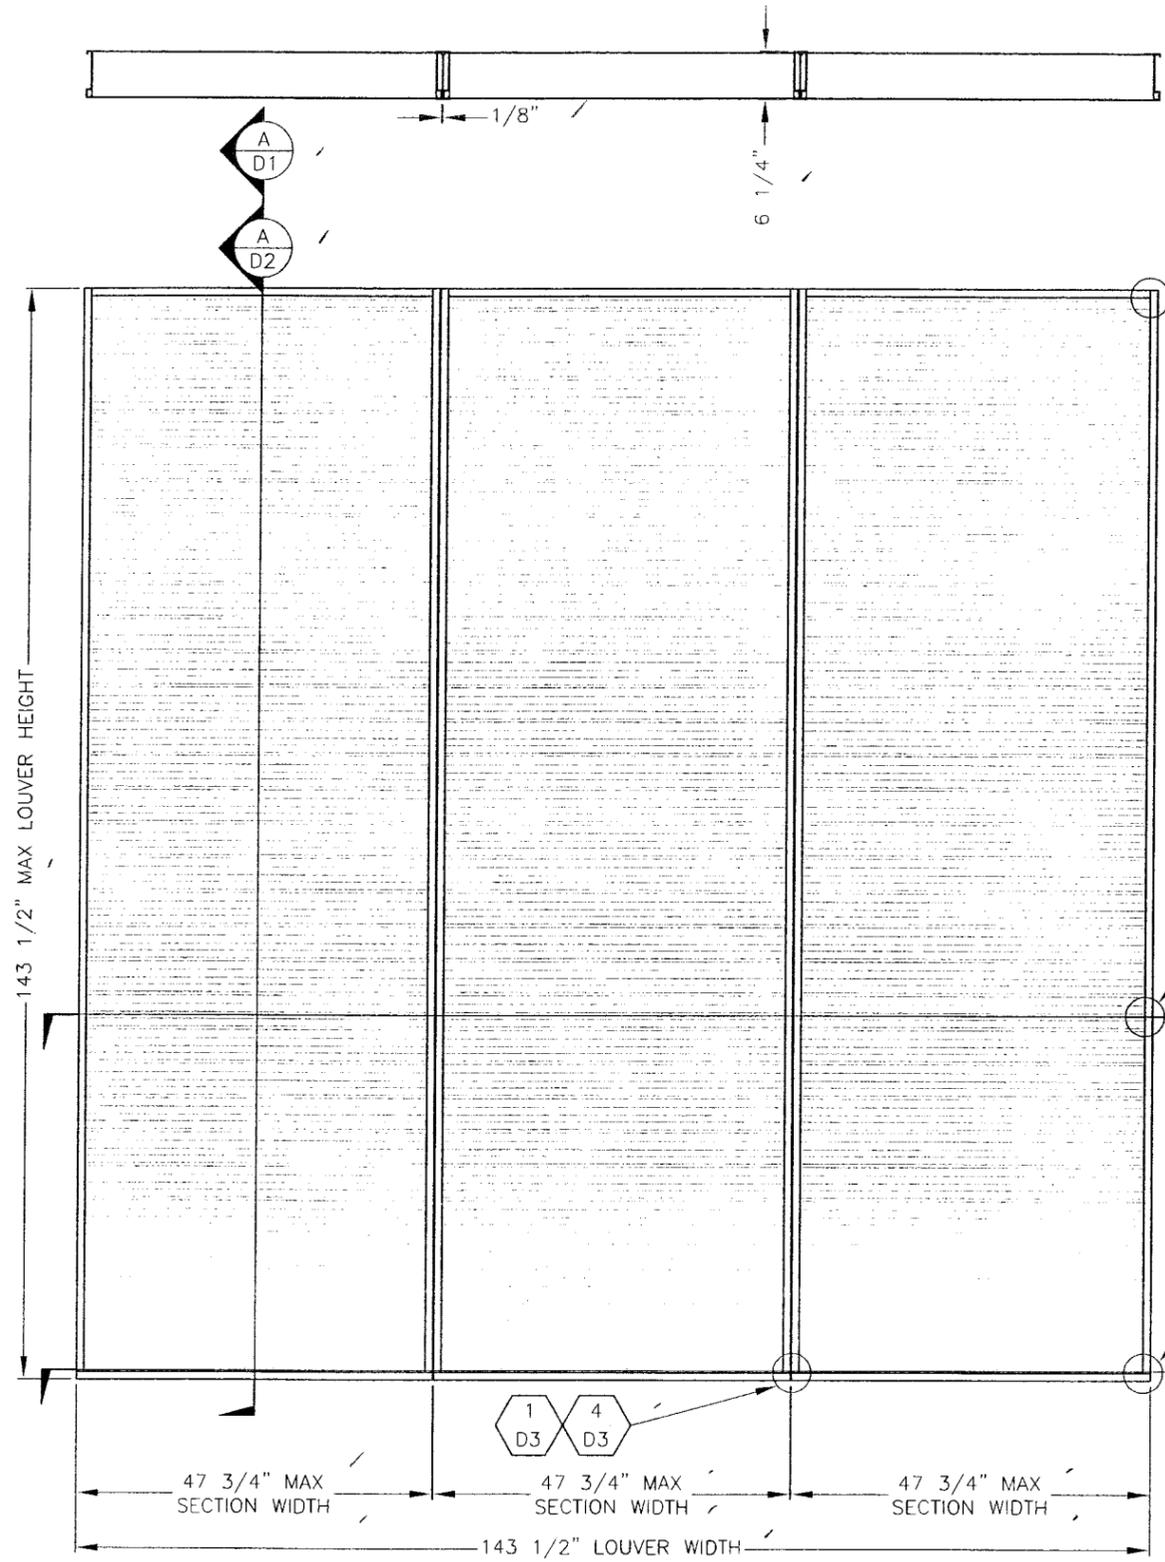

EXTERIOR ELEVATION


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FILE: C:\JOBS\DADE CO GEN SUB\POTTORFF DADE COUNTY REV B


REV NO.	DESCRIPTION	DATE	DRAWN BY

NOTE: A LOUVERED OPENING MAY BE UNLIMITED IN WIDTH, BEING MADE UP OF MULTIPLE SECTIONS, PROVIDED THAT EACH SECTION DOES NOT EXCEED 47 3/4" IN WIDTH AND 143 1/2" IN HEIGHT.

*[Handwritten Signature]*  
2/27/04

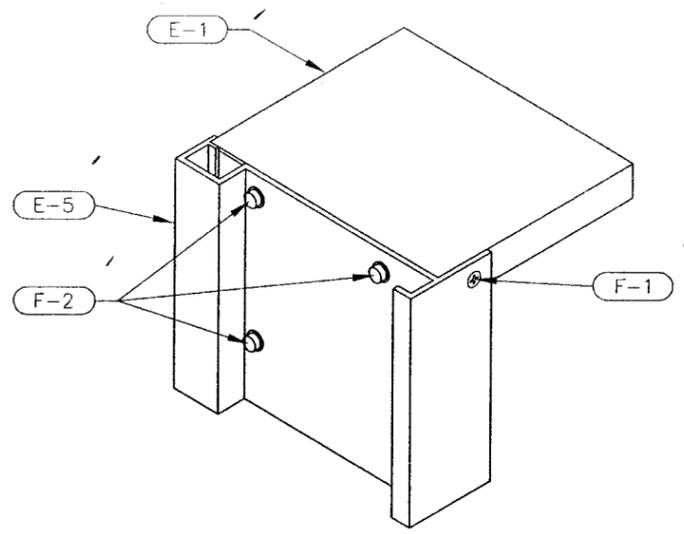

LOUVER CORNER DETAIL (TYP BOTH ENDS) 1 JAMB TOP, HEAD, AND DRIP CONNECTION  
3"=1' E1 E1

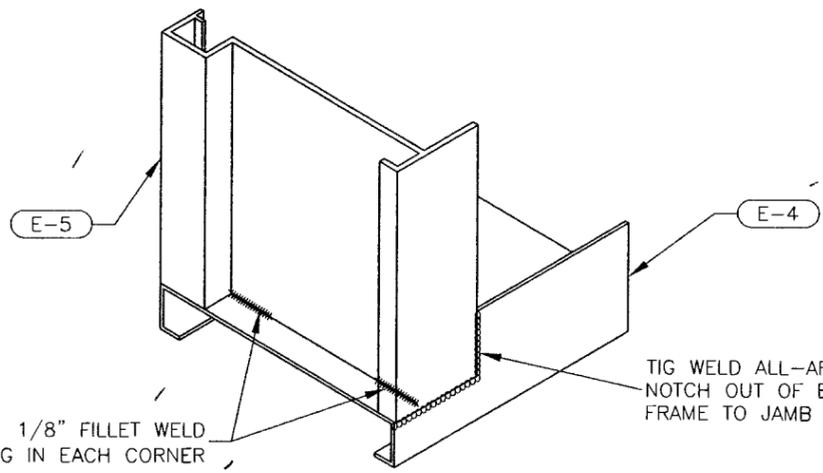


LOUVER CORNER DETAIL (TYP BOTH ENDS) 2 JAMB BOTTOM AND SILL CONNECTION  
3"=1' E1 E1


**PRODUCT RENEWED**  
as complying with the Florida Building Code  
Acceptance No 07-1007.01  
Expiration Date 02/17/2014  
By *[Signature]*  
Miami Dade Product Control Division

04-0909.01  
04-0909.01  
*[Signature]*


<b>POTTORFF</b>		2824 North Sylvania Avenue Fort Worth, Texas 76111 Phone: 817-831-7038 Fax: 817-831-3110		
DRAWING DESC.: ELEVATION				
PROJECT: DADE COUNTY				
LOCATION:				
ARCHITECT:				
CUSTOMER:				
DATE: 2/23/04	DWN BY: DSR	POTTORFF ORDER NO.	CUSTOMER P.O. NO.	DRAWING NO.
SCALE: NOTED	SHEET: 2 of 8			DC-E1

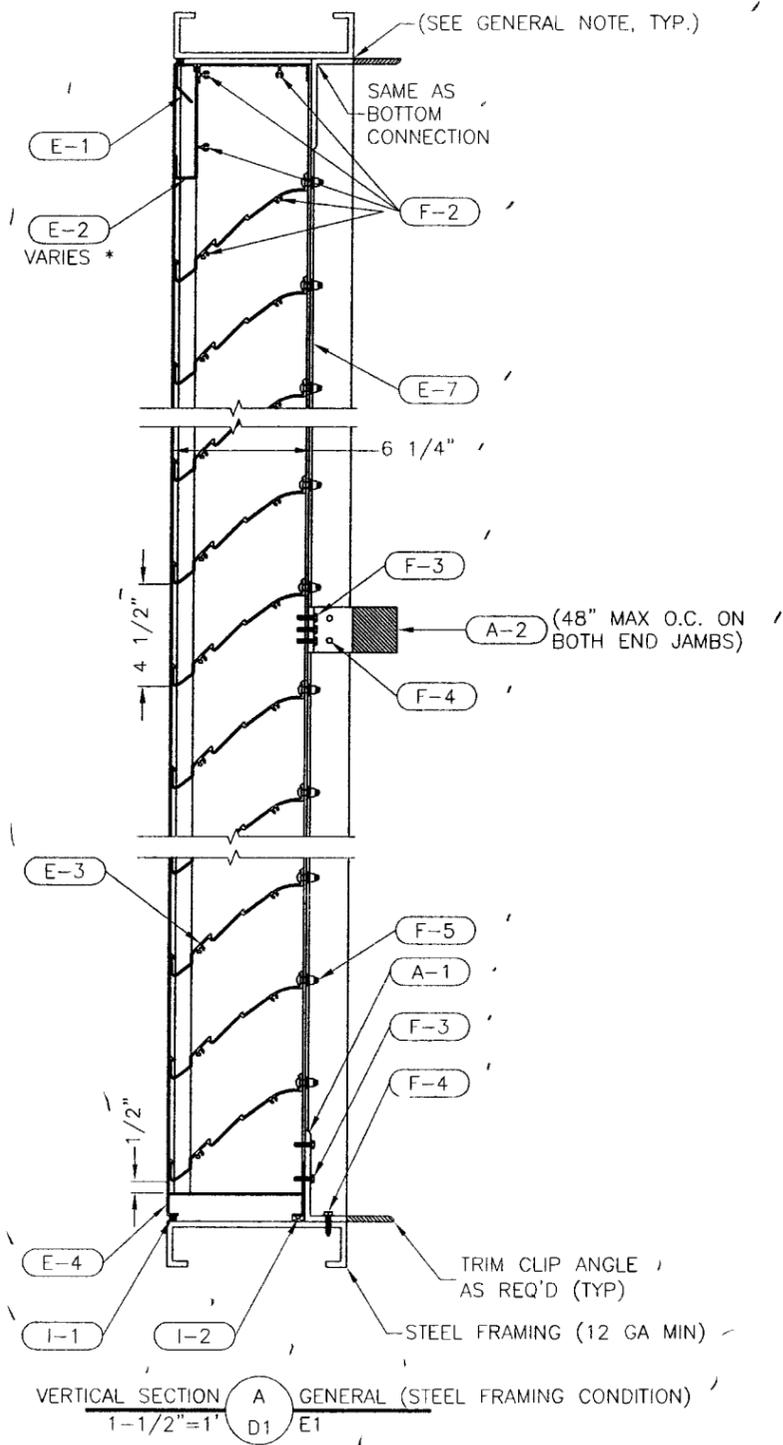

VERTICAL SECTION **A** GENERAL (STEEL FRAMING CONDITION)  
1-1/2"=1' D1 E1

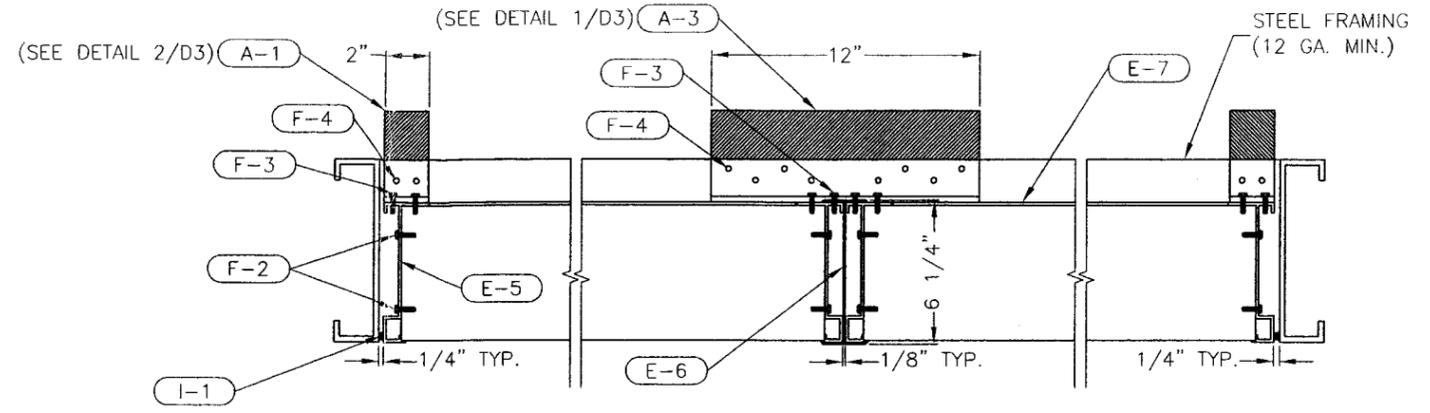

PLAN VIEW - HORIZONTAL SECTION **B** GENERAL (STEEL FRAMING CONDITION)  
1-1/2"=1' D1 E1

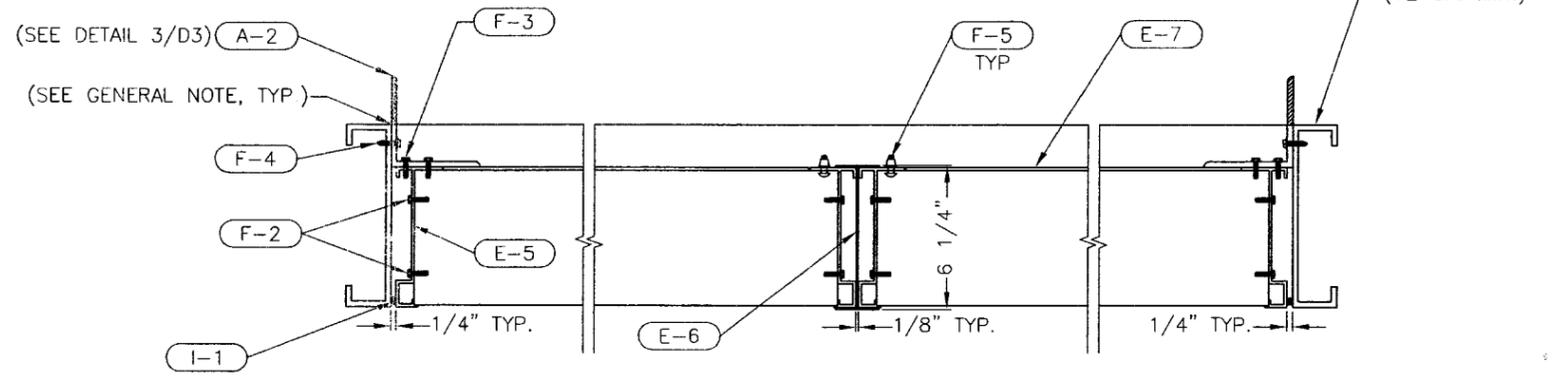

INTERMEDIATE JAMB CLIPS - HORIZONTAL SECTION **C** GENERAL (STEEL FRAMING CONDITION)  
1-1/2"=1' D1 E1 (BOTTOM CLIP ANGLES REMOVED FOR CLARITY)

**E-2 \* NOTE:**  
E-2 VARIES IN HEIGHT FROM 2-3/16" TO 5-3/8" DEPENDING ON THE SECTION HEIGHT.

**GENERAL NOTE:**  
INSTALLER TO PROVIDE GASKET MATERIAL BETWEEN DISSIMILAR MATERIALS FOR SEPARATION.

**PRODUCT RENEWED**  
as complying with the Florida Building Code  
Acceptance No. 07-1007.01  
Expiration Date 02/19/2014  
By [Signature]  
Miami Dade Product Control Division


Approved by [Signature]  
Date 10/21/04  
Phone 09-0409.67  
Division [Signature]

<b>POTTORFF</b>		2824 North Sylvania Avenue Fort Worth, Texas 76111 Phone: 817-831-7038 Fax: 817-831-3110		
DRAWING DESC.: DETAILS / SECTIONS				
PROJECT: DADE COUNTY				
LOCATION:				
ARCHITECT:				
CUSTOMER:				
DATE: 2/23/04	DWN BY: DSR	POTTORFF ORDER NO.	CUSTOMER P.O. NO.	DRAWING NO.
SCALE: NOTED	SHEET: 3 of 8			DC-D1


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REV	NO	DESCRIPTION	DATE	DRAWN BY


*[Handwritten Signature]*  
10/21/04

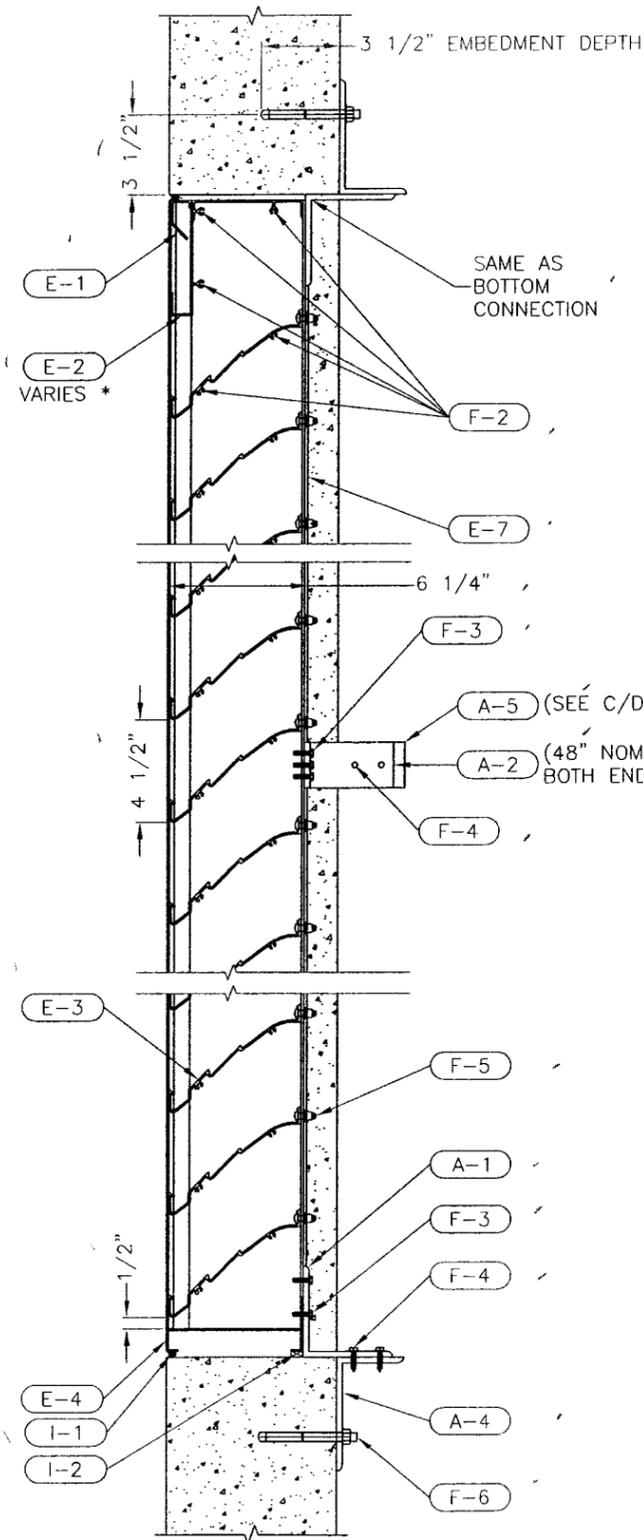

VERTICAL SECTION **A** GENERAL [SEE NOTE 1]  
1-1/2"=1" D2 E1

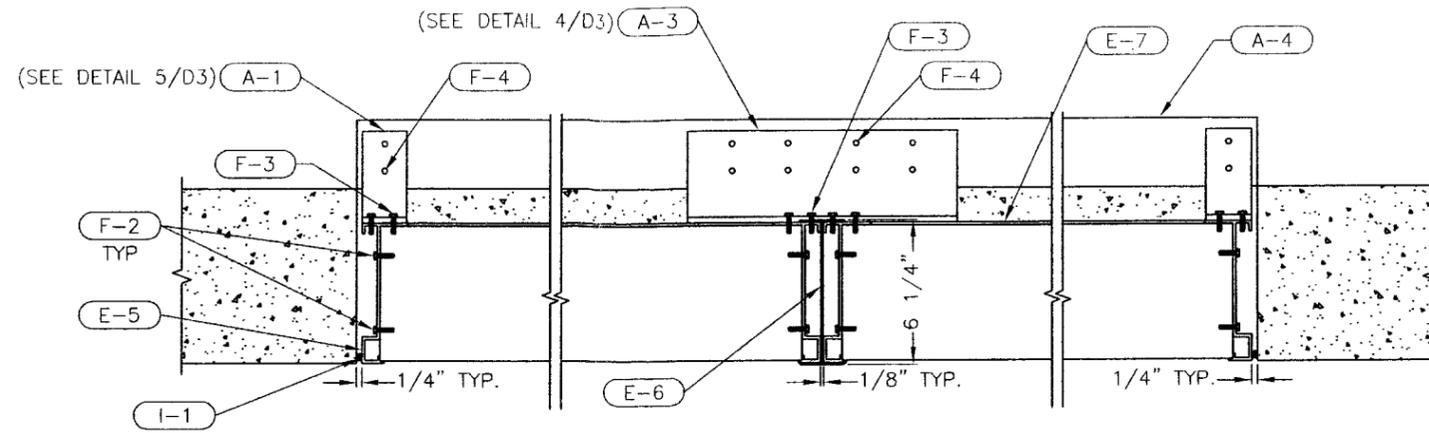

PLAN VIEW - HORIZONTAL SECTION **B** GENERAL [SEE NOTE 1]  
1-1/2"=1" D2 E1

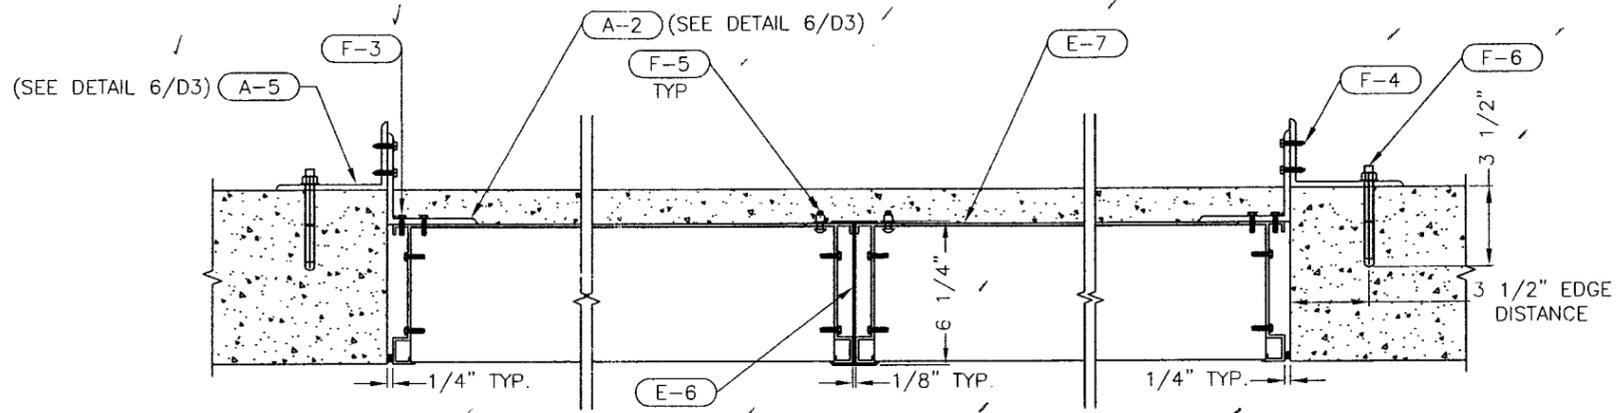

INTERMEDIATE JAMB CLIPS - HORIZONTAL SECTION **C** GENERAL [SEE NOTE 1]  
1-1/2"=1" D2 E1 (BOTTOM CLIP ANGLES AND SHELF ANGLE REMOVED FOR CLARITY)

**CONDITION NOTE:**  
1: THIS CONDITION MAY BE ONE OF THE FOLLOWING:  
A: 8" SOLIDLY GROUTED BOND BEAM BLOCKS - REINFORCED (GROUT STRENGTH 4000 PSI)  
B: SOLID CONCRETE (2000 PSI)  
1. PRE-CAST CONCRETE  
2. CAST-IN-PLACE CONCRETE

**E-2 \* NOTE:**  
E-2 VARIES IN HEIGHT FROM 2-3/16" TO 5-3/8" DEPENDING ON THE SECTION HEIGHT.

**GENERAL NOTE:**  
INSTALLER TO PROVIDE GASKET MATERIAL BETWEEN DISSIMILAR MATERIALS FOR SEPARATION.

**PRODUCT RENEWED**  
as complying with the Florida Building Code  
Acceptance No. 09-1007.01  
Expiration Date 02/19/2014  
By: [Signature]  
Miami Dade Product Control Division


Approved as complying with the Florida Building Code  
Date: 10/21/09  
04-0904.01  
Miami Dade Product Control Division

*[Handwritten Signature]*  
2/27/04


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REV. NO.	DESCRIPTION	DATE	DRAWN BY

<b>POTTORFF</b>		2824 North Sylvania Avenue Fort Worth, Texas 76111 Phone: 817-831-7038 Fax: 817-831-3110		
DRAWING DESC.: DETAILS / SECTIONS				
PROJECT: DADE COUNTY				
LOCATION:				
ARCHITECT:				
CUSTOMER:				
DATE: 2/23/04	DWN BY: DSR	POTTORFF ORDER NO.	CUSTOMER P.O. NO.	DRAWING NO.
SCALE: NOTED	SHEET: 4 of 8			DC-D2

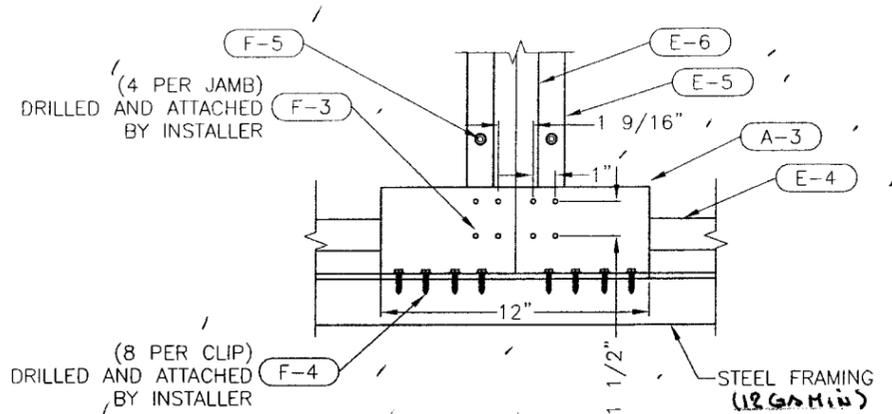

REAR MULLION ELEVATION 1 CLIP ANGLE ATTACHMENT @ MULLION (TYP)  
1-1/2"=1" D3 E1

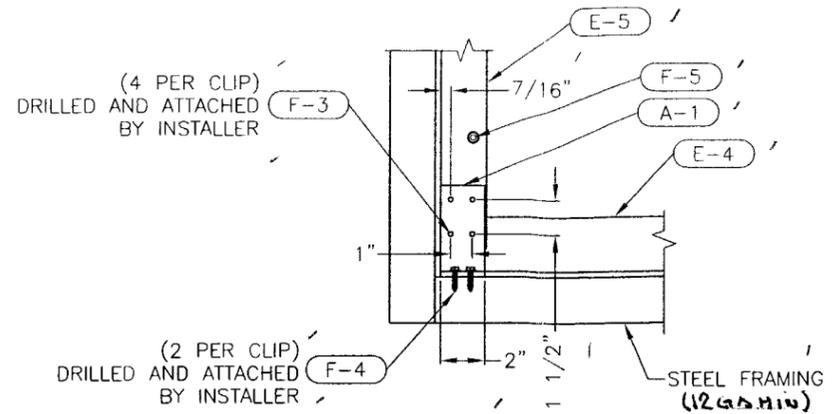


REAR CORNER ELEVATION 2 CLIP ANGLE ATTACHMENT @ CORNER (TYP)  
1-1/2"=1" D3 E1


OPPOSITE CORNER MIRRORED HOLE PATTERN

DETAILS FOR STEEL CONDITION


DETAILS FOR CONCRETE / REINFORCED BLOCK CONDITION

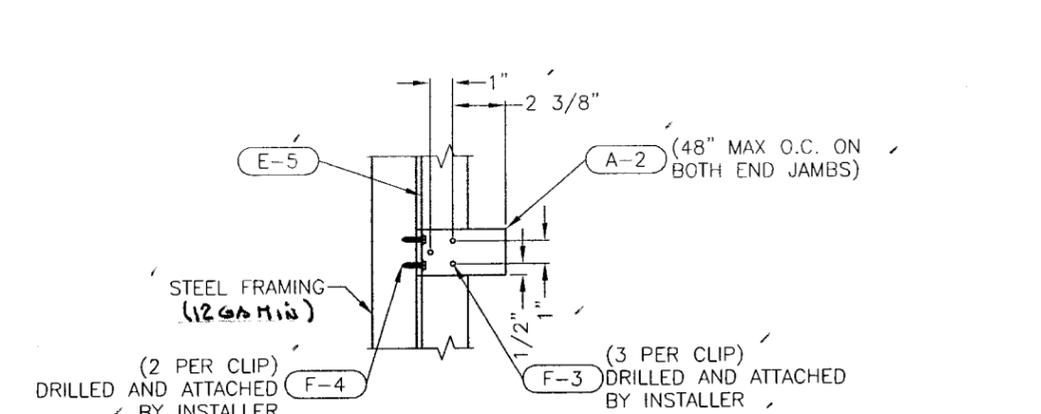

REAR INTERMEDIATE JAMB ELEVATION 3 CLIP ANGLE ATTACHMENT @ INTERMEDIATE LOCATION  
1-1/2"=1" D3 E1

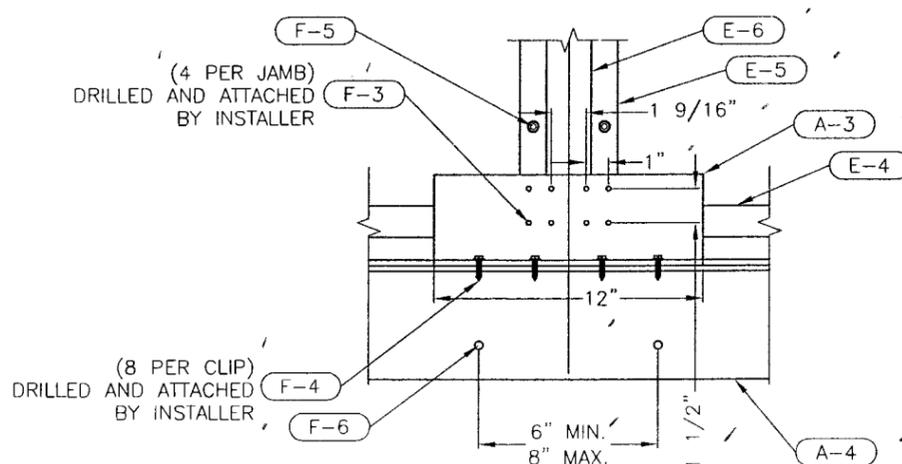


REAR MULLION ELEVATION 4 CLIP ANGLE ATTACHMENT @ MULLION (TYP)  
1-1/2"=1" D3 E1

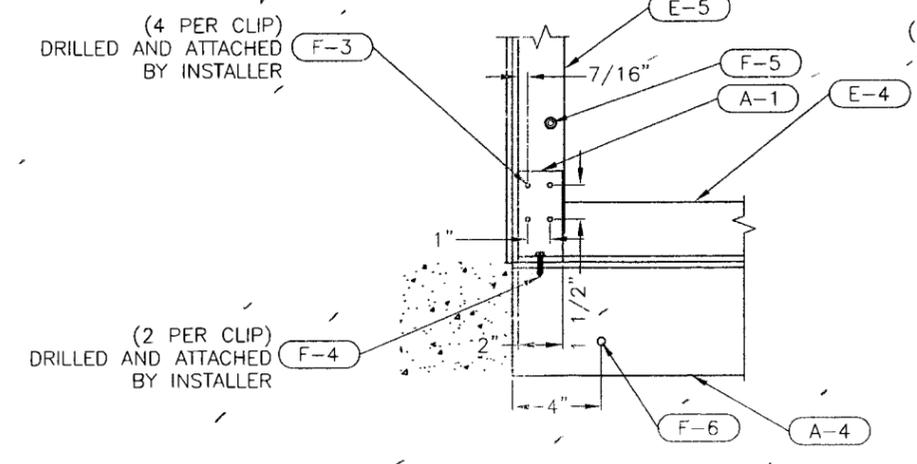

REAR CORNER ELEVATION 5 CLIP ANGLE ATTACHMENT @ CORNER (TYP)  
1-1/2"=1" D3 E1

OPPOSITE CORNER MIRRORED HOLE PATTERN

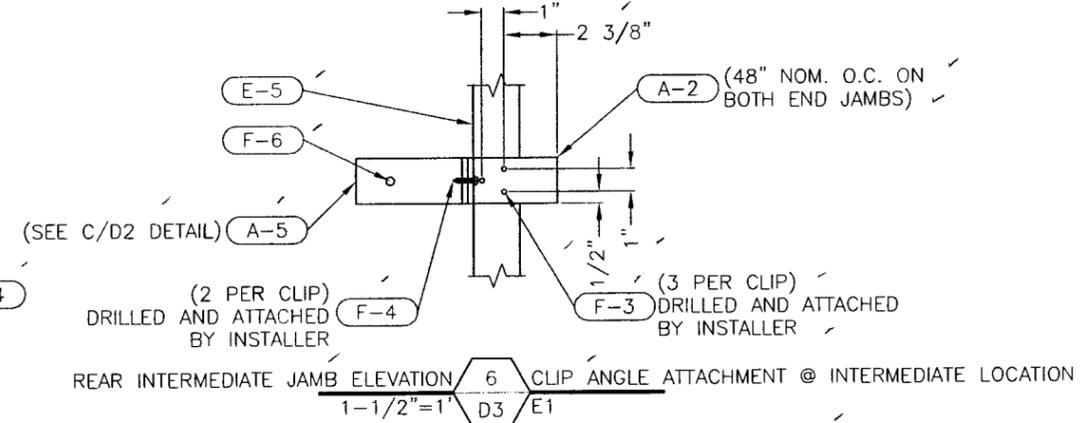

REAR INTERMEDIATE JAMB ELEVATION 6 CLIP ANGLE ATTACHMENT @ INTERMEDIATE LOCATION  
1-1/2"=1" D3 E1

PRODUCT RENEWED as complying with the Florida Building Code  
Acceptance No. 09-1007.01  
Expiration Date 02/19/2014  
By *[Signature]*  
Miami Dade Product Control Division


Approved by *[Signature]* with the Florida Building Code  
Date 04/02/09  
04-0909.07  
Miami Dade Product Control Division

*[Handwritten Signature]* 2/27/04

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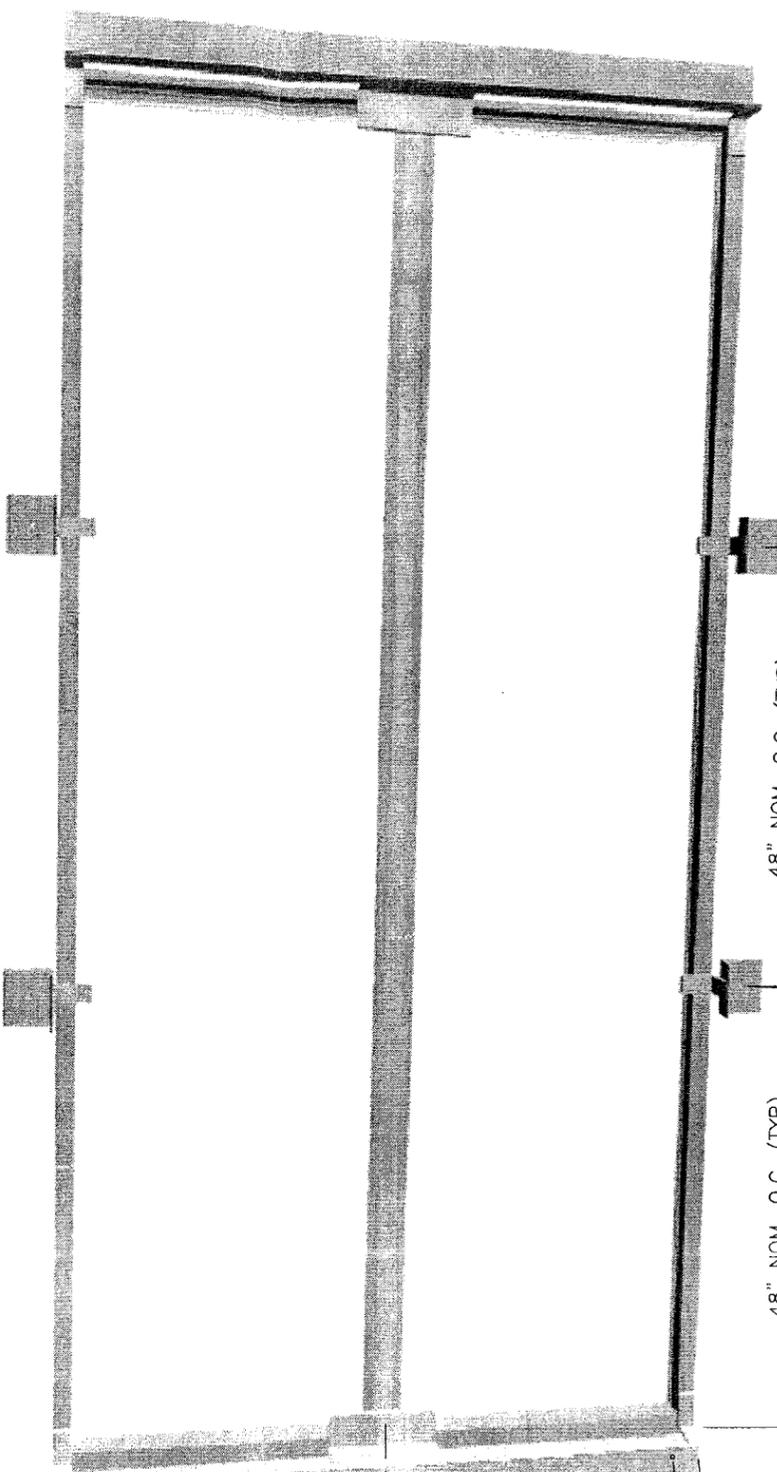
REV. NO.	DESCRIPTION	DATE	DRAWN BY

<b>POTTORFF</b>	2824 North Sylvania Avenue Fort Worth, Texas 76111 Phone: 817-831-7038 Fax: 817-831-3110			
	DRAWING DESC.: DETAILS / SECTIONS			
PROJECT: DADE COUNTY				
LOCATION:				
ARCHITECT:				
CUSTOMER:				
DATE: 2/23/04	DWN BY: DSR	POTTORFF ORDER NO.	CUSTOMER P.O. NO.	DRAWING NO.
SCALE: NOTED	SHEET: 5 of 8			DC-D3

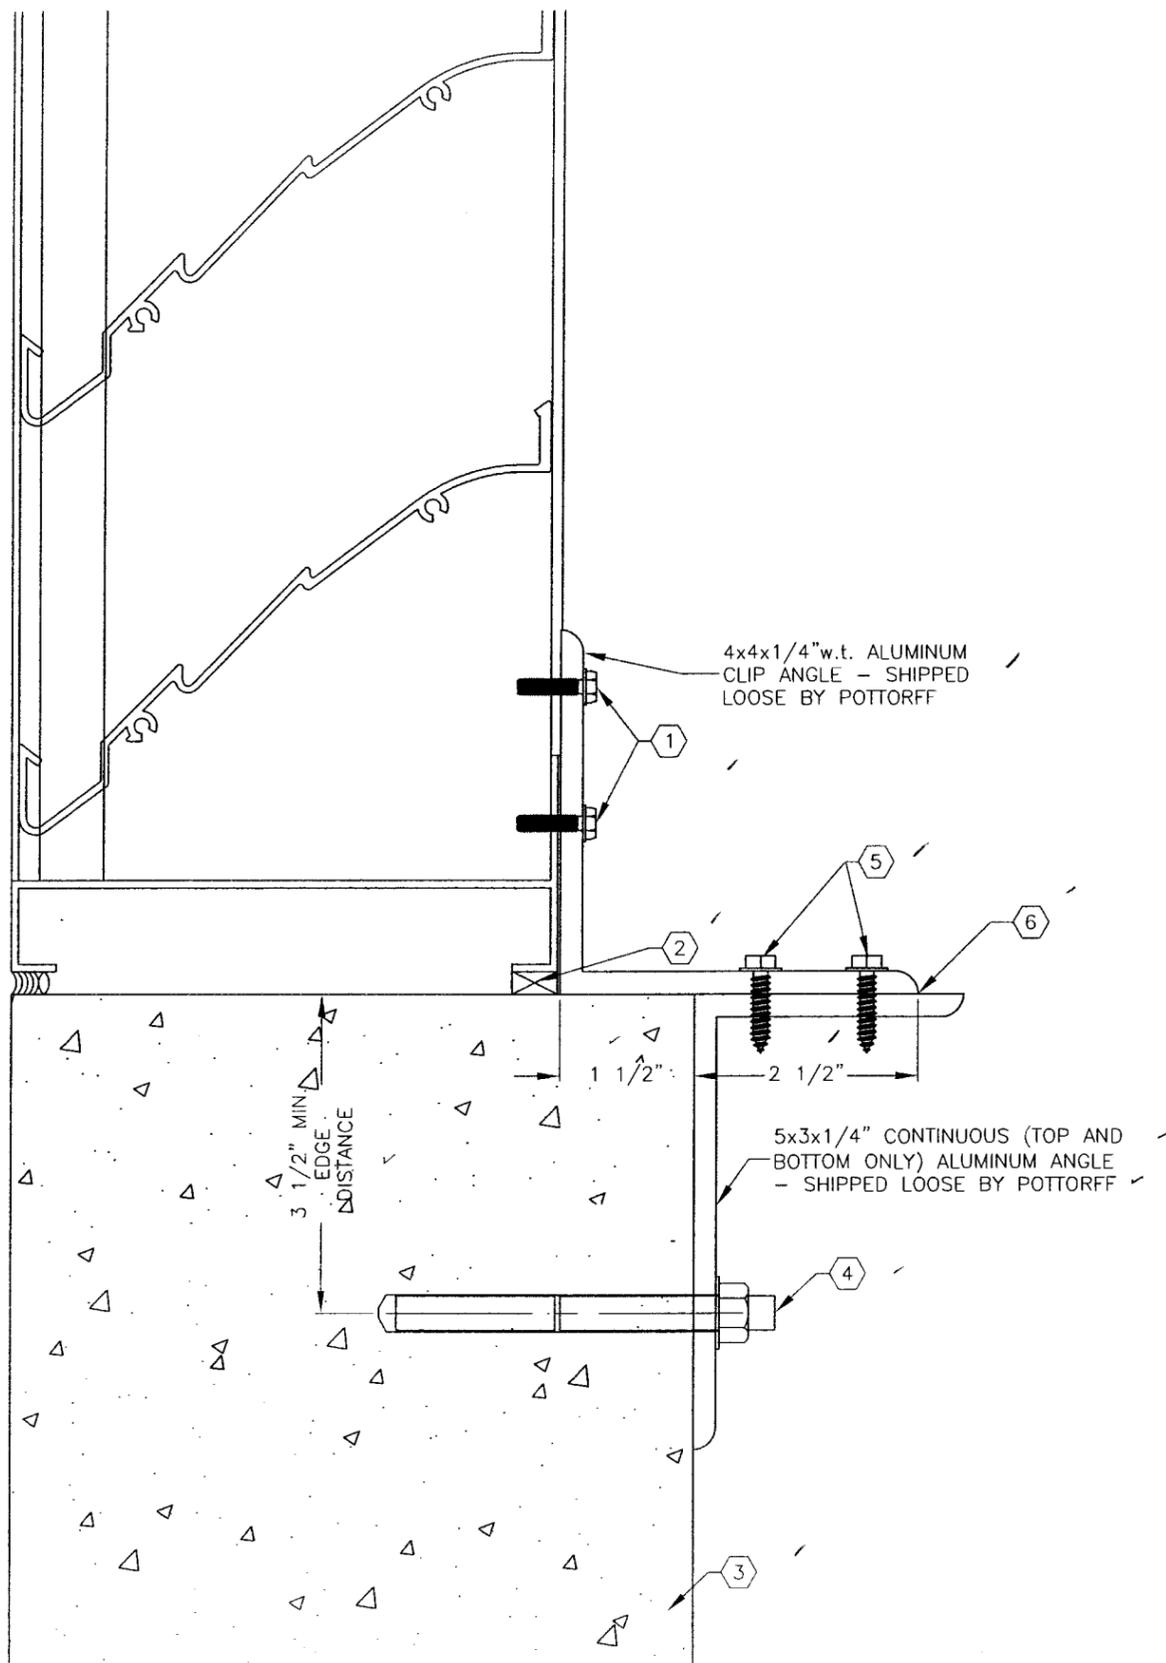

4x4x1/4" w.t. ALUMINUM CLIP ANGLE - SHIPPED LOOSE BY POTTORFF

5x3x1/4" CONTINUOUS (TOP AND BOTTOM ONLY) ALUMINUM ANGLE - SHIPPED LOOSE BY POTTORFF



24" NOM. O.C. (TYP.) ANCHOR SPACING  
NO LESS THAN 6" AND NO MORE THAN 8"

4" (TYP.) ANCHORING SPACING

CODED NOTES

- ① F1 - FOUR (4) FASTENERS FROM CLIP ANGLE INTO EACH OF TWO FRAME MEMBERS - #12-24x1" LONG SELF TAPPING STAINLESS STEEL MACHINE SCREWS, F-POINT, BRIGHT HARDENED PASSIVATED AND WAXED, MADE IN USA. (SHIPPED LOOSE BY ALL-LITE).  $\phi 0.177$ " / #16 DRILL BIT PILOT HOLE REQUIRED.
- ② SHIM AS REQUIRED TO MAKE LOUVER LEVEL AND PLUMB - BY INSTALLER (TYP)
- ③ THIS CONDITION MAY BE ONE OF THE FOLLOWING:
  - A: 8" SOLIDLY GROUTED BOND BEAM BLOCKS - REINFORCED (GROUT STRENGTH 4000 PSI)
  - B: SOLID CONCRETE (2000 PSI)
    - 1. PRE-CAST CONCRETE
    - 2. CAST-IN-PLACE CONCRETE
- ④  $\phi 3/8$ " HILTI HIT HY 150 EPOXY INJECTION ADHESIVE ANCHOR WITH STAINLESS STEEL HAS ROD. 3-1/2" EMBEDMENT DEPTH. ANCHORS MUST BE 4" FROM EITHER END AND MAINTAIN A NOMINAL DISTANCE OF 24" O.C.
- ⑤ FASTENERS FROM CLIP ANGLE INTO 5x3x1/4" ANCHOR CLIP - #12-24x1" LONG 410 STAINLESS STEEL SELF DRILLING TEK SCREWS.  $\phi 0.218$ " / 7/32" DRILL BIT THRU HOLES.
- ⑥ INSTALLER TO PROVIDE GASKET MATERIAL BETWEEN ALUMINUM AND STEEL CLIP ANGLES FOR SEPARATION OF DISSIMILAR MATERIALS, WHERE APPROPRIATE.

PRODUCT RENEWED as complying with the Florida Building Code  
 Acceptance No. 09-1007.01  
 Expiration Date 02/19/2014  
 By: [Signature]  
 Miami Dade Product Control Division


Approved as complying with the Florida Building Code  
 Date: 10/21/09  
 No. 04-0909.01  
 By: [Signature]

<b>POTTORFF</b>		2824 North Sylvania Avenue Fort Worth, Texas 76111 Phone: 817-831-7038 Fax: 817-831-3110	
DRAWING DESC.: DETAILS / SECTIONS			
PROJECT: DADE COUNTY			
LOCATION:			
ARCHITECT:			
CUSTOMER:			
DATE: 2/23/04	DWN BY: DSR	POTTORFF ORDER NO.	CUSTOMER P.O. NO.
SCALE: NOTED	SHEET: 6 of 8		DRAWING NO. DC-D4


FILE: C:\JOBS\DADE CO GEN SUB\POTTORFF DADE COUNTY REV B

REV. NO.	DESCRIPTION	DATE	DRAWN BY


PART #: E-1  
 PART NAME: HEAD  
 MATERIAL: 0.081" THICK 6063-T5 EXTRUDED ALUMINUM  
 SCALE: 3"=1'

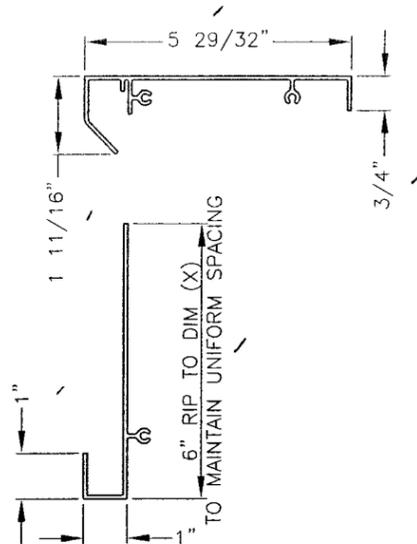


PART #: E-2  
 PART NAME: DRIP  
 MATERIAL: 0.081" THICK 6063-T5 EXTRUDED ALUMINUM  
 SCALE: 3"=1'  
 (HEIGHT DIM (X) IS DETERMINED BY THE LOUVER HEIGHT TO KEEP A UNIFORM BLADE SPACING)

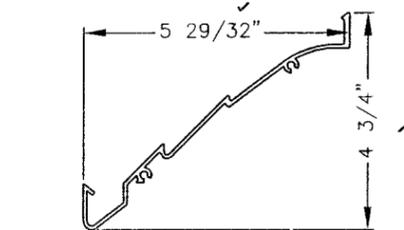


PART #: E-3  
 PART NAME: BLADE  
 MATERIAL: 0.081" THICK 6063-T5 EXTRUDED ALUMINUM  
 SCALE: 3"=1'

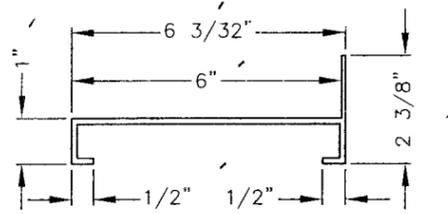

PART #: E-4  
 PART NAME: SILL  
 MATERIAL: 0.125" THICK 6063-T5 EXTRUDED ALUMINUM  
 SCALE: 3"=1'

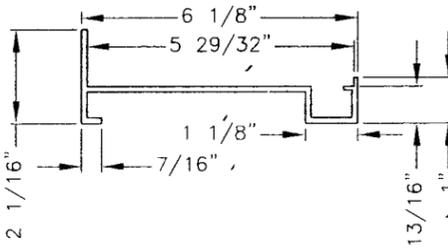


PART #: E-5  
 PART NAME: JAMB  
 MATERIAL: 0.125" THICK 6063-T5 EXTRUDED ALUMINUM  
 SCALE: 3"=1'

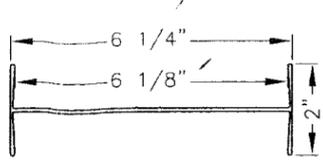


PART #: E-6  
 PART NAME: 1-MULLION SEAM COVER  
 MATERIAL: 0.078" THICK 6063-T5 EXTRUDED ALUMINUM  
 SCALE: 3"=1'


PART #: E-7  
 PART NAME: SCREEN FRAME  
 MATERIAL: 0.065" THICK 6063-T5 EXTRUDED ALUMINUM  
 SCALE: 3"=1'

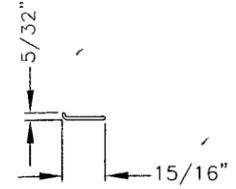


PART #: A-1, A-2  
 PART NAME: CLIP ANGLE - @ TOP CORNER, BOTTOM CORNER, & INTERMEDIATE OF JAMB  
 MATERIAL: 0.25" THICK 6063-T5 EXTRUDED ALUMINUM (2" LONG)  
 SCALE: 3"=1'

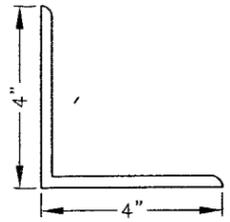


PART #: A-3  
 PART NAME: CLIP ANGLE - @ TOP & BOTTOM OF JAMB MULLION CONNECTION  
 MATERIAL: 0.25" THICK 6063-T5 EXTRUDED ALUMINUM (12" LONG)  
 SCALE: 3"=1'

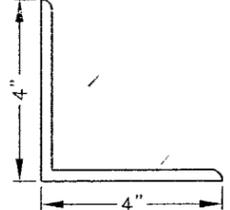

PART #: A-4  
 PART NAME: CONTINUOUS ANGLE  
 MATERIAL: 0.25" THICK 6063-T5 EXTRUDED ALUMINUM  
 SCALE: 3"=1'

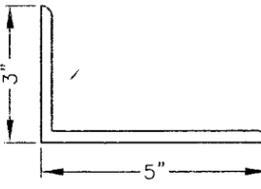

PART #: A-5  
 PART NAME: INTERMEDIATE JAMB CONDITION CLIP ANGLE  
 MATERIAL: 0.25" THICK 6063-T5 EXTRUDED ALUMINUM (2" LONG)  
 SCALE: 3"=1'

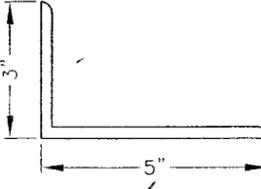

**PRODUCT RENEWED**  
 as complying with the Florida  
 Building Code  
 Acceptance No. 09-1907.01  
 Expiration Date 02/19/2014  
 By: [Signature]  
 Miami Dade Product Control  
 Division

Approved as complying with the  
 Florida Building Code  
 Date: 10/21/09  
 Sign: 09-0909.01  
 Miami Dade Product Control  
 Division  
 By: [Signature]

[Handwritten Signature] 2/27/04

FILE: C:\JOBS\DADE CO GEN SUB\POTTORFF DADE COUNTY REV B

REV. NO.	DESCRIPTION	DATE	DRAWN BY

<b>POTTORFF</b>		2824 North Sylvania Avenue Fort Worth, Texas 76111 Phone: 817-831-7038 Fax: 817-831-3110	
DRAWING DESC.: DETAILS / SECTIONS			
PROJECT: DADE COUNTY			
LOCATION:			
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CUSTOMER:			
DATE: 2/23/04	DWN BY: DSR	POTTORFF ORDER NO.	CUSTOMER P.O. NO.
SCALE: NOTED	SHEET: 7 of 8	DRAWING NO. DC-05	

PARTS KEY

FASTENERS / ANCHORS

F-1	#10-UNCx5/8" LONG, 410 S.S., SELF-DRILLING TEK MACHINE SCREW ✓
F-2	#10-24x3/4" LONG, 410 S.S., "F" POINT THREAD-CUTTING MACHINE SCREW, BRIGHT HARDENED, PASSIVATED AND WAXED, MADE IN U.S.A. ✓
F-3	#12-24x1" LONG, 410 S.S., "F" POINT THREAD-CUTTING MACHINE SCREW, BRIGHT HARDENED, PASSIVATED AND WAXED, MADE IN U.S.A. ✓
F-4	#12-24x1" LONG, 410 S.S., SELF-DRILLING TEK MACHINE SCREW ✓
F-5	Ø1/4"-10 GRIP BUTTON HEAD ALUMINUM HUCK MAGNA-GRIP STYLE LOCK BOLT ✓
F-6	Ø3/8"x3 3/8" LONG HILTI HIT HY 150 EPOXY INJECTED ADHESIVE ANCHOR W/ 5 1/8" LONG S.S. HAS ROD, ✓ EMBEDMENT DEPTH OF 3 1/2"

ANGLES

A-1	4"x4"x2"x1/4" w.t. 6063-T5 EXTRUDED ALUMINUM ANGLE ✓ @ TOP AND BOTTOM CORNERS
A-2	4"x4"x2"x1/4" w.t. 6063-T5 EXTRUDED ALUMINUM ANGLE ✓ @ INTERMEDIATE OF OUTER MOST JAMBS
A-3	4"x4"x12"x1/4" w.t. 6063-T5 EXTRUDED ALUMINUM ANGLE ✓ @ TOP AND BOTTOM OF MULLION CONNECTIONS
A-4	5"x3"x1/4" w.t. 6063-T5 EXTRUDED ALUMINUM CONTINUOUS ANGLE ✓
A-5	5"x3"x1/4" w.t. x2" LONG 6063-T5 EXTRUDED ALUMINUM ANGLE ✓

EXTRUDED FRAME

E-1	HEAD FRAME, 0.081" THICK, 6063-T5 EXTRUDED ALUMINUM ✓
E-2	DRIP, 0.081" THICK, 6063-T5 EXTRUDED ALUMINUM ✓
E-3	BLADE, 0.081" THICK, 6063-T5 EXTRUDED ALUMINUM ✓
E-4	SILL FRAME, 0.125" THICK, 6063-T5 EXTRUDED ALUMINUM ✓
E-5	JAMB FRAME, 0.125" THICK, 6063-T5 EXTRUDED ALUMINUM ✓
E-6	I-MULLION SEAM COVER, 0.078" THICK, ✓ 6063-T5 EXTRUDED ALUMINUM
E-7	SCREEN FRAME, 0.065" THICK, 6063-T5 EXTRUDED ALUMINUM W/ 1/2"x0.050" EXPANDED ALUMINUM BIRD SCREEN ✓

INSTALLATION NOTES

I-1	SEALANT AND BACKER ROD PROVIDED BY INSTALLER (TYP) ✓
I-2	SHIM AS REQ'D TO MAKE LEVEL AND PLUMB, PROVIDED BY INSTALLER (TYP) ✓

PRODUCT RENEWED  
as complying with the Florida  
Building Code  
Acceptance No 09-1007.01  
Expiration Date 02/19/2014  
By *[Signature]*  
Miami Dade Product Control  
Division

Approved by *[Signature]*  
Florida Building Code  
Date 10/21/09  
NO. 04-0909.01  
Miami Dade Product Control  
Division

<b>POTTORFF</b>	2824 North Sylvania Avenue Fort Worth, Texas 76111 Phone: 817-831-7038 Fax: 817-831-3110			
DRAWING DESC.: PARTS KEY				
PROJECT: DADE COUNTY				
LOCATION:				
ARCHITECT:				
CUSTOMER:				
DATE: 2/23/04	DWN BY: DSR	POTTORFF ORDER NO.	CUSTOMER P.O. NO.	DRAWING NO. DC-06
SCALE: NONE	SHEET: 8 of 8			

FILE: C:\JOBS\DADE CO GEN SUB\POTTORFF DADE COUNTY REV B

REV. NO.	DESCRIPTION	DATE	DRAWN BY

*[Signature]*  
2/27/04