

DEPARTMENT OF REGULATORY AND ECONOMIC RESOURCES (RER) BOARD AND CODE ADMINISTRATION DIVISION

NOTICE OF ACCEPTANCE (NOA)

MIAMI-DADE COUNTY PRODUCT CONTROL SECTION 11805 SW 26 Street, Room 208

Miami, Florida 33175-2474 T (786) 315-2590 F (786) 315-2599

www.miamidade.gov/economy

Tischler Und Sohn (USA) Ltd. Six Suburban Avenue Stamford, Ct. 06901

SCOPE:

This NOA is being issued under the applicable rules and regulations governing the use of construction materials. The documentation submitted has been reviewed and accepted by Miami-Dade County RER -Product Control Section to be used in Miami Dade County and other areas where allowed by the Authority Having Jurisdiction (AHJ).

This NOA shall not be valid after the expiration date stated below. The Miami-Dade County Product Control Section (In Miami Dade County) and/or the AHJ (in areas other than Miami Dade County) reserve the right to have this product or material tested for quality assurance purposes. If this product or material fails to perform in the accepted manner, the manufacturer will incur the expense of such testing and the AHJ may immediately revoke, modify, or suspend the use of such product or material within their jurisdiction. RER reserves the right to revoke this acceptance, if it is determined by Miami-Dade County Product Control Section that this product or material fails to meet the requirements of the applicable building code.

This product is approved as described herein and has been designed to comply with the Florida Building Code, including the High Velocity Hurricane Zone.

DESCRIPTION: Tischler series Outswing Wood Doors-L.M. Impact

APPROVAL DOCUMENT: Drawing No.**1616 REV** C, titled "Out-Swing Impact Wood Panel Doors", sheets 1 through 17 of 17, dated 10/08/08 and last revised on May 15, 2018, prepared by W.W. Schaefer Engineering & Consulting, P.A., signed and sealed by Warren Schaefer, P.E., bearing the Miami-Dade County Product Control Revision stamp with the Notice of Acceptance number and expiration date by the Miami-Dade County Product Control Section.

MISSILE IMPACT RATING: Large Missile Impact Resistant

Limitations:

- 1. MDF material: Medite Exterior MDF panel EN 622 Type MDF-H2
- 2. See sheets 8 thru 10 for reinforcements, see panel glazing options on sheet 11.
- 3. Lower design pressure shall control when doors mulled w/ Tishler's transom (under separate approval) see sheet $\underline{6}$.
- 4. CMU to conform to ASTM-C 90 and min 2000 psi net compressive masonry strength.

LABELING: Each unit shall bear a permanent label with the manufacturer's name or logo, Wedel (Schleswig-Holstein), Germany and series and following statement: "Miami-Dade County Product Control Approved", unless otherwise noted herein.

RENEWAL of this NOA shall be considered after a renewal application has been filed and there has been no change in the applicable building code negatively affecting the performance of this product.

TERMINATION of this NOA will occur after the expiration date or if there has been a revision or change in the materials, use, and/or manufacture of the product or process. Misuse of this NOA as an endorsement of any product, for sales, advertising or any other purposes shall automatically terminate this NOA. Failure to comply with any section of this NOA shall be cause for termination and removal of NOA.

ADVERTISEMENT: The NOA number preceded by the words Miami-Dade County, Florida, and followed by the expiration date may be displayed in advertising literature. If any portion of the NOA is displayed, then it shall be done in its entirety.

INSPECTION: A copy of this entire NOA shall be provided to the user by the manufacturer or its distributors and shall be available for inspection at the job site at the request of the Building Official.

This NOA revises NOA # 18-0531.12 and consists of this page 1 and evidence pages E-1, E-2, E-3 & E-4, as well as approval document mentioned above.

The submitted documentation was reviewed by Ishaq I. Chanda, P.E.

MIAMI-DADE COUNTY
APPROVED

Ishaq I. Chands

NOA No. 20-0623.11 Expiration Date: May 27, 2024 Approval Date: August 13, 2020

Page 1

Tischler Und Sohn (USA) Ltd.

NOTICE OF ACCEPTANCE: EVIDENCE SUBMITTED

1. Evidence submitted under previous approvals

A. DRAWINGS

- 1. Manufacturer's parts drawings and sections (submitted under 11-1101.14 / #09-0212.06)
- 2. Drawing No.**1616 REV B**, titled "Out-Swing Impact Wood Panel Doors", sheets 1 through 17 of 17, dated 10/08/08 and last revised on FEB 20, 2014, prepared by W.W. Schaefer Engineering & Consulting, P.A., signed and sealed by Warren Schaefer, P.E.

(Note: The revision consists of updating angle clip masonry screws)

B. TESTS (submitted under 11-1101.15/#09-0212.07)

- 1. Test reports on: 1) Air Infiltration Test, per FBC, TAS 202-94
 - 2) Uniform Static Air Pressure Test, Loading per FBC TAS 202-94
 - 3) Water Resistance Test, per FBC, TAS 202-94
 - 4) Large Missile Impact Test per FBC, TAS 201-94
 - 5) Cyclic Wind Pressure Loading per FBC, TAS 203-94
 - 6) Forced Entry Test, per FBC 2411 3.2.1, TAS 202-94

Along with installation diagram of Single & Double Outswing /Inswing, Tilt/Turn Mahogany Wood French doors w/wo Sidelite & Transom, w/ MDF & wood Veneered Panels and different shapes top, prepared by Architectural Testing, Test Report(s) No. **ATI 77326.01-109-18**, dated 02/03/09 and **ATI 77327.01-109-18**, dated 02/202/09, both signed and sealed by Michael D. Stremmel, P.E.

2. Additional test report: ATI 77324.01-109.18 (specimen A3-1 & A3-7) issued by Architectural Testing per TAS 201, 202 and 203-94.

C. CALCULATIONS

1. Anchor calculations and structural analysis complying w/ FBC 2014 dated 02/20/2014, prepared by W.W. Schaefer Engineering & Consulting, P.A., signed & sealed by Warren Schaefer, P.E.

D. QUALITY ASSURANCE

1. Miami Dade Department of Regulatory and Economic Resources (RER).

E. MATERIAL CERTIFICATIONS

1. Test report No. ATI-86006.01-106-18 (Rev 2) dated 12/12/08 and ATI-86006.02-106-18 02/05/09 for "Durability of Wood-Based Composite Lumber and panels" per ASTM ASTM D-1761 and ASTM D-4761, issued by Architectural Testing Lab (submitted under 11-1101.15 / #09-0212.07).

F. STATEMENTS

- 1. Statement letters of conformance to FBC <u>5th</u> Edition (2014), dated MAR 27, 2014 and e-mail dated APR 17, 2014, prepared by W. W. Schafer Engineering & Consulting, P. A., signed and sealed by Warren W. Schafer, P.E.
- 2. Statement letters of conformance to FBC 2010, dated OCT 28, 2011 and "No financial interest dated OCT 24, 2011, prepared by W. W. Schafer Engineering & Consulting, P. A., signed and sealed by Warren W. Schafer, P.E. (submitted under #11-1101.15)
- 3. E-mail statement dated 03/31/09, issued by Michael D. Stremmel, P.E. of Architectural testing in reference to low sill, water infiltration test (submitted under 11-1101.15/#09-0212.07)

Ishaq I. Chanks

Ishaq I. Chanda, P.E.

Product Control Unit Supervisor

NOA No. 20-0623.11 Expiration Date: May 27, 2024 Approval Date: August 13, 2020

NOTICE OF ACCEPTANCE: EVIDENCE SUBMITTED

G. OTHER

- 1. This NOA revises & renews NOA # 11-1101.15, expiring 05/27/14.
- 2. Test proposal # **07-3533** dated Oct 22, 2007, approved by BCCO.
- 3. Distribution agreement between Tishler Und Sohn (USA) and Tishler/Cornelius Korn GmbH, Germany, signed by Tim Carpenter & Wilhem Korn, respectively.
- 4. Tishler's current Fixed Casement windows NOA(s) w/ Drawing references No. 1514 or 1533.

2. Evidence submitted under previous approval

A. DRAWINGS

1. None.

B. TESTS

1. None

C. CALCULATIONS

1. None

D. QUALITY ASSURANCE

1. Miami Dade Department of Regulatory and Economic Resources (RER).

E. MATERIAL CERTIFICATIONS

1. None.

F. STATEMENTS

1. Statement letters of conformance to FBC 2017(6th Edition) and still complies with FBC 2014 (5th Edition), dated JUL 20,2017, prepared by W. W. Schafer Engineering & Consulting, P. A., signed and sealed by Warren W. Schafer, P.E.

G. OTHER

- 1. This NOA revises NOA # 14-0303.08, expiring 05/27/2019.
- 2. E-mail request dated 10/12/17 for correction of Tischler Und Sohn manufacturing location in Germany, signed by Stefan Precht, VP project management.

3. Evidence submitted under previous submittal

A. DRAWINGS

1 Drawing No.**1616 REV** C, titled "Out-Swing Impact Wood Panel Doors", sheets 1 through 17 of 17, dated 10/08/08 and last revised on May 15, 2018, prepared by W.W. Schaefer Engineering & Consulting, P.A., signed and sealed by Warren Schaefer, P.E.

Ishaq I. Chands

Ishaq I. Chanda, P.E. Product Control Unit Supervisor NOA No. 20-0623.11

Expiration Date: May 27, 2024 Approval Date: August 13, 2020

Tischler Und Sohn (USA) Ltd.

NOTICE OF ACCEPTANCE: EVIDENCE SUBMITTED

- 3. Evidence submitted under previous approval (continue):
- B. TESTS
 - 1. None
- C. CALCULATIONS
 - 1. Anchor calculations and structural analysis complying w/ FBC 2017(6th Edition) dated May 15, 2018, prepared by W.W. Schaefer Engineering & Consulting, P.A., signed & sealed by Warren Schaefer, P.E.
- D. QUALITY ASSURANCE
 - 1. Miami Dade Department of Regulatory and Economic Resources (RER).
- E. MATERIAL CERTIFICATIONS
 - 1. None
- F. STATEMENTS
 - 1. Statement letters of conformance to FBC 2017(6th Edition) and still complies with FBC 2017 (6th Edition), dated May 15, 2018, prepared by W. W. Schafer Engineering & Consulting, P. A., signed and sealed by Warren W. Schafer, P.E.
 - 2. Statement letter dated May 11, 2018, issued by Tishler Und Sohn, Ltd, requesting Renewal, signed by Timothy K. Carpenter, company's president.
- G. OTHER
 - 1. This NOA revises & renews NOA # 17-0803.33, expiring 05/27/2024.
 - 2. Distribution agreement between Tishler Und Sohn (USA) and Tishler/Cornelius Korn GmbH, Germany, signed by Tim Carpenter & Wilhem Korn, respectively.
 - 3. E-mail request dated 10/12/17 for correction of Tischler Und Sohn manufacturing location in Germany, signed by Stefan Precht, VP project management.
- 4. New Evidence submitted
- A. DRAWINGS
 - 1. None.
- B. TESTS
 - 1. None
- C. CALCULATIONS
 - 1. None
- D. QUALITY ASSURANCE
 - 1. Miami Dade Department of Regulatory and Economic Resources (RER).

Ishaq I. Chandes
Ishaq I. Chanda, P.E.

Product Control Unit Supervisor NOA No. 20-0623.11

Expiration Date: May 27, 2024 Approval Date: August 13, 2020

Tischler Und Sohn (USA) Ltd.

NOTICE OF ACCEPTANCE: EVIDENCE SUBMITTED

- 4. Evidence submitted under previous approval (continue
- E. MATERIAL CERTIFICATIONS
 - 1. None.

F. STATEMENTS

2. Statement letters of conformance to FBC 2020 (7th Edition), dated June 05, 2020, prepared by W. W. Schafer Engineering & Consulting, P. A., signed and sealed by Warren W. Schafer, P.E.

G. OTHER

1. This NOA revises NOA # 18-0513.12, for FBC 2020 update.

Ishaq I. Chands

E -4

GENERAL NOTES:

- 1. THIS PRODUCT HAS BEEN TESTED, ANALYZED & APPROVED FOR DESIGN PRESSURES NOT TO EXCEED THOSE SHOWN IN THE "ALLOWABLE DESIGN PRESSURE TABLE(S)".
- OPENINGS. BUCKING & BUCKING FASTENERS MUST BE PROPERLY DESIGNED & INSTALLED TO TRANSFER WIND LOADS TO THE STRUCTURE
- 3. ALL HARDWARF & FASTENERS SHALL BE IN ACCORDANCE WITH THESE DRAWINGS & SHALL NOT VARY UNLESS SPECIFICALLY MENTIONED ON THE DRAWINGS. SPECIFIED ANCHOR EMBED TO BASE MATERIAL SHALL BE BEYOND WALL FINISH OR STUCCO
- 4. THE DETAILS & SPECIFICATIONS SHOWN HEREIN REPRESENT THE PRODUCTS TESTED & PROPOSED FOR CONFORMANCE WITH THE FLORIDA BUILDING CODE PROTOCOLS TAS-201, 202 & 203 FOR LARGE MISSILE IMPACT PRODUCTS.
- 5. THIS PRODUCT HAS BEEN DESIGNED IN ACCORDANCE WITH AND MEETS THE REQUIREMENTS OF THE FLORIDA BUILDING CODE (FBC) INCLUDING HIGH VELOCITY HURRICANE ZONES (HVHZ).
- 6. IMPACT SHUTTERS ARE NOT REQUIRED WITH THIS PRODUCT.
- 7. ALL ANCHORS SECURING PRODUCT FRAMES TO PRESSURE TREATED BUCKS OR WOOD FRAMING SHALL BE CAPABLE OF RESISTING CORROSION CAUSED BY THE PRESSURE TREATING CHEMICALS IN THE WOOD.
- 8. DETERMINE THE POSITIVE & NEGATIVE DESIGN LOADS TO USE WHEN REFERENCING THESE DOCUMENTS IN ACCORDANCE WITH THE GOVERNING CODE AND GOVERNING WIND VELOCITY. FOR WIND LOAD CALCULATIONS IN ACCORDANCE WITH THE FLORIDA BUILDING CODE, A DIRECTIONALITY FACTOR OF Kd = 0.85 MAY BE APPLIED PER THE ASCE-7 STANDARD. 9. NO INCREASE IN ALLOWABLE STRESS HAS BEEN USED IN THE CERTIFICATION OF THIS PRODUCT. WIND LOAD DURATION FACTOR Cd = 1.6 WAS USED FOR WOOD SCREW ANALYSIS ONLY.
- 10. MATERIALS, INCLUDING BUT NOT LIMITED TO STEEL SCREWS, THAT COME INTO CONTACT WITH OTHER DISSIMILAR MATERIALS SHALL MEET THE REQUIREMENTS OF FLORIDA BUILDING CODE.
- 11. All WOOD MEMBERS OF THIS PRODUCT THAT MAY POSSIBLY COME INTO CONTACT WITH MASONRY OR CONCRETE SUBSTRATES, ARE SUBJECT TO MOISTURE &/OR ARE SUBJECT TO THE OUTSIDE ENVIRONMENT SHALL BE OF AN APPROVED DURABLE SPECIES OR BE TREATED IN AN APPROVED METHOD WITH AN APPROVED PRESERVATIVE PER FBC REQUIREMENTS.

FRAME ANCHOR REQUIREMENTS TABLE OPENING TYPE (SUBSTRATE) FRAME/SILL/CLIP/BRACKET TO MINIMUM EMBED EDGE DIST. FRAME/SILL SCREWS MIN. 2X4 WOOD FRAME OR BUCK NO. 14 SMS/WOOD SCREW OR (MIN. GR. 3 & G=0.55) MIN. 18 GA. 33 KSI METAL STUD (2)1/4-14 SELF TAP/DRILLING SCREW FULL 1/2" MIN. 1/8" THK A36 STEEL (2)1/4-14 SELF TAP/DRILLING SCREW FULL 1/2" MIN. 1/8" THK 6063-T5 ALUM. (2)1/4-14 SELF TAP/DRILLING SCREW FULL 1/2" C-90 CMU/2500 PSI CONCRETE (1) 1/4" CONCRETE SCREW 1 1/4" INSTALLATION CLIP SCREWS MIN. 2X6 WOOD FRAME OR BUCK (MIN. GR. 3 & G=0.55) NO. 12 X 1 1/2" SMS 1 3/4" MIN. 18 GA. 33 KSI METAL STUD (2)12-14 SELF TAP/DRILLING SCREW FULL 1/2"								
	FRAME/SILL/CLIP/BRACKET TO OPENING FASTENER TYPE	1						
	FRAME/SILL SCREWS							
		1 1/4"	3/4"					
MIN. 18 GA. 33 KSI METAL STUD		FULL	1/2"					
MIN. 1/8" THK A36 STEEL	(2)1/4-14 SELF TAP/DRILLING SCREW	FULL	1/2"					
MIN. 1/8" THK 6063-T5 ALUM.	(2)1/4-14 SELF TAP/DRILLING SCREW	FULL	1/2"					
C-90 CMU/2500 PSI CONCRETE	(1) 1/4" CONCRETE SCREW	1 1/4"	2"					
SUBSTRATE OPÉNING FASTÉNER TYPE EMBED EDGE DIST.								
MIN. 2X6 WOOD FRAME OR BUCK								
MIN. 18 GA. 33 KSI METAL STUD	FULL	1/2"						
MIN. 1/8" THK A36 STEEL	(2)12-14 SELF TAP/DRILLING SCREW	FULL	1/2"					
MIN. 1/8" THK 6063-T5 ALUM.	(2)12-14 SELF TAP/DRILLING SCREW	FULL	1/2"					
C-90 CMU/2500 PSI CONCRETE	(1) 1/4" CONCRETE SCREW	1 1/4"	2"					
(MIN. GR. 3 & G=0.55) NO. 8 X 1 1/2 SMS 1 3/8"								
MIN. 18 GA. 33 KSI METAL STUD	(2) 8-18 SELF TAP/DRILLING SCREW	FULL	1/2"					
MIN. 1/8" THK A36 STEEL	(2) 8-18 SELF TAP/DRILLING SCREW	FULL	, ,					
MIN. 1/8" THK 6063-T5 ALUM.	(2) 8-18 SELF TAP/DRILLING SCREW	FULL	1/2"					
	ANGLE CLIP SCREWS							
MIN. 2X6 WOOD FRAME OR BUCK (MIN. GR. 3 & G=0.55)	NO. 8 X 1 1/2" SMS	1 3/8"	3/4"					
MIN. 18 GA. 33 KSI METAL STUD	(2) 8-18 SELF TAP/DRILLING SCREW	FULL	1/2"					
MIN. 1/8" THK A36 STEEL	(2) 8-18 SELF TAP/DRILLING SCREW	FULL	1/2"					
MIN. 1/8" THK 6063-T5 ALUM.	(2) 8-18 SELF TAP/DRILLING SCREW	FULL	1/2"					
C-90 CMU/2500 PSI CONCRETE	(1) 1/4" CONCRETE SCREW	1 1/4"	2"					
(1) CONCRETE SCREWS SHALL BE	ELCO ULTRACONS, ELCO CRETE-FLEX C	R HILTI						

- |(1)CONCRETE SCREWS SHALL BE ELCO ULTRACONS, ELCO CRETE—FLEX OR HILTI KWIK-CON II (HARDENED STEEL OR S.S.).
- (2) ALL SELF TAP/DRILLING SCREWS SHALL BE MIN. GR. 5

į.	LOCK STRIKE REQUIREMENTS					
(TOP OF I	(TOP OF PANEL)					
PANEL WIDTH	QUANTITY PER PANEL					
RECTANGULAI	RECTANGULAR PANEL					
ALL WIDTHS	ALL WIDTHS 2					
ARCH & ROUND	TOP PANEL					
OVER 32"	3					
28" TO 32"	2					

	REQUIREMENTS				
ļ	(BOTTOM OF	PANEL)			
Y	PANEL	QUANTITY			
EL	WIDTH	PER PANEL			
	ALL PANEL	SHAPES			
	ALL WIDTHS	2			
EL	(1) WHEN ADA C	II IC LICED			

(1) LOCK STRIKE

|(1) WHEN ADA SILL IS USED WITH DOUBLE DOORS, ONLY THE KFV LOCK SYSTEM MAY BE USED. WHEN ADA SILL IS USED WITH A SINGLE DOOR. BOTH THE KFV & SIEGENIA LOCK SYSTEMS APPLY BUT DO NOT REQUIRE SILL STRIKES.

PANEL WIDTH DIMENSIONS ARE

LESS THAN THE FRAME HEIGHT

APPROXIMATELY 3" LESS THAN THE

FRAME WIDTH & PANEL HEIGHT WIDTH DIMENSIONS ARE APPROXIMATELY 1 3/4

LOCK STRIKE REQUIREMENTS (LOCK SIDE OF PANEL)

. , ., .,					
(1) PANEL	QUANTITY				
HEIGHT	PER PANEL				
ALL PANEL	SHAPES				
OVER 96"	4				
76" TO 96"	3				
A THE "DANIEL	LICIOLIT" IC				

(1) THE "PANEL HEIGHT" IS CONSIDERED TO BE FULL PANEL HEIGHT FOR RECTANGULAR UNITS OR DISTANCE FROM THE BASE OF PANEL TO PANEL SRINGLINE FOR SHAPED UNITS

THESE DRAWINGS ARE APPLICABLE ONLY TO THE PRODUCT DRAWN BY:
SPECIFIED. THEY MAY NOT BE USED FOR THE ASSEMBLY W.R.M. AND/OR INSTALLATION OF ANY OTHER PRODUCT NOR MAY THEY BE USED FOR RATIONAL AND/OR LOCAL APPROVAL OF ANY PRODUCT NOT PRODUCED BY THE MANUFACTURES STATED ON THESE DRAWINGS.

HINGE REQUIR	EMENTS
(1) PANEL	QUANTITY
HEIGHT	PER PANEL
OVER 99"	5
76" TO 99"	4

(1) THE "PANEL HEIGHT" IS CONSIDERED TO BE FULL PANEL HEIGHT FOR RECTANGULAR UNITS OR DISTANCE FROM THE BASE OF PANEL TO PANEL SRINGLINE FOR SHAPED UNITS

PRODUCT REVISED as complying with the Florida **Building Code** NOA-No. 20-0623.11

Expiration Date 05/27/2024

Ishaq I. Chands Miami-Dade Product Control

> SKODUC T REVISED in camplying with the Florida Mending Code Acceptance No 18-0531.12 Expiration Detc MAY 27, Zoly

Ishag Chan. Sant Bad Product Control

ALLOWABLE DESIGN PRESSURE (SINGLE & DOUBLE OPERABLE DOORS)

MAX. FRAME	MAX. FRAME	ALLOWABLE	PRESSURE
WIDTH (IN.)	HEIGHT (IN.)	POSITIVE (PSF)	NEGATIVE (PSF)
	SINGLE	DOOR	
51 11/16	120	70	70
41 1/2	99	70	(1) 85
	DOUBLE	DOOR	
80 1/16	120	70	70
80 1/16	99	70	(1) (2) 85

- (1) HIGHER PRESSURE OF -85 PSF IS ONLY APPLICABLE WITH STANDARD OR OPTIONAL SILL (USE OF ADA SILL IS NOT APPLICABLE TO UNITS WITH PRESSURE EXCEEDING $\pm 1/-70$ PSF).
- (2) HIGHER PRESSURE OF -85 PSF IS ONLY APPLICABLE WITH DOUBLE DOORS WHEN THE DOUBLE DOOR MEETING STILES ARE BAR REINFORCED (REF. SECTIONS).

CORNER CONSTRUCTION:

RECTANGULAR FRAME CORNERS: MORTISE & TENON CONSTRUCTION JOINED & GLUED WITH PONAL SUPER 3 WOOD GLUE OR EQUIVALENT.

ARCHED FRAME CORNERS: ARCHED FRAME BUTTED TO STRAIGHT FRAME, JOINED WITH ONE(1) NO.14 X 3" WOOD SCREW, & GLUED WITH PONAL SUPER 3 WOOD GLUE OR EQUIVALENT. HALF ROUND FRAME CORNERS: FINGER JOINT CONSTRUCTION JOINED & GLUED WITH PONAL SUPER 3 WOOD GLUE OR EQUIVALENT.

RECTANGULAR PANEL CORNERS: OPTION 1 (USED WITH STILE & RAIL CONDITIONS WHERE MEMBERS ARE 4.250" OR LESS IN OVERALL HEIGHT): MORTISE & TENON CONSTRUCTION JOINED & GLUED WITH PONAL SUPER 3 WOOD GLUE OR EQUIVALENT.

OPTION 2 (USED WITH STILE & RAIL CONDITIONS WHERE MEMBERS ARE GREATER THAN 4.250" IN OVERALL HEIGHT): MEMBERS ARE SQUARE CUT, BUTTED, JOINED WITH FIVE(5) \$5/16 X 2" WOOD DOWELS, & GLUED WITH PONAL SUPER 3 WOOD GLUE OR EQUIVALENT.

ARCHED PANEL CORNERS: ARCHED RAIL BUTTED TO STRAIGHT STILE, JOINED WITH ONE(1) NO.14 X 3" WOOD SCREW, & GLUED WITH PONAL SUPER 3 WOOD GLUE OR EQUIVALENT. HALF ROUND PANEL CORNERS: FINGER JOINT CONSTRUCTION JOINED & GLUED WITH PONAL SUPER 3 WOOD GLUE OR

ALL SILL CONDITIONS: SILL IS BUTTED TO THE JAMBS & JOINED WITH THREE(3) NO.6 X 2" WOOD SCREWS & SEALED WITH

SILL CORNERS:

R. ENGINEERING
P.A. (CA 6809)
UNIT NORTH
ENS, FL 33418 IMPACT -SWING W. SCHAEFER I CONSULTING, P 7480 150TH COUR PALM BEACH GARDENS PHONE: 551-74 15 ું≱ંજ

TISCHLER UND SOHN (USA) LTD.
SIX SUBURBAN AVENUE
STAMFORD, CONNECTICUT 06901
203-674-0600

DOORS

PANEL

WOOD

DRAWING

CHECKED BY


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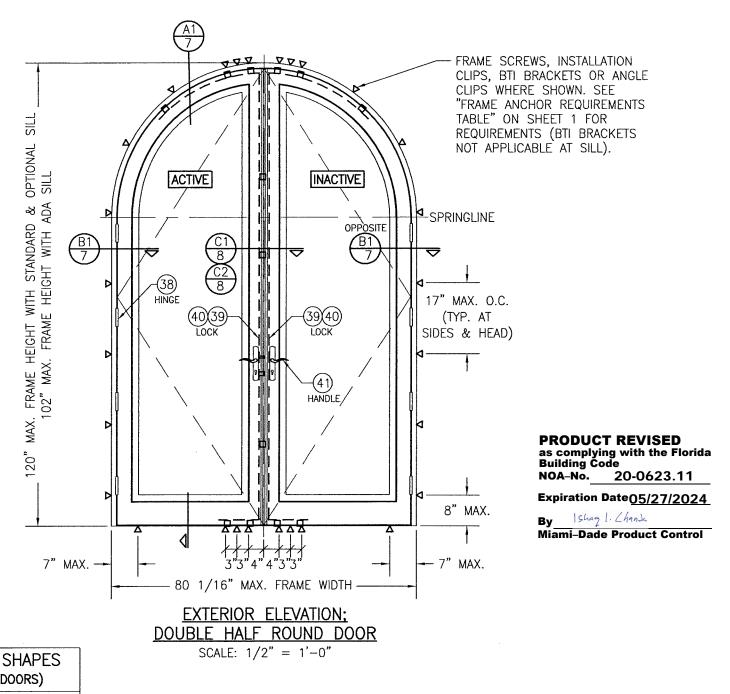
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\$ 2018 MAX

1616 SHEET NO.


1 of 17



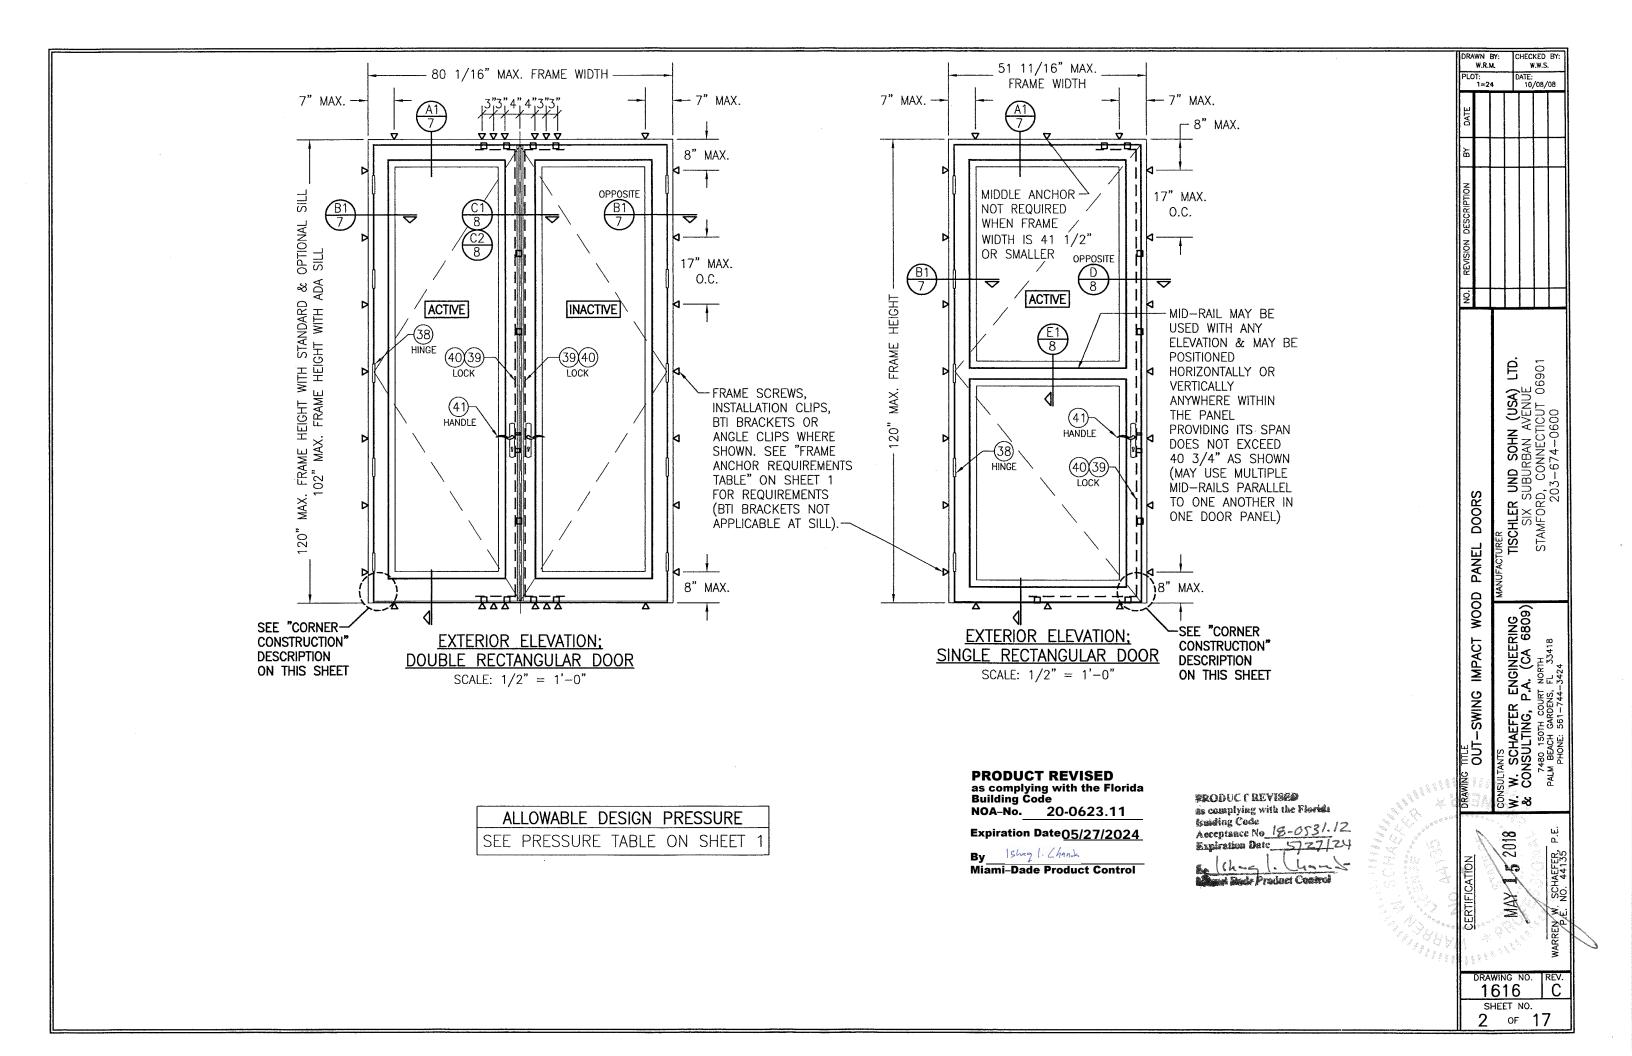

FRAME SCREWS, INSTALLATION CLIPS, BTI-BRACKETS OR ANGLE CLIPS WHERE SHOWN. SEE "FRAME ANCHOR REQUIREMENTS TABLE" ON SHEET 1 FOR REQUIREMENTS (BTI BRACKETS NOT APPLICABLE AT SILL). SPRINGLINE ACTIVE 8 HEIGHT FRAME 40(39)-LOCK 17" MAX. O.C. (TYP. AT SIDES & HEAD) -MIDDLE ANCHOR NOT REQUIRED WHEN FRAME WIDTH IS 41 1/2' OR SMALLER 8" MAX 7" MAX. → - 7" MAX. 51 11/16" MAX. FRAME WIDTH **EXTERIOR ELEVATION**; SINGLE HALF ROUND DOOR SCALE: 1/2" = 1'-0"

APPROVED SHAPES (OPERABLE DOORS)

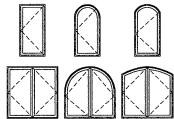

NOTES:

. OTHER SHAPES MAY APPLY PROVIDING THEY ARE SIMILAR TO THOSE SHOWN & HAVE CORNER CONSTRUCTION AS DESCRIBED IN THIS DRAWING.

2. ALL SHAPED UNITS MUST FIT INSCRIBED INTO THE ALLOWABLE RECTANGULAR UNITS & BE GOVERNED BY THE ALLOWABLE PRESSURE OF THE RESPECTIVE RECTANGULAR UNIT.

ALLOWABLE DESIGN PRESSURE

SEE PRESSURE TABLE ON SHEET

ANCHOR NOTE: ANCHOR SPACING AT THE HEAD OF ALL TYPES OF SHAPED DOORS MUST EQUAL THAT SPECIFIED AT THE SIDES (17" MAX. O.C.)

PRODUCT REVISED as complying with the Florist Isolding Code Acceptance No 18-0531.12 Expiration Date <727/24

W. SCHAEFER ENGINEERING CONSULTING, P.A. (CA 6809) 7480 150TH COURT NORTH PALM BEACH GARDENS, FL 33418 DHONE: 561-744-3424 ું કે શ્ર 1616

SHEET NO.

3 of 17

DATE: 10/08/08

TISCHLER UND SOHN (USA) LTD.
SIX SUBURBAN AVENUE
STAMFORD, CONNECTICUT 06901
203-674-0600


DOORS


PANEL

WOOD

IMPACT

1=24

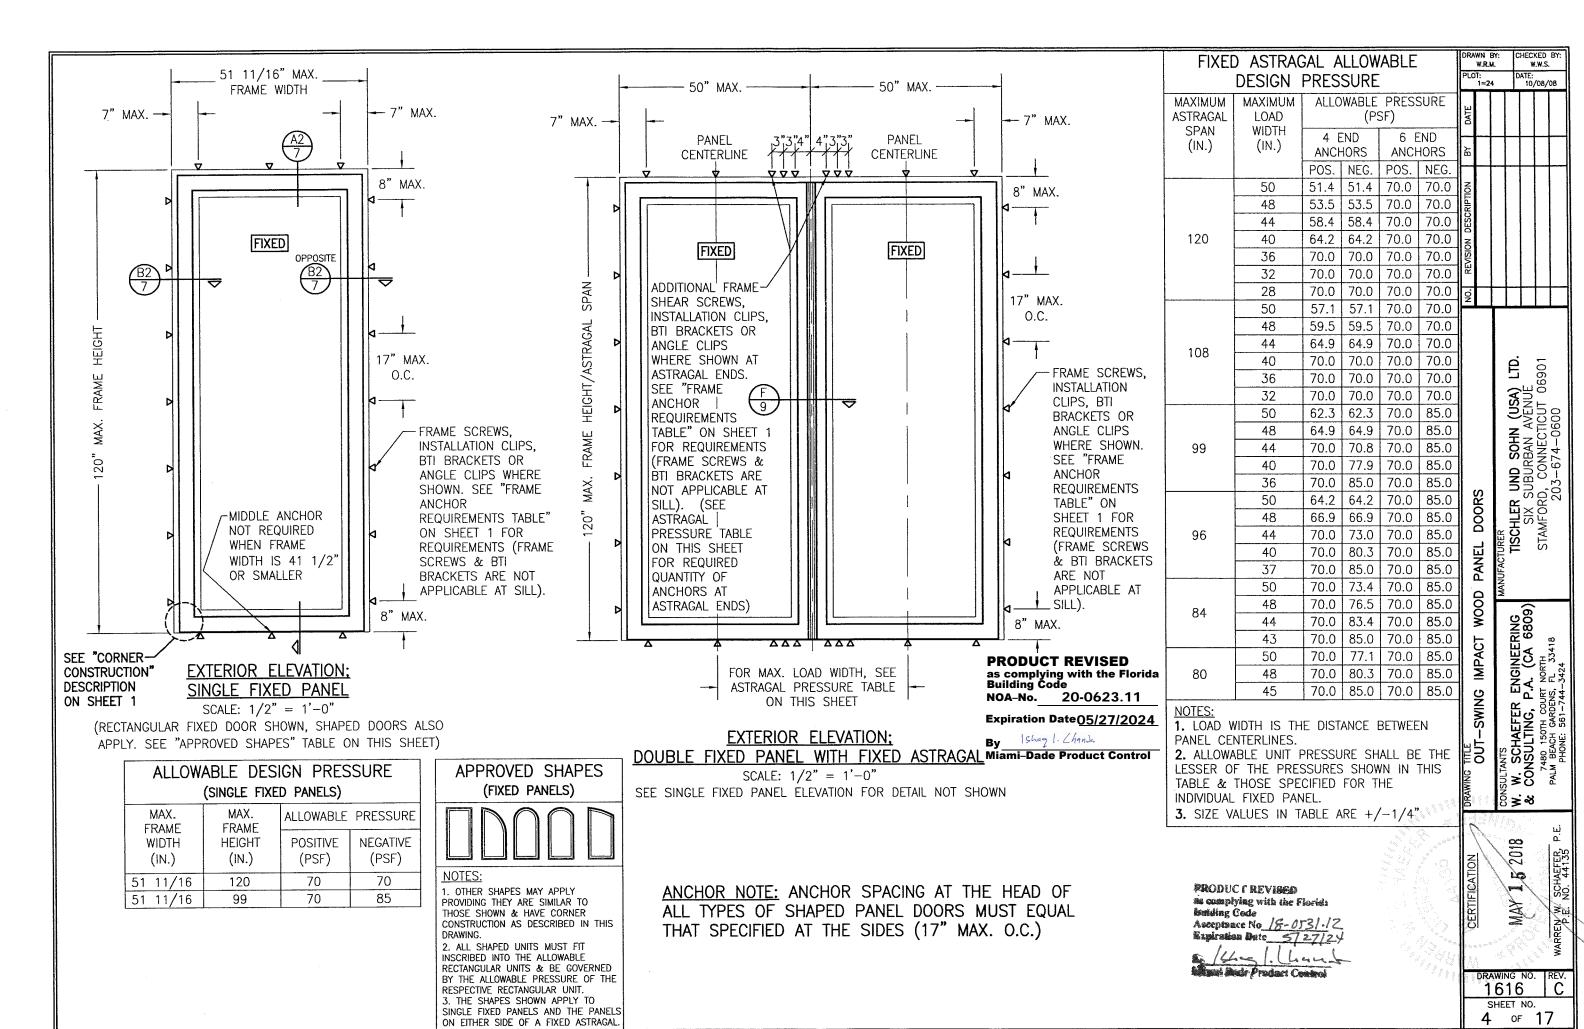

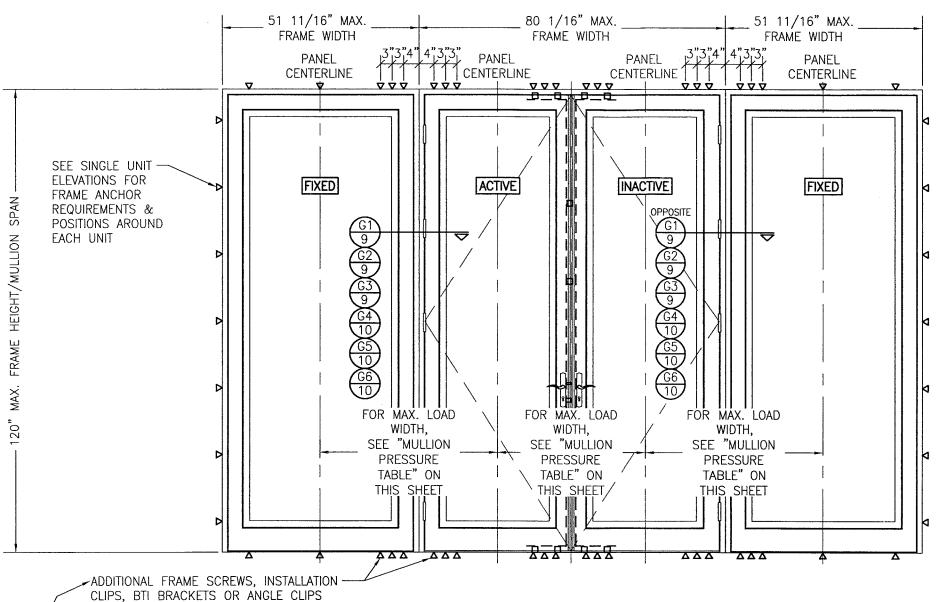

FRAME SCREWS ARE NOT **APPLICABLE** FOR USE WITH FIXED PANEL DOOR SILLS

EXTERIOR ELEVATION; DOUBLE DOORS WITH FIXED PANELS

SCALE: 1/2" = 1'-0"

(RECTANGULAR DOORS SHOWN, SHAPED DOORS ALSO APPLY. SEE "APPROVED SHAPED" TABLE ON SHEETS 3 & 4)

MULTIPLE UNIT NOTES:

WHERE SHOWN AT MULLION ENDS. SEE

"FRAME ANCHOR REQUIREMENTS TABLE"

ON SHEET 1 FOR REQUIREMENTS (BTI

BRACKETS NOT APPLICABLE AT SILL).

- 1. FOR ALL DETAIL NOT SHOWN, SEE INDIVIDUAL UNIT ELEVATIONS.
- 2. THERE IS NO LIMIT ON THE NUMBER OF DOORS THAT MAY BE COMBINED IN ONE DIRECTION INTO ONE OPENING PROVIDING THE OPENING IS DESIGNED TO SUPPORT ALL LOADS TRANSFERED FROM THE DOORS & THEIR MULLIONS.
- 3. OXXO UNIT IS SHOWN. ALL OTHER FIXED/OPERABLE COMBINATIONS ALSO APPLY WITH THE MULLION CONDITIONS SHOWN.
- 4. INDIVIDUAL DOOR/FIXED PANEL SIZES SHALL BE RESTRICTED AS SPECIFIED IN THE SINGLE UNIT ELEVATIONS.

ľ	DESIGN	PRESSUR	i
MAXIMUM MULLION	MAXIMUM LOAD WIDTH		VABLE RE (PSF)
SPAN (IN.)	(IN.)	POS.	NEG.
	52	53.8	53.8
	48	58.3	58.3
120	44	63.6	63.6
120	40	70.0	70.0
	36	70.0	70.0
	32	70.0	70.0
	52	59.8	59.8
	48	64.8	64.8
108	44	70.0	70.0
	40	70.0	70.0
	36	70.0	70.0
	52	70.0	75.2
99	48	70.0	81.5
	46	70.0	85.0
	52	70.0	77.5
96	48	70.0	84.0
	44	70.0	85.0
84	52	70.0	85.0

MULLION ALLOWARIE

NOTES:

- 1. LOAD WIDTH IS THE DISTANCE BETWEEN PANEL CENTERLINES.
- 2. ALLOWABLE UNIT PRESSURE SHALL BE THE LESSER OF THE PRESSURES SHOWN IN THIS TABLE & THOSE SPECIFIED FOR THE INDIVIDUAL DOOR/FIXED PANEL.
- 3. SIZE VALUES IN TABLE ARE $\pm 1/4$ "

PRODUCT REVISED as complying with the Florida Building Code NOA-No. 20-0623.11

Expiration Date 05/27/2024

Ishaq I. Chands

Miami-Dade Product Control

PRODUCT REVISED as complying with the Florida **Building Code** Acceptance No 18-0531.12 Expiration Date 5727/24 Mrs. Bade Product Control

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CHECKED BY:

ATE: 10/08/08

TISCHLER UND SOHN (USA) LTD.
SIX SUBURBAN AVENUE
STAMFORD, CONNECTICUT 06901
203-674-0600

R ENGINEERING P.A. (CA 6809) DURT NORTH ENS, EN 33418

ISULTANTS

W. SCHAEFER

CONSULTING, P
7480 150TH COUR
PALM BEACH GARDENS
PHONE: S61-754


DOORS


PANEL


WOOD


- i

1616 SHEET NO. 5 of 17

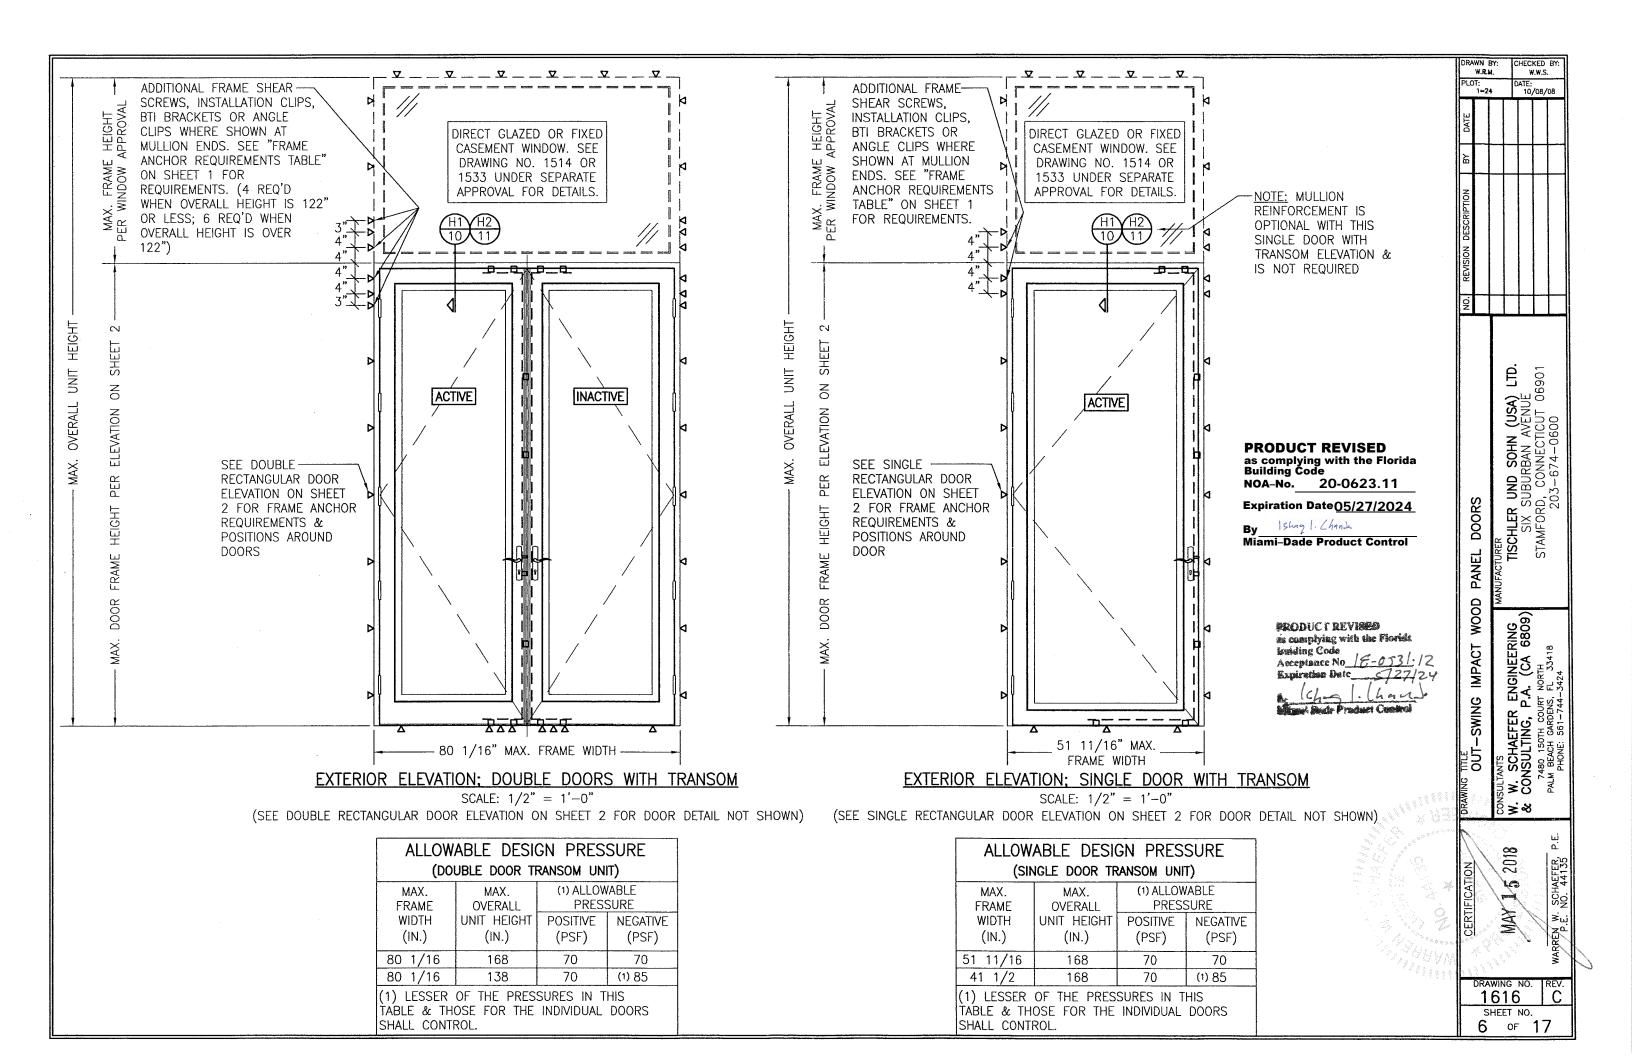

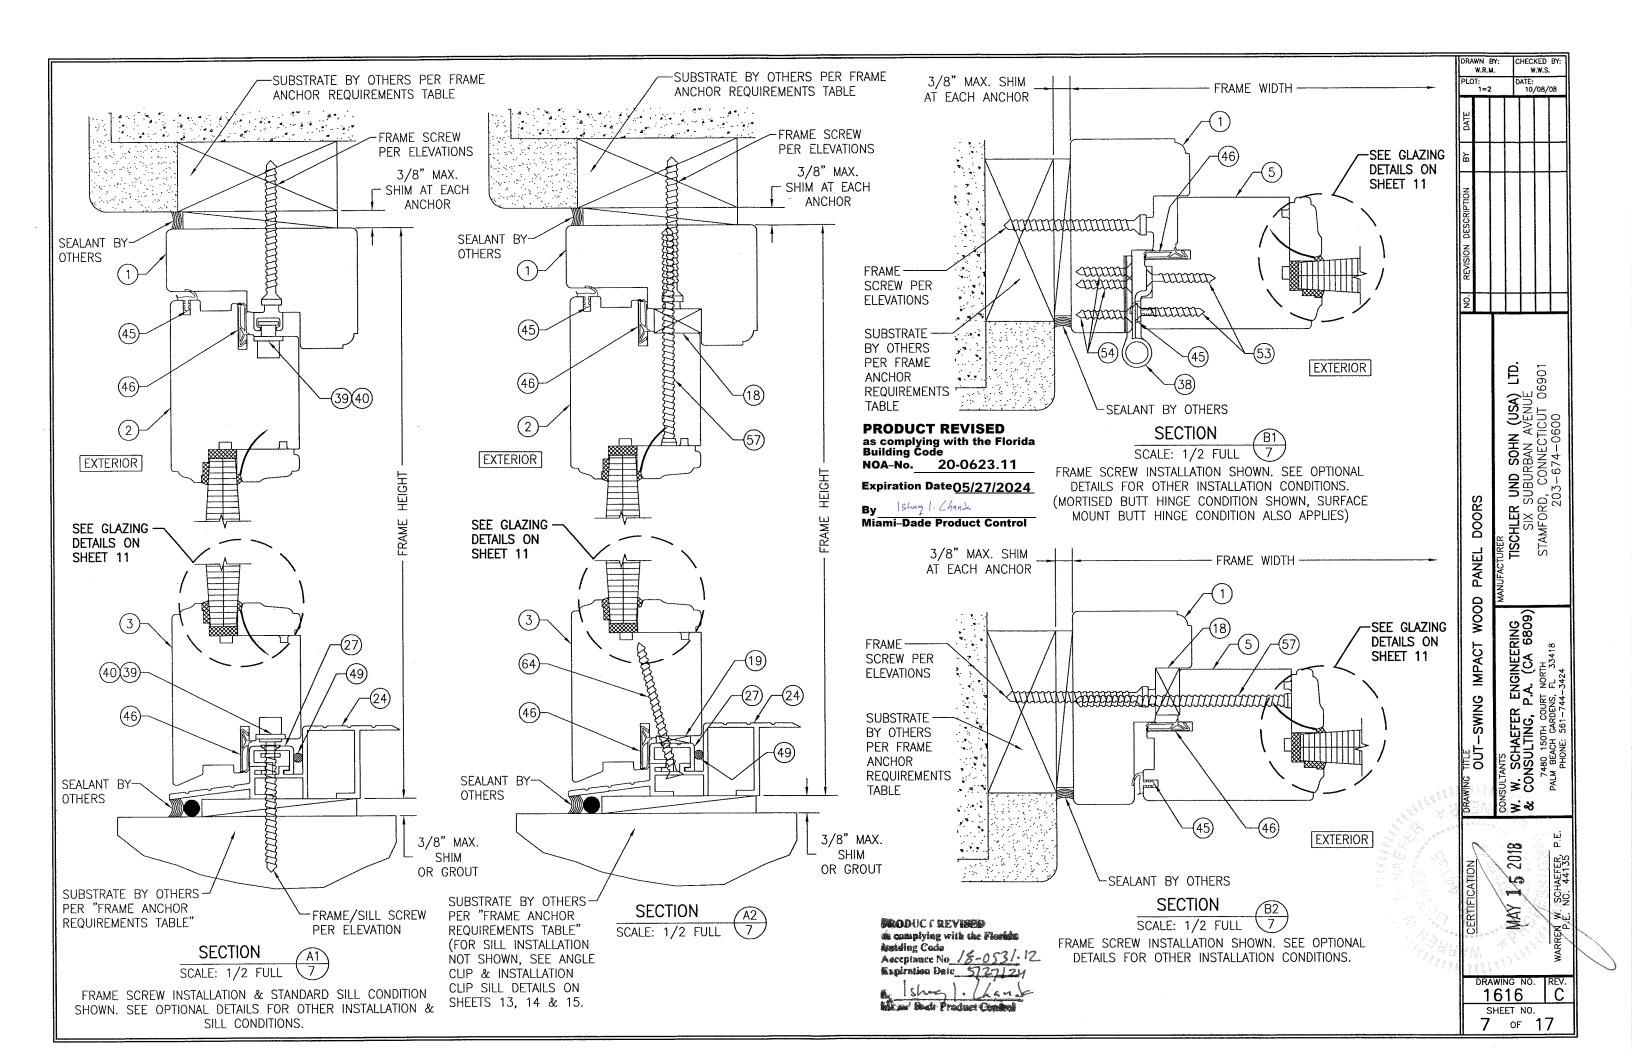

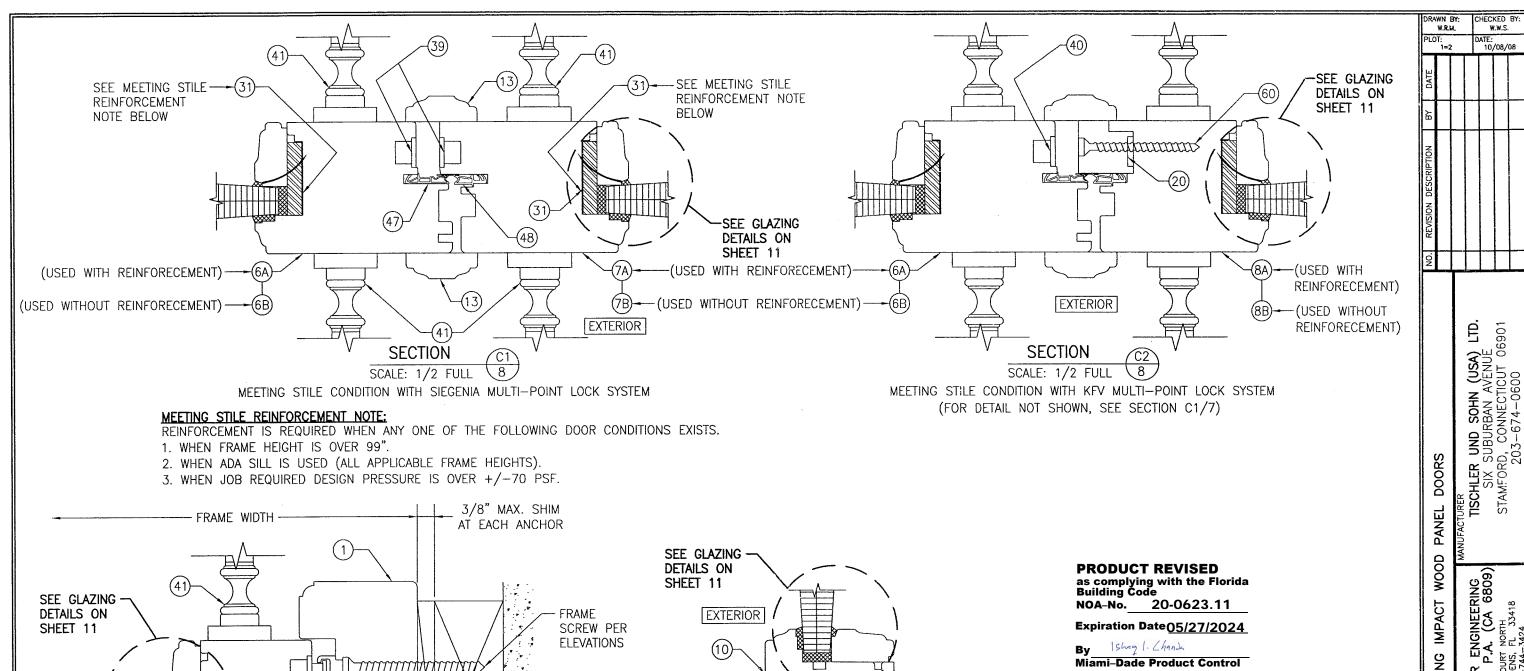

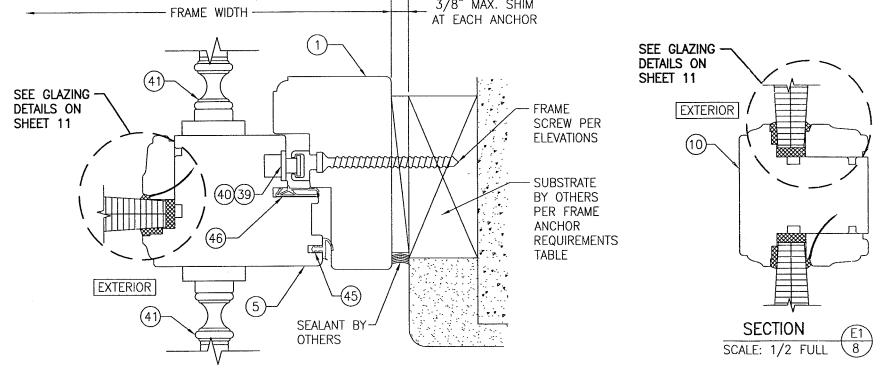

NOA-No. 20-0623.11 Expiration Date 05/27/2024

Ishaq 1. Chands Miami-Dade Product Control

> PRODUCT REVISED as complying with the Florida **building Code**

W. SCHAEFER CONSULTING, P ્ટ્રે ≯્ક્ર 2018


OUT-SWING


1616 SHEET NO. 8 of 17

DETAILS FOR OTHER INSTALLATION CONDITIONS.


SECTION SCALE: 1/2 FULL

FRAME SCREW INSTALLATION SHOWN. SEE OPTIONAL

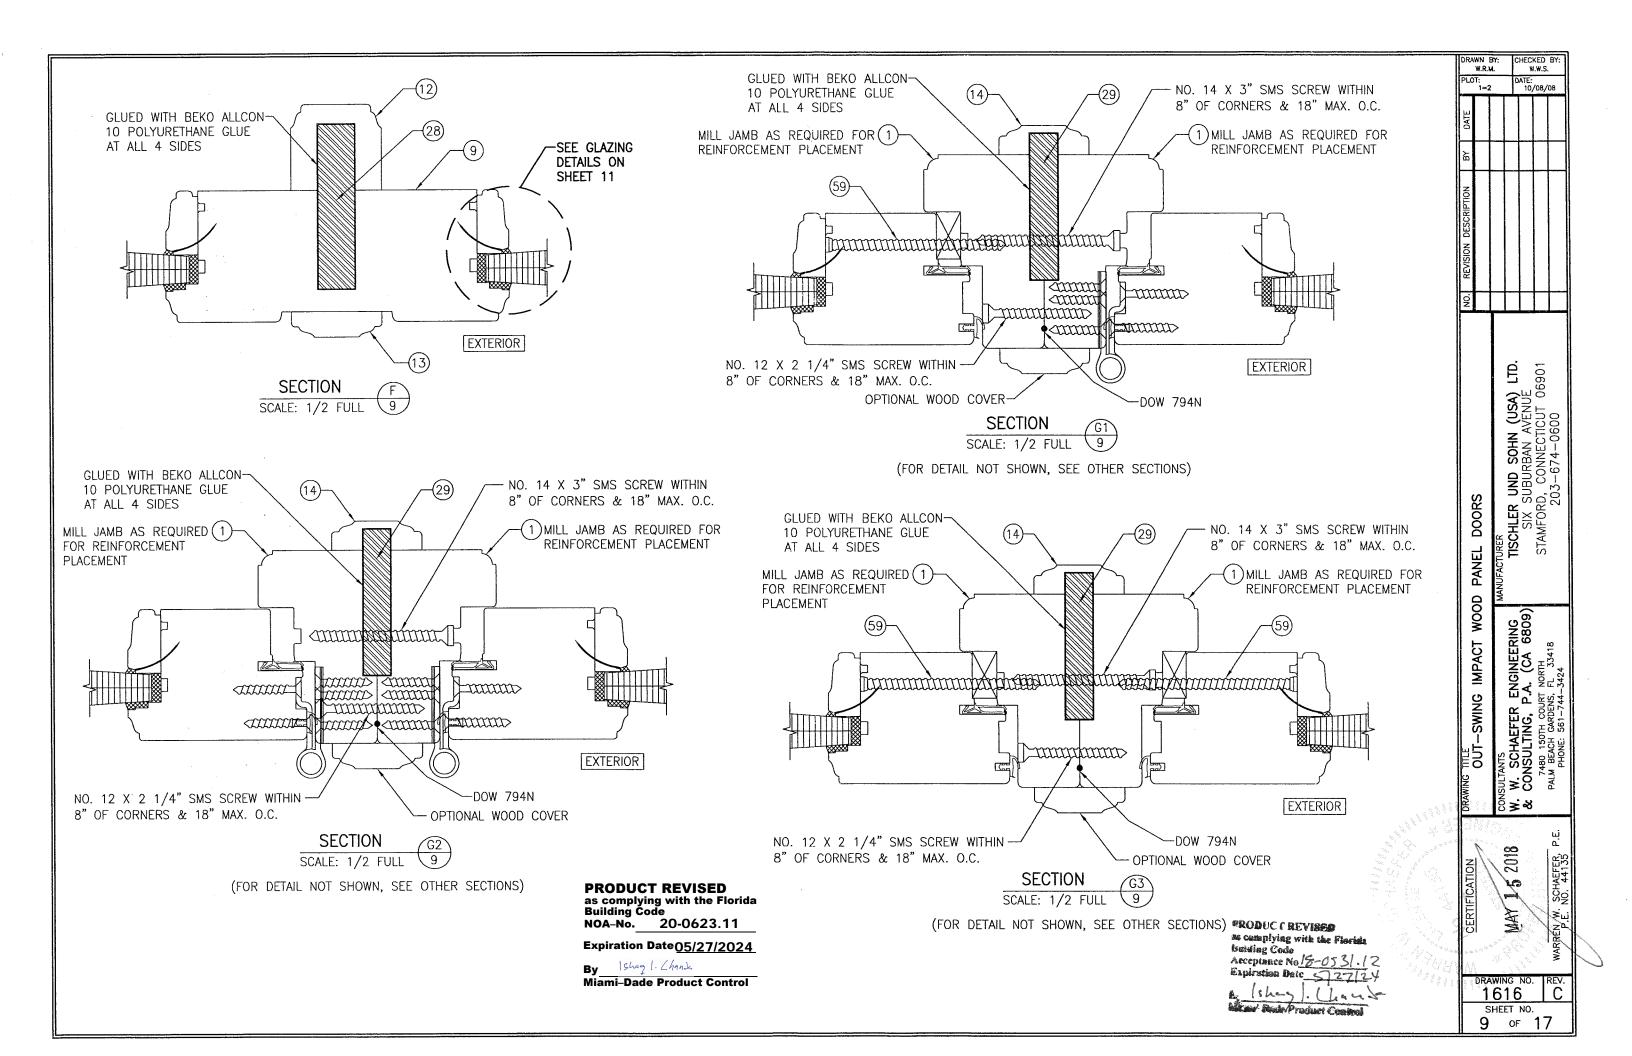


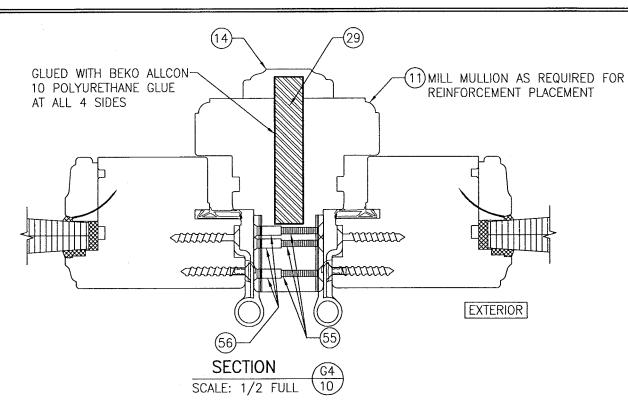

(FOR DETAIL NOT SHOWN, SEE OTHER SECTIONS)

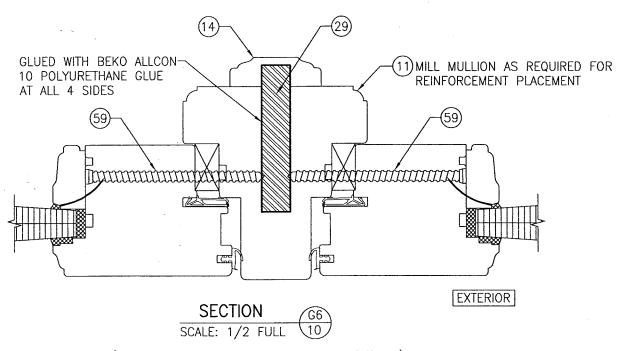

(FOR DETAIL NOT SHOWN, SEE OTHER SECTIONS)

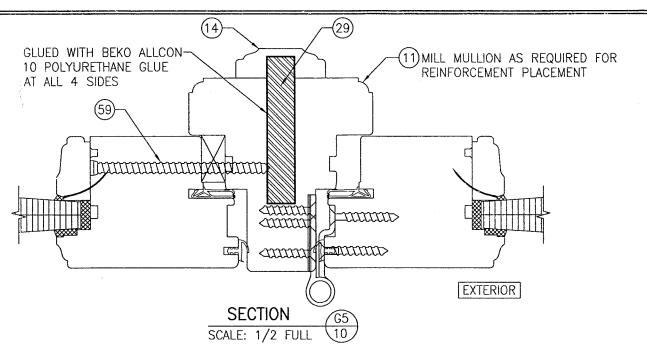


(FOR DETAIL NOT SHOWN, SEE OTHER SECTIONS)

PRODUCT REVISED
as complying with the Florida
Building Code
NOA-No. 20-0623.11

Expiration Date 05/27/2024

By Shap I Chank
Miami-Dade Product Control

CREW

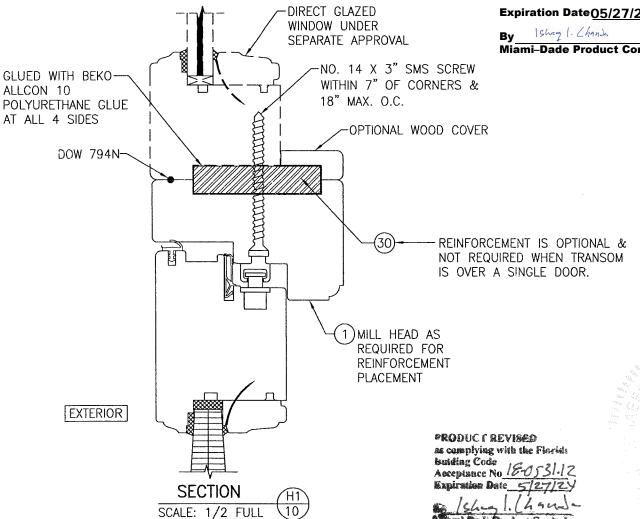

(FOR DETAIL NOT SHOWN, SEE OTHER SECTIONS)

(OPERABLE DOOR CONDITION SHOW, FIXED PANEL DOOR IS MULLED THE SAME)

TISCHLER UND SOHN (USA) LTD.
SIX SUBURBAN AVENUE
STAMFORD, CONNECTICUT 06901
203-674-0600 DOORS PANEL WOOD W. SCHAEFER ENGINEERING
CONSULTING, P.A. (CA 6809)
7480 150TH COURT NORTH
PAIGH GARDENS, FL 33418 IMPACT TITLE OUT-SWING ું કે જ MAY 1,5 2018 1616 SHEET NO.


10 of 17


CHECKED BY:


ATE: 10/08/08


W.R.M.


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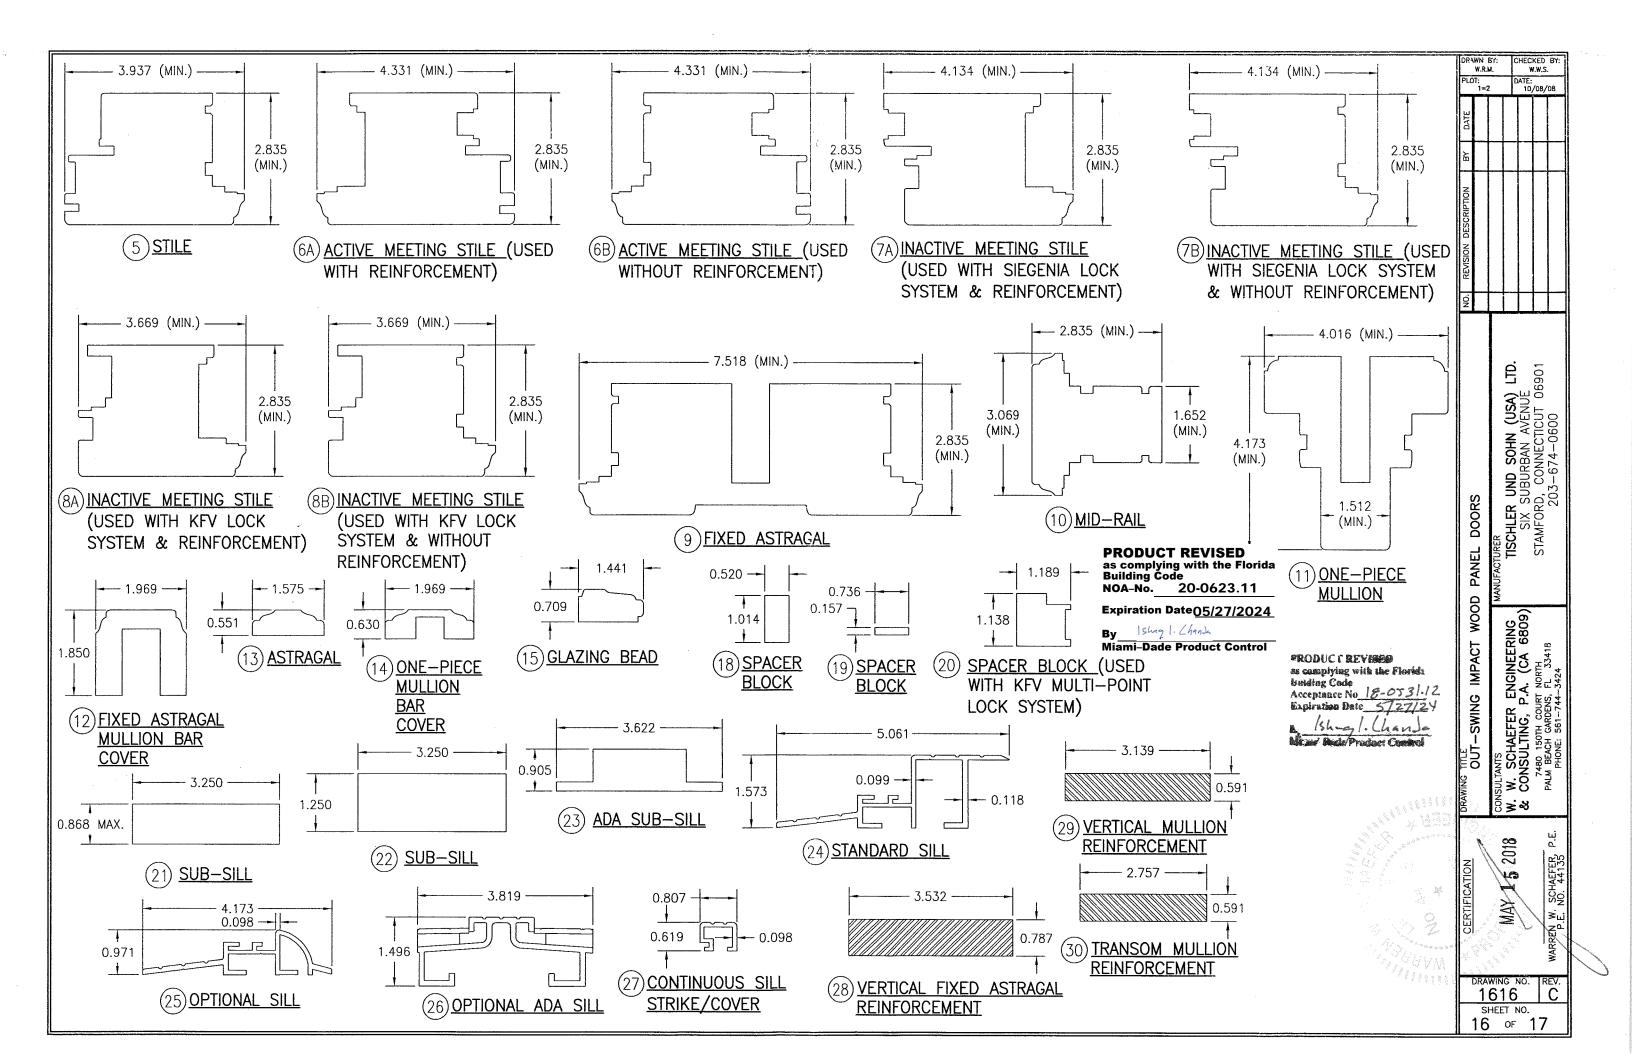


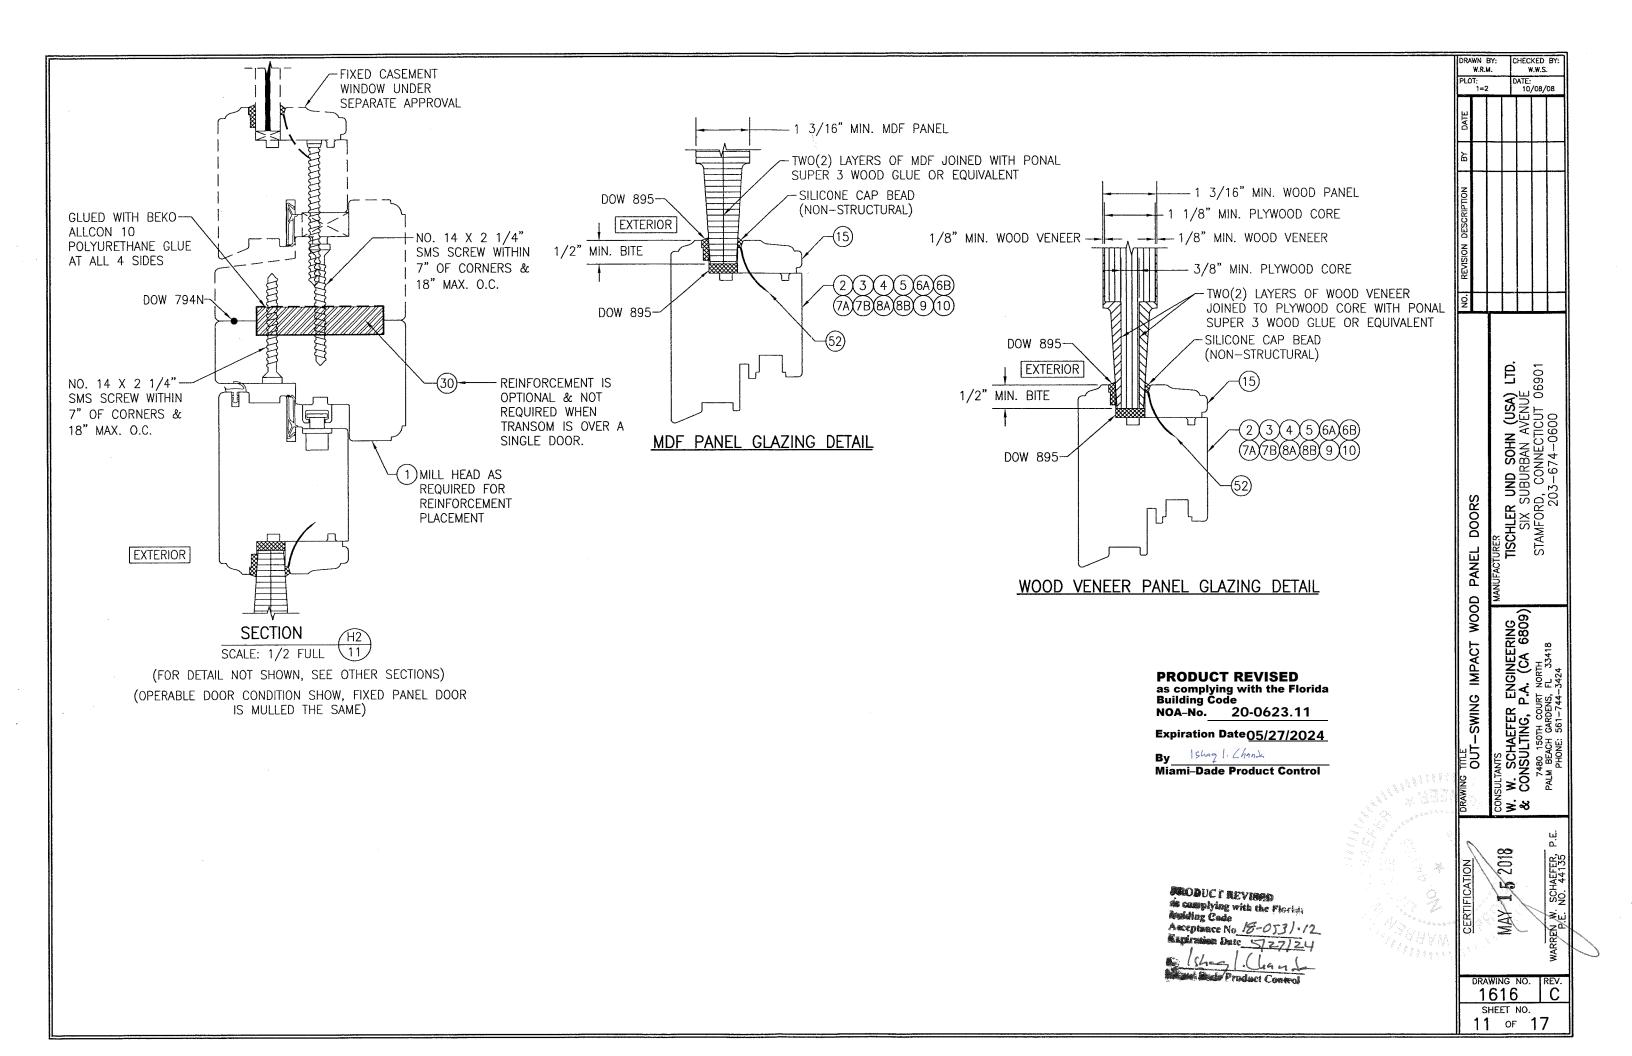

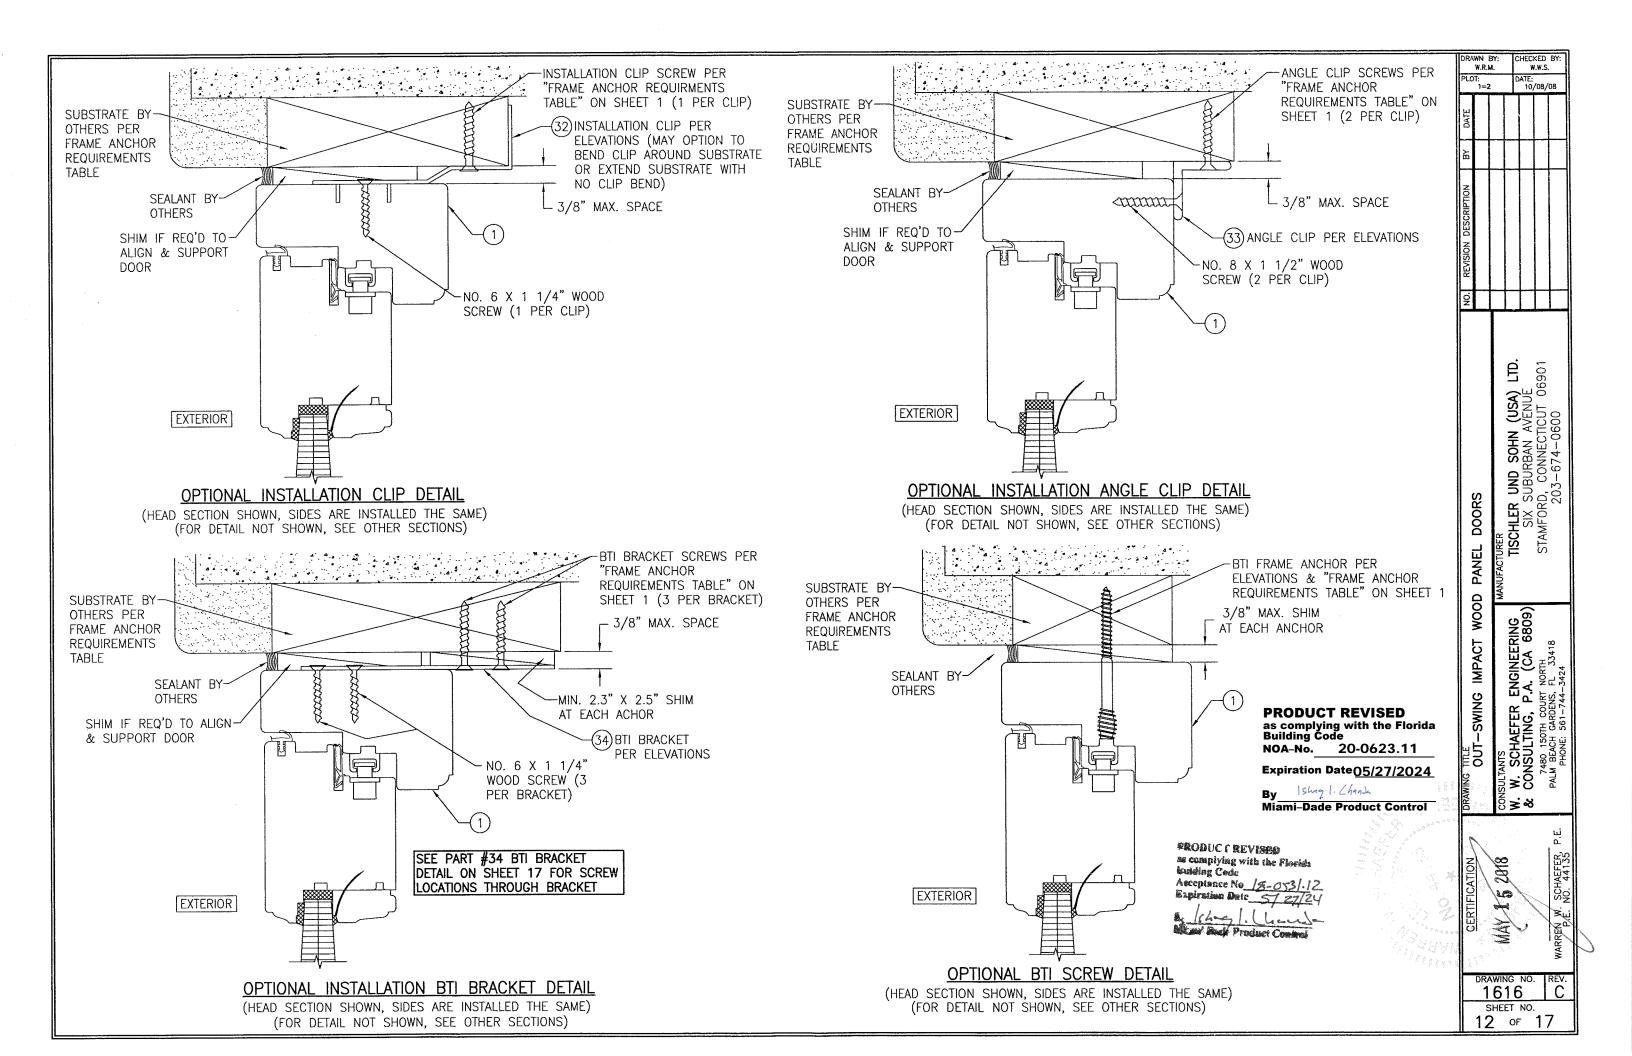

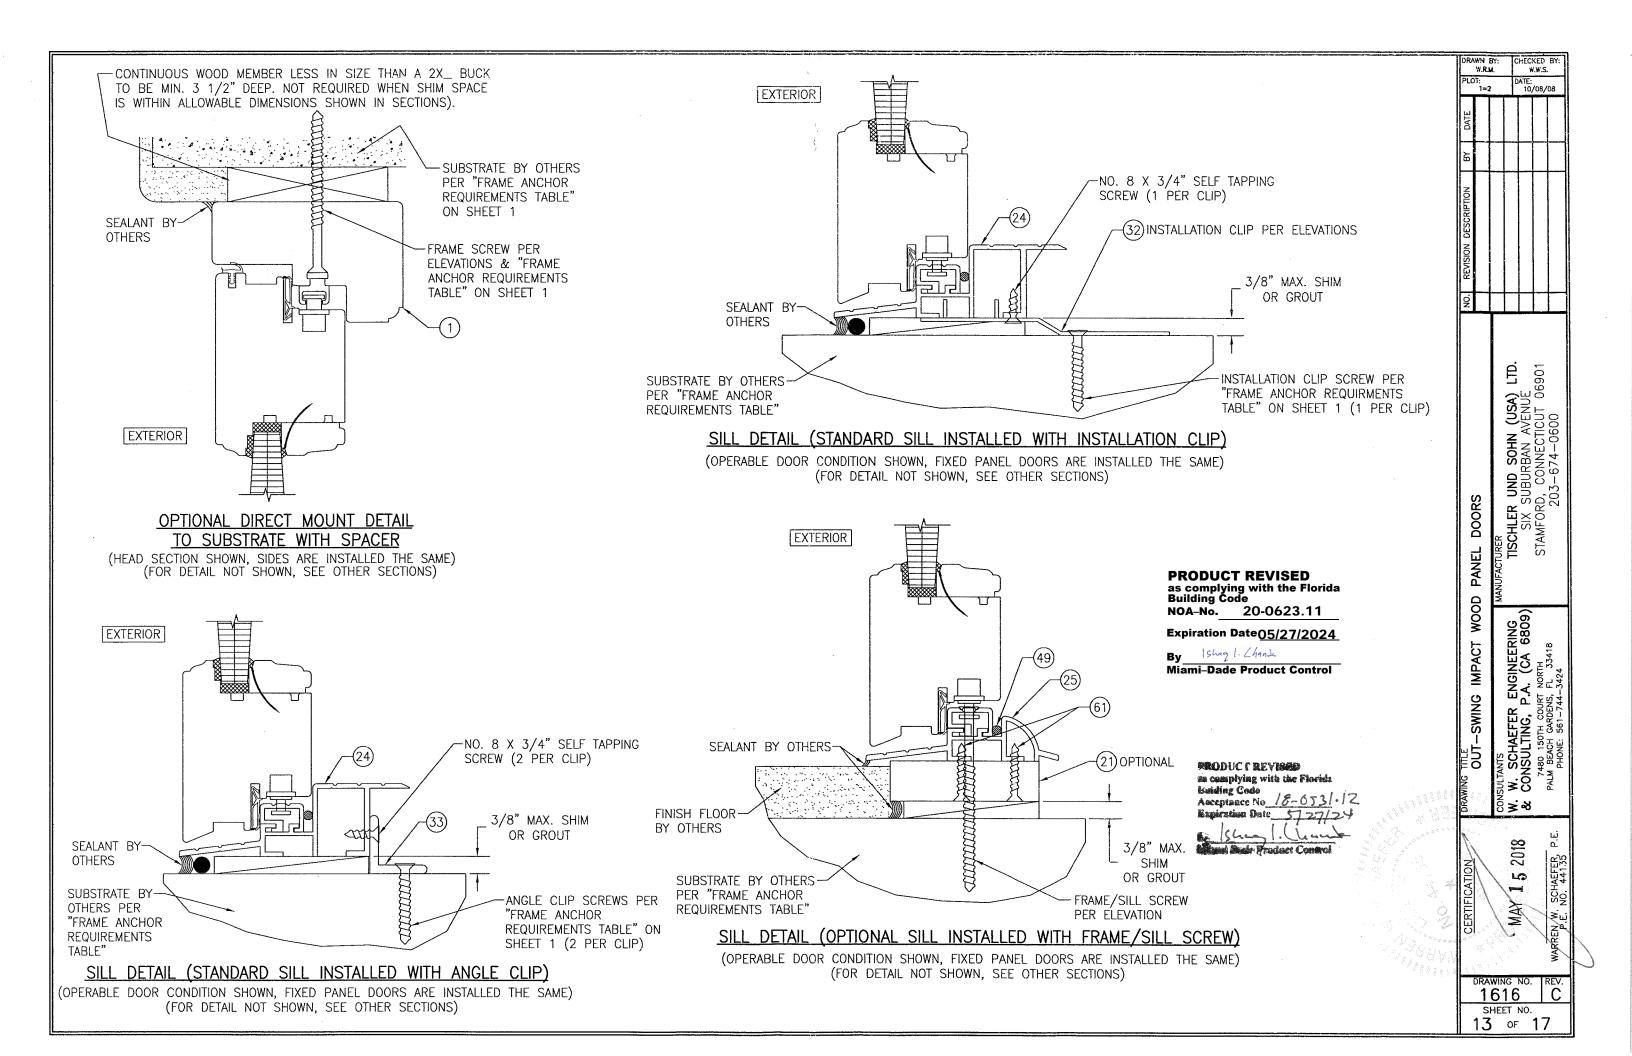

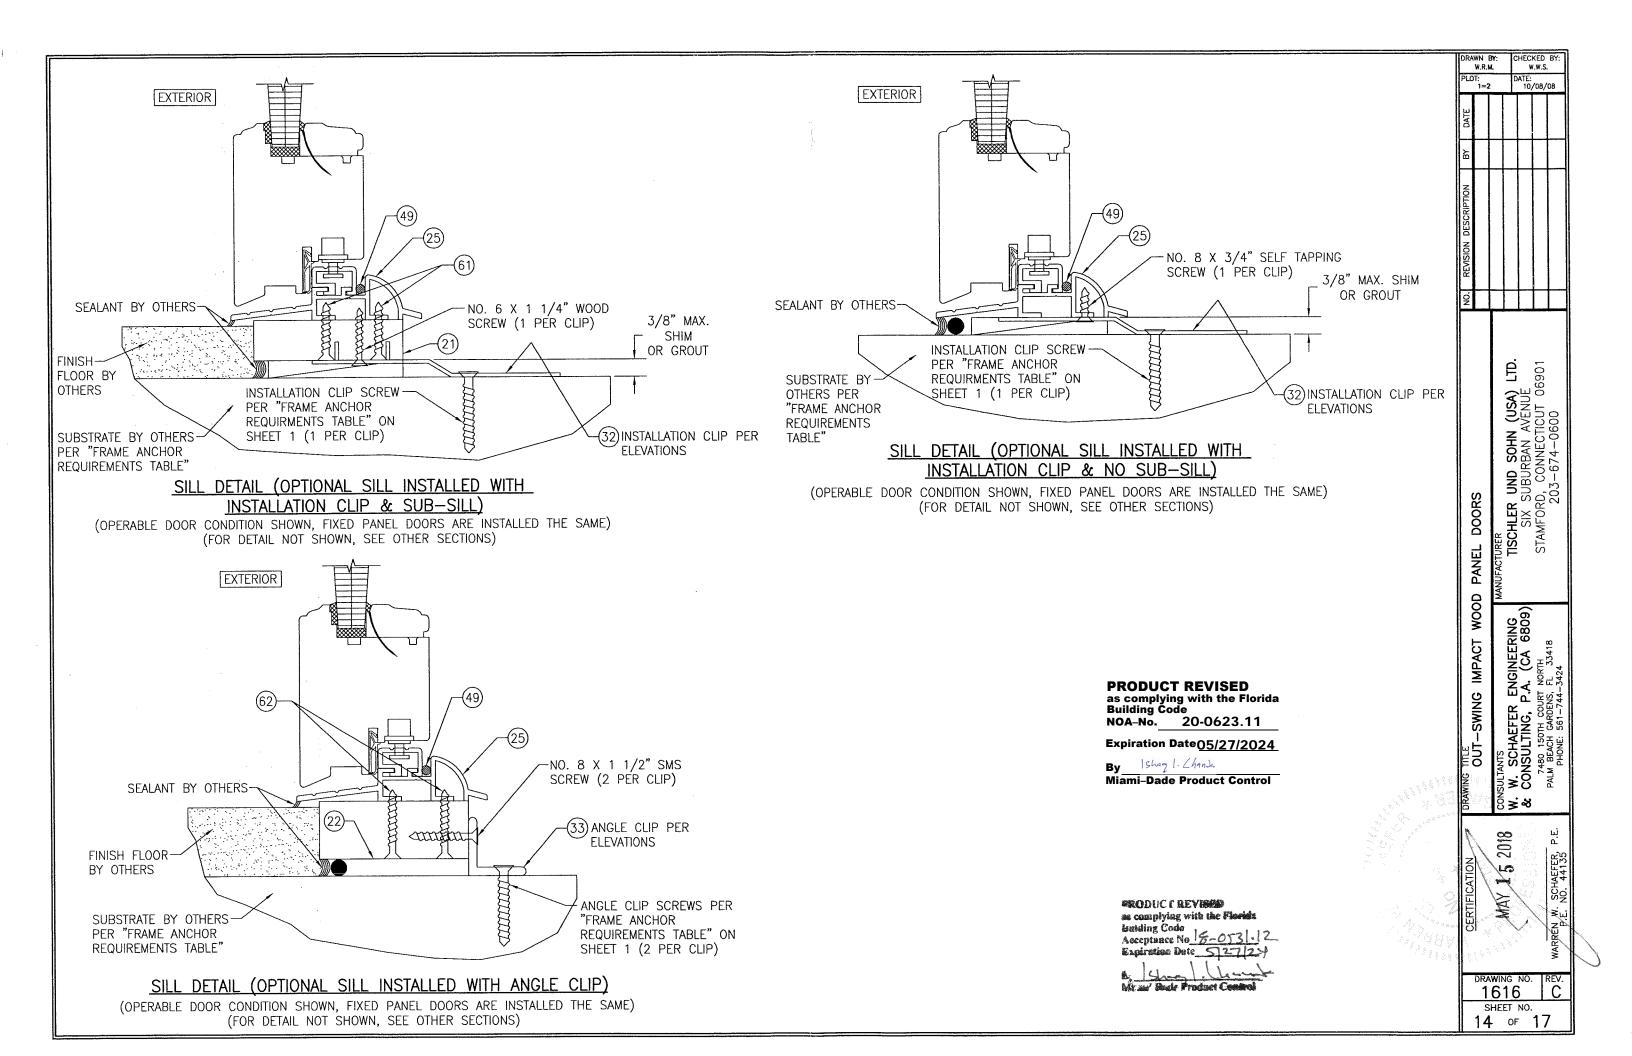

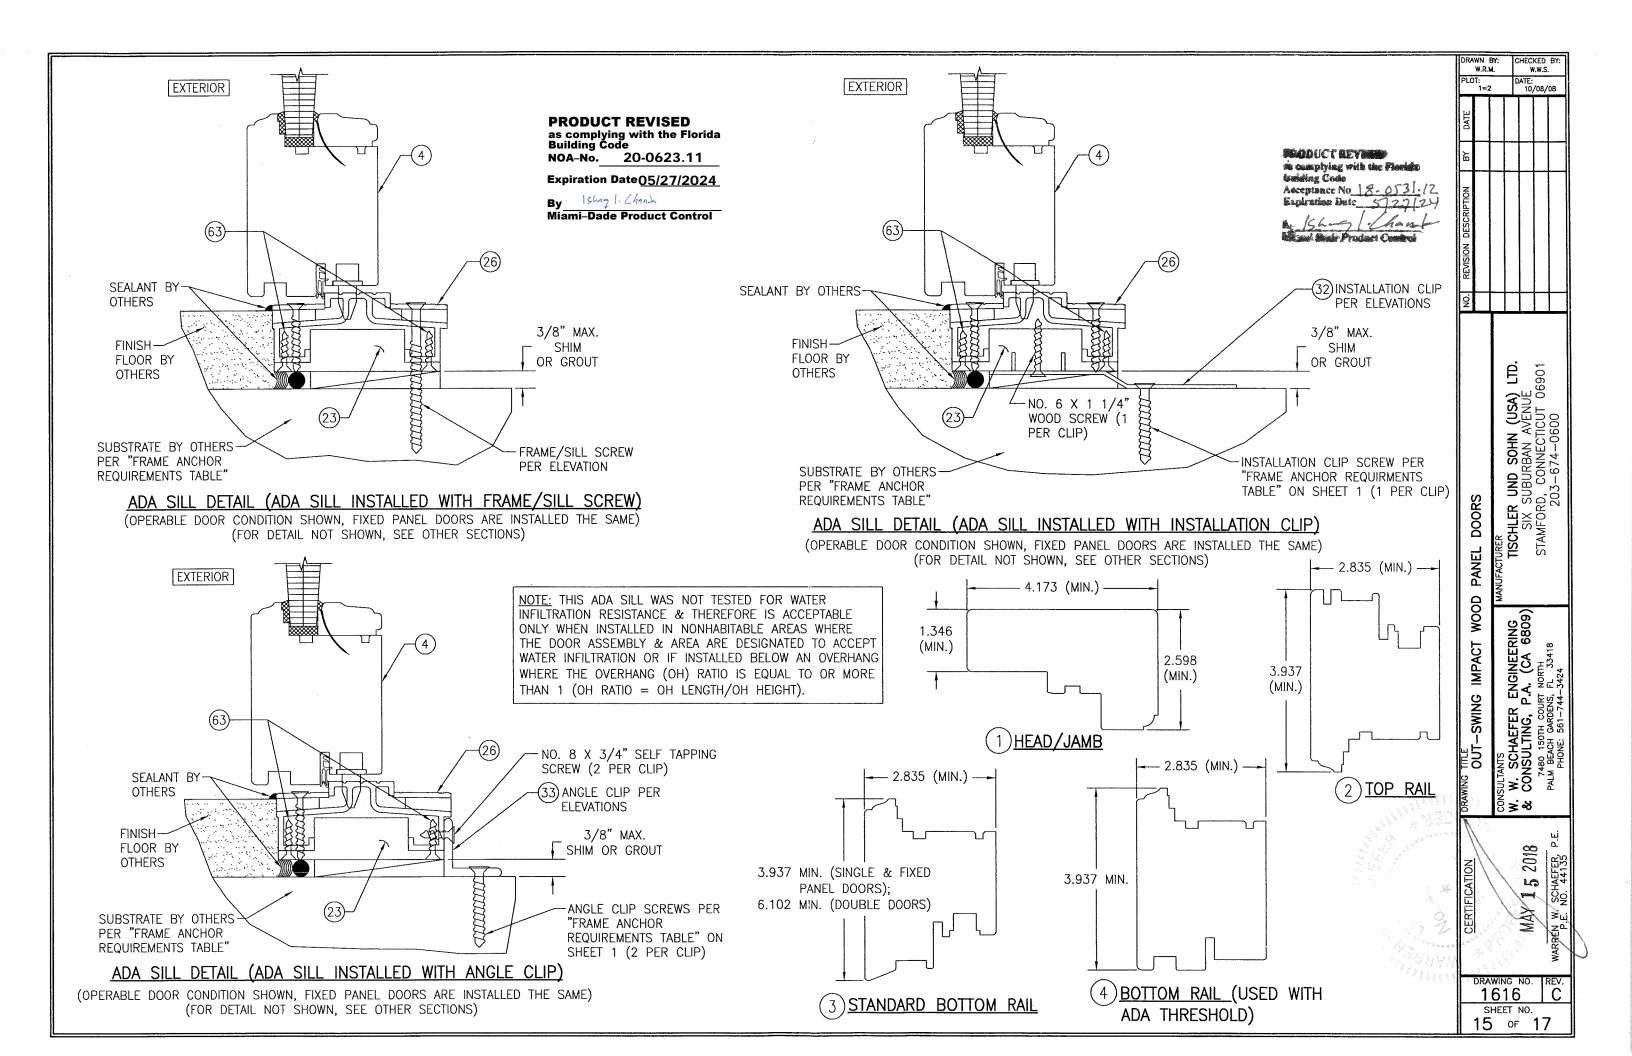

ITEM #	ITEM DESCRIPTION	MANUFACTURER/NOTES	ITEM #	ITEM DESCRIPTION	MANUFACTURER/	NOTES		DRAWN BY: W.R.M.	: CHECKED BY: W.W.S.
	PARTS	1		SEALS & SE	,			PLOT: 1=2	DATE: 10/08/08
1	HEAD/JAMB	MAHOGANY	45 WEATHERSTRI		THERMOPLASTIC ELASTOMER	: BY: DEVENTER			
2	TOP RAIL	MAHOGANY	46 WEATHERSTRI		THERMOPLASTIC ELASTOMER			JATE	
	STANDARD BOTTOM RAIL	MAHOGANY	47 WEATHERSTRI		THERMOPLASTIC ELASTOMER				
4	BOTTOM RAIL (USED WITH ADA THRESHOLD)	MAHOGANY	48 WEATHERSTRI		THERMOPLASTIC ELASTOMER	`		6	
5	STILE	MAHOGANY	49 WEATHERSTRI		THERMOPLASTIC ELASTOMER	···		 	++++-
6A	ACTIVE MEETING STILE	MAHOGANY		FASTENE		,		S	
	(USED WITH REINFORCEMENT)		52 0.06" X 1.26	6" S.S. CURVED NAIL	4" FROM CORNERS & 12"	MAX. O.C.		E L	
6B	ACTIVE MEETING STILE	MAHOGANY		7" WOOD SCREW	2 PER HINGE INTO STILE			ESCF	
	(USED WITHOUT REINFORCEMENT)			B" WOOD SCREW	3 PER HINGE INTO JAMB			Z	
7A	INACTIVE MEETING STILE (USED WITH SIEGENIA	MAHOGANY		/4" MACHINE SCREW	3 PER HINGE			VISIO	
	LOCK SYSTEM & REINFORCEMENT)		56 0.16" THREA	<u> </u>	3 PER HINGE			8	
7B	INACTIVE MEETING STILE (USED WITH SIEGENIA	MAHOGANY	57 0.30" X 4.72	2" BAUTEC WOOD SCREW	WITHIN 8" OF ENDS & 18'	MAX. O.C.		ö	++++
	LOCK SYSTEM & WITHOUT REINFORCEMENT)			BAUTEC WOOD SCREW	WITHIN 8" OF ENDS & 18'			2	
8A	INACTIVE MEETING STILE (USED WITH KFV	MAHOGANY	60 0.18" X 2"		WITHIN 6" OF ENDS & 18'				
	LOCK SYSTEM & REINFORCEMENT)			26" SELF TAPPING SCREW	WITHIN 4" OF ENDS & 13				
8B	INACTIVE MEETING STILE (USED WITH KFV	MAHOGANY		50" SELF TAPPING SCREW	WITHIN 4" OF ENDS & 13				. =
	LOCK SYSTEM & WITHOUT REINFORCEMENT)			7" SELF TAPPING SCREW	WITHIN 4" OF ENDS & 13				LT 590
9	FIXED ASTRAGAL	MAHOGANY		" WOOD SCREW	WITHIN 8" OF ENDS & 18'				JSA) LTD. INUE JT 06901
10	MID-RAIL	MAHOGANY			DGANY WITH A SPECIFIC GRAVITY (
11	ONE-PIECE MULLION	MAHOGANY			= 1,6000,000 PSI. OTHER WOOD S				AVENCTICUT
12	FIXED ASTRAGAL MULLION BAR COVER	MAHOGANY			CT ARE THOSE WITH A SPECIFIC (E
13	ASTRAGAL	MAHOGANY	0.62 AND M	ODULUS OF ELASTICITY OF 1	1,600,000 PSI OR GREATER. ALL	WOOD IS	1 4 050 1		S C S S S S S S S S S S S S S S S S S S
14	ONE-PIECE MULLION BAR COVER	MAHOGANY	MINIMUM GRA	ADE 2 MILLED BY TISCHLER	UND SOHN TO SELECT.		1.250		SUBURE SUBURE RD, CON 203-67
15	GLAZING BEAD	MAHOGANY					- 0.500	DOORS	% Su 20,
	SPACER BLOCK	MAHOGANY						8	TISCHLER SIX S STAMFORE
19	SPACER BLOCK	MAHOGANY	- 0.315				 	H 6	Ĭ Ž Š
20	SPACER BLOCK (USED WITH KFV	MAHOGANY		5.5	500 —			PANEL	. S ⊒
	MULTI-POINT LOCK SYSTEM)			1		2.500 1.500		A A	<u> </u>
21	SUB-SILL	MAHOGANY	.575	707 10 0 1				ll fa	<u>΄</u>
22	SUB-SILL	MAHOGANY		0.787	0 0 0 0		+ +	∥ ö F	
23	ADA SUB-SILL	MAHOGANY		1		<u> </u>		WOOD	8809) 6809)
24	STANDARD SILL	BRONZE	- NEETING	' <u> </u>				11 . 1	88 88 88 88
25	OPTIONAL SILL	BRONZE	31) MEETING		ı			IMPACT	ENGINEER! P.A. (CA 6 IRT NORTH NS, FL 33418 44-3424
26	OPTIONAL ADA SILL	BRONZE	STILE	NT (32)INSTALLATI	ON CLID	<u> </u>		₹	. (CRT 408T
27	CONTINUOUS SILL STRIKE/COVER	BRONZE	REINFORCEME	<u>NT</u> (32) INSTALLATI	ON CLIP	1.250 0.875	┌ 0.188		A. F. S. 4
28	VERTICAL FIXED ASTRAGAL REINFORCEMENT	34 KSI STAINLESS STEEL OR A36 STEEL				1		SWING	S C C C C C C C C C C C C C C C C C C C
29	VERTICAL MULLION REINFORCEMENT	34 KSI STAINLESS STEEL OR A36 STEEL					1	ļ ķ	EN ESS
30	TRANSOM MULLION REINFORCEMENT	34 KSI STAINLESS STEEL OR A36 STEEL		1. 550		(33)	ANGLE CLIP	Life L	See Fig.
31	MEETING STILE REINFORCEMENT	34 KSI STAINLESS STEEL OR A36 STEEL	BRACKET TO FRAME- SCREW LOCATIONS	5.50	JO				W. SCH, W. SCH, CONSUL: 7480 15 PALM BEACH
32	INSTALLATION CLIP	GALVANIZED 54 KSI STEEL	T TOCATIONS			PPOD	UCT REVISED	ING	
33	ANGLE CLIP	6061-T6 ALUMINUM		\\\	BRACKE	「TO as com	plying with the Florida g Code		ટું >ંજ -
34	BTI BRACKET	GALVANIZED 54 KSI STEEL		16 0			g Čode		72 -
	HARDWARE		2.31	$_3$ \setminus \setminus \circ	LOCATIO	· -	o. <u>20-0623.11</u>	·** # # # # # # # # # # # # # # # # # #	<u>ப</u> ்
38	BUTT HINGE	BY: GENIATEC GMBH	1	" Φ ' \	0 / 0	Expirat	ion Date <u>05/27/2024</u>	<u> </u>	All the second s
39	MULTI-POINT LOCK SYSTEM	BY: KFV: STRAIGHT SHOOT		* •		By 19	shag 1. Chanks		2018 FFER,
40	MULTI-POINT LOCK SYSTEM	BY: SIEGENIA AUBI KG TYPE: MUSHROOM	<u> </u>	0 0	* 0	Miami-l	Dade Product Control	18 /	5 2018 SCHAEFER NO. 44135
41	HANDLE	AS REQUIRED TO OPERATE LOCK SYSTEM			0.070	PRODUCT REVISE	. The state of the		
					↓ 0.078	COMENIVER TO THE ACT	H) e Florist	CERTI	M N N N N N N N N N N N N N N N N N N N
						Ascentance No. 14	aral .a 1880	- ~ ′′ ′′ ′′ ′′	一 源
				_	I	Asceptance No 18-	<u>V22.2-2-1</u>	M The	× AF
				(34) <u>BTI_BR</u> /	ACKET	alsheel. Ch	- Hoch	DRAWII	NG NO. REV.
				<u> </u>		Product			16 C
						100		SHE	ET NO.
								17	OF 17