

MIAMI-DADE COUNTY PRODUCT CONTROL SECTION

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www.miamidade.gov/building

DEPARTMENT OF REGULATORY AND ECONOMIC RESOURCES (RER) BOARD AND CODE ADMINISTRATION DIVISION

NOTICE OF ACCEPTANCE (NOA)

Ultimate Door of Palm Beach, Inc. 2800 2nd Avenue North Lake Worth, FL 33461

SCOPE:

This NOA is being issued under the applicable rules and regulations governing the use of construction materials. The documentation submitted has been reviewed and accepted by Miami-Dade County RER -Product Control Section to be used in Miami Dade County and other areas where allowed by the Authority Having Jurisdiction (AHJ).

This NOA shall not be valid after the expiration date stated below. The Miami-Dade County Product Control Section (In Miami-Dade County) and/ or the AHJ (in areas other than Miami-Dade County) reserve the right to have this product or material tested for quality assurance purposes. If this product or material fails to perform in the accepted manner, the manufacturer will incur the expense of such testing and the AHJ may immediately revoke, modify, or suspend the use of such product or material within their jurisdiction. RER reserves the right to revoke this acceptance if it is determined by Miami-Dade County Product Control Section that this product or material fails to meet the requirements of the applicable building code.

This product is approved as described herein and has been designed to comply with the Florida Building Code, including the High Velocity Hurricane Zone.

DESCRIPTION: Series "Direct Set" Aluminum Clad Wood Fixed Window – L.M.I.

APPROVAL DOCUMENT: Drawing No. 1749, titled "Aluminum Clad Wood Impact Direct Glazed Fixed Window", sheets 1 through 5 of 5, dated 04/17/12, with revision A1 dated 11/30/16, prepared by W. W. Schaefer Engineering & Consultant, P.A., signed and sealed by Warren W. Schaefer, P.E., bearing the Miami-Dade County Product Control Revision stamp with the Notice of Acceptance number and expiration date by the Miami-Dade County Product Control Section.

MISSILE IMPACT RATING: Large and Small Missile Impact Resistant

LABELING: Each unit shall bear a permanent label with the manufacturer's name or logo, city, state, series, and following statement: "Miami-Dade County Product Control Approved", unless otherwise noted herein.

RENEWAL of this NOA shall be considered after a renewal application has been filed and there has been no change in the applicable building code negatively affecting the performance of this product.

TERMINATION of this NOA will occur after the expiration date or if there has been a revision or change in the materials, use, and/ or manufacture of the product or process. Misuse of this NOA as an endorsement of any product, for sales, advertising or any other purposes shall automatically terminate this NOA. Failure to comply with any section of this NOA shall be cause for termination and removal of NOA.

ADVERTISEMENT: The NOA number preceded by the words Miami-Dade County, Florida, and followed by the expiration date may be displayed in advertising literature. If any portion of the NOA is displayed, then it shall be done in its entirety.

INSPECTION: A copy of this entire NOA shall be provided to the user by the manufacturer or its distributors and shall be available for inspection at the job site at the request of the Building Official.

This NOA revises NOA No. 17-0803.04 and consists of this page 1 and evidence pages E-1, E-2 and E-3, as well as approval document mentioned above.

The submitted documentation was reviewed by Manuel Perez, P.E.

MIAMI-DADE COUNTY

NOA No. 20-0623.18 **Expiration Date: April 16, 2022** Approval Date: July 30, 2020

Page 1

Ultimate Door of Palm Beach, Inc.

NOTICE OF ACCEPTANCE: EVIDENCE SUBMITTED

1. EVIDENCE SUBMITTED UNDER PREVIOUS NOA's

A. DRAWINGS

- 1. Manufacturer's die drawings and sections. (Submitted under NOA No. 12-0410.12)
- 2. Drawing No. 1749, titled "Aluminum Clad Wood Impact Direct Glazed Fixed Window", sheets 1 through 5 of 5, dated 04/17/12, with revision A1 dated 11/30/16, prepared by W.W. Schaefer Engineering & Consulting, P.A., signed and sealed by Warren W. Schaefer, P.E.

(Submitted under NOA No. 16-1205.01)

B. TESTS

- 1. Test reports on: 1) Air Infiltration Test, per FBC, TAS 202-94.
 - 2) Uniform Static Air Pressure Test Loading, per FBC, TAS 202-94.
 - 3) Water Resistance Test, per FBC, TAS 202-94.
 - 4) Large Missile Impact Test, per FBC, TAS 201-94.
 - 5) Cyclic Wind Pressure Loading, per FBC, TAS 203-94.

along with marked—up drawings and installation diagram of four (rectangular and curved-top) direct set wood fixed windows, and one rectangular mulled configuration, prepared by Architectural Testing, Test Report No. **B5667.01-450-18A**, dated 05/03/12, signed and sealed by Vinu J. Abraham, P.E.

(Submitted under NOA No. 12-0410.12)

C. CALCULATIONS

- 1. Anchor verification calculations and structural analysis, complying with FBC-5th Edition (2014), dated 05/27/11 and updated on 11/30/16, prepared by W. W. Schaefer Engineering & Consultant, P.A., signed and sealed by Warren W. Schaefer, P.E. (Submitted under NOA No. 16-1205.01)
- 2. Glazing complies with ASTM E1300-04

D. **QUALITY ASSURANCE**

1. Miami-Dade Department of Regulatory and Economic Resources (RER).

E. MATERIAL CERTIFICATIONS

1. Notice of Acceptance No. 14-0916.11 issued to Kuraray America, Inc. for their "SentryGlas® (Clear and White) Glass Interlayers" dated 06/25/15, expiring on 07/04/18.

Manuel Perez, P.E. Product Control Examiner NOA No. 20-0623.18

Expiration Date: April 16, 2022 Approval Date: July 30, 2020

Ultimate Door of Palm Beach, Inc.

NOTICE OF ACCEPTANCE: EVIDENCE SUBMITTED

F. STATEMENTS

- 1. Statement letter of conformance to FBC 5th Edition (2014) and FBC 6th Edition (2017), dated 07/21/17, issued by W. W. Schaefer Engineering & Consultant, P.A., signed and sealed by Warren W. Schaefer, P.E.
 - (Submitted under NOA No. 17-0803.04)
- 2. Statement letter of independence and of no financial interest, dated 11/30/16, issued by W. W. Schaefer Engineering & Consultant, P.A., signed and sealed by Warren W. Schaefer, P.E.
 - (Submitted under NOA No. 16-1205.01)
- 3. Laboratory compliance letter for Test Report No. **B5667.01-450-18A**, issued by Architectural Testing, dated 05/03/12, signed and sealed by Vinu J. Abraham, P.E. (Submitted under NOA No. 12-0410.12)

G. OTHERS

1. Notice of Acceptance No. **16-1205.01**, issued to Ultimate Door of Palm Beach, Inc. for their Series "Direct Set" Aluminum Clad Wood Fixed Window – L.M.I., approved on 02/02/17 and expiring on 04/16/22.

Manuel Perez, P.E.
Product Control Examiner
NOA No. 20-0623.18/
Expiration Date: April 16, 2022

Approval Date: July 30, 2020

Ultimate Door of Palm Beach, Inc.

NOTICE OF ACCEPTANCE: EVIDENCE SUBMITTED

- 2. NEW EVIDENCE SUBMITTED
- A. DRAWINGS
 - 1. None.
- B. TESTS
 - 1. None.
- C. CALCULATIONS
 - 1. None.
- D. QUALITY ASSURANCE
 - 1. Miami-Dade Department of Regulatory and Economic Resources (RER).

E. MATERIAL CERTIFICATIONS

1. Notice of Acceptance No. 18-0725.11 issued to Kuraray America, Inc. for their "Kuraray SentryGlas® Xtra™ (SGX™) Clear Glass Interlayer" dated 05/23/19, expiring on 05/23/24.

F. STATEMENTS

1. Statement letter of conformance, complying with FBC 6th Edition (2017) and FBC 7th Edition (2020) dated June 05, 2020, issued by W.W. Schaefer Engineering & Consulting, P.A., signed and sealed by Warren W. Schaefer, P.E.

G. OTHERS

1. Notice of Acceptance No. 17-0803.04, issued to Ultimate Door of Palm Beach, Inc. for their Series "Direct Set" Aluminum Clad Wood Fixed Window – L.M.I., approved on 10/26/17 and expiring on 04/16/22.

Manuel Perez, P.E.
Product Control Examiner
NOA No. 20-0623.18
Expiration Date: April 16, 2022

Approval Date: July 30, 2020

GENERAL NOTES:

1. THIS PRODUCT HAS BEEN TESTED, ANALYZED & APPROVED FOR DESIGN PRESSURES NOT TO EXCEED THOSE SHOWN IN THE "ALLOWABLE DESIGN PRESSURE

2. OPENINGS, BUCKING & BUCKING FASTENERS MUST BE PROPERLY DESIGNED &

INSTALLED TO TRANSFER WIND LOADS TO THE STRUCTURE.

3. ALL HARDWARE & FASTENERS SHALL BE IN ACCORDANCE WITH THESE DRAWINGS & SHALL NOT VARY UNLESS SPECIFICALLY MENTIONED ON THE DRAWINGS. SPECIFIED ANCHOR EMBED TO BASE MATERIAL SHALL BE BEYOND WALL

4. THE DETAILS & SPECIFICATIONS SHOWN HEREIN REPRESENT THE PRODUCTS TESTED & PROPOSED FOR CONFORMANCE WITH THE FLORIDA BUILDING CODE PROTOCOLS TAS-201, 202 & 203 FOR LARGE MISSILE IMPACT PRODUCTS.

5. THIS PRODUCT HAS BEEN DESIGNED IN ACCORDANCE WITH AND MEETS THE REQUIREMENTS OF THE FLORIDA BUILDING CODE (FBC) INCLUDING HIGH VELOCITY HURRICANE ZONES (HVHZ).

6. IMPACT SHUTTERS ARE NOT REQUIRED WITH THIS PRODUCT.

7. ALL ANCHORS SECURING PRODUCT FRAMES TO PRESSURE TREATED BUCKS OR WOOD FRAMING SHALL BE CAPABLE OF RESISTING CORROSION CAUSED BY THE

PRESSURE TREATING CHEMICALS IN THE WOOD.

8. DETERMINE THE POSITIVE & NEGATIVE DESIGN LOADS TO USE WHEN REFERENCING THESE DOCUMENTS IN ACCORDANCE WITH THE GOVERNING CODE AND GOVERNING WIND VELOCITY. FOR WIND LOAD CALCULATIONS IN ACCORDANCE WITH THE FLORIDA BUILDING CODE, A DIRECTIONALITY FACTOR OF Kd = 0.85 MAY BE APPLIED PER THE ASCE-7 STANDARD.

9. NO INCREASE IN ALLOWABLE STRESS HAS BEEN USED IN THE CERTIFICATION OF THIS PRODUCT. WIND LOAD DURATION FACTOR Cd = 1.6 WAS USED FOR

WOOD SCREW ANALYSIS ONLY.


KWIK-CON I! (C.S OR S.S.).

10. MATERIALS, INCLUDING BUT NOT LIMITED TO STEEL SCREWS, THAT COME INTO CONTACT WITH OTHER DISSIMILAR MATERIALS SHALL MEET THE REQUIREMENTS OF FLORIDA BUILDING CODE.

11. All WOOD MEMBERS OF THIS PRODUCT THAT MAY POSSIBLY COME INTO CONTACT WITH MASONRY OR CONCRETE SUBSTRATES, ARE SUBJECT TO MOISTURE &/OR ARE SUBJECT TO THE OUTSIDE ENVIRONMENT SHALL BE OF AN APPROVED DURABLE SPECIES OR BE TREATED IN AN APPROVED METHOD WITH AN APPROVED PRESERVATIVE PER FBC REQUIREMENTS.

CORNER CONSTRUCTION:

WOOD FRAME: MEMBERS ARE COPED, BUTTED AND JOINED WITH (1)ONE NO. 10 X 3 1/2" GALVANIZED WOOD SCREW THROUGH THE HORIZONTAL FRAME MEMBERS INTO THE VERTICAL MEMBERS & (2)TWO NO. 8 X 2 1/2" GALVANIZED WOOD SCREWS THROUGH THE VERTICAL MEMBER INTO THE HORIZONTAL MEMBERS. CORNERS SEALED WITH DOW 795. FRAME CLAD: MEMBERS ARE MITERED AND JOINED WITH (2)TWO NO. 6 X 2" SMS SCREWS INTO THE SCREW SPLINE. CORNERS ARE SEALED WITH DOW 795 SILICONE SEALANT.

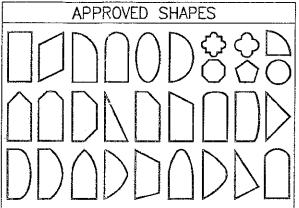

. OTHER SHAPES MAY APPLY PROVIDING THEY ARE SIMILAR TO THOSE SHOWN & HAVE CORNER CONSTRUCTION AS DESCRIBED

2. ALL SHAPED UNITS MUST FIT INSCRIBED INTO THE ALLOWABLE RECTANGULAR UNITS & BE GOVERNED BY THE ALLOWABLE PRESSURE OF THE RESPECTIVE RECTANGULAR UNIT.

MAY BE 1/2" MIN. WHEN SCREW IS ANGLED INTO BUCK AS SHOWN IN SECTION A2/4.

| FRAME ANCHUR REQUIREMENTS TABLE | | | | | | |
|--|------------------------------------|------------------|-----------------------|--|--|--|
| OPENING TYPE (SUBSTRATE) | FRAME/FIN TO OPENING FASTENER TYPE | MINIMUM EMBED | MINIMUM EDGE DIST. | | | |
| FRAME SCREWS | | | | | | |
| MIN. 2X4 WOOD FRAME OR BUCK (MIN. GR. 3 & G=0.55) | NO. 12 SMS OR WOOD SCREW | 1 1/4" | 7/8" | | | |
| MIN. 16 GA. 33 KSI METAL STUD | NO. 12 GR. 5 SELF TAP/DRILL SCREW | FULL | 1/2" | | | |
| MIN. 1/8" THK A36 STEEL | NO. 12 GR. 5 SELF TAP/DRILL SCREW | FULL | 1/2" | | | |
| MIN. 1/8" THK 6063-T5 ALUM. | NO. 12 GR. 5 SELF TAP/DRILL SCREW | FULL | 1/2" | | | |
| MIN. C-90 CMU OR 2500 PSI CONCRETE | (1) 1/4" CONCRETE SCREW | 1 1/4" | 2" | | | |
| NAILING FIN FASTENERS | | | | | | |
| MIN. 2X4 WOOD FRAME OR BUCK (MIN. GR. 3 & G=0.55) | NO. 8 SMS SCREW | 1 1/8" | 1/2" | | | |
| MIN. 1/8" THK A36 STEEL | NO. 8 GR. 5 SELF TAP/DRILL SCREW | FULL | 1/2" | | | |
| MIN. 1/8" THK 6063-T5 ALUM. | NO. 8 GR. 5 SELF TAP/DRILL SCREW | FULL | 1/2" | | | |

COALIC ANOHOD DECURENCE TABLE

(1) CONCRETE SCREWS SHALL BE ELCO ULTRACONS (C.S.), ELCO CRETE-FLEX (S.S.) OR HILTI

PRODUCT REVISED as complying with the Florida **Building Code** 20-0623.18

Expiration Date: 04/16/2022

Miami-Dade Product Control

PRODUCT REVISED as complying with the Florida Building Code 17-0803.04 NOA-No.

Expiration Date 04/16/2022

Miami-Dade Product Control

022 PRODUCT REVISED as complying with the Florida Building Code
Acceptance No 16-1205.01
Expiration Date April 16, 2022
By Manuel Stop
Miami/Dade Product Control **Building Code**

THESE DRAWINGS ARE APPLICABLE ONLY TO THE PRODUCT DRAWN BY:
SPECIFIED, THEY MAY NOT BE USED FOR THE ASSEMBLY WR.M.

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WINDOW

FIXED

GLAZED

DIRECT

IMPACT

WOOD

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ULTIMATE

04/17/12

AND/OR INSTALLATION OF ANY OTHER PRODUCT NOR MAY

THEY BE USED FOR RATIONAL AND/OR LOCAL APPROVAL OF ANY PRODUCT NOT PRODUCED BY THE MANUFACTURER

NS CHAEFER ENGINEERING
CONSULTING, P.A. (CA 6809)
7480 150TH COURT NORTH
PALM BEACH GARDENS, FL 33418
PHONE: 561-744-3424 ALUMINUM हें ≽ ∻४ SCHAEFER, NO. 44135 NOV-80 1749 SHEET NO.

1 OF

ALLOWABLE SINGLE WINDOW SIZE/PRESSURE TABLE (GLASS OPTIONS 1 & 3) MAXIMUM MAXIMUM ALLOWABLE FRAME FRAME **PRESSURE** LONG SHORT (PSF) DIMENSION DIMENSION (IN.) (IN.)POS. NEG. 32 65.0 65.0 65.0 69.3 30 144 27 65.0 | 75.0 65.0 66.7 34 132 30 65.0 75.0 38 65.0 | 65.7 65.0 69.3 36 120 33 65.0 | 75.0 65.0 42 66.0 108 37 65.0 75.0 45 63.8 | 63.8 65.0 70.5 42 100 65.0 75.0 38 65.0 | 65.0 48 42 65.0 71.3 96 39 65.0 75.0 65.0 | 66.5 48 65.0 72.7 42 90 40 65.0 | 75.0 65.0 68.3 48 65.0 42 74.3 84 65.0 75.0 41 65.0 48 70.4 78 42 65.0 75.0 48 65.0 73.1 72 45 65.0 75.0 65.0 75.0 66 48 1. WINDOW SIZES SHOWN ARE

MAXIMUM SIZES. SMALLER SIZES SHALL APPLY TO LOADS EQUAL TO THE NEAREST LARGER SIZE SHOWN IN TABLE,


2. LONG DIMENSION MAY BE HORIZONTAL OR VERTICAL 3. DIMENSIONS SHOWN ARE

+/-1/2".

ALLOWABLE SINGLE WINDOW SIZE/PRESSURE TABLE

| (GLASS OPTIONS 2 & 4) | | | | | |
|---------------------------|---------------------------|--------------------------------|------|--|--|
| MAXIMUM FRAME LONG | MAXIMUM FRAME SHORT | ALLOWABLE PRESSURE (PSF) | | | |
| DIMENSION (IN.) | DIMENSION (IN.) | GLASS OPTIONS 2 & 4 | | | |
| | | POS. | NEG. | | |
| 144 | 50 | 75.0 | 75.0 | | |
| | 44 | 75.0 | 85.0 | | |
| 132 | 54 1/2 | 75.0 | 75.0 | | |
| | 48 | 75.0 | 85.0 | | |
| 120 | 60 | 75.0 | 75.0 | | |
| | 52 | 75.0 | 85.0 | | |
| 108 | 66 3/4 | 75.0 | 75.0 | | |
| | 52 | 75.0 | 85.0 | | |
| 100. | 72 | 75.0 | 75.0 | | |
| | 52 | 75.0 | 85.0 | | |
| 1. WINDOW SIZES SHOWN ARE | | | | | |

MAXIMUM SIZES. SMALLER SIZES SHALL APPLY TO LOADS EQUAL TO THE NEAREST LARGER SIZE SHOWN IN TABLE. 2. LONG DIMENSION MAY BE HORIZONTAL OR VERTICAL

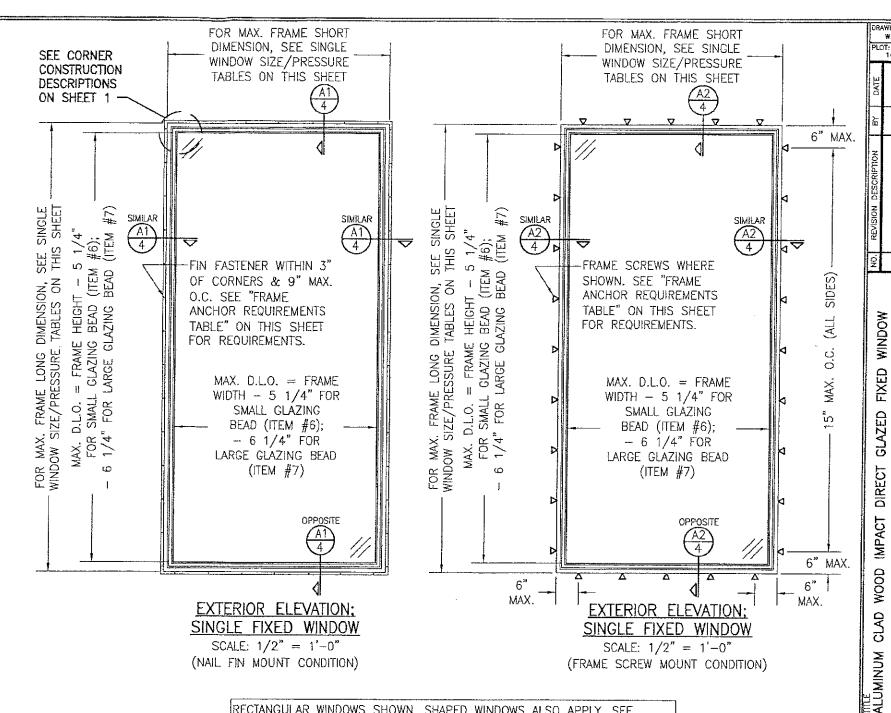

RECTANGULAR WINDOWS SHOWN. SHAPED WINDOWS ALSO APPLY. SEE "APPROVED SHAPES TABLE ON SHEET 1", ANCHORING OF SHAPED WINDOWS IS THE SAME WITH REQUIRED ANCHOR SPACING ALONG THE FRAME CIRCUMFERENCE BEING THE SAME AS SPECIFIED FOR A STRAIGHT FRAME.

PRODUCT REVISED as complying with the Florida Building Code NOA-No. 20-0623.18

Expiration Date: 04/16/2022

By: Manuel Peres Miami-Dade Product Control **PRODUCT REVISED** as complying with the Florida Building Code 17-0803.04 NOA-No.

Expiration Date 04/16/2022

Miami-Dade Product Control

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Acceptance No. 16-1205.01
Expiration Date April 16, 2012
By Manuel Date

NSULTANTS

W. SCHAEFER

CONSULTING, P
7480 150TH COUR
PALM BEACH CARDENE
PHONE: 561-744 કંકે 3.0 2016 N6 V

1749 SHEET NO.

SCHAEFER NO. 44135

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P.A. (CA 6809)
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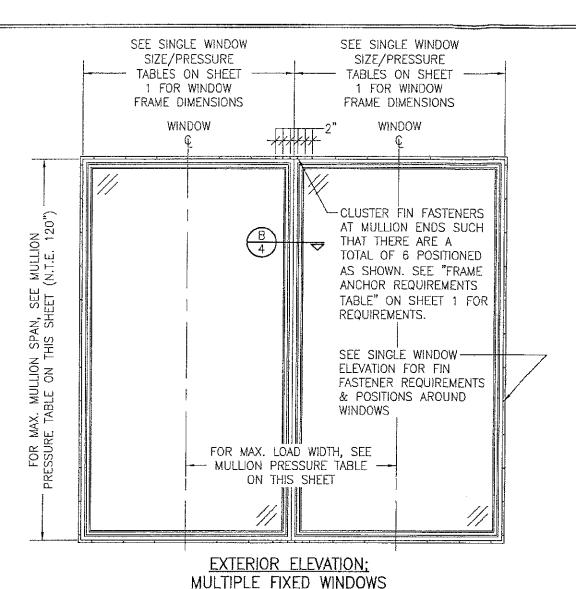
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| | MULLION ALLOWABLE | | | | |
|---------|-------------------|----------|-------|--|--|
| DESI | GN PRE | SSUR | E | | |
| MAXIMUM | MAXIMUM | ALLO | WABLE | | |
| MULLION | LOAD | PRESSURE | | | |
| SPAN | WIDTH | (PSF) | | | |
| (IN.) | (IN.) | POS. | NEG. | | |
| 120 | 60 | 45.5 | 45.5 | | |
| | 54 | 49.8 | 49.8 | | |
| | 48 | 55.0 | 55.0 | | |
| | 42 | 62.2 | 62.2 | | |
| | 40 | 65.0 | 65.0 | | |
| | 36 | 65.0 | 70.8 | | |
| | 33 | 65.0 | 75.0 | | |
| | 66 | 52.5 | 52.5 | | |
| | 60 | 55.6 | 55.6 | | |
| 400 | 54 | 59.4 | 59.4 | | |
| 108 | 48 | 64.5 | 64.5 | | |
| | 42 | 65.0 | 71.2 | | |
| | . 39 | 65.0 | 75.0 | | |
| | 70 | 55.4 | 55.4 | | |
| | 66 | 57.1 | 57.1 | | |
| 400 | 60 | 60.2 | 60.2 | | |
| 102 | 54 | 64.2 | 64.2 | | |
| | 48 | 65.0 | 69.4 | | |
| | 43 | 65.0 | 75.0 | | |
| | 72 | 60.2 | 60.2 | | |
| | 66 | 62.5 | 62.5 | | |
| 96 | 60 | 65.0 | 65.7 | | |
| | 54 | 65.0 | 69.8 | | |
| | 48 | 65.0 | 75.0 | | |
| | 72 | 65.0 | 66.9 | | |
| 20 | 66 | 65.0 | 69.1 | | |
| 90 | 60 | 65.0 | 72.2 | | |
| | 55 | 65.0 | 75.0 | | |
| 84 | 72 | 65.0 | 75.0 | | |

1. SEE ELEVATIONS FOR DIMENSIONING OF LOAD WIDTH. 2. ALLOWABLE UNIT PRESSURE SHALL BE THE LESSER OF THE PRESSURE SHOWN IN THIS TABLE

INDIVIDUAL WINDOW.

& THAT SPECIFIED FOR THE



SCALE: 1/2" = 1'-0"

(NAIL FIN MOUNT CONDITION)

SEE SINGLE WINDOW SEE SINGLE WINDOW SIZE/PRESSURE SIZE/PRESSURE TABLES ON SHEET TABLES ON SHEET 1 FOR WINDOW 1 FOR WINDOW FRAME DIMENSIONS FRAME DIMENSIONS WINDOW **WINDOW** MULLION (N.T.E. 120") ADDITIONAL FRAME SCREWS WHERE SHOWN AT MULLION ENDS. SEE 4 "FRAME ANCHOR REQUIREMENTS TABLE" ON SHEET 1 FOR N SPAN, SEE THIS SHEET REQUIREMENTS. NOTE: OUTERMOST ANCHOR AT EACH SIDE IS NOT REQUIRED WHEN LOAD SEE SINGLE WINDOW ELEVATION FOR FRAME WIDTH IS 35" OR LESS ANCHOR REQUIREMENTS FOR MAX. MULLION PRESSURE TABLE ON T & POSITIONS AROUND WINDOWS FOR MAX. LOAD WIDTH, SEE MULLION PRESSURE TABLE ON THIS SHEET AAA AAA

EXTERIOR ELEVATION: MULTIPLE FIXED WINDOWS

SCALE: 1/2" = 1'-0"(FRAME SCREW MOUNT CONDITION)

MULTIPLE UNIT NOTES:

- 1. FOR ALL DETAIL NOT SHOWN, SEE SINGLE WINDOW ELEVATIONS.
- 2. MULLION MAY BE HORIZONTAL OR VERTICAL PROVIDING UNIT SIZES ARE RESTRICTED AS SHOWN IN THIS ELEVATION.
- 3. WINDOWS MAY BE STACKED HORIZONTAL OR VERTICAL. TO INSURE THAT THE DEAD WEIGHT OF THE ABOVE WINDOW(S) WILL NOT CAUSE UNDO STRESS ON THE BELOW WINDOW, WHEN VERTICALLY STACKED, THE MANUFACTURER/INSTALLER SHALL LIMIT THE SAG OF THE HORIZONTAL MULLION TO MAX. 1/8".
- 4. THERE IS NO LIMIT ON THE NUMBER OF WINDOWS THAT MAY BE COMBINED IN ONE DIRECTION INTO ONE OPENING PROVIDING THE OPENING IS DESIGNED TO SUPPORT ALL LOADS TRANSFERRED FROM THE WINDOWS & THEIR MULLIONS.
- 5. INDIVIDUAL WINDOW SIZES SHALL BE RESTRICTED AS SPECIFIED IN THE SINGLE WINDOW ELEVATIONS. 6. RECTANGULAR WINDOWS SHOWN. SHAPED WINDOWS ALSO APPLY UNDER THE SAME CONDITIONS SHOWN

PRODUCT REVISED as complying with the Florida Building Code

FOR RECTANGULAR.

NOA-No. 20-0623.18 **Expiration Date: 04/16/2022**

By: Manuel Peres Miami-Dade Product Control

PRODUCT REVISED as complying with the Florida Building Code 17-0803.04 NOA-No.

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PRODUCT REVISED as complying with the Florida Building Code

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Acceptance No 16-1205.01
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W. SCHAEFER
CONSULTING, P ર્કે **≥ ઇ** 200 20.44.33 **\$** 63 NOV 1749 SHEET NO.

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04/17/12

WINDOW

FIXED

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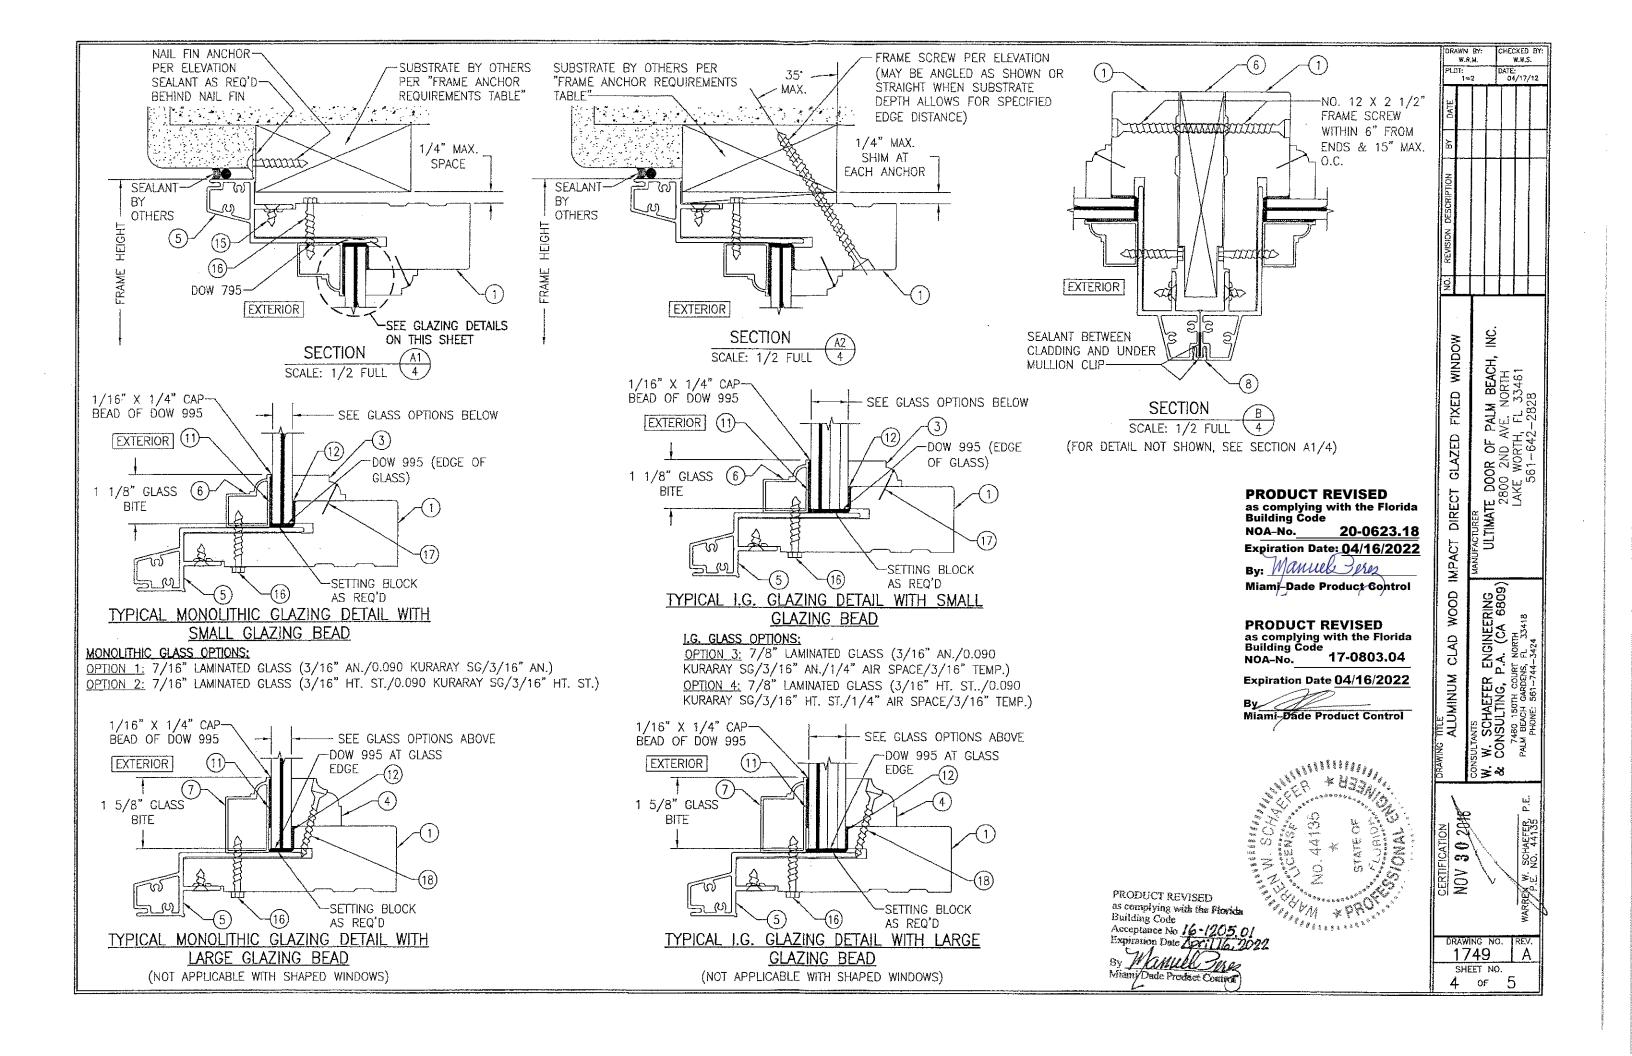
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P.A. (CA 6809)

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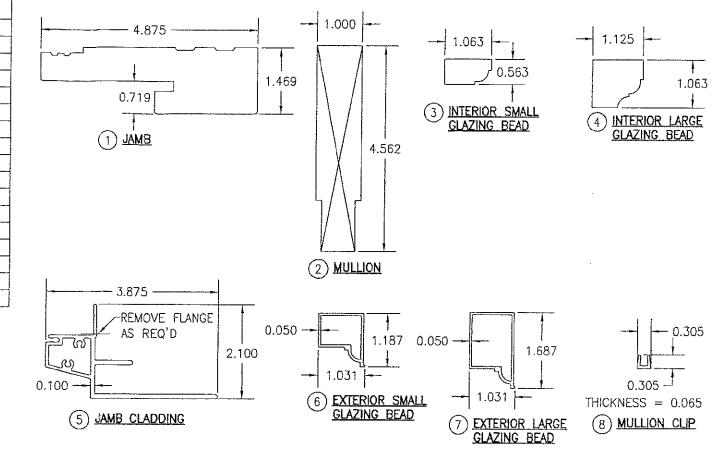
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. DOOR OF PALM BEACH, 1 2800 2ND AVE. NORTH AKE WORTH, FL 33461 561-642-2828



| ΠEM ∦ | ITEM DESCRIPTION | MANUFACTURER/NOTES | | |
|---------------------|------------------------------------|---------------------------------------|--|--|
| PARTS | | | | |
| 1 | JAMB | WOOD | | |
| 2 | MULLION | WOOD | | |
| 3 | INTERIOR SMALL GLAZING BEAD | WOOD | | |
| 4 | INTERIOR LARGE GLAZING BEAD | WOOD | | |
| 5 | JAMB CLADDING | 6063-T5 ALUMINUM | | |
| 6 | EXTERIOR SMALL GLAZING BEAD | 6063-T5 ALUMINUM | | |
| 7 | EXTERIOR LARGE GLAZING BEAD | 6063-T5 ALUMINUM | | |
| 8 | MULLION CLIP | 6063-T5 ALUMINUM | | |
| SEALS & SEALANTS | | | | |
| 11 | GLAZING TAPE 1/16" X 7/8" | SAINT GOBIAN V2862 | | |
| 12 | GLAZING TAPE 1/16" X 1/2" | SAINT GOBIAN V2862 | | |
| FASTENERS FASTENERS | | | | |
| 15 | NO. 6 X 3/4" SMS | WITHN 2" FROM CORNERS & 12" MAX. O.C. | | |
| 16 | NO. 10 X 1 1/4" HEX HEAD TEK SCREW | WITHN 2" FROM ENDS & 9" MAX. O.C. | | |
| 17 | 18 GA. X 3/4" BRAD NAIL | WITHIN 2" FROM CORNERS & 9" MAX. O.C. | | |
| 18 | NO. 7 X 1 5/8" TRIM SCREW | WITHIN 2" FROM CORNERS & 9" MAX. O.C. | | |

NOTE: WOOD USED IN TESTING WAS PONDEROSA PINE WITH A SPECIFIC GRAVITY OF G=0.43 AND A MODULUS OF ELASTICITY OF E = 1,200,000 PSI. OTHER WOOD SPECIES APPLICABLE FOR USE WITH THIS PRODUCT ARE THOSE WITH A SPECIFIC GRAVITY OF 0.43 AND MODULUS OF ELASTICITY OF 1,200,000 PSI OR GREATER. ALL WOOD IS MINIMUM GRADE 2 MILLED BY ULTIMATE DOOR TO SELECT.



PRODUCT REVISED as complying with the Florida Building Code 20-0623.18 NOA-No.

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Expiration Date 04/16/2022

Miami-Dade Product Control

PRODUCT REVISED as complying with the Florida Building Code
Acceptance No 16-1205.01
Expiration Date Sprill6, 2022
By Manual Jak

A CONTRACTOR OF THE STATE OF TH

ONSULTANTS

N. W. SCHAEFER ENGINEERING

& CONSULTING, P.A. (CA 6809)

7480 150TH COURT NORTH
PALM BEACH CARDENS, FL 33418

PLIM BEACH CARDENS, FL 33418

PLIM BEACH CARDENS, FL 33418 TITLE ALUMINUM CLAD WOOD NOY 3 0.2016 1749 Α SHEET NO. 5 of 5

CHECKED BY:

AIE: 04/17/12

ULTIMATE DOOR OF PALM BEACH, INC. 2800 2ND AVE. NORTH LAKE WORTH, FL 33461 561-642-2828

IMPACT DIRECT GLAZED FIXED WINDOW