

#### MIAMI-DADE COUNTY PRODUCT CONTROL SECTION

11805 SW 26 Street, Room 208 Miami, Florida 33175-2474 T (786) 315-2590 F (786) 315-2599 www.miamidade.gov/economy

## DEPARTMENT OF REGULATORY AND ECONOMIC RESOURCES (RER) BOARD AND CODE ADMINISTRATION DIVISION

#### NOTICE OF ACCEPTANCE (NOA)

PCI Industries Inc. dba All-Lite Arch. Products 5101 Blue Mound Road Fort Worth, TX 76106 SCOPE:

This NOA is being issued under the applicable rules and regulations governing the use of construction materials. The documentation submitted has been reviewed and accepted by Miami-Dade County RER-Product Control Section to be used in Miami-Dade County and other areas, where allowed by the Authority Having Jurisdiction (AHJ).

This NOA shall not be valid after the expiration date stated below. The Miami-Dade County Product Control Section (In Miami-Dade County) and/ or the AHJ (in areas other than Miami-Dade County) reserve the right to have this product or material tested for quality assurance purposes. If this product or material fails to perform in the accepted manner, the manufacturer will incur the expense of such testing and the AHJ may immediately revoke, modify, or suspend the use of such product or material within their jurisdiction. RER reserves the right to revoke this acceptance if it is determined by Miami-Dade County Product Control Section that this product or material fails to meet the requirements of the applicable building code.

This product is approved as described herein and has been designed to comply with the Florida Building Code, including the High Velocity Hurricane Zone.

**DESCRIPTION:** Model ECV-645-MD Aluminum Louver

**APPROVAL DOCUMENT:** Drawing No. **ECV-645-MD NOA**, titled "ECV-645-MD", sheets 1 through 12 of 12, dated 08/27/2013, with revision **8** dated 03/22/2021, prepared by the manufacturer, signed and sealed by Wayne K. Helmila, P.E., bearing the Miami-Dade County Product Control revision stamp with the Notice of Acceptance number and expiration date by the Miami-Dade County Product Control Section.

#### MISSILE IMPACT RATING: Large and Small Missile Impact Resistant

**LABELING:** A permanent label with the manufacturer's name or logo, manufacturing plant's city, state, model/ series, and the statement reading: "Miami-Dade County Product Control Approved", is to be located on each unit.

**RENEWAL** of this NOA shall be considered after a renewal application has been filed and there has been no change in the applicable building code negatively affecting the performance of this product.

**TERMINATION** of this NOA will occur after the expiration date or if there has been a revision or change in the materials, use, and/or manufacture of the product or process. Misuse of this NOA as an endorsement of any product, for sales, advertising or any other purposes shall automatically terminate this NOA. Failure to comply with any section of this NOA shall be cause for termination and removal of NOA.

**ADVERTISEMENT:** The NOA number preceded by the words Miami-Dade County, Florida, and followed by the expiration date may be displayed in advertising literature. If any portion of the NOA is displayed, then it shall be done in its entirety.

**INSPECTION:** A copy of this entire NOA shall be provided to the user by the manufacturer or its distributors and shall be available for inspection at the job site at the request of the Building Official.

This NOA revises NOA #19-0711.05 and consists of this page 1 and evidence pages E-1, E-2 and E-3, as well as approval document mentioned above.

The submitted documentation was reviewed by Carlos M. Utrera, P.E.

MIAMI-DADE COUNTY
APPROVED

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NOA-No. 20-1222.03 Expiration Date: January 22, 2025 Approval Date: April 08, 2021 Page 1

#### NOTICE OF ACCEPTANCE: EVIDENCE SUBMITTED

#### 1. EVIDENCE SUBMITTED UNDER PREVIOUS NOA's

#### A. DRAWINGS "Submitted under NOA #14-0605.12"

1. Drawing No. ECV-645-MD NOA, titled "ECV-645-MD", sheets 1 through 15 of 15, dated 08/27/2013, with revision 5 dated 10/10/2014, prepared by the manufacturer, signed and sealed by Wayne K. Helmila, P.E.

#### B. TESTS "Submitted under NOA #14-0605.12"

- 1. Test reports on 1) Uniform Static Air Pressure Test, Loading per FBC, TAS 202-94
  - 2) Large Missile Impact Test per FBC, TAS 201-94
  - 3) Cyclic Wind Pressure Loading per FBC, TAS 203-94

along with installation diagram of Model ECV-645-MD Aluminum Louvers, prepared by Architectural Testing, Inc, Test Report No. **C8134.01-801-18**, dated 02/24/2014, signed and sealed by Vinu J. Abraham, P.E.

2. Test Report on High Velocity Wind Driven Rain Resistance per AMCA 550 of a Model ECV-645 Aluminum Louver, prepared by Architectural Testing, Inc, Test Report No. **C3038.02-801-44**, dated 11/02/2012, signed and sealed by Vinu J. Abraham, P.E.

#### C. CALCULATIONS "Submitted under NOA #14-0605.12"

- 1. ECV-545-MD louver structural calculations prepared by Rice Engineering, dated 10/22/2014, signed and sealed by Wayne K. Helmila, P.E.
- 2. ECV-545-MD louver calculations prepared by Rice Engineering, dated 05/15/2014, signed and sealed by L. David Rice, P.E.

#### D. QUALITY ASSURANCE

1. Miami-Dade Department of Regulatory and Economic Resources (RER).

#### E. MATERIAL CERTIFICATIONS

1. None.

#### F. STATEMENTS "Submitted under NOA #15-0602.02"

1. Statement letter of code conformance to the 5<sup>th</sup> edition (2014) FBC issued by Rice Engineering, dated 05/22/2015, signed and sealed by L. David Rice, P.E.

#### "Submitted under NOA #14-0605.12"

2. No financial interest letter issued by Rice Engineering, dated 05/15/2014, signed and sealed by L. David Rice, P.E.

Carlos M. Utrera, P.E.
Product Control Examiner
NOA-No. 20-1222.03
Expiration Date: January 22, 2025

Approval Date: April 08, 2021

#### NOTICE OF ACCEPTANCE: EVIDENCE SUBMITTED

#### 2. EVIDENCE SUBMITTED UNDER NOA # 19-0711.05

#### A. DRAWINGS

1. Drawing No. **ECV-645-MD NOA**, titled "ECV-645-MD", sheets 1 through 12 of 12, dated 08/27/2013, with revision 7 dated 07/30/2019, prepared by the manufacturer, signed and sealed by Wayne K. Helmila, P.E.

#### B. TESTS

- 1. Test reports on 1) Uniform Static Air Pressure Test, Loading per FBC, TAS 202-94
  - 2) Large Missile Impact Test per FBC, TAS 201-94 (Level 'E', 80 fps)
  - 3) Cyclic Wind Pressure Loading per FBC, TAS 203-94

along with installation diagram of Model ECV-645-MD Aluminum Louvers, prepared by Intertek, Test Report No. **J5028.01-801-18 R0**, dated 07/01/2019, signed and sealed by Tyler Westerling, P.E.

#### C. CALCULATIONS

1. ECV-545-MD NOA louver anchor calculations prepared by Rice Engineering, dated 04/26/2019, signed and sealed by Wayne K. Helmila, P.E.

#### D. OUALITY ASSURANCE

1. Miami-Dade Department of Regulatory and Economic Resources (RER).

#### E. MATERIAL CERTIFICATIONS

1. None.

#### F. STATEMENTS

- 1. Statement letter of code conformance to the 6<sup>th</sup> edition (2017) FBC issued by Rice Engineering, dated 04/26/2019, signed and sealed by L. David Rice, P.E.
- 2. No financial interest letter issued by Rice Engineering, dated 04/26/2019, signed and sealed by L. David Rice, P.E.

Carlos N

Carlos M. Utrera, P.E.
Product Control Examiner
NOA-No. 20-1222.03
Expiration Date: January 22, 2025
Approval Date: April 08, 2021

#### NOTICE OF ACCEPTANCE: EVIDENCE SUBMITTED

#### 3. NEW EVIDENCE SUBMITTED

#### A. DRAWINGS

1. Drawing No. **ECV-645-MD NOA**, titled "ECV-645-MD", sheets 1 through 12 of 12, dated 08/27/2013, with revision **8** dated 03/22/2021, prepared by the manufacturer, signed and sealed by Wayne K. Helmila, P.E.

#### B. TESTS

1. None.

#### C. CALCULATIONS

1. None.

#### D. QUALITY ASSURANCE

1. Miami-Dade Department of Regulatory and Economic Resources (RER).

#### E. MATERIAL CERTIFICATIONS

1. None.

#### F. STATEMENTS

1. Statement letter of code conformance to the 7<sup>th</sup> edition (2020) FBC and no financial interest, issued by Rice Engineering, dated 03/26/2021, signed and sealed by Wayne K. Helmila, P.E.

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Carlos M. Utrera, P.E.
Product Control Examiner
NOA-No. 20-1222.03
Expiration Date: January 22, 2025
Approval Date: April 08, 2021

#### NOTES:

- 1. THIS NOA DRAWING INCLUDES INSTALLATION DETAILS TO ATTAIN MAXIMUM DESIGN PRESSURES OF 150 PSF AS TESTED IN ACCORDANCE WITH PROTOCOLS TAS 201 (LEVEL 'E', 80 FPS), TAS 202, TAS 203, & AMCA 550 FOR USE WITHIN HIGH VELOCITY HURRICANE-AFFECTED ZONES DEFINED BY THE FLORIDA BUILDING CODE.
- 2. ALL VARIATIONS ARE LARGE MISSILE IMPACT RESISTANT.
- 3. UNITS OF MEASURE ARE FRACTIONAL INCHES UNLESS OTHERWISE SPECIFIED.
- 4. IT IS ASSUMED THAT THE LOUVER SYSTEMS DO NOT SUPPORT ANY LOADS TRANSFERRED FROM THE BUILDING CONDITION.
- 5. IT IS ASSUMED THAT THE BUILDING CONDITIONS ARE ADEQUATELY DESIGNED TO SUPPORT LOADS IMPARTED BY THE LOUVER SYSTEM.
- 6. TO PREVENT GALVANIC CORROSION, ELECTROCHEMICALLY DISSIMILAR MATERIALS IN CONTACT WITH ONE ANOTHER SHALL BE PROTECTED BY PAINT, GASKETING OR OTHER MEANS PER THE FLORIDA BUILDING CODE.
- 7. SINCE THE DESIGN MEETS THE PERFORMANCE STANDARDS OF AMCA 550, THE ROOM BEHIND THE LOUVER NEED NOT BE DESIGNED TO DRAIN WATER PENETRATION INTO THE ROOM, AND MAY HOUSE NON-WATER RESISTANT EQUIPMENT, COMPONENTS, OR SUPPLIES.
- 8. OTHER BUILDING CONDITIONS THAN THOSE DENOTED CAN BE UTILIZED IF ANALYZED AND APPROVED BY A PROFESSIONAL ENGINEER.
- 9. MULTI-SECTION HIGH LOUVER SYSTEMS ARE ALLOWABLE PROVIDED THE INDIVIDUAL SECTIONS ARE SUPPORTED PER THE DETAILS ON THIS DRAWING AND A SUITABLE SUPPORT STRUCTURE IS ANALYZED AND APPROVED BY A PROFESSIONAL ENGINEER.

TABLE 3					
ANCHOR SCHEDULE					
SUBSTRATE	ANCHOR TYPE	MIN. EMBEDMENT	MIN. EDGE DISTANCE	MAX. EDGE DISTANCE	MAX. SPACING
CONCRETE (f'c ≥ 4000 PSI, WALL DEPTH ≤ 8 7/8")	3/8" X 4" HILTI KH-EZ SCREW ANCHOR (F-5)	3 1/4"	1 1/2"	2"	10"
CONCRETE (f'c ≥ 4000 PSI, WALL DEPTH > 8 7/8")	3/8" X 3 1/2" HILTI KH-EZ SCREW ANCHOR (F-6)	3 1/4"	1 7/8"	-	6"
GROUT-FILLED CMU (f'm ≥ 1500 PSI, WALL DEPTH ≤ 8 7/8")	3/8" X 4" HILTI KH-EZ SCREW ANCHOR (F-5)	3 1/4"	4"	4"	4"
GROUT-FILLED CMU (f'm ≥ 1500 PSI, WALL DEPTH > 9 5/8")	3/8" X 3 1/2" HILTI KH-EZ SCREW ANCHOR (F-6)	3 1/4"	2 5/8"	-	6"
STRUCTURAL STEEL (MIN. 3/16" THICK, Fy ≥ 36 KSI)	1/4" X 1" SELF-DRILLING SCREW (F-4)	FULL	1"	-	7"
STEEL STUD (MIN. 16 GA., Fy ≥ 50 KSI)	1/4" X 1" SELF-DRILLING SCREW (F-4)	FULL	1"	-	4"
WOOD (S.G. ≥ 0.43)	1/2" X 3 1/2" LAG BOLT WITH FLAT WASHER (F-7)	3"	2"	-	5"



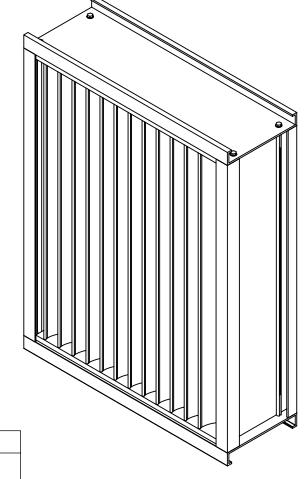


	TABLE 1	
SINGLE SECTION SIZE LIMITATIONS		
MAX DESIGN PRESSURE	MIN (W X H)	MAX (W X H)
±150 PSF	12" X 12"	60" X 120"

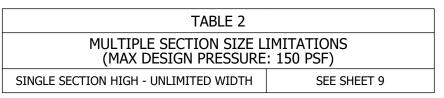

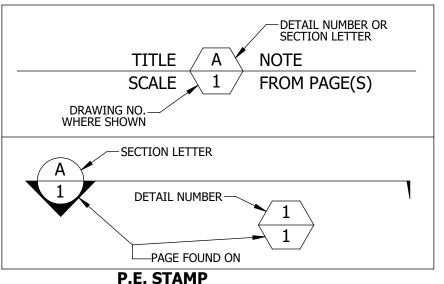

**PRODUCT REVISED** as complying with the Florida Building Code

NOA-No. 20-1222.03

Expiration Date 01/22/2025

Tuns Miami-Dade Product Control

#### **RICE**


#### **ENGINEERING**

105 School Creek Trail Luxemburg, WI 54217 Phone: (920) 617-1042 Fax: (920) 617-1100 www.rice-inc.com

Florida Firm No: F-01000005061 Certificate of Authorization: #9090 Wayne K. Helmila Registration No: 59092

SHEET: 1 of 12

SCALE: NONE

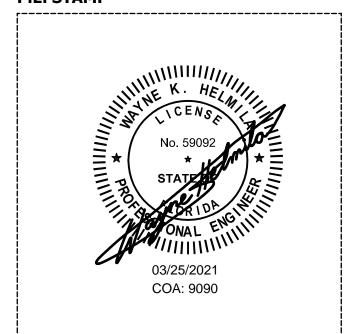

ECV-645-MD NOA

<u>ن</u>	RI	EV.	DI	ESCRIPTION	DATE	DRAWN BY
Use		2	REVISED IN	STALLATION DETAILS	1/27/2014	JG
rs\r		3	REVISED F	PER RICE MARKUPS	4/23/2014	JG
MO		4 REVISED PER		MIAMI DADE COUNTY	8/22/2014	JG
γpc		5 CHANGED LOUVE		VER MATERIAL TO 6063-T6	10/13/2014	NW
ort		6 UPDATED FOR NO		OA RENEWAL & REVISION	4/23/2019	JMR / NW
ğ		7 REVISED PER MI		MIAMI DADE COUNTY	7/30/2019	NWW
sskt		8	UPDATED I	FOR NOA RENEWAL	3/22/2021	NWW
C:\Users\nwoodworth\Desktop\Miami-Dade Updates (2020)\ECV-645-MD'		W	OOD (S.G. ≥ 0.43)	1/2" X 3 1/2" LAG E WITH FLAT WASHER	BOLT (F-7)	3"
i-Dade			STEEL STUD (MIN. 16 GA., Fy ≥ 50 KSI)	1/4" X 1" SELF-DRILLIN (F-4)	G SCREW	FULL
Update		STRUCTURAL STEEL (MIN. 3/16" THICK, Fy ≥ 36 KSI)		1/4" X 1" SELF-DRILLING (F-4)	G SCREW	FULL
s (202)		-	ROUT-FILLED CMU (f'm ≥ 1500 PSI, LL DEPTH > 9 5/8")	3/8" X 3 1/2" HILTI I SCREW ANCHOR (I	KH-EZ F-6)	3 1/4"
0)\ECV		-	ROUT-FILLED CMU (f'm $\geq$ 1500 PSI, LL DEPTH $\leq$ 8 7/8")	3/8" X 4" HILTI KH SCREW ANCHOR (I	-EZ F-5)	3 1/4"
-645-MI				CONCRETE (f'c $\geq$ 4000 PSI, LL DEPTH $>$ 8 7/8")	3/8" X 3 1/2" HILTI I SCREW ANCHOR (I	KH-EZ F-6)
Ճ		WAI	LL DEPTH $\leq 8.7/8"$ )	SCREW ANCHOR (I	F-5)	J =, .

UNLESS OTHERWISE SPECIFIED DIMENSION ARE IN INCHES.

**TOLERANCE UNLESS NOTED:** ±0.030 X.XX ±0.015 ±0.010 X.XXX ANGLE ±1° FRACTION ±1/16

MAX HOLE BREAKOUT: 15% OF MATERIAL THICKNESS

5101 Blue Mound Road Fort Worth, Texas 76106 Phone: 817-509-2300 Fax: 817-831-3110

THIRD ANGLE PROJECTIO






DRAWING DESCR:	COVER SHEET			
PROJECT: ECV-645-	MD			
LOCATION:				
CUSTOMER:				
PROJ. MGR:		DRAWN BY: LGH		
DATE: 8/27/2013	CHK'D BY: NW	ORDER NUMBER	P.O. NUMBER	DRAWING NUMBER

# 

SECTION VIEW B GENERAL ASSEMBLY 3/4"=1'-0" 2 2

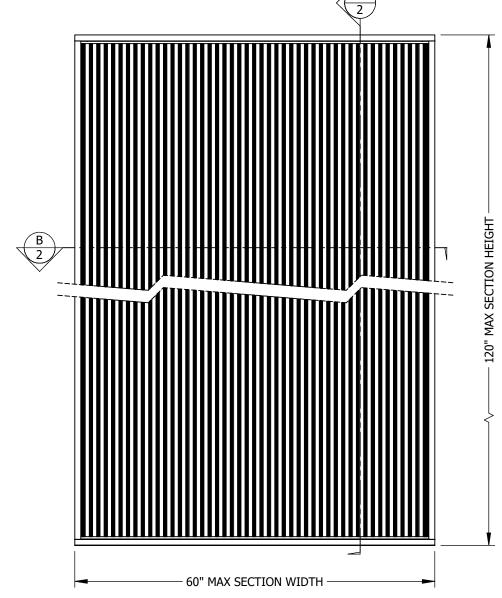



#### **RICE**

#### **ENGINEERING**

105 School Creek Trail Luxemburg, WI 54217 Phone: (920) 617-1042 Fax: (920) 617-1100 www.rice-inc.com

Florida Firm No: F-0100005061 Certificate of Authorization: #9090 Wayne K. Helmila Registration No: 59092

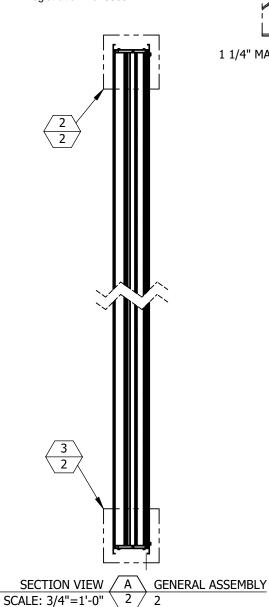

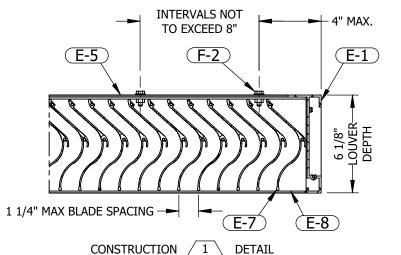

IN FLANGED CONFIGURATIONS: E-2 WILL BE USED IN PLACE OF E-1 E-6 WILL BE USED IN PLACE OF E-5

2"=1'-0"

2 / 2

# E-8 F-1 F-1

IN FLANGED CONFIGURATIONS: E-2 WILL BE USED IN PLACE OF E-1 E-6 WILL BE USED IN PLACE OF E-5

**GENERAL LOUVER ASSEMBLY** 

CONSTRUCTION 3 DETAIL 2"=1'-0" 2 2


PRODUCT REVISED
as complying with the Florida
Building Code


NOA-No. 20-1222.03

Expiration Date 01/22/2025

By Miami-Dade Product Control

#### P.E. STAMP

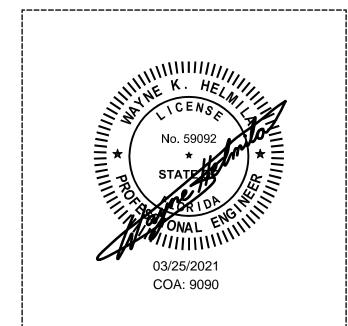

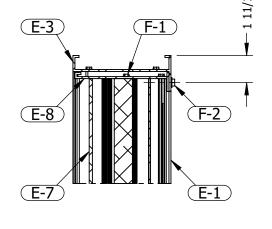

CONSTRUCTION 2 DETAIL 2"=1'-0" 2 2

IN FLANGED CONFIGURATIONS: E-2 WILL BE USED IN PLACE OF E-1 E-4 WILL BE USED IN PLACE OF E-3

#### **EXTERIOR ELEVATION**

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Deskto	8	UPDATED FOR NOA RENEWAL	3/22/2021	NWW
~	7	revised per miami dade county	7/30/2019	NWW
worth	6	UPDATED FOR NOA RENEWAL & REVISION	4/23/2019	JMR / NW
	5	CHANGED LOUVER MATERIAL TO 6063-T6	10/13/2014	NW
nwood	4	REVISED PER MIAMI DADE COUNTY	8/22/2014	JG
$\overline{}$	3	REVISED PER RICE MARKUPS	4/23/2014	JG
Users	2	REVISED INSTALLATION DETAILS	1/27/2014	JG
: ::	REV.	DESCRIPTION	DATE	DRAWN BY

p\Miami-Dade Updates (2020)\ECV-645-MD\

UNLESS OTHERWISE SPECIFIED DIMENSION ARE IN INCHES.

 $\begin{array}{lll} \text{TOLERANCE UNLESS NOTED:} \\ \text{X.X} & \pm 0.030 \\ \text{X.XX} & \pm 0.015 \\ \text{X.XXX} & \pm 0.010 \\ \text{ANGLE} & \pm 1^{\circ} \end{array}$ 

MAX HOLE BREAKOUT: 15% OF MATERIAL THICKNESS

FRACTION ±1/16

5101 Blue Mound Road Fort Worth, Texas 76106 Phone: 817-509-2300 Fax: 817-831-3110

THIRD ANGLE PROJECTION



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ALL-LIIE
ARCHITECTURAL PRODUCTS

DRAWING DESCR: GENERAL LOUVER ASSEMBLY

PROJECT: ECV-645-MD


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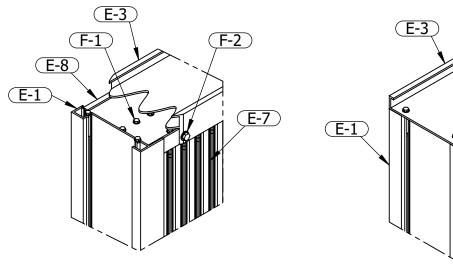
CUSTOMER:


PROJ. MGR: DRAWN BY: LGH
DATE: 8/27/2013 | CHK'D BY: NW ORDER NUMBER

DATE: 8/27/2013 CHK'D BY: NW ORDER NUMBER P.O. NUMBER DRAWING NUMBER SHEET: 2 of 12 SCALE: 3/4"=1'-0" ECV-645-MD NOA

#### **GENERAL LOUVER ASSEMBLY**



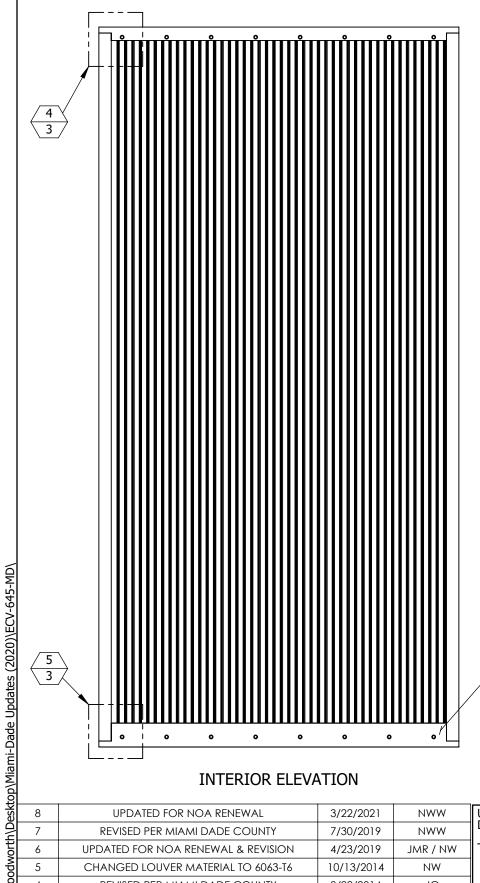

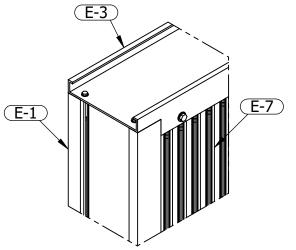

CONSTRUCTION / 4 \ DETAIL 3/3 2" = 1'-0"

IN FLANGED CONFIGURATIONS: E-2 WILL BE USED IN PLACE OF E-1 E-4 WILL BE USED IN PLACE OF E-3

### **RICE**

**PRODUCT REVISED** as complying with the Florida Building Code

NOA-No. 20-1222.03

Expiration Date 01/22/2025


Tuns Miami-Dade Product Control

#### **ENGINEERING**

105 School Creek Trail Luxemburg, WI 54217 Phone: (920) 617-1042 Fax: (920) 617-1100 www.rice-inc.com

Florida Firm No: F-01000005061 Certificate of Authorization: #9090 Wayne K. Helmila Registration No: 59092


#### P.E. STAMP

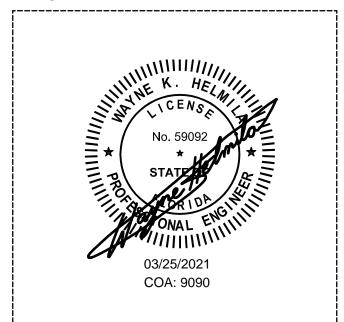

ENGRAVED LABEL DETAIL

PCI Industries Inc d/b/a **ALL-LITE** Ft Worth TX SO# 123456

Miami Dade County **Product Control** Approved

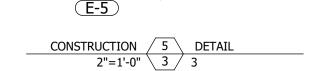

IN FLANGED CONFIGURATIONS: E-2 WILL BE USED IN PLACE OF E-1 E-6 WILL BE USED IN PLACE OF E-5

#### **INTERIOR ELEVATION**

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ב נו	8	UPDATED FOR NOA RENEWAL	3/22/2021	NWW
2	7	REVISED PER MIAMI DADE COUNTY	7/30/2019	NWW
5	6	UPDATED FOR NOA RENEWAL & REVISION	4/23/2019	JMR / NW
ξ	5	CHANGED LOUVER MATERIAL TO 6063-T6	10/13/2014	NW
⋛	4	REVISED PER MIAMI DADE COUNTY	8/22/2014	JG
2	3	REVISED PER RICE MARKUPS	4/23/2014	JG
ב ק	2	REVISED INSTALLATION DETAILS	1/27/2014	JG
<u>ر</u> ز	REV.	DESCRIPTION	DATE	DRAWN BY

UNLESS OTHERWISE SPECIFIED DIMENSION ARE IN INCHES.

TOLERANCE UNLESS NOTED: X.X ±0.030 X.XX ±0.015 X.XXX  $\pm 0.010$ ANGLE ±1° FRACTION ±1/16

MAX HOLE BREAKOUT: 15% OF MATERIAL THICKNESS

5101 Blue Mound Road Fort Worth, Texas 76106 Phone: 817-509-2300 Fax: 817-831-3110

THIRD ANGLE PROJECTIO



# **ARCHITECTURAL PRODUCTS**

PCI INDUSTRIES DOING BUSINESS AS

DRAWING DESCR: GENERAL LOUVER ASSEMBLY

PROJECT: ECV-645-MD

LOCATION:


CUSTOMER:

SHEET: 3 of 12

PROJ. MGR: DRAWN BY: LGH DATE: 8/27/2013 CHK'D BY: NW

ORDER NUMBER | P.O. NUMBER | DRAWING NUMBER SCALE: 3/4"=1'-0" ECV-645-MD NOA

#### **SINGLE SECTION WIDE X SINGLE SECTION HIGH - STEEL CONDITION**

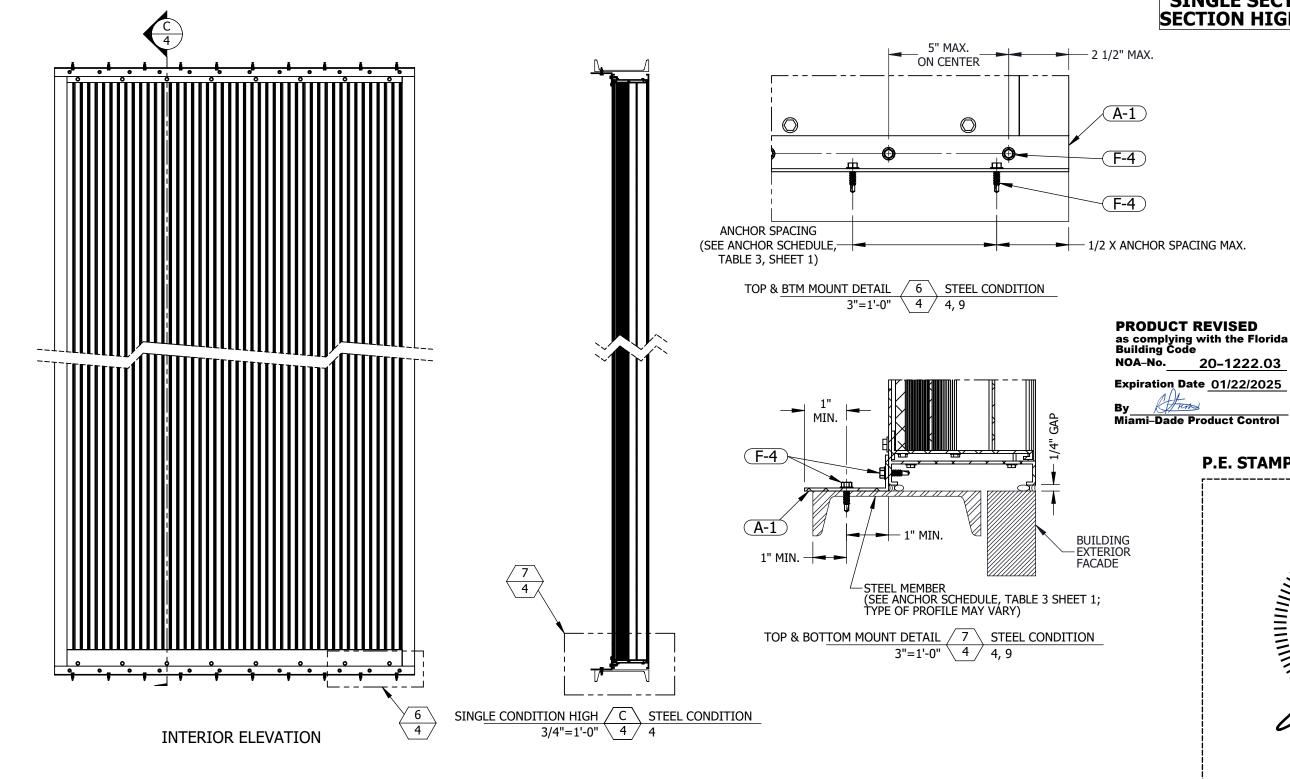

#### **RICE**


#### **ENGINEERING**

105 School Creek Trail Luxemburg, WI 54217 Phone: (920) 617-1042 Fax: (920) 617-1100 www.rice-inc.com

Florida Firm No: F-01000005061 Certificate of Authorization: #9090 Wayne K. Helmila Registration No: 59092

#### P.E. STAMP

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C:\Users\nwoodworth\Desktop\Miami-Dade Updates (2020)\ECV-645-MD\		INTERIOR ELEV	ATION	6 4
esk	8	UPDATED FOR NOA RENEWAL	3/22/2021	NWW
h\D	7	REVISED PER MIAMI DADE COUNTY	7/30/2019	NWW
/ort	6	UPDATED FOR NOA RENEWAL & REVISION	4/23/2019	JMR / NW
wpc	5	CHANGED LOUVER MATERIAL TO 6063-T6	10/13/2014	NW
WO	4	REVISED PER MIAMI DADE COUNTY	8/22/2014	JG
rs\n	3	REVISED PER RICE MARKUPS	4/23/2014	JG
Jse	2	REVISED INSTALLATION DETAILS	1/27/2014	JG
7	REV.	DESCRIPTION	DATE	DRAWN BY

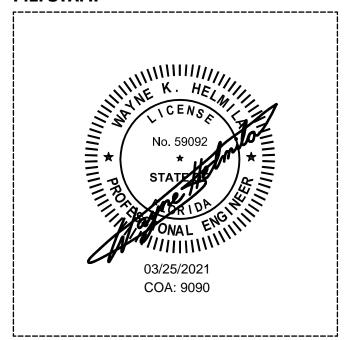UNLESS OTHERWISE SPECIFIED DIMENSION ARE IN INCHES.

TOLERANCE UNLESS NOTED: X.X ±0.030 X.X X.XX ±0.015 X.XXX ±0.010 ±1° ANGLE FRACTION ±1/16

MAX HOLE BREAKOUT: 15% OF MATERIAL THICKNESS

5101 Blue Mound Road Fort Worth, Texas 76106 Phone: 817-509-2300 Fax: 817-831-3110

THIRD ANGLE PROJECTION



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ARCHITECTURAL PRODUCTS	
ARCHITECTORAL I RODUCTS	I

PCI INDUSTRIES DOING BUSINESS AS


DRAWING DESCR: SINGLE SECTION WIDE X SINGLE SECTION HIGH - STEEL CONDITION


PROJECT: ECV-645-MD

LOCATION:


CUSTOMER:

PROJ. MGR: DRAWN BY: LGH ORDER NUMBER | P.O. NUMBER | DRAWING NUMBER DATE: 8/27/2013 CHK'D BY: NW SHEET: 4 of 12 SCALE: 3/4"=1'-0" ECV-645-MD NOA

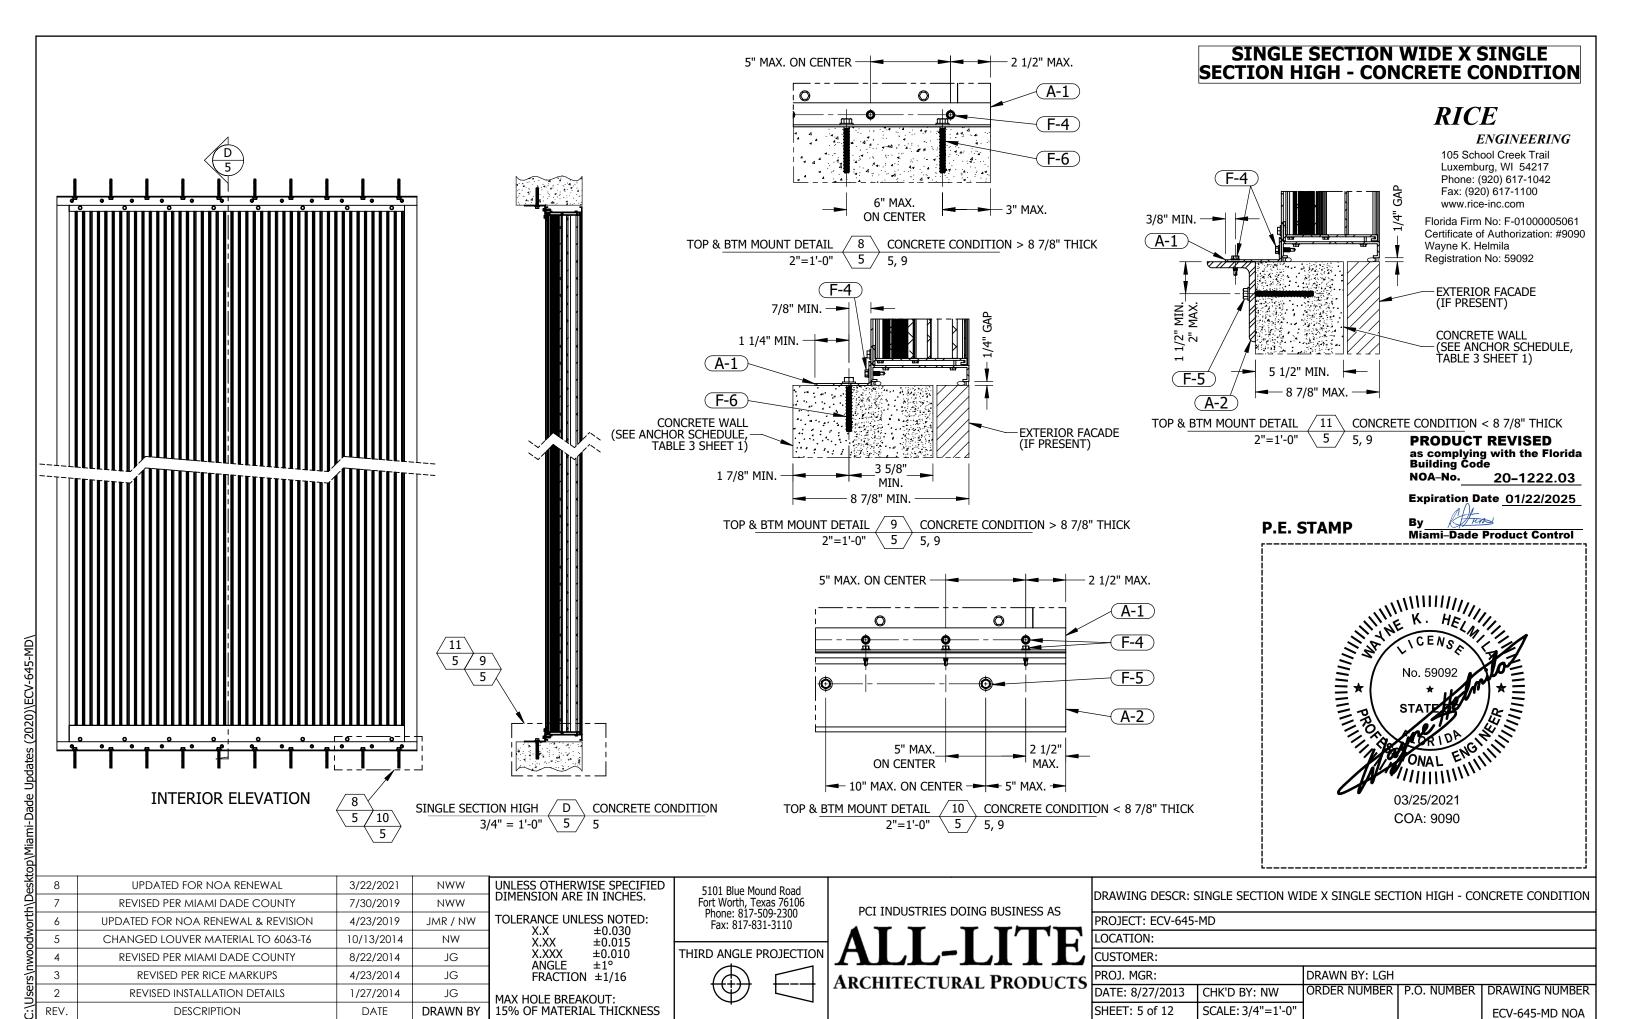

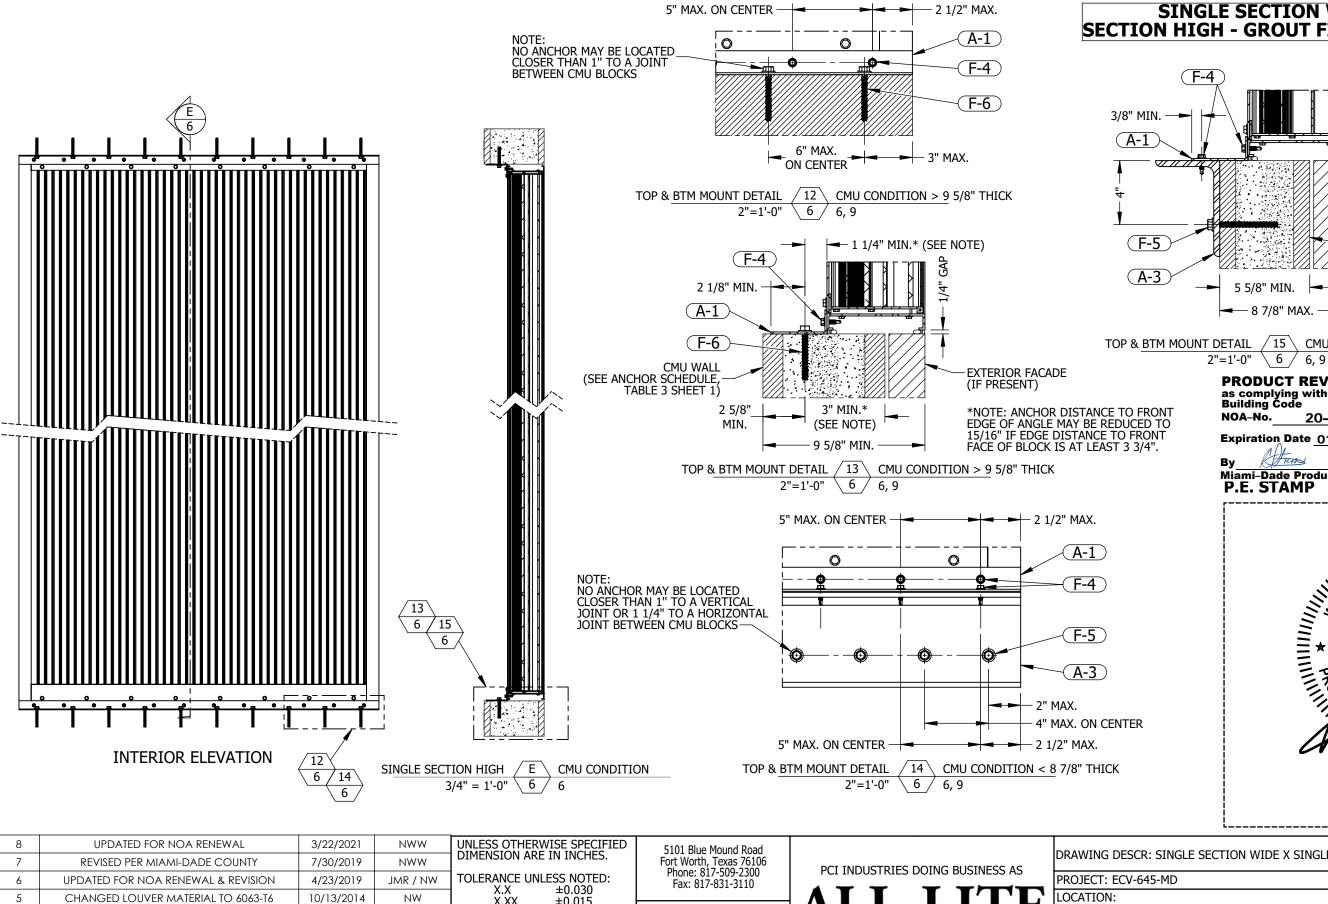

#### **SINGLE SECTION WIDE X SINGLE** SECTION HIGH - GROUT FILLED CMU CONDITION

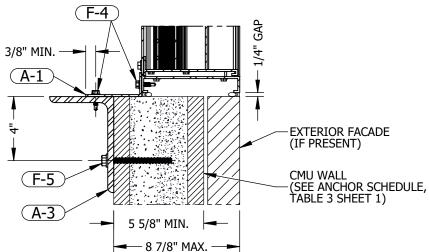

TOP & BTM MOUNT DETAIL  $\sqrt{15}$  CMU CONDITION < 8 7/8" THICK

#### PRODUCT REVISED

as complying with the Florida Building Code 20-1222.03

Expiration Date 01/22/2025


Miami-Dade Product Control
P.E. STAMP

#### **RICE**

**ENGINEERING** 

105 School Creek Trail Luxemburg, WI 54217 Phone: (920) 617-1042 Fax: (920) 617-1100

Florida Firm No: F-01000005061 Certificate of Authorization: #9090 Wayne K. Helmila Registration No: 59092

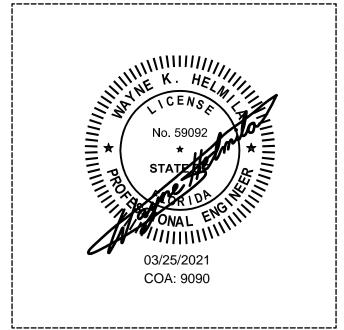

ဌ				
esktop	8	UPDATED FOR NOA RENEWAL	3/22/2021	NWW
⊇	7	REVISED PER MIAMI-DADE COUNTY	7/30/2019	NWW
70	6	UPDATED FOR NOA RENEWAL & REVISION	4/23/2019	JMR / NW
nwoodworth	5	CHANGED LOUVER MATERIAL TO 6063-T6	10/13/2014	NW
Š	4	REVISED PER MIAMI DADE COUNTY	8/22/2014	JG
	3	REVISED PER RICE MARKUPS	4/23/2014	JG
Jsers	2	revised installation details	1/27/2014	JG
::	REV.	DESCRIPTION	DATE	DRAWN BY

mi-Dade Updates (2020)\ECV-645-MD\

X.XX ±0.015 X.XXX ±0.010 ANGLE ±1° FRACTION ±1/16

MAX HOLE BREAKOUT: 15% OF MATERIAL THICKNESS THIRD ANGLE PROJECTION



ARCHITECTURAL PRODUCTS

DRAWING DESCR: SINGLE SECTION WIDE X SINGLE SECTION HIGH - CMU CONDITION

CUSTOMER:

PROJ. MGR: DRAWN BY: LGH ORDER NUMBER | P.O. NUMBER | DRAWING NUMBER

DATE: 8/27/2013 CHK'D BY: NW SHEET: 6 of 12 SCALE: 3/4"=1'-0' ECV-645-MD NOA

### 5" MAX. - 2 1/2" MAX. ON CENTER (A-1) **F-4** (F-7) \_ 5" MAX. ON CENTER 2 1/2" MAX. TOP & BTM MOUNT DETAIL 16 WOOD CONDITION 3"=1'-0" 7 7, 9 (F-7) 1" MIN. -(A-1) MIN. 2 EXTERIOR -BUILDING FACADE . 7 CONTINUOUS WOOD BLOCKING -(SEE ANCHOR SCHEDULE, TABLE 3 SHEET 1) → 2" MIN. -TOP & BTM MOUNT DETAIL 17 WOOD CONDITION 3"=1'-0" 7 7, 9 **INTERIOR ELEVATION**

#### **SINGLE SECTION WIDE X SINGLE SECTION HIGH - WOOD CONDITION**

**PRODUCT REVISED** 

as complying with the Florida Building Code

NOA-No. 20-1222.03

Expiration Date 01/22/2025

Hum Miami-Dade Product Control


P.E. STAMP

#### **RICE**

#### **ENGINEERING**

105 School Creek Trail Luxemburg, WI 54217 Phone: (920) 617-1042 Fax: (920) 617-1100 www.rice-inc.com

Florida Firm No: F-01000005061 Certificate of Authorization: #9090 Wayne K. Helmila Registration No: 59092

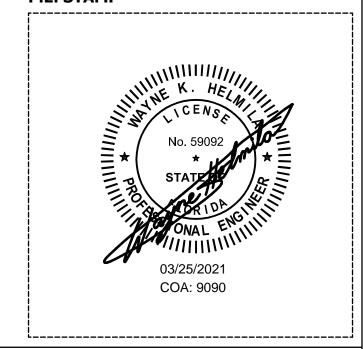

g	1			
SK	8	UPDATED FOR NOA RENEWAL	3/22/2021	NWW
2	7	REVISED PER MIAMI DADE COUNTY	7/30/2019	NWW
ב	6	UPDATED FOR NOA RENEWAL & REVISION	4/23/2019	JMR / NW
Š	5	CHANGED LOUVER MATERIAL TO 6063-T6	10/13/2014	NW
≷	4	REVISED PER MIAMI DADE COUNTY	8/22/2014	JG
S	3	REVISED PER RICE MARKUPS	4/23/2014	JG
Se	2	REVISED INSTALLATION DETAILS	1/27/2014	JG
/ز	REV.	DESCRIPTION	DATE	DRAWN BY

UNLESS OTHERWISE SPECIFIED DIMENSION ARE IN INCHES.

TOLERANCE UNLESS NOTED: ±0.030 X.XX ±0.015 ±0.013 ±1° X.XXX ANGLE FRACTION ±1/16

MAX HOLE BREAKOUT: 15% OF MATERIAL THICKNESS

5101 Blue Mound Road Fort Worth, Texas 76106 Phone: 817-509-2300 Fax: 817-831-3110

THIRD ANGLE PROJECTION



PCI INDUSTRIES DOING BUSINESS AS

**ARCHITECTURAL PRODUCTS** 

DRAWING DESCR: SINGLE SECTION WIDE X SINGLE SECTION HIGH - WOOD CONDITION
DIAWING DESCR. SINGLE SECTION WIDE A SINGLE SECTION HIGH - WOOD CONDITION


PROJECT: ECV-645-MD

LOCATION:

CUSTOMER: PROJ. MGR:

DRAWN BY: LGH DATE: 8/27/2013 ORDER NUMBER | P.O. NUMBER | DRAWING NUMBER CHK'D BY: NW SHEET: 7 of 12 SCALE: 3/4"=1'-0" ECV-645-MD NOA

p\Miami-Dade Updates (2020)\ECV-645-MD`

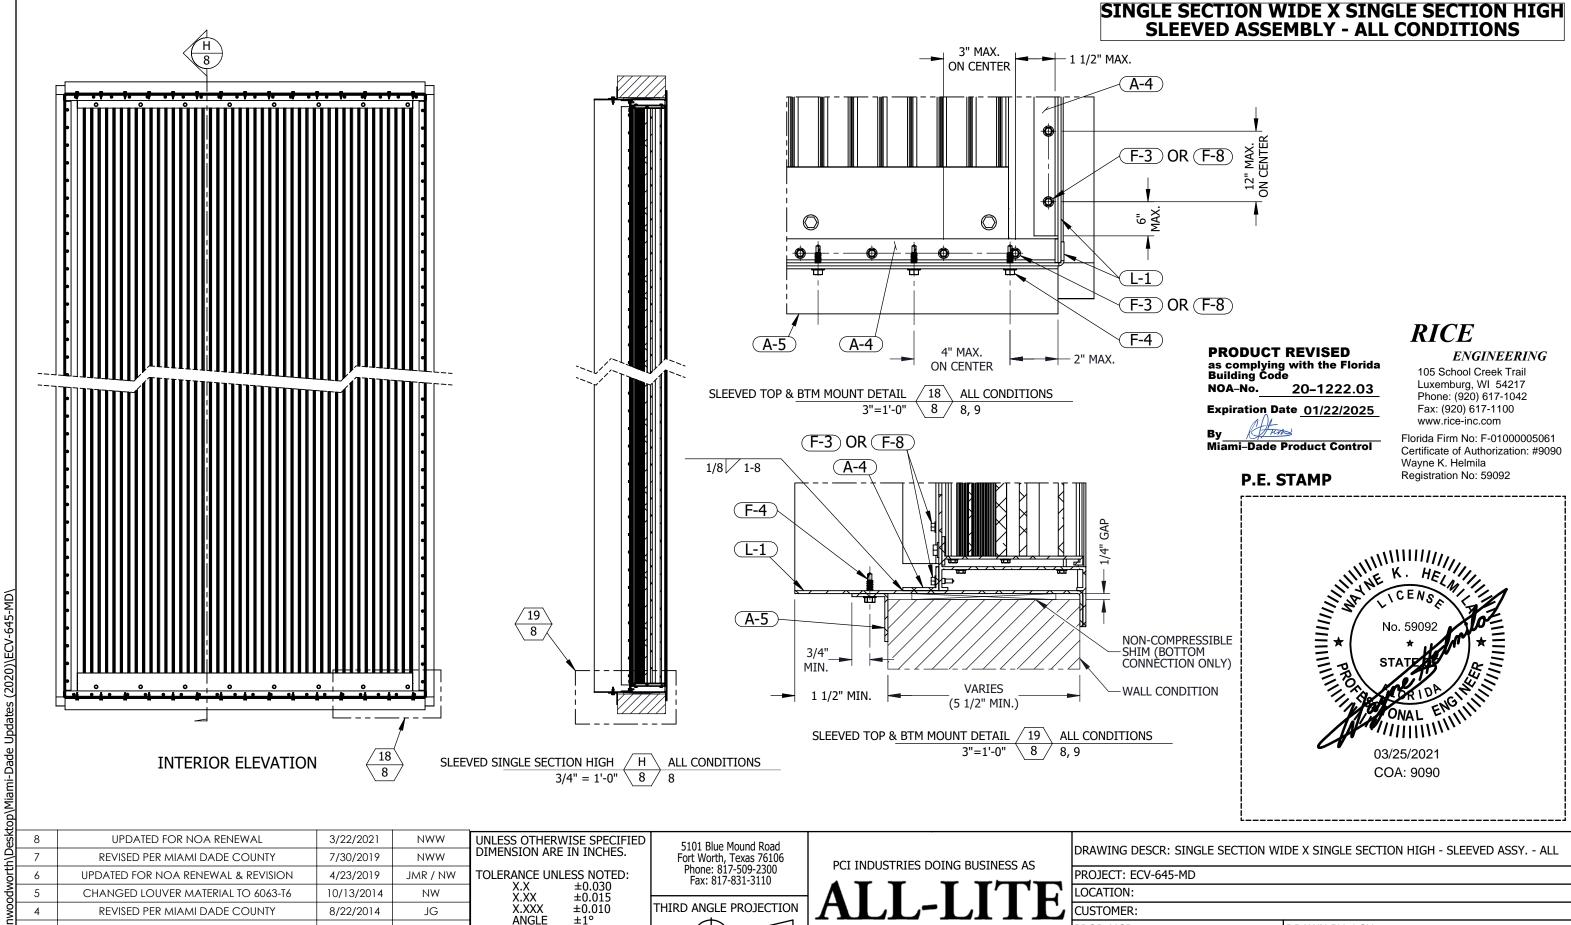

MAX HOLE BREAKOUT: 15% OF MATERIAL THICKNESS

FRACTION ±1/16

ANGLE

4

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2

REV.

REVISED PER RICE MARKUPS

**REVISED INSTALLATION DETAILS** 

**DESCRIPTION** 

4/23/2014


1/27/2014

JG

JG

DRAWN BY



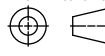

**ARCHITECTURAL PRODUCTS** 

CUSTOMER:

PROJ. MGR: DRAWN BY: LGH ORDER NUMBER | P.O. NUMBER | DRAWING NUMBER DATE: 8/27/2013

CHK'D BY: NW SHEET: 8 of 12 SCALE: 3/4"=1'-0' ECV-645-MD NOA

# MULTI-SECTION WIDE K ALL CONDITIONS 3/4"=1'-0" \ 9 / 9 16 7 14 6 12 6 10 5 8 5


INTERIOR ELEVATION
QUANTITY SECTIONS WIDE IS UNLIMITED

#### **RICE**

#### **ENGINEERING**


105 School Creek Trail Luxemburg, WI 54217 Phone: (920) 617-1042 Fax: (920) 617-1100 www.rice-inc.com

Florida Firm No: F-01000005061 Certificate of Authorization: #9090 Wayne K. Helmila Registration No: 59092

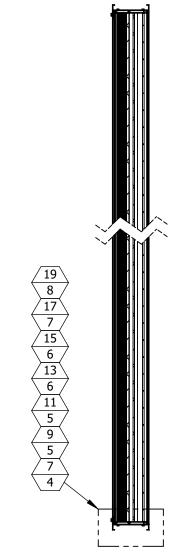

ALL CONDITIONS MULTI-SECTION WIDE 9 / 9 3/4"=1'-0"

# MULTI-SECTION WIDE X SINGLE SECTION HIGH - ALL CONDITIONS

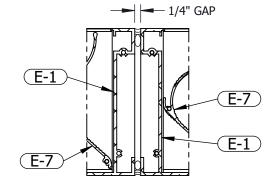

MULTI-SECTION WIDE 20 VERTICAL MULLION 3"=1'-0" 9 9

QUANTITY SECTIONS WIDE IS UNLIMITED


#### **PRODUCT REVISED**

as complying with the Florida Building Code NOA-No. 20-1222.03

Expiration Date 01/22/2025

Turos Miami-Dade Product Control

P.E. STAMP

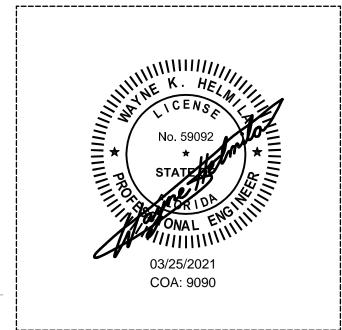

eski	8	UPDATED FOR NOA RENEWAL	3/22/2021	NWW
7	7	REVISED PER MIAMI DADE COUNTY	7/30/2019	NWW
ort	6	UPDATED FOR NOA RENEWAL & REVISION	4/23/2019	JMR / NW
nwoodwor	5	CHANGED LOUVER MATERIAL TO 6063-T6	10/13/2014	NW
MO	4	REVISED PER MIAMI DADE COUNTY	8/22/2014	JG
	3	REVISED PER RICE MARKUPS	4/23/2014	JG
Jsers	2	REVISED INSTALLATION DETAILS	1/27/2014	JG
7	RFV.	DESCRIPTION	DATE	DRAWN BY

ni-Dade Updates (2020)\ECV-645-MD\

UNLESS OTHERWISE SPECIFIED DIMENSION ARE IN INCHES.

TOLERANCE UNLESS NOTED: ±0.030 ±0.015 ±0.010 ±1° X.XXX **ANGLE** FRACTION ±1/16

MAX HOLE BREAKOUT: 15% OF MATERIAL THICKNESS

5101 Blue Mound Road Fort Worth, Texas 76106 Phone: 817-509-2300 Fax: 817-831-3110

THIRD ANGLE PROJECTIO



**ARCHITECTURAL PRODUCTS** 

PCI INDUSTRIES DOING BUSINESS AS

DRAWING DESCR: MULTI-SECTION WIDE X SINGLE SECTION HIGH - ALL CONDITION
---

PROJECT: ECV-645-MD

LOCATION:


CUSTOMER:

SHEET: 9 of 12

PROJ. MGR: DRAWN BY: LGH DATE: 8/27/2013 ORDER NUMBER | P.O. NUMBER | DRAWING NUMBER CHK'D BY: NW

SCALE: 3/4"=1'-0"

ECV-645-MD NOA

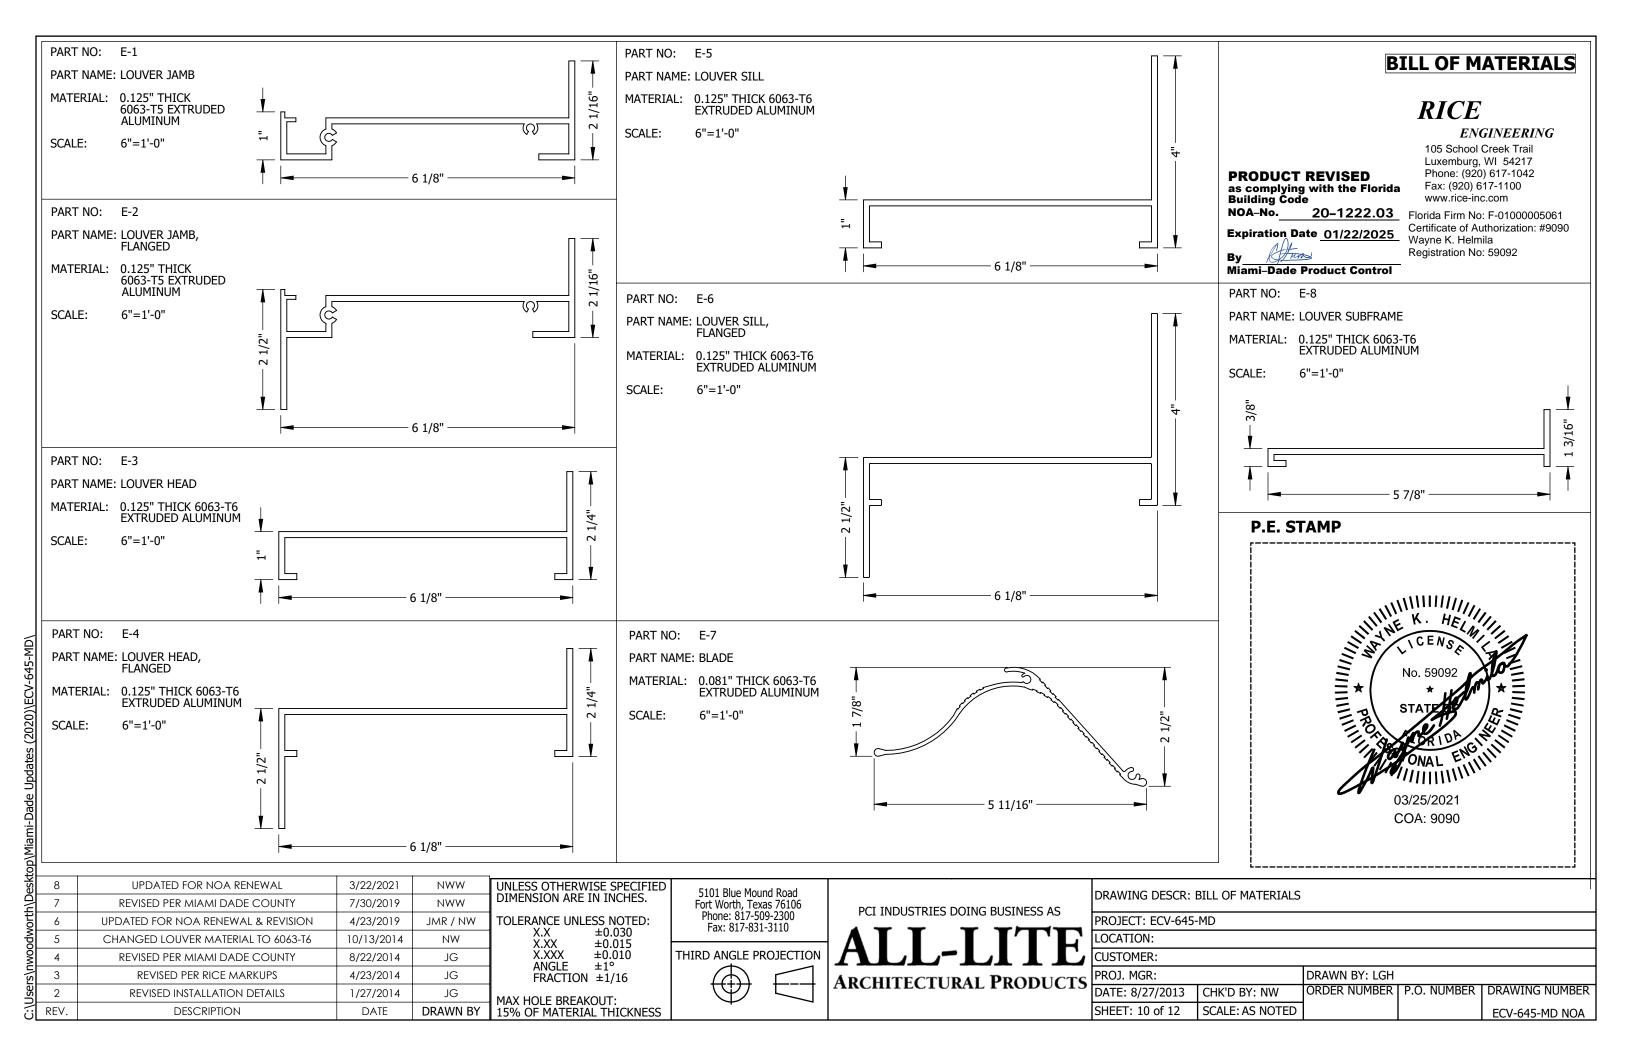


#### **BILL OF MATERIALS**

PART NO: A-1

PART NAME: CONTINUOUS ANGLE

MATERIAL: 3 1/2" X 1 1/2" X 1/8" THK. 6063-T6 EXTRUDED ALUMINUM

SCALE: FULL

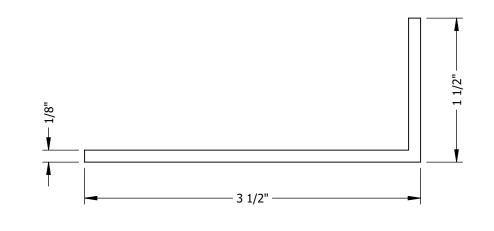


PART NO: A-3

PART NAME: SHELF ANGLE, CMU (CONTINUOUS)

MATERIAL: 6" X 4" X 3/8" THK.

6061-T6 EXTRUDED ALUMINUM

SCALE: 6"=1'-0"

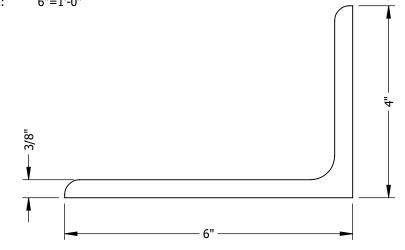

PART NO: L-1

PART NO: A-5

**FULL** 

MATERIAL:

SCALE:


PART NAME: SLEEVE

MATERIAL: 1/8" THK. 5052-H32 SHEET ALUMINUM

PART NAME: RETAINING ANGLE (CONTINUOUS)

2" X 1 1/2" X 1/8" THK. 6061-T6 EXTRUDED ALUMINUM

SCALE: 6"=1'-0"

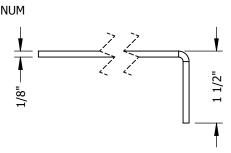

PART NO: A-2

PART NAME: SHELF ANGLE, CONCRETE (CONTINUOUS)

MATERIAL: 5" X 3" X 3/8" THK. 6061-T6 EXTRUDED ALUMINUM

UPDATED FOR NOA RENEWAL

REVISED PER MIAMI DADE COUNTY

**UPDATED FOR NOA RENEWAL & REVISION** 

CHANGED LOUVER MATERIAL TO 6063-T6


REVISED PER MIAMI DADE COUNTY

REVISED PER RICE MARKUPS

**REVISED INSTALLATION DETAILS** 

DESCRIPTION

SCALE: 6"=1'-0"

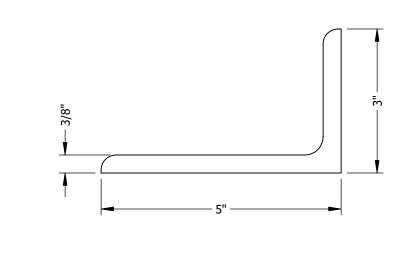

3/22/2021

7/30/2019

4/23/2019

10/13/2014

8/22/2014

4/23/2014

1/27/2014

NWW

NWW

JMR / NW

NW

JG

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JG


DRAWN BY

PART NO: A-4

PART NAME: SLEEVE ATTACHMENT ANGLE (CONTINUOUS)

MATERIAL: 1 1/2" X 1" X 1/8" THK. 6063-T5 EXTRUDED ALUMINUM

SCALE: **FULL** 

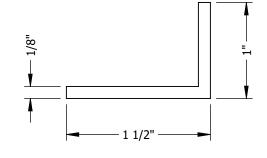

#### P.E. STAMP

as complying with the Florida Building Code 20-1222.03 03/25/2021 Expiration Date 01/22/2025 COA: 9090 Miami-Dade Product Control

RICE

**ENGINEERING** 

105 School Creek Trail Luxemburg, WI 54217 Phone: (920) 617-1042 Fax: (920) 617-1100 www.rice-inc.com

Florida Firm No: F-01000005061 Certificate of Authorization: #9090 Wayne K. Helmila Registration No: 59092

UNLESS OTHERWISE SPECIFIED DIMENSION ARE IN INCHES. TOLERANCE UNLESS NOTED:  $\pm 0.030$ X.XX ±0.015

±0.010 ±1°

FRACTION ±1/16 MAX HOLE BREAKOUT: 15% OF MATERIAL THICKNESS

X.XXX

ANGLE

5101 Blue Mound Road Fort Worth, Texas 76106 Phone: 817-509-2300 Fax: 817-831-3110

THIRD ANGLE PROJECTION



**ARCHITECTURAL PRODUCTS** 

PCI INDUSTRIES DOING BUSINESS AS

DRAWING DESCR: BILL OF MATERIALS

PROJECT: ECV-645-MD

**PRODUCT REVISED** 

Stuns

LOCATION:

CUSTOMER:

NOA-No.

SHEET: 11 of 12

PROJ. MGR: DRAWN BY: LGH ORDER NUMBER | P.O. NUMBER | DRAWING NUMBER DATE: 8/27/2013 CHK'D BY: NW

> SCALE: AS NOTED ECV-645-MD NOA

op\Miami-Dade Updates (2020)\ECV-645-MD\

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REV.

#### **BILL OF MATERIALS**

MISCELLANEOUS FASTENERS						
PART NO	DESCRIPTION					
F-1	#10-16 X 2" LONG, HWH, 410 SST, SELF-DRILLING SCREW					
F-2	1/4-20 X 3/4" LONG HEX BOLT WITH LOCKNUT AND FLAT WASHER, 18-8 SST					
F-3	#12-14 X 3/4" LONG, HWH, SELF-DRILLING SCREW, 300-SERIES SST					
F-4	1/4-14 X 1" LONG, HWH, SELF-DRILLING SCREW, 300-SERIES SST					
F-5	3/8" X 4" HILTI KH-EZ SCREW ANCHOR, 316 SST					
F-6	3/8" X 3 1/2" HILTI KH-EZ SCREW ANCHOR, 316 SST					
F-7	1/2" X 3 1/2" LONG HEX LAG BOLT AND FLAT WASHER, 300-SERIES SST					
F-8	#12-14 X 3/4" LONG, HWH, SELF-DRILLING SCREW, ULTRA-CORROSION-RESISTANT COATED STEEL (ELCO DRIL-FLEX)					

PRODUCT REVISED
as complying with the Florida
Building Code

NOA-No. 20-1222.03

Expiration Date 01/22/2025

By Miami-Dade Product Control


#### **RICE**

#### **ENGINEERING**

105 School Creek Trail Luxemburg, WI 54217 Phone: (920) 617-1042 Fax: (920) 617-1100 www.rice-inc.com

Florida Firm No: F-01000005061 Certificate of Authorization: #9090 Wayne K. Helmila Registration No: 59092

#### P.E. STAMP

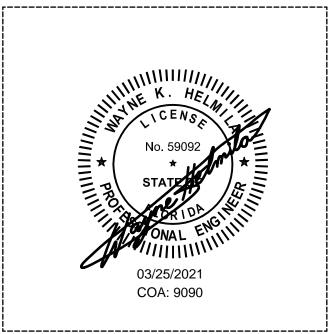

NOTE: ALL INSTALLATION FASTENERS AND ANCHORS SHOULD BE OF CORROSION-RESISTANT STEEL (300-SERIES STAINLESS OR HOT-DIP GALVANIZED)

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esk	8	UPDATED FOR NOA RENEWAL	3/22/2021	NWW	π
2	7	REVISED PER MIAMI DADE COUNTY	7/30/2019	NWW	ם
5	6	UPDATED FOR NOA RENEWAL & REVISION	4/23/2019	JMR / NW	٦
Š	5	CHANGED LOUVER MATERIAL TO 6063-T6	10/13/2014	NW	1
Š	4	REVISED PER MIAMI DADE COUNTY	8/22/2014	JG	1
2	3	REVISED PER RICE MARKUPS	4/23/2014	JG	1
Š	2	REVISED INSTALLATION DETAILS	1/27/2014	JG	١,
<u>ر</u>	REV.	DESCRIPTION	DATE	DRAWN BY	1

UNLESS OTHERWISE SPECIFIED DIMENSION ARE IN INCHES.

 $\begin{array}{ll} \text{TOLERANCE UNLESS NOTED:} \\ \text{X.X} & \pm 0.030 \\ \text{X.XX} & \pm 0.015 \\ \text{X.XXX} & \pm 0.010 \\ \text{ANGLE} & \pm 1^{\circ} \\ \text{FRACTION} & \pm 1/16 \end{array}$ 

MAX HOLE BREAKOUT: 15% OF MATERIAL THICKNESS 5101 Blue Mound Road Fort Worth, Texas 76106 Phone: 817-509-2300 Fax: 817-831-3110

THIRD ANGLE PROJECTION



ALL-LITE
ARCHITECTURAL PRODUCTS

	DRAWING DESCR: BILL OF MATERIALS					
	PROJECT: ECV-645-MD					
	LOCATION:					
CUSTOMER:						
	PROJ. MGR:		DRAWN BY: LGH			
,	DATE 0/27/2042   CI	11 (ID D) ( A D) ( (	ODDED MILIMPED I	D O NILIMDED	DDAM/TNIC NI	IMPED

DATE: 8/27/2013 CHK'D BY: NW ORDER NUMBER P.O. NUMBER DRAWING NUMBER
SHEET: 12 of 12 SCALE: AS NOTED ECV-645-MD NOA