

MIAMI-DADE COUNTY PRODUCT CONTROL SECTION

11805 SW 26 Street, Room 208 Miami, Florida 33175-2474 T (786) 315-2590 F (786) 315-2599

www.miamidade.gov/economy

NOTICE OF ACCEPTANCE (NOA)

Nortek Air Solutions, Inc. 4841 North Sewell Oklahoma City, OK 73118

SCOPE:

This NOA is being issued under the applicable rules and regulations governing the use of construction materials. The documentation submitted has been reviewed and accepted by Miami-Dade County RER- Product Control Section to be used in Miami Dade County and other areas where allowed by the Authority Having Jurisdiction (AHJ).

This NOA shall not be valid after the expiration date stated below. The Miami-Dade County Product Control Section (In Miami Dade County) and/or the AHJ (in areas other than Miami Dade County) reserve the right to have this product or material tested for quality assurance purposes. If this product or material fails to perform in the accepted manner, the manufacturer will incur the expense of such testing and the AHJ may immediately revoke, modify, or suspend the use of such product or material within their jurisdiction. RER reserves the right to revoke this acceptance if it is determined by Miami-Dade County Product Control Section that this product or material fails to meet the requirements of the applicable building code.

This product is approved as described herein and has been designed to comply with the High Velocity Hurricane Zone of the Florida Building Code.

DESCRIPTION: Series "ITF" Air Handling Unit

APPROVAL DOCUMENT: Drawing No. MD-2019.01.07, titled "Series "ITF" Air Handling Unit", sheets 1 through 11 of 11, prepared by Nortek Air Solutions, Inc., dated May 15, 2021, signed and sealed by Robert James Amoruso, P.E., on May 15, 2021, bearing the Miami-Dade County Product Control Revision stamp with the Notice of Acceptance number and the expiration date by the Miami-Dade County Product Control Section.

MISSILE IMPACT RATING: Large and Small Missile Impact Resistant

LABELING: Each panel shall bear a permanent label with the manufacturer's name or logo, Okarche, OK or Oklahoma City, OK and the following statement: "Miami-Dade County Product Control Approved", unless otherwise noted herein.

RENEWAL of this NOA shall be considered after a renewal application has been filed and there has been no change in the applicable building code negatively affecting the performance of this product.

TERMINATION of this NOA will occur after the expiration date or if there has been a revision or change in the materials, use, and/or manufacture of the product or process. Misuse of this NOA as an endorsement of any product, for sales, advertising or any other purposes shall automatically terminate this NOA. Failure to comply with any section of this NOA shall be cause for termination and removal of NOA.

ADVERTISEMENT: The NOA number preceded by the words Miami-Dade County, Florida, and followed by the expiration date may be displayed in advertising literature. If any portion of the NOA is displayed, then it shall be done in its entirety.

INSPECTION: A copy of this entire NOA shall be provided to the user by the manufacturer or its distributors and shall be available for inspection at the job site at the request of the Building Official.

This NOA revises NOA #20-0213.06 and consists of this page 1, evidence submitted pages E-1 and E-2 as well as approval document mentioned above.

The submitted documentation was reviewed by Helmy A. Makar, P.E., M.S.

MIAMI-DADE COUNTY
APPROVED

Hely A. Melor 07/22/2021

NOA No. 21-0521.05 Expiration Date: 04/25/2024 Approval Date: 07/22/2021

Page 1

Nortek Air Solutions, Inc.

NOTICE OF ACCEPTANCE: EVIDENCE SUBMITTED

1. EVIDENCE SUBMITTED UNDER PREVIOUS APPROVAL #19-0227.05

A. DRAWINGS

1. Drawing titled "Series "ITF" Air Handling Unit", sheets 1 through 11 of 11, prepared by Nortek Air Solutions, Inc., dated Feb. 13, 2019, signed and sealed by Robert James Amoruso, P.E., on Feb. 21, 2019.

B. TESTS

1. Test report on Large Missile Impact Test per TAS-201, Cyclic Wind Pressure Test per TAS-203 and Uniform Static Air Pressure Test per TAS-202 of Series ITF Air Handling Unit, prepared by NCTL, Report No. NCTL-210-4132-01, dated 02/01/2019, signed and sealed by Douglas J. McDougall, P.E.

C. CALCULATIONS

1. Anchoring of base to building or this structure is not part of this approval and is the responsibility of the Architect or Engineer of Record.

D. QUALITY ASSURANCE

1. By Miami-Dade County Department of Regulatory and Economic Resources.

E. MATERIAL CERTIFICATIONS

1. None.

F. STATEMENTS

1. FBC, 2017 Edition Compliance letter prepared by Robert James Amoruso, P.E., dated February 21, 2019, signed and sealed by Robert James Amoruso, P.E.

2. EVIDENCE SUBMITTED UNDER PREVIOUS APPROVAL #20-0213.06

A. DRAWINGS

1. Drawing titled "Series "ITF" Air Handling Unit", sheets 1 through 11 of 11, prepared by Nortek Air Solutions, Inc., dated Feb. 12, 2020, signed and sealed by Robert James Amoruso, P.E., on Feb. 12, 2020.

B. TESTS

1. None.

C. CALCULATIONS

1. None.

D. **QUALITY ASSURANCE**

1. By Miami-Dade County Department of Regulatory and Economic Resources.

F. MATERIAL CERTIFICATIONS

1. None.

Helmy A. Makar, P.E., M.S. Product Control Section Supervisor NOA No. 21-0521.05

> Expiration Date: 04/25/2024 Approval Date: 07/22/2021

Nortek Air Solutions, Inc.

NOTICE OF ACCEPTANCE: EVIDENCE SUBMITTED

3. NEW EVIDENCE SUBMITTED

A. DRAWINGS

1. Drawing No. MD-2019.01.07, titled "Series "ITF" Air Handling Unit", sheets 1 through 11 of 11, prepared by Nortek Air Solutions, Inc., dated May 15, 2021, signed and sealed by Robert James Amoruso, P.E., on May 15, 2021.

B. TESTS

1. None.

C. CALCULATIONS

1. None.

D. QUALITY ASSURANCE

1. By Miami-Dade County Department of Regulatory and Economic Resources.

E. MATERIAL CERTIFICATIONS

1. None.

F. STATEMENTS

1. FBC, 2020 Edition Compliance letter prepared by Robert James Amoruso, P.E., dated May 15, 2021, signed and sealed by Robert James Amoruso, P.E.

Helmy A. Makar, P.E., M.S. Product Control Section Supervisor

NOA No. 21-0521.05

Expiration Date: 04/25/2024 Approval Date: 07/22/2021

NOTES:

- 1. THE PRODUCT SHOWN HEREIN IS DESIGNED AND MANUFACTURED TO COMPLY WITH REQUIREMENTS OF THE 7th EDITION (2020) FLORIDA BUILDING CODE.
- 2. ALL SUPPORTIVE STRUCTURE UNDER THE AIR HANDLING UNIT (AHU) SUCH AS CONCRETE OR STEEL STRUCTURE TO BE PROPERLY DESIGNED TO TRANSFER ALL LOADS TO SAID STRUCTURE. ANCHORING OF BASE TO BUILDING OR THIS STRUCTURE IS NOT PART OF THIS APPROVAL AND IS THE RESPONSIBILITY OF THE ARCHITECT OR ENGINEER OF RECORD.
- 3. ALL JOINTS OF STRUCTURAL STEEL MEMBERS ARE CONTINUOUSLY WELDED.
- 4. UNIT BASE AS SHOWN IS COMPLETELY PRIMED AND PAINTED.
- 5. INTERNAL FLOOR MEMBER SPACING ARE 24" (MAX).
- 6. AHU SIZE CAN VARY BUT SPACING OF STEEL FRAMEWORK NOT TO EXCEED MAXIMUM ROOF/FLOOR AND WALL PANEL WIDTH AS SHOWN ON SHEET 2.
- 7. DESIGN AND SIZE OF STEEL BASE/FRAMEWORK WILL VARY DEPENDING ON THE STRUCTURAL ADEQUACY REQUIRED.
- 8. SPRAY FOAM INSULATION THERMAL AND ACOUSTICAL PROPERTIES MEET 3LB DENSITY RATING.
- 9. STANDARD INNER LINER ARE SOLID 20ga. (.0396" MIN) STEEL, SST OR ALUMINUM WHICH MAY BE USED IN ANY COMBINATION AS MAY BE REQUIRED THROUGHOUT THE AHU CABINET.

REVISIONS REV. LEVEL DESCRIPTION BY DATE ADDED NUMBERS TO GENERAL NOTES, UPDATED **JRM** 6/19/2019 A 6A IN BILL OF MATERIALS CORRECTED ROOF PANEL В 2/12/2020 PRESSURES ON SHEET 2 UPDATE TO 7TH EDITION С 5/15/2021 **RJA** (2020) FBC

	PARTS LIST	
NO.	DESCRIPTION	MATERIAL/REFERENCE
1	BASE TUBE, 2x5x1/8 (MIN)	STEEL
2	INTERNAL CHANNEL, NO TABS, 3" FLANGE, 5" HIGH	HR STEEL
3	INTERNAL CHANNEL, END TABS, 3" FLANGE, 5" HIGH	HR STEEL
4	INTERNAL CHANNEL, END TABS, 5" HIGH	HR STEEL
5	GASKET, 1x1/4	PVC PSA
6	FOAM, SPRAY, 2 PART	
6A	FIBERGLASS INSULATION	
7	FLOOR, SHEET, GALV	STEEL, SST, HR STEEL, ALUMINUM
8	SUB-FLOOR	
9	LIFTING LUG	STEEL
10	EXTERIOR LINER PANEL	STEEL, SST, ALUMINUM
11	INTERIOR LINER	STEEL, SST, ALUMINUM
12	SCREW, 1/4-14x2-3/4 TEK	STEEL
13	WALL/ROOF TUBE, PENTA, 16ga (MIN)	STEEL
14	WALL/ROOF ROLLED FORMED TUBE, 16ga (MIN)	STEEL
15	DOOR JAMB FRAME	ALUMINUM
16	DOOR FRAME	ALUMINUM
17	DOOR EXTERIOR LINER 0.039" (MIN)	STEEL, SST
18	DOOR INTERIOR LINER 0.039" (MIN)	STEEL, SST, ALUMINUM
19	HINGE, HEAVY DUTY	STEEL
20	LATCH ASSEMBLY	
21	SCREW, #12x1 TEK	STEEL

Nortek Air Solutions 106 North Industrial Boulevard Okarche, OK 73762

SERIES: ITF AIR HANDLING UNIT

GENERAL NOTES AND PARTS LIST

MD - 2019,01,07

DRAWN: DWG NO.

SCALE NTS

DATE 05/15/2021 SHEET 1 OF 11


734 S CENTER ST.
ORMOND BEACH, FL 32174
rjaengpe@gmail.com

OR LENGTH

ROBERT J. AMORUSO FL. P.E. NO. 49752

PRODUCT REVISED
as complying with the Florida
Building Code
Acceptance No 21-052/.65
Expiration Date 04/1251.65

mi Dade Floddet Control

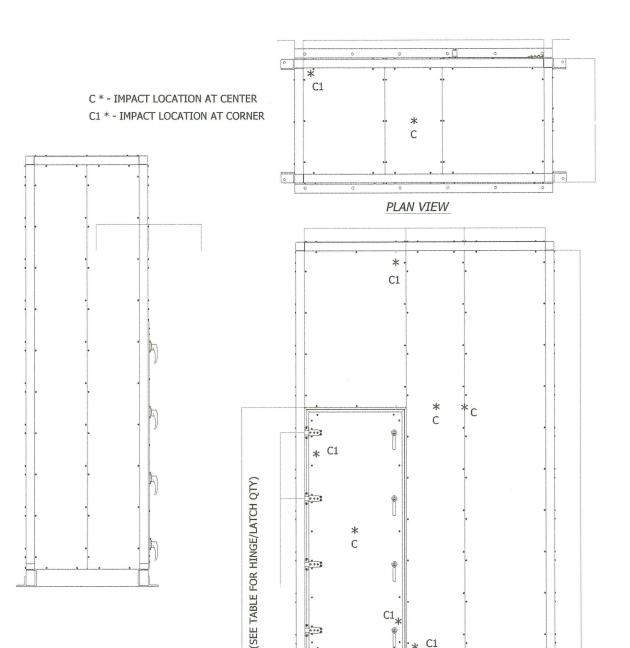

LEFT ELEVATION

* C1

FRONT ELEVATION

SAMPLE 1 - SIDE 1

APPROVED MAX.	SIZES FOR PANELS	
EXTERIOR LINER	INTERIOR LINER	
0.059" MIN.	0.0396" MIN.	
G-90 GALV.	G-90 GALV, SST, ALUM	
30 x 117.5	30 x 117.5	
24 x 117.5	24 x 117.5	
17 x 117.5	17 x 117.5	
15.5 x 117.5	15.5 x 117.5	
24 x 31	24 x 31	
17 X 31	17 X 31	
30 X 31	30 X 31	

- 10 ga Stiffener channel attached with ¹/₄" X 1" HH Self Drill Screws

FASTENERS PANELS SECURED TO THE STEEL FRAME WITH 1/4" X 2-3/4" HH SELF DRILL SCREWS WITH NEOPRENE WASHERS AT 12" O.C. (MAX.)

UNIT BASE FULLY WELDED TUBULAR STEEL, 0.120 (MIN.) THICKNESS WITH STRUCTURAL FLOOR PANEL SUPPORTS 24" WIDE MAX (SEE NOTES ON SHEET 4)

UNIT FLOORS INNER FLOOR IS 0.059" (MIN) HR STEEL OUTER FLOOR IS 0.0396" (MIN) G-90 GALV. STEEL

UNIT FRAMEWORK .059" (MIN.) STEEL FRAMEWORK AT 30" O.C. (MAX.)

ACCESS DOOR (30" x 72") 0.059" (MIN.) G-90 GALV. (OUTER) 0.0396" (MIN.) G-90 (INNER) ALLEGIS HANDLES HEAVY DUTY HINGES BY TEMTROL (SST) HINGE/LATCH QTY = 2 HINGE/LATCH COMBO PER DOOR AND NO LESS THAN 1 COMBO PER 3.75 SQ. FT. OF NOMINAL DOOR AREA.

GALV or SS UNIT CONSTRUCTION

WALL AND ROOF PANEL D	ESIGN PRESSURE RATING
WALL PANEL	ROOF PANEL
 +/- 135.0 PSF	+/- 101.25 PSF

ALUM PANEL UNIT CONSTRUCTION

1	WALL AND ROOF PANEL I	DESIGN PRESSURE RATING
	WALL PANEL	ROOF PANEL
	+/- 120.0 PSF	+/- 90.0 PSF

Okarche, OK 73762

SERIES: ITF AIR HANDLING UNIT

DWG NO. MD-2019.01.07

Nortek Air Solutions 106 North Industrial Boulevard

PANEL ASSEMBLY

SHEET 2 OF 11 SCALE NTS DATE 05/15/2021

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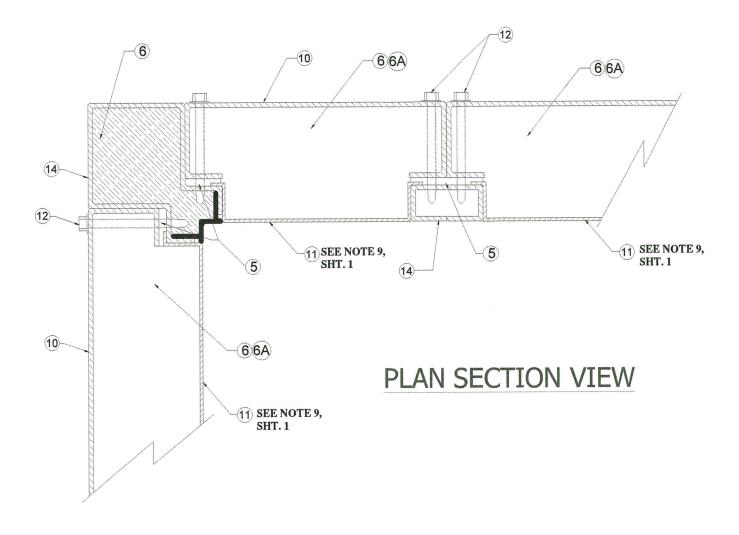
ROBERT J. AMORUSO

FL. P.E. NO. 49752

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PRODUCT REVISED

RIGHT ELEVATION



PRODUCT REVISED
as complying with the Florida
Building Code
Acceptance No 2 1 - 0 85 21.05
Expiration Date 6 4/25/2024
By Held H. M.

Nortek Air Solutions 106 North Industrial Boulevard Okarche, OK 73762

SERIES: ITF AIR HANDLING UNIT

PANEL/FRAME CONSTRUCTION

DRAWN: DWG NO. REV MD-2019.01.07 C

SCALE NTS DATE 05/15/2021 SHEET 3 OF 11

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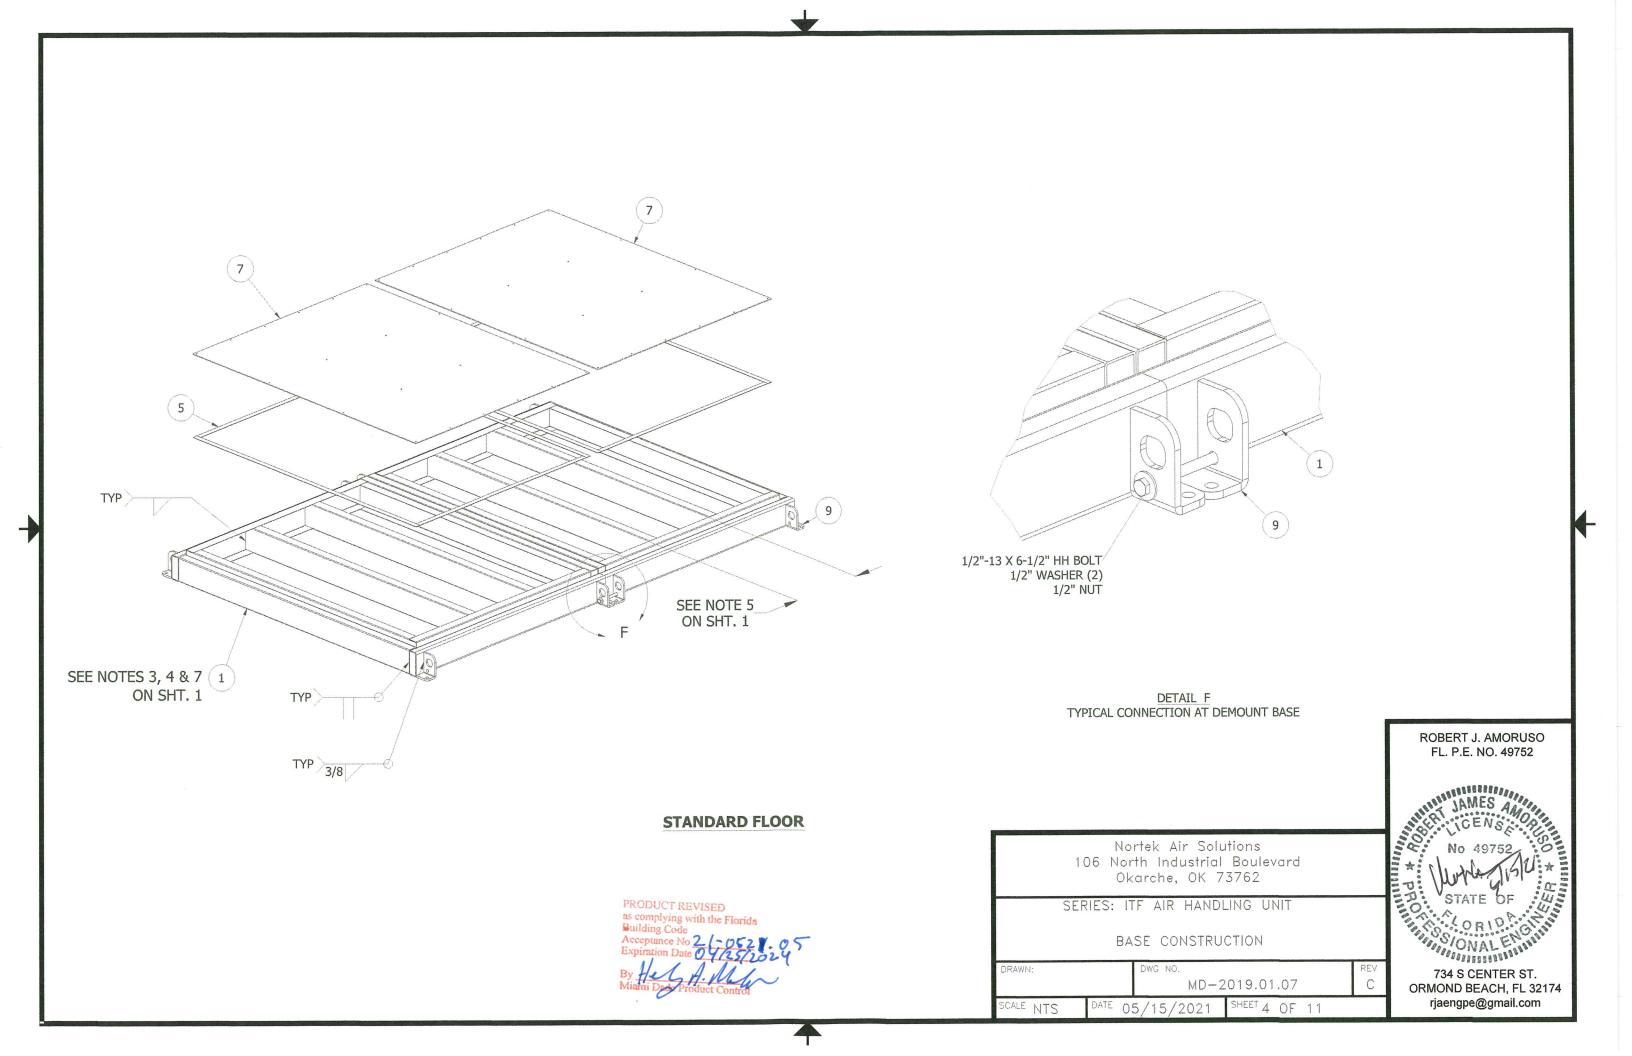
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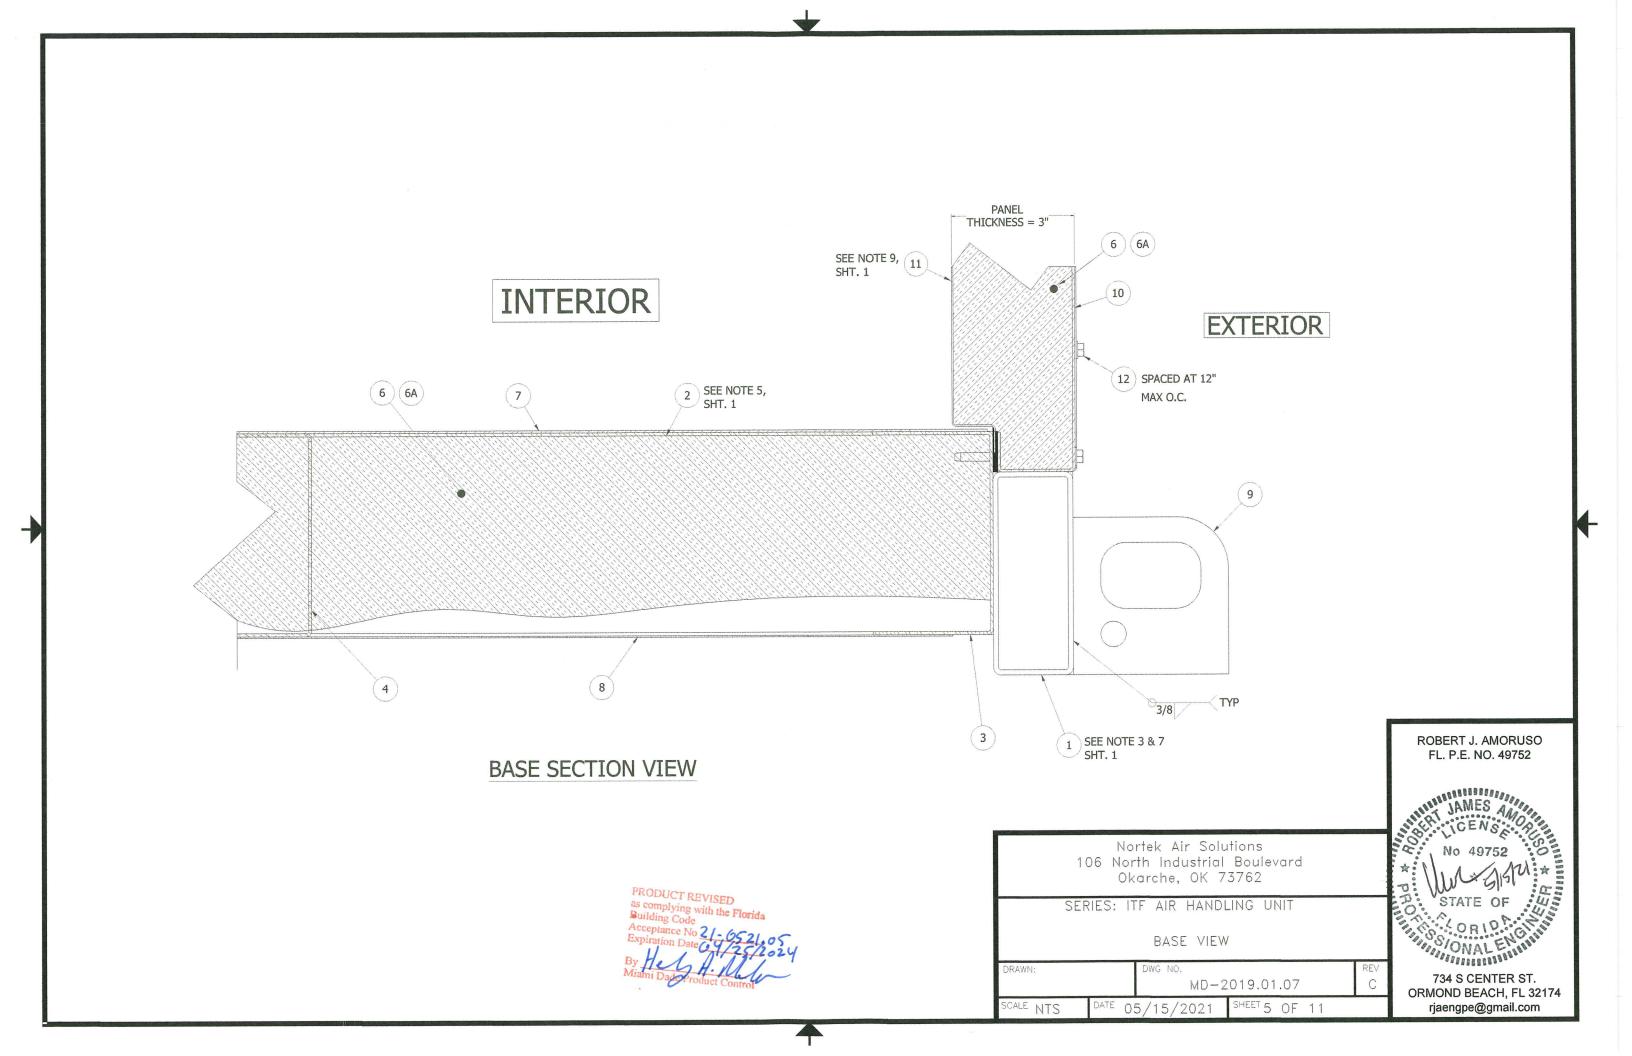
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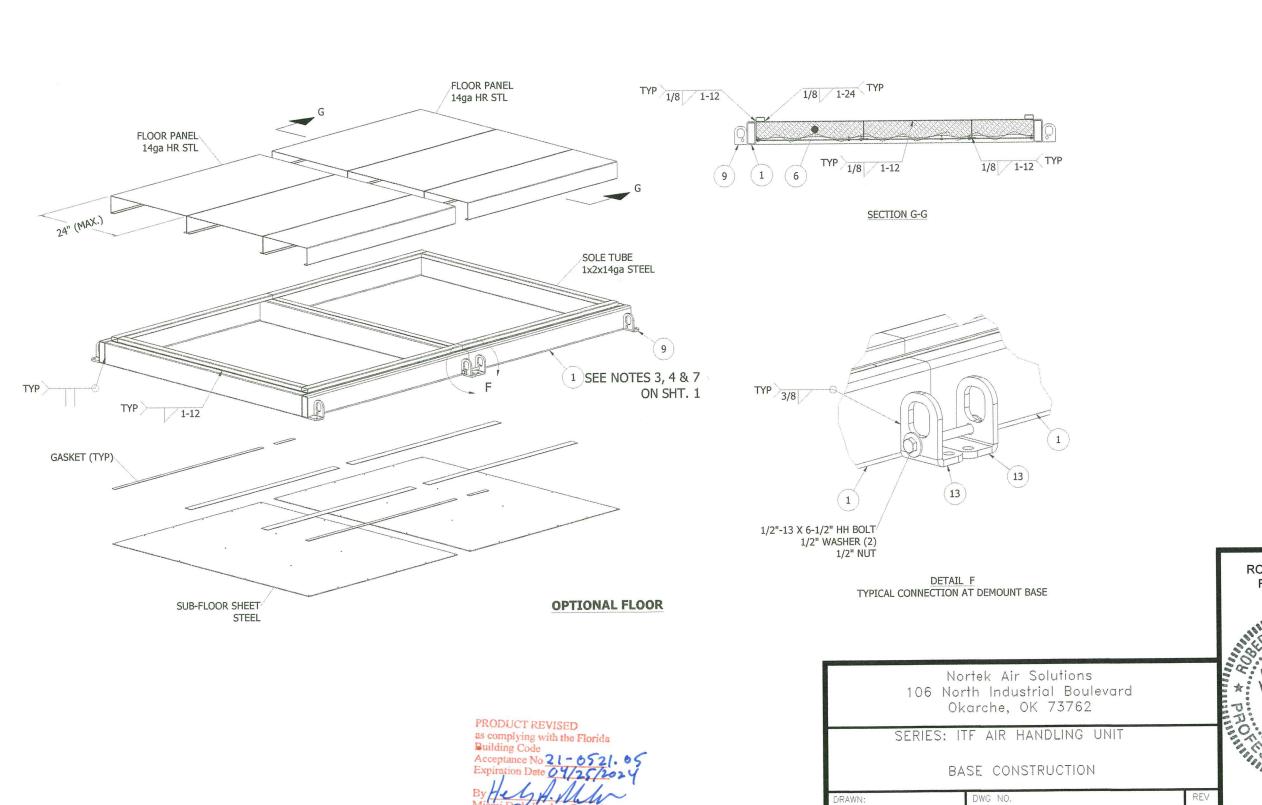
STATE OF

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ROBERT J. AMORUSO FL. P.E. NO. 49752

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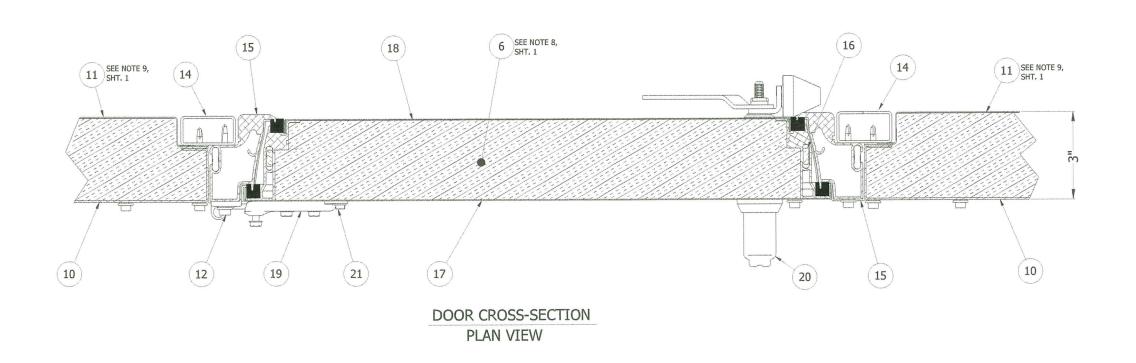
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MD-2019.01.07

DATE 05/15/2021

SCALE NTS

SHEET 6 OF 11





Nortek Air Solutions
106 North Industrial Boulevard
Okarche, OK 73762

SERIES: ITF AIR HANDLING UNIT

DOOR DETAIL

DRAWN:

DWG NO.

MD-2019.01.07

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SCALE NTS

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SCALE NTS

DATE 05/15/2021

SHEET 7 OF 11

ROBERT J. AMORUSO
FL. P.E. NO. 49752

JAMES
AMORUSO
FL. P.E. NO. 49752


JAMES
NO. 49752

STATE OF


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ORMOND BEACH, FL 32174

ORMOND BEACH, FL 32176 rjaengpe@gmail.com

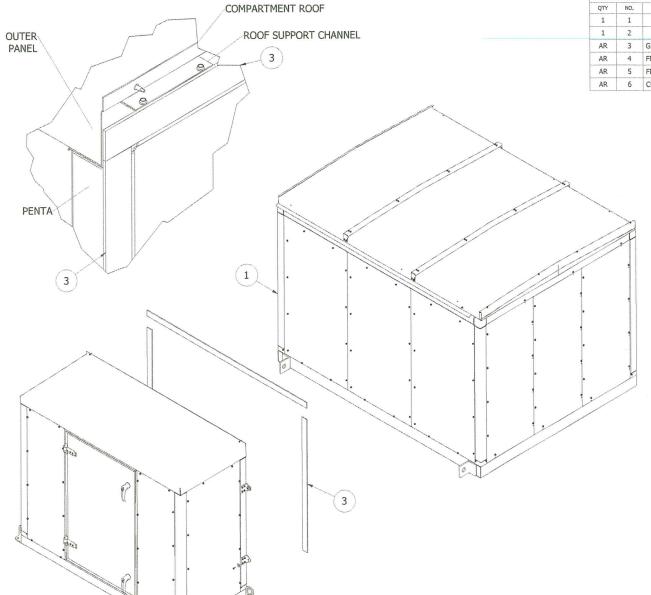

			PARTS LIST		
QTY	NO.	ITEM NUMBER	DESCRIPTION	MATERIAL	REMARKS
1	1		UNIT SECTION		
1	2		ASSEMBLY, PENTA PIPE HOUSE, ITF		
AR	3	GKFM0150	TEM 30, PVC, FOAM TAPE, 5/16 X 2		
AR	4	FNWS0009	WASHER, FENDER, 5/16" X 1-1/2", ZP		
AR	5	FNSC0031	SCREW, SELF- DRILLING, RUBER WASHER, TEK #12-14 X 1 LG, 5/16" HWH, 3PT		
AR	6	CKXX0030	MASTERWELD 620, SLATE, ELASTROMERIC ADHESIVE		

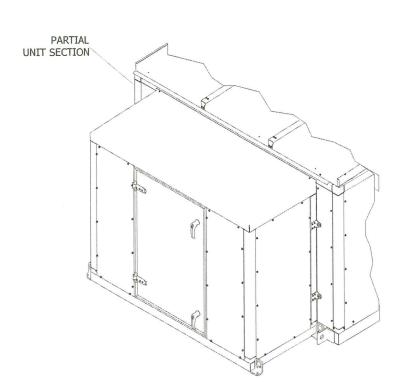

SCALE NTS

OUTDOOR OPTION: WATERSHED ROOF

PRODUCT REVISED

Nortek Air Solutions 106 North Industrial Boulevard Okarche, OK 73762

SERIES: ITF AIR HANDLING UNIT

PIPE HOUSE ATTACHMENT

MD-2019.01.07 SHEET 8 OF 11


DATE 05/15/2021


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ROBERT J. AMORUSO FL. P.E. NO. 49752

			PARTS LIST			
QTY	NO.	ITEM NUMBER	DESCRIPTION	MATERIAL	REMARKS	
1	1		UNIT SECTION			
1	2		ASSEMBLY, PENTA PIPE HOUSE, ITF			
AR	3	GKFM0150	TEM 30, PVC, FOAM TAPE, 5/16 X 2			
AR	4	FNWS0009	WASHER, FENDER, 5/16" X 1-1/2", ZP			
AR	5	FNSC0031	SCREW, SELF- DRILLING, RUBER WASHER, TEK #12-14 X 1 LG, 5/16" HWH, 3PT			
AR	6	CKXX0030	MASTERWELD 620, SLATE, ELASTROMERIC ADHESIVE			



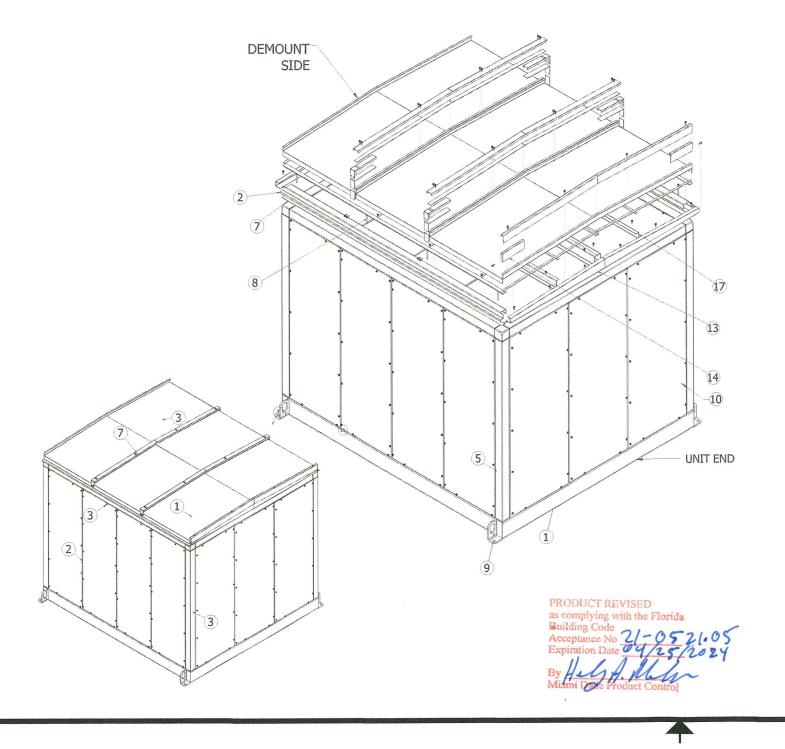

Nortek Air Solutions 106 North Industrial Boulevard Okarche, OK 73762

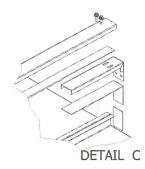SERIES: ITF AIR HANDLING UNIT

WATERSHED ROOF

DRAWN: DWG NO. MD-2019.01.07 CO

No 49752

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ROBERT J. AMORUSO FL. P.E. NO. 49752


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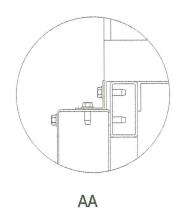
USE ONLY MIAMI DADE APPROVED LOUVER INSTALLED IN ACCORDANCE WITH THE MANUFACTURER'S INSTALLATION INSTRUCTIONS.

NOA APPROVED RUSKIN LOUVER EME6625D (#20-0909.05 OR LATER). ATTACHMENT SHOWN BELOW.


LOUVER IS ATTACHED TO THE FRAME OF THE NOA CERTIFIED UNIT USING 1/4"-14 X 1-3/4" TEK SCREWS RATED AT 1145 LBS PULL OUT STRENGTH EACH.

ALL ATTCHMENT HARDWARE AND MATERIAL ARE PROVIDED BY NORTEK AIR SOLUTIONS.



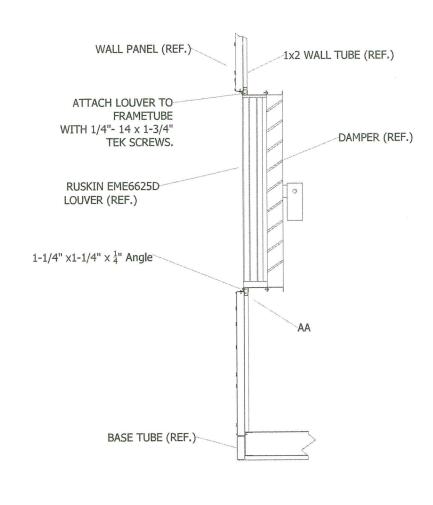

PRODUCT REVISED
as complying with the Florida
Building Code
Acceptance No 21-0521.05
Expiration Date 04/25/2024

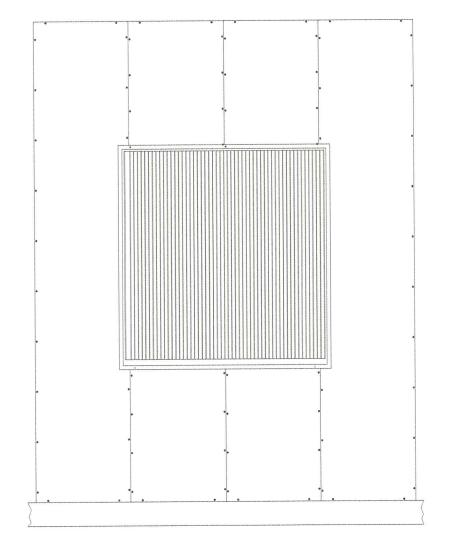

Nortek Air Solutions 106 North Industrial Boulevard Okarche, OK 73762

SERIES: ITF AIR HANDLING UNIT


LOUVER ATTACHMENT

DRAWN: DWG NO. RE MD-2019.01.07

SHEET 10 OF 11


DATE 05/15/2021


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Nortek Air Solutions 106 North Industrial Boulevard Okarche, OK 73762

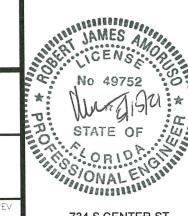SERIES: ITF AIR HANDLING UNIT

DATE 05/15/2021

BOX ELEVATION

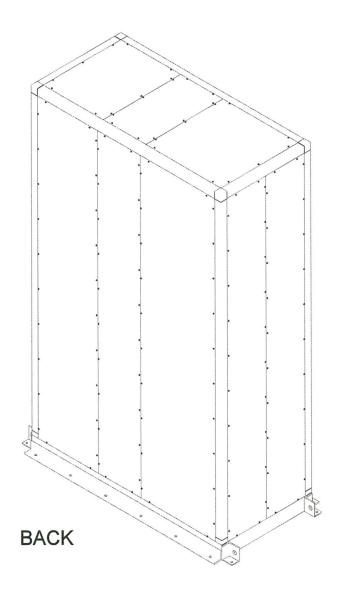DWG NO. MD-2019.01.07 SCALE NTS SHEET 11 OF 11

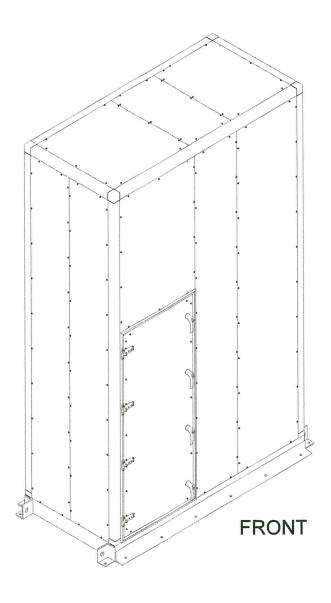ROBERT J. AMORUSO FL. P.E. NO. 49752 STATE OF STA

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