

MIAMI-DADE COUNTY PRODUCT CONTROL SECTION

11805 SW 26 Street, Room 208 Miami, Florida 33175-2474 T (786) 315-2590 F (786) 315-2599 www.miamidade.gov/building

DEPARTMENT OF REGULATORY AND ECONOMIC RESOURCES (RER) BOARD AND CODE ADMINISTRATION DIVISION

NOTICE OF ACCEPTANCE (NOA)

Allegion Access Technologies, LLC 65 Scott Swamp Road Farmington, CT 06032

SCOPE:

This NOA is being issued under the applicable rules and regulations governing the use of construction materials. The documentation submitted has been reviewed and accepted by Miami-Dade County RER -Product Control Section to be used in Miami Dade County and other areas where allowed by the Authority Having Jurisdiction (AHJ).

This NOA shall not be valid after the expiration date stated below. The Miami-Dade County Product Control Section (In Miami Dade County) and/or the AHJ (in areas other than Miami Dade County) reserve the right to have this product or material tested for quality assurance purposes. If this product or material fails to perform in the accepted manner, the manufacturer will incur the expense of such testing and the AHJ may immediately revoke, modify, or suspend the use of such product or material within their jurisdiction. RER reserves the right to revoke this acceptance, if it is determined by Miami-Dade County Product Control Section that this product or material fails to meet the requirements of the applicable building code.

This product is approved as described herein and has been designed to comply with the Florida Building Code, including the High Velocity Hurricane Zone.

DESCRIPTION: Series "Dura Storm" Aluminum Automatic Sliding Glass Door: O-Sx-Sx-O, Sx-O w/ wo Transom, So-Sx-Sx-So and Sx-So w/wo Transom & Breakout –NI

APPROVAL DOCUMENT: Drawing No. **20-33204** (former **14-1854**), titled "Dura-Storm 2000/3000 Auto SGD Bi-Parting /Single Slide-NI", sheets 1 through 19 of 19, prepared by Engineering Express, dated 08/23/17 and last revised on FEB 10, 2023, signed and sealed by Frank L. Bennardo, P.E., bearing the Miami-Dade County Product Control Revision stamp with the Notice of Acceptance number and expiration date by the Miami-Dade County Product Control Section.

MISSILE IMPACT RATING: None. Approved Hurricane Protection devices are required per FBC, as applicable.

LIMITATIONS:

- 1. See elevation for anchors requirements in sheets 1, 2 & 3 and Header clusters details in sheet 7 and Threshold clusters in sheet 12. The 1/4" Power Tapper anchors at head/Jamb & Sill to be in min 3 Ksi concrete. See sheets 4, 5 & 6 for concealed 3-point locking (active panel) & 2-point (in-active). Also see applicable 2-point G-86 CVR panic devices (active/inactive panels) for series 3000 in sheets 5 & 6 to be used w/ Horizontal muntin bars (detail V, sheet 15) and DLO height not to exceed 36-3/4" max.
- 2. See details 1A/8, 3A/9 & 5A/10 for Transom nested reinforcements item #101 for Bi-Parting series 2000 (O-Sx-Sx-O) and series 3000 (So-Sx-Sx-So). The Single Slide O-Sx and So-Sx require light reinforcement item #73.
- 3. Electrical devices, functions and installation is not part of this approval and to be reviewed and approved by Authority Having Jurisdiction (AHJ)
- 4. See Door panel and Transom glazing details in sheets 16 & 18. Fixed glass more than 36" wide must be supported with approved setting blocks per FBC requirements.
- 5. Not approved where water infiltration is required.

MIAMI-DADE COUNTY
APPROVED

Ishaq I. Chands

NOA No. 22-1207.02 Expiration Date: April 11, 2028 Approval Date: March 09, 2023

Page 1 of 2



DEPARTMENT OF REGULATORY AND ECONOMIC RESOURCES (RER) BOARD AND CODE ADMINISTRATION DIVISION

NOTICE OF ACCEPTANCE (NOA)

PRODUCT CONTROL SECTION

11805 SW 26 Street, Room 208

Miami, Florida 33175-2474

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www.miamidade.gov/building

MIAMI-DADE COUNTY

Allegion Access Technologies, LLC 65 Scott Swamp Road Farmington, CT 06032

LABELING: Each unit shall bear a permanent label with the manufacturer's name or logo, city, state and series and following statement: "Miami-Dade County Product Control Approved", unless otherwise noted herein.

RENEWAL of this NOA shall be considered after a renewal application has been filed and there has been no change in the applicable building code negatively affecting the performance of this product

TERMINATION of this NOA will occur after the expiration date or if there has been a revision or change in the materials, use, and/or manufacture of the product or process. Misuse of this NOA as an endorsement of any product, for sales, advertising or any other purposes shall automatically terminate this NOA. Failure to comply with any section of this NOA shall be cause for termination and removal of NOA.

ADVERTISEMENT: The NOA number preceded by the words Miami-Dade County, Florida, and followed by the expiration date may be displayed in advertising literature. If any portion of the NOA is displayed, then it shall be done in its entirety.

INSPECTION: A copy of this entire NOA shall be provided to the user by the manufacturer or its distributors and shall be available for inspection at the job site at the request of the Building Official.

This NOA revises # 22-0830.08 (former Stanley Access Technologies, LLC), consists of pages 1 and 2 as well as evidence pages E-1, E-2, E-3, E-4 and E-5.

The submitted documentation was reviewed by Ishaq I. Chanda, P.E.



Ishaq I. Chands

NOA No. 22-1207.02 Expiration Date: April 11, 2028 Approval Date: March 09, 2023

Page 2 of 2

NOTICE OF ACCEPTANCE: EVIDENCE SUBMITTED

1. EVIDENCE SUBMITTED UNDER PREVIOUS NOA'S

A. DRAWINGS

- 1. Manufacturer's die drawings and sections (submitted under files below)
- 2. Drawing No. **14-1854** (former **12-SAT-15**), titled "Dura-Storm 2000/3000 Bi-Parting /Single slide-NI", sheets 1 through 19 of 19, prepared by Engineering Express, dated 07-01-12 and last revised on 10/14/2014, signed and sealed by Frank L. Bennardo, P.E.
- **B.** TESTS (submitted under files # 13-0529.21/#12-0807.05)
 - 1. Test reports on: 1) Air Infiltration Test, per FBC, TAS 202-94
 - 2) Uniform Static Air Pressure Test, Loading per FBC TAS 202-94
 - 3) Water Resistance Test, per FBC, TAS 202-94 (Not conducted)
 - 4) Forced Entry Test, per FBC 2411 3.2.1, TAS 202-94

Along with installation diagram of aluminum automatic entrance doors Sx-So w/ G-86 CVR Panic and So-Sx-Sx-So w/ Transom & G-86 CVR Panic, prepared by Fenestration Testing Laboratory, Inc. Test Report No. FTL-7247, dated 03/08/13, signed and sealed by Marlin D. Brinson, P. E.

- 2. Test reports on: 1) Air Infiltration Test, per FBC, TAS 202-94
 - 2) Uniform Static Air Pressure Test, Loading per FBC TAS 202-94
 - 3) Water Resistance Test, per FBC, TAS 202-94 (Not conducted)
 - 4) Forced Entry Test, per FBC 2411 3.2.1, TAS 202-94

Along with installation diagram of aluminum automatic entrance doors, prepared by Fenestration Testing Laboratory, Inc. Test Report No. **FTL-6803**, dated 05/11/12 and last revised on 03/21/13, signed and sealed by Marlin D. Brinson, P. E.

Note: This test report has been revised by an addendum letter dated Nov 21, 2012 and April 03, 2013, issued by Fenestration Testing Lab, signed and sealed by Marlin D. Brinson, P. E. (submitted under file # 12-0807.05)

C. CALCULATIONS

- 1. Anchor verification calculations and structural analysis, complying with FBC-2014 (5th Edition), prepared by Engineering Express, dated 05-13-15, signed and sealed by Frank L. Bennardo, P.E.
- 2. Glazing complies w/ ASTME-1300-02, -04 & -09.

D. QUALITY ASSURANCE

1. Miami Dade Department of Regulatory and Economic Resources (RER).

E. MATERIAL CERTIFICATIONS (submitted under file # 12-0807.05)

1. Technical strength data of Trelleborg EPDM per ASTM C864.

F. STATEMENTS

- 1. Statement letter of conformance to FBC 2014(5th Edition), prepared by Engineering Express, dated May 13, 2015, signed and sealed by Frank L. Bennardo, P.E.
- 2. Statement letter of no financial interest, prepared by Engineering Express, dated 08-02-12, signed and sealed by Frank L. Bennardo, P.E. (submitted under file # 12-0807.05)
- 3. Lab compliance as part of the above referenced test report.

Ishaq 1. Chands

NOTICE OF ACCEPTANCE: EVIDENCE SUBMITTED

G. OTHER

- 1. This NOA revises NOA #13-0529.21, expiring 04/18/18.
- 2. Test proposals # 13-0006 dated 01/14/13 approved by RER and # 11-1016, dated NOV 11, 2011 approved by PERA.
- 3. Manufacture supplied Adam Rites deadbolt/hook & bolts mechanism & G-86 panic brochures.

2. EVIDENCE SUBMITTED UNDER PREVIOUS APPROVAL # 17-0828.09

A. DRAWINGS

1. Drawing No. **14-1854**, titled "Dura-Storm 2000/3000 Auto SGD Bi-Parting /Single Slide-NI", sheets 1 through 19 of 19, prepared by Engineering Express, dated 07/01/12 and last revised on 08/23/17, signed and sealed by Frank L. Bennardo, P.E.

B. TESTS

1. None.

C. CALCULATIONS

1. Anchor verification calculations and structural analysis, complying with **FBC** 6th **Edition (2017)**, prepared by manufacturer, dated 08/01/17, signed and sealed by Frank L. Bennardo, P.E.

D. QUALITY ASSURANCE

1. Miami Dade Department of Regulatory and Economic Resources (RER).

E. MATERIAL CERTIFICATIONS

1. None.

F. STATEMENTS

- 1. Statement letter of conformance to **FBC 6th Edition (2017)**, dated 07/31/17, prepared by Engineering Express, signed and sealed by Frank L. Bennardo, P.E.
- 2. Statement letter of no financial interest, prepared by Engineering Express, dated 07/28/17, signed and sealed by Frank L. Bennardo, P.E.

G. OTHER

1. This NOA revises NOA #15-0127.05, expiring on 04/11/2018.

Ishaq I. Chands

Ishaq I. Chanda, P.E. Product Control Unit Supervisor NOA No. 22-1207.02 Expiration Date: April 11, 2028

NOTICE OF ACCEPTANCE: EVIDENCE SUBMITTED

- 3. EVIDENCE SUBMITTED submitted under previous NOA(s)
- A. DRAWINGS
 - 1. None.
- B. TESTS
 - 1. None.
- C. CALCULATIONS
 - 1. None.
- D. QUALITY ASSURANCE
 - 1. Miami Dade Department of Regulatory and Economic Resources (RER).
- E. MATERIAL CERTIFICATIONS
 - 1. None.
- F. STATEMENTS
 - 1. None.
- G. OTHER
 - 1. This NOA **renews** NOA #**17-0828.09**, expiring on 04/11/2018.
- 4. EVIDENCE SUBMITTED submitted under previous NOA(s)
- A. DRAWINGS
 - 1. None.
- B. TESTS
 - 1. None.
- C. CALCULATIONS
 - 1. None.
- D. QUALITY ASSURANCE
 - 1. Miami Dade Department of Regulatory and Economic Resources (RER).
- E. MATERIAL CERTIFICATIONS
 - 1. None.
- F. STATEMENTS
 - 1. None.
- G. OTHER
 - 1. This NOA renews NOA #18-0221.09, expiring on 04/11/2023.

Ishaq 1. Chands

Ishaq I. Chanda, P.E. Product Control Unit Supervisor NOA No. 22-1207.02 Expiration Date: April 11, 2028

Allegion Access Technologies, LLC

NOTICE OF ACCEPTANCE: EVIDENCE SUBMITTED

5. **EVIDENCE SUBMITTED under previous approval**

DRAWINGS A.

1. Drawing No. 20-33204 (former 14-1854), titled "Dura-Storm 2000/3000 Auto SGD Bi-Parting /Single Slide-NI", sheets 1 through 19 of 19, prepared by Engineering Express, dated 08/23/17 and last revised on NOV 10, 2022, signed and sealed by Frank L. Bennardo, P.E.

В. **TESTS**

1. None.

C. **CALCULATIONS**

1. None.

D. **OUALITY ASSURANCE**

Miami Dade Department of Regulatory and Economic Resources (RER).

E. **MATERIAL CERTIFICATIONS**

1. Technical strength data of Trelleborg EPDM per ASTM C864.

F. **STATEMENTS**

- 1. Statement letter of conformance to FBC 2020 (7th Edition), prepared by Engineering Express, dated 11/10/2022, signed and sealed by Frank L. Bennardo, P.E.
- 2. Statement letter dated 11/10/22 requesting Renewal with no change and no changes have been made from previous approval, prepared by Engineering Express, dated 11/10/22, signed and sealed by Frank L. Bennardo, P.E.

G. **OTHER**

1. This NOA renews NOA #20-1216.25, expiring 04/11/28.

Allegion Access Technologies, LLC

NOTICE OF ACCEPTANCE: EVIDENCE SUBMITTED

6. New EVIDENCE SUBMITTED

A. DRAWINGS

1. Drawing No. **20-33204** (former **14-1854**), titled "Dura-Storm 2000/3000 Auto SGD Bi-Parting /Single Slide-NI", sheets 1 through 19 of 19, prepared by Engineering Express, dated 08/23/17 and last revised on FEB 10, 2023, signed and sealed by Frank L. Bennardo, P.E.

B. TESTS

1. None.

C. CALCULATIONS

1. None.

D. QUALITY ASSURANCE

1. Miami Dade Department of Regulatory and Economic Resources (RER).

E. MATERIAL CERTIFICATIONS

1. Technical strength data of Trelleborg EPDM per ASTM C864.


F. STATEMENTS

- 1. Statement letter of conformance to FBC 2020 (7th Edition), prepared by Engineering Express, dated FEB 10, 2023, signed and sealed by Frank L. Bennardo, P.E.
- Certificate of Amendment issued by State of Delaware dated September 01, 2022,
 Stanley Access Technologies, LLC, changed its name to Allegion Access Technologies,
 LLC signed by Jeffery W. Bullocks, Secretary of State, State of Delaware.
- 3. Certificate of Formation, issued by State of Delaware, dated September 01, 2022, amended **Stanley Access Technologies**, **LLC**, to **Allegion Access Technologies**, **LLC**, signed by Jeffrey W. Bullock, Secretary of State, State of Delaware

G. OTHER

1. This NOA revises # 22-0830.08 (former Stanley Access Technologies, LLC), expiring 04/11/28.

Ishaq I. Chands

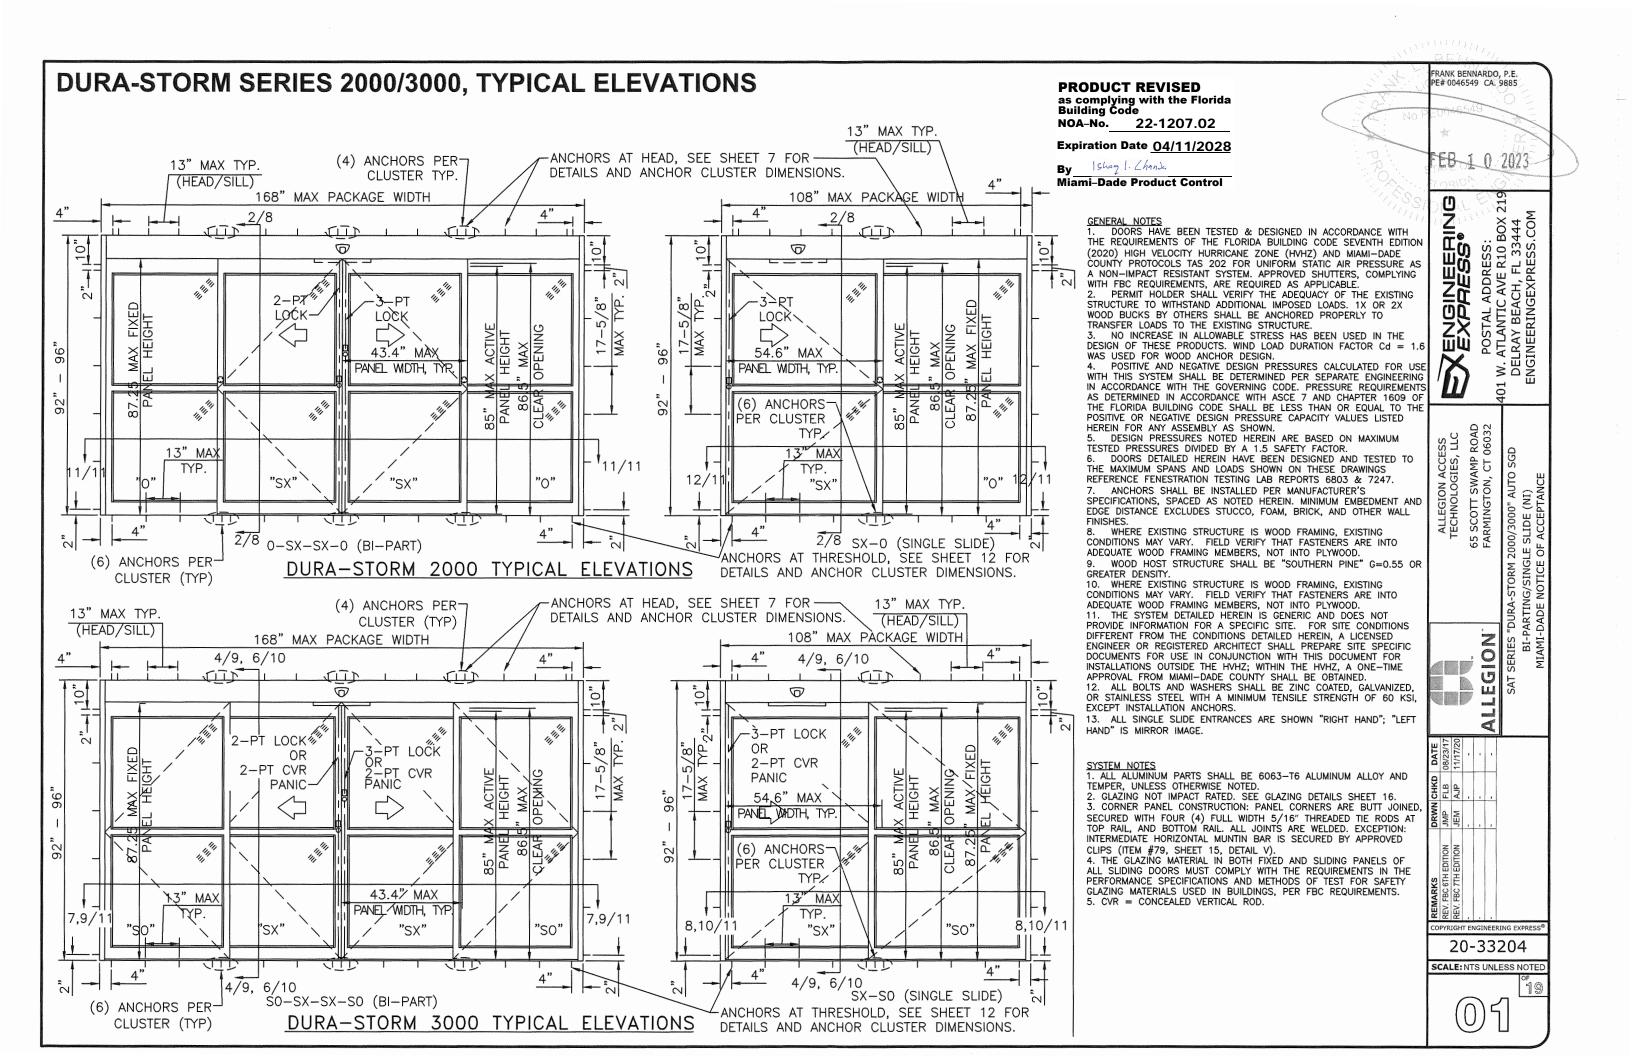

DURA-STORM SERIES 2000 W/ OPTIONAL TRANSOM, TYPICAL ELEVATIONS

PRODUCT REVISED as complying with the Florida Building Code NOA-No. 22-1207.02

Expiration Date <u>04/11/2028</u>

Ishag 1. Chands Miami-Dade Product Control

ANCHORS AT HEAD, SEE SHEET 7 FOR DETAILS AND ANCHOR (4) ANCHORS PER CLUSTER TYP. ANCHORS AT HEAD, (4) ANCHORS PER-CLUSTER DIMENSIONS. 13" MAX TYP. 13" MAX TYP. SEE SHEET 7 FOR CLUSTER TYP. ANCHORS AT (HEAD/SILL) (HEAD/SILL) DETAILS AND ANCHOR 108" MAX PACKAGE WIDTH 168" MAX\PACKAGE/WIDTH JAMBS, SEE 4"CLUSTER DIMENSIONS. 1A/8 SHEET 8 FOR DETAILS AND **ANCHOR** 12 **CLUSTER** DIMENSIONS. TRANSOM 51 1/2" MAX 13/187 39 7/8" MAX TRANSOM -REINF. 73 27 DLO TYP. -REINF. 101 3/18 DLO TYP. 14/18 14/18 10" _Q_ \geq \geq 2,1 HEIGHT 2," HEIGHT 5/8" MAX FIXED EL HEIGHT LOCK. 5 " MAX OPENING X ACTIVE HEIGHT 17-{ MAX 17 PACKAGE 7" MAX DLO 54.6" MAX 96 PANEL WIDTH, TYP 86. CLEAR CLEAR CLEAR 85" N 48.3" MAX MAX37" MAX 92, DLO DLO 3/4" 43.4" MAX MAX 13" MA PANEL/MDTH, TYP. TYP. TYP. 12/11 11/11 123 "SX' "O" "SX" 'SX' 1/8 1A/8 ANCHORS AT THRESHOLD, -ANCHORS AT THRESHOLD, (6) ANCHORS PER (6) ANCHORS PER SEE SHEET 12 FOR SEE SHEET 12 FOR CLUSTER TYP. CLUSTER (TYP) DETAILS AND ANCHOR DETAILS AND ANCHOR CLUSTER DIMENSIONS. CLUSTER DIMENSIONS.

DURA-STORM 2000 TYPICAL ELEVATIONS

0-SX-SX-0 (BI-PART)

DURA-STORM 2000 TYPICAL ELEVATIONS

SX-0 (SINGLE SLIDE)

- MAX DLO AS SHOWN.
- BI-PARTING PANEL: 37" W X 77" H; TRANSOMS: 39 7/8" W X 26" H.
- SINGLE SLIDE PANEL: 48 1/4" W X 77" H; TRANSOMS: 51 1/2" W X 26" H.
- 5-POINT LOCKING STANDARD (3-PT ACTIVE & 2-PT). SEE SHEET 17.
 PRODUCT SHALL BE MANUFACTURED AND INSTALLED IN ACCORDANCE WITH PRODUCT APPROVALS.
- SEE SHEETS 7, 8, 11 AND 12 FOR REQUIRED ANCHORAGE.
- SEE SHEET 16 FOR GLAZING DETAILS.

FRANK BENNARDO, P.E. PE# 0046549 CA. 9885 FEB 1 1 2023 219

EXPRESS. POSTAL ADDRESS: 2401 W. ATLANTIC AVE R10 BOX 2DELRAY BEACH, FL 33444 ENGINEERINGEXPRESS.COM

65 SCOTT SWAMP ROAD FARMINGTON, CT 06032

ALLEGION

4 2000/3000" AUTO SGD GLE SLIDE (NI) E OF ACCEPTANCE

OPYRIGHT ENGINEERING EXPRESS

20-33204

SCALE: NTS UNLESS NOTED



FRANK BENNARDO, P.E. PE# 0046549 CA. 9885 **DURA-STORM SERIES 3000 W/ OPTIONAL TRANSOM, TYPICAL ELEVATIONS PRODUCT REVISED** as complying with the Florida Building Code 22-1207.02 NOA-No. Expiration Date 04/11/2028 Ishag 1. Chands 0.2023 Miami-Dade Product Control 219 EXPRESS. POSTAL ADDRESS: 101 W. ATLANTIC AVE R10 BOX 2 DELRAY BEACH, FL 33444 ENGINEERINGEXPRESS.COM ANCHORS AT HEAD, -(4) ANCHORS PER SEE SHEET 7 FOR (4) ANCHORS PER-13" MAX TYP. CLUSTER TYP. 13" MAX TYP. DETAILS AND ANCHOR CLUSTER TYP. (HEAD/SILL) ANCHORS AT HEAD, ANCHORS AT (HEAD/SILL) CLUSTER DIMENSIONS. 108" MAX\PACKAGE WIDTH 168" MAX\PACKAGE WYDTH SEE SHEET 7 FOR JAMBS, SEE DETAILS AND ANCHOR SHEET 9 FOR 3/9 3A/94"CLUSTER DIMENSIONS. DETAILS AND 5/10 5A/10 ANCHOR CLUSTER DIMENSIONS. 7, 12, TRANSOM W/TRANSOM 51 1/2" MAX 13/18 70 39 7/8" MAX -REINF. 73 27 3/18 DLO TYP. -REINF. 101 DLO TYP. 14/18 14/18 ALLEGION ACCESS TECHNOLOGIES, LLC 65 SCOTT SWAMP ROAD FARMINGTON, CT 06032 \overline{Q} 2, ⋛ SAT SERIES "DURA-STORM 2000/3000" AUTO SGD BI-PARTING/SINGLE SLIDE (NI) MIAMI-DADE NOTICE OF ACCEPTANCE 3-PT LOCK 2,1 HEIGHT OR 2-PT LOCK HEIGHT ထို့ 2-PT CVR OR **PANIC** 5 2-PT CVR " MAX OPENING PACKAGE 17 PACKAGE PANIC: 54.6" " MAX DLO MAX "MAX DLO 96 PANEL WIDTH, TYP 86. CLEAR 85" M PANE PANEL 86. 48.3" MAX MAX37" MAX DLO DLO 3/4" 43.4" MAX 13" MAX ALLEGION PANEL/MDTH, TYP TYP. 8,10/11 8,10/11 7,9/11 **'**SO 23 "SX "SO "SX" SX" 3/9 3A/9 5/10 5A/10 ANCHORS AT THRESHOLD, (6) ANCHORS PER (6) ANCHORS PER--ANCHORS AT THRESHOLD, SEE SHEET 12 FOR CLUSTER TYP. CLUSTER (TYP) DETAILS AND ANCHOR SEE SHEET 12 FOR DETAILS AND ANCHOR CLUSTER DIMENSIONS. CLUSTER DIMENSIONS. **DURA-STORM 3000 TYPICAL ELEVATIONS** DURA-STORM 3000 TYPICAL ELEVATIONS SX-SO (SINGLE SLIDE) SO-SX-SX-SO (BI-PART)

MAX DLO AS SHOWN.

BI-PARTING PANEL: 37" W X 77" H, 36 3/4" H WITH PANIC MUNTIN; TRANSOMS: 39 7/8" W X 26" H. SINGLE SLIDE PANEL: 48 1/4" W X 77" H, 36 3/4" H WITH PANIC MUNTIN; TRANSOMS: 51 1/2" W X 26" H.

4-POINT CVR LOCKING WITH G86 PANIC RELEASE (2-PT CVR ACTIVE & 2-PT CVR) AND 5-POINT LOCKING (3-PT ACTIVE & 2-PT) AVAILABLE. SEE SHEET 17. PRODUCT SHALL BE MANUFACTURED AND INSTALLED IN ACCORDANCE WITH PRODUCT APPROVALS.

SEE SHEETS 7, 9, 10, 11 AND 12 FOR REQUIRED ANCHORAGE. SEE SHEET 16 FOR GLAZING DETAILS.

20-33204 SCALE: NTS UNLESS NOTED


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DURA-STORM SERIES 2000 ELEVATION AND PLAN

PRODUCT REVISED as complying with the Florida Building Code NOA-No. 22-1207.02

Expiration Date 04/11/2028

Ishag 1. Chands Miami-Dade Product Control

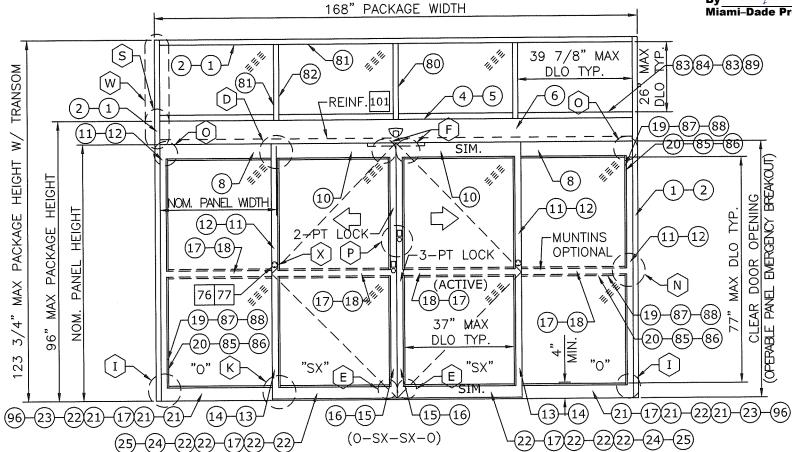

EXTERIOR ELEVATION (XX): EXTRUSION

INTERIOR

(XXXX): EXTRUSION, MULTI-PIECE

(XX)-(XX): EXTRUSION, OPTION XX : PART

XXXX : PART, MULTI-PIECE

XX XX : PART, OPTION (XX): DETAIL

(XX)-(XX): DETAIL, OPTION

EXTERIOR OPERABLE PANEL EMERGENCY BREAKOUT CLEAR DOOR OPENING

PLAN

168"

PACKAGE WIDTH

TYPICAL DOOR SHOWN. STILE, RAIL AND MUNTIN OPTIONS AVAILABLE AS INDICATED.

- HORIZONTAL MUNTIN BAR NOT REQUIRED AS INDICATED BY DASHED LINES. MAX DLO: 37" W X 77" H AS SHOWN
- 5-POINT LOCKING STANDARD (3-PT ACTIVE & 2-PT). SEE SHEET 17.
 PRODUCT SHALL BE MANUFACTURED AND INSTALLED IN ACCORDANCE WITH PRODUCT APPROVALS. SEE SHEETS 7, 8, 11, AND 12 FOR REQUIRED ANCHORAGE.
- SEE SHEET 16 FOR GLAZING DETAILS.

DESIGN RATINGS MISSILE IMPACT RATING NON-IMPACT RESISTANT DESIGN PRESSURE RATING (PSF[Pa]) WHERE WATER INFILTRATION RATING IS INFILTRATION RATING IS REQUIRED NOT REQUIRED POSITIVE NOT APPROVED 55 PSF NOT APPROVED 55 PSF NEGATIVE

	SERIES :	2000 AVAIL	ABLE PACK	AGE WIDTH	INFORMATION	*
PACKAGE WIDTH	ROUGH OPENING	STILE TYPE	NOMINAL CLEAR DOOR OPENING	NOMINAL PANEL WIDTH (SX)	NOMINAL PANEL WIDTH (0)	CAULKING ALLOWANCE
168.0"	168.5"	NARROW	70.6"	42.7"	42.7"	1/4" / SIDE
168.0"	168.5"	MEDIUM	66.3"	43.4"	43.4"	1/4" / SIDE

SERIES 2000 AVAILABLE PACKAGE HEIGHT INFORMATION*				
PACKAGE HEIGHT	ROUGH OPENING	NOMINAL CLEAR DOOR OPENING	CAULKING ALLOWANCE	
92.0"	92.3"	82.5"	1/4" TOP	
96.0"	96.3"	86.5"	1/4" TOP	

65 SCOTT SWAMP ROAD FARMINGTON, CT 06032 SAT SERIES "DURA-STORM 2000/3000" AUTO SGD BI-PARTING/SINGLE SLIDE (NI) MIAMI-DADE NOTICE OF ACCEPTANCE ALLEGION PYRIGHT ENGINEERING EXPRESS

FRANK BENNARDO, P.E. PE# 0046549 CA. 9885

EB-1-0-2023


KEXPRESS.

219

POSTAL ADDRESS: 101 W. ATLANTIC AVE R10 BOX 2 DELRAY BEACH, FL 33444 ENGINEERINGEXPRESS.COM

20-33204

SCALE: NTS UNLESS NOTED

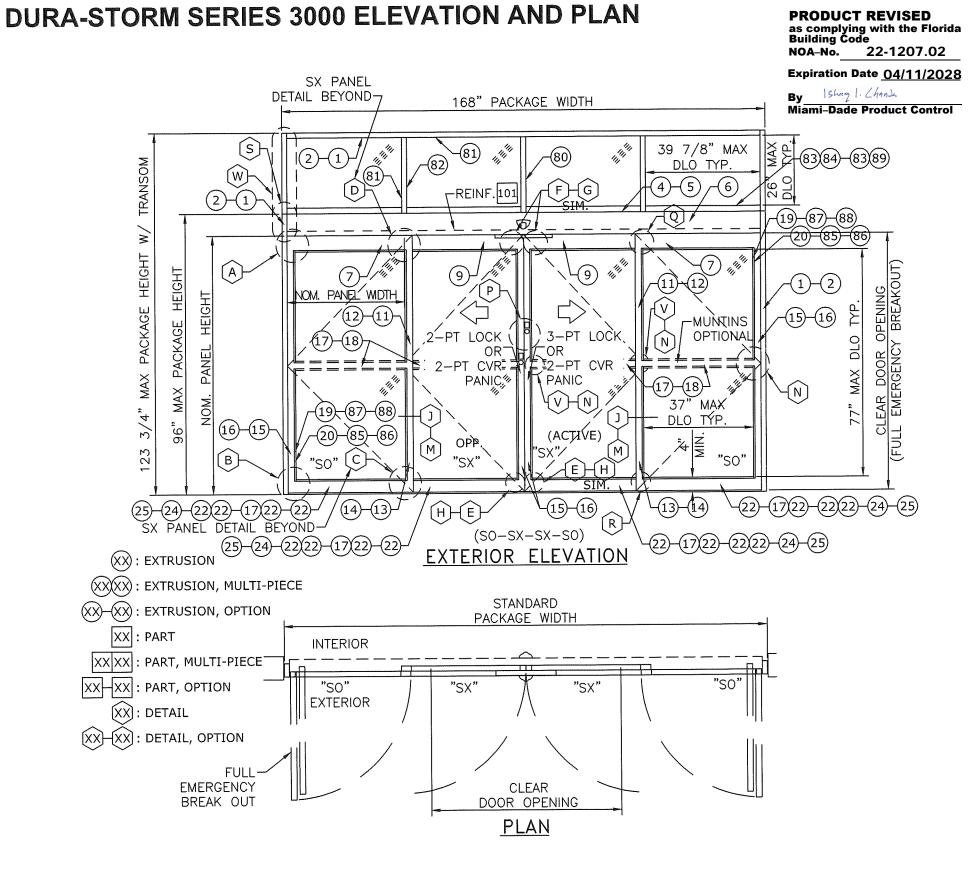

	DESIGN RATING	S
MISSILE IMPA		
	NON-IMPACT RESISTANT	
DESIGN PRES	SSURE RATING (PSF[Pa])	
	WHERE WATER	WHERE WATER
	INFILTRATION RATING IS	INFILTRATION RATING IS
	REQUIRED	NOT REQUIRED
POSITIVE	NOT APPROVED	55 PSF
NEGATIVE	NOT APPROVED	55 PSF

	SERIES 3	3000 AVAIL	ABLE PACK	AGE WIDTH	INFORMATION	*
PACKAGE WIDTH	ROUGH OPENING	STILE TYPE	NOMINAL CLEAR DOOR OPENING	NOMINAL PANEL WIDTH (SX)	NOMINAL PANEL WIDTH (O)	CAULKING ALLOWANCE
168.0"	168.5"	NARROW	70.6"	42.7"	42.7"	1/4" / SIDE
168.0"	168.5"	MEDIUM	66.3"	43.4"	43.4"	1/4" / SIDE

SERIE		'AILABLE PACKAGE FORMATION*	HEIGHT
PACKAGE HEIGHT	ROUGH OPENING	NOMINAL CLEAR DOOR OPENING	CAULKING ALLOWANCE
92.0"	92.3"	82.5"	1/4" TOP
96.0"	96.3"	86.5"	1/4" TOP

FRANK BENNARDO, P.E. PE# 0046549 CA. 9885

219 EXPRESS.

POSTAL ADDRESS: 401 W. ATLANTIC AVE R10 BOX 219 DELRAY BEACH, FL 33444 ENGINEERINGEXPRESS.COM

65 SCOTT SWAMP ROAD FARMINGTON, CT 06032 ALLEGION ACCESS TECHNOLOGIES, LLC

"DURA-STORM 2000/3000" AUTO SGD PARTING/SINGLE SLIDE (NI) -DADE NOTICE OF ACCEPTANCE

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20-33204

SCALE: NTS UNLESS NOTE


1. TYPICAL DOOR SHOWN. STILE, RAIL AND MUNTIN OPTIONS AVAILABLE AS INDICATED.

2. HORIZONTAL MUNTIN BAR NOT REQUIRED EXCEPT AT PANIC DEVICE, AS INDICATED BY DASHED LINES. MAX PANEL DLO: 37" W X 77 3/8" H, 36 3/4" H WITH PANIC MUNTIN AS SHOWN.

3. 4-POINT CVR LOCKING WITH G86 PANIC RELEASE (2-PT CVR ACTIVE & 2-PT CVR) AND 5-POINT LOCKING (3-PT ACTIVE & 2-PT) AVAILABLE. SEE SHEET 17.
4. PRODUCT SHALL BE MANUFACTURED AND INSTALLED IN ACCORDANCE WITH PRODUCT APPROVALS.

5. SEE SHEETS 7, 9, 10, 11, AND 12 FOR REQUIRED ANCHORAGE.

6. SEE SHEET 16 FOR GLAZING DETAILS.

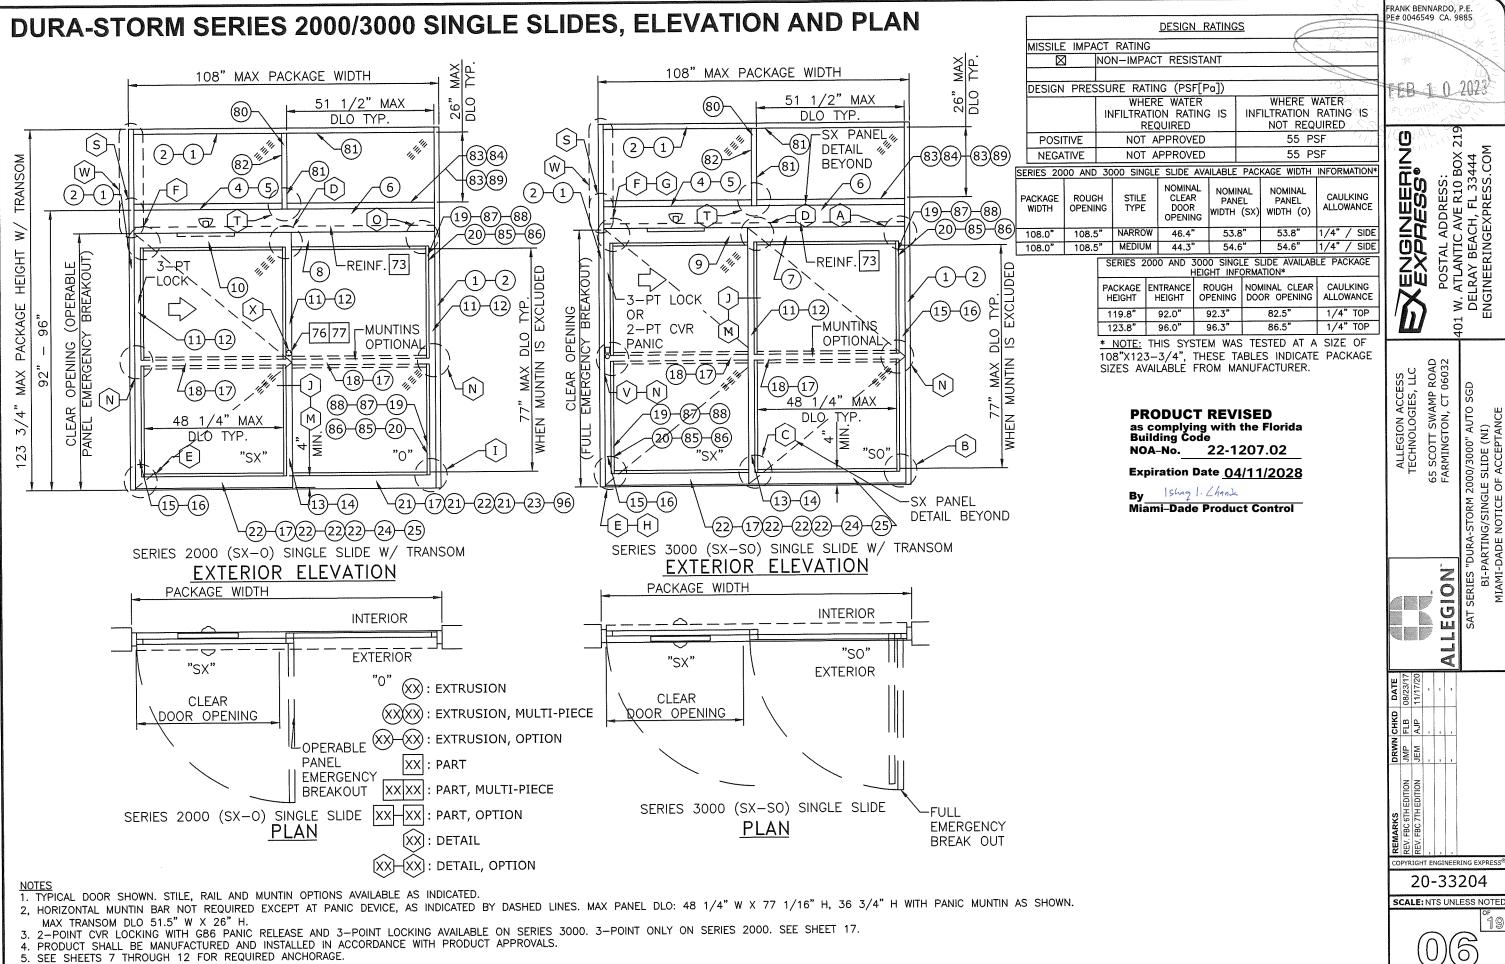



SEE SHEET 16 FOR GLAZING DETAILS.


EB-1 0-202


1 W. ATLANTIC AVE R10 BOX DELRAY BEACH, FL 33444 ENGINEERINGEXPRESS.CON


SCALE: NTS UNLESS NOTED

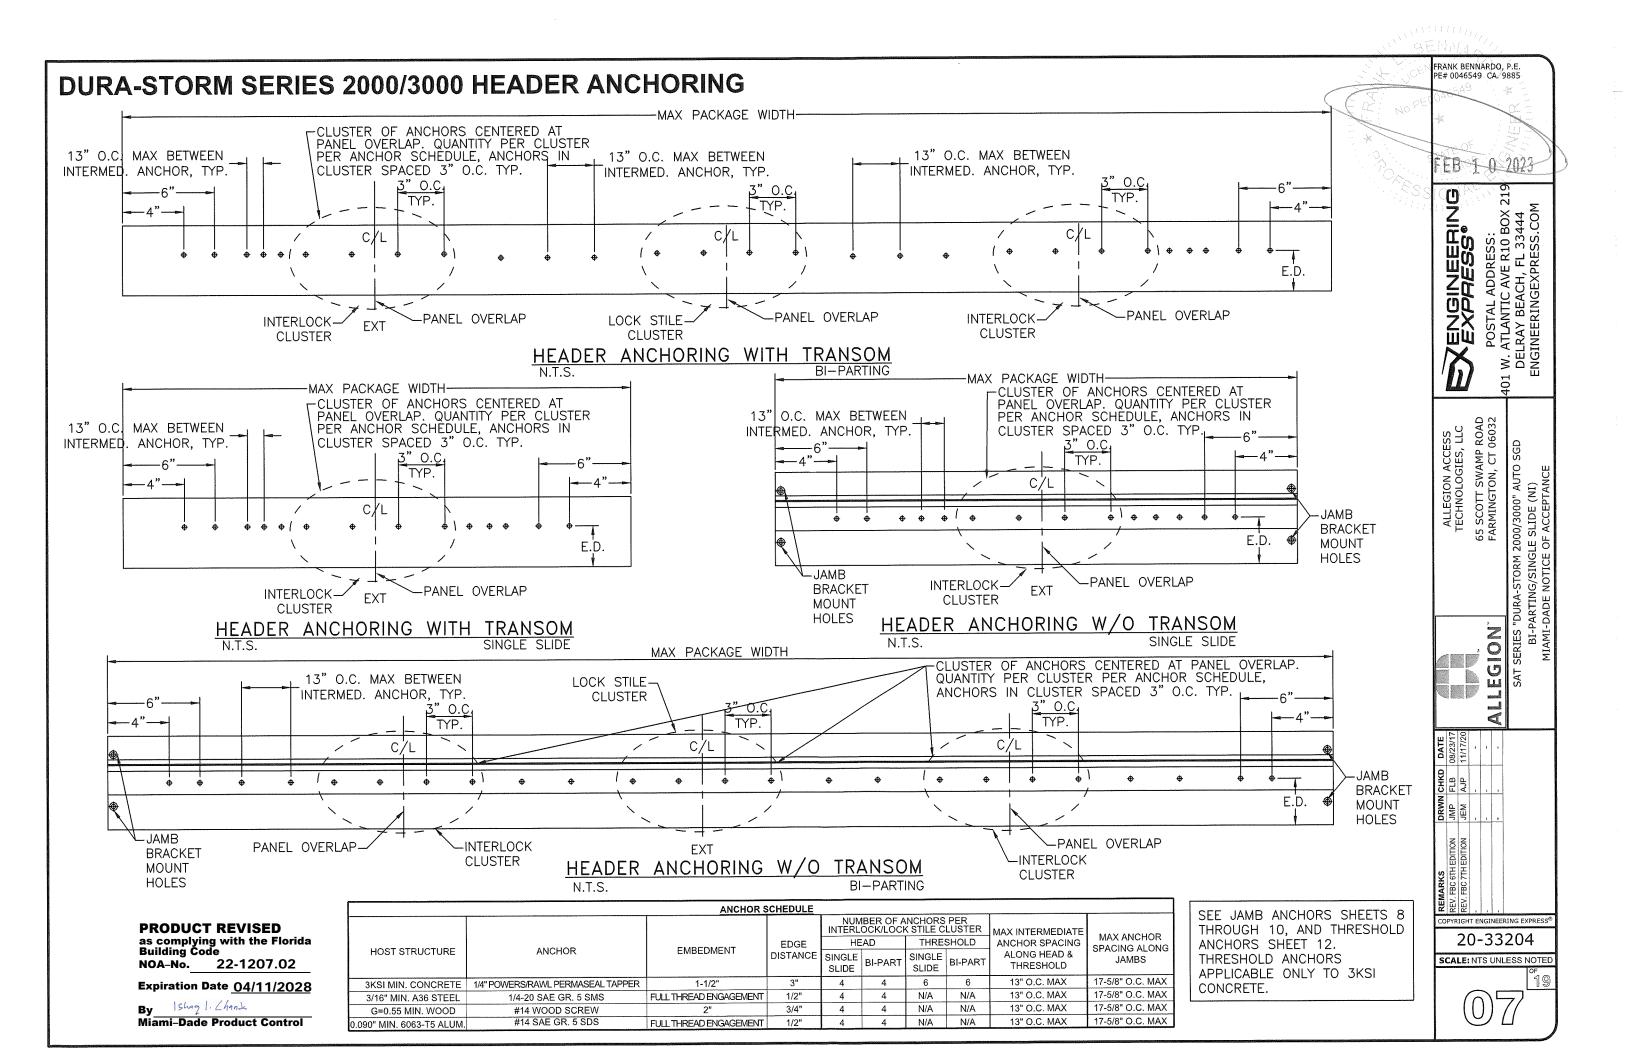


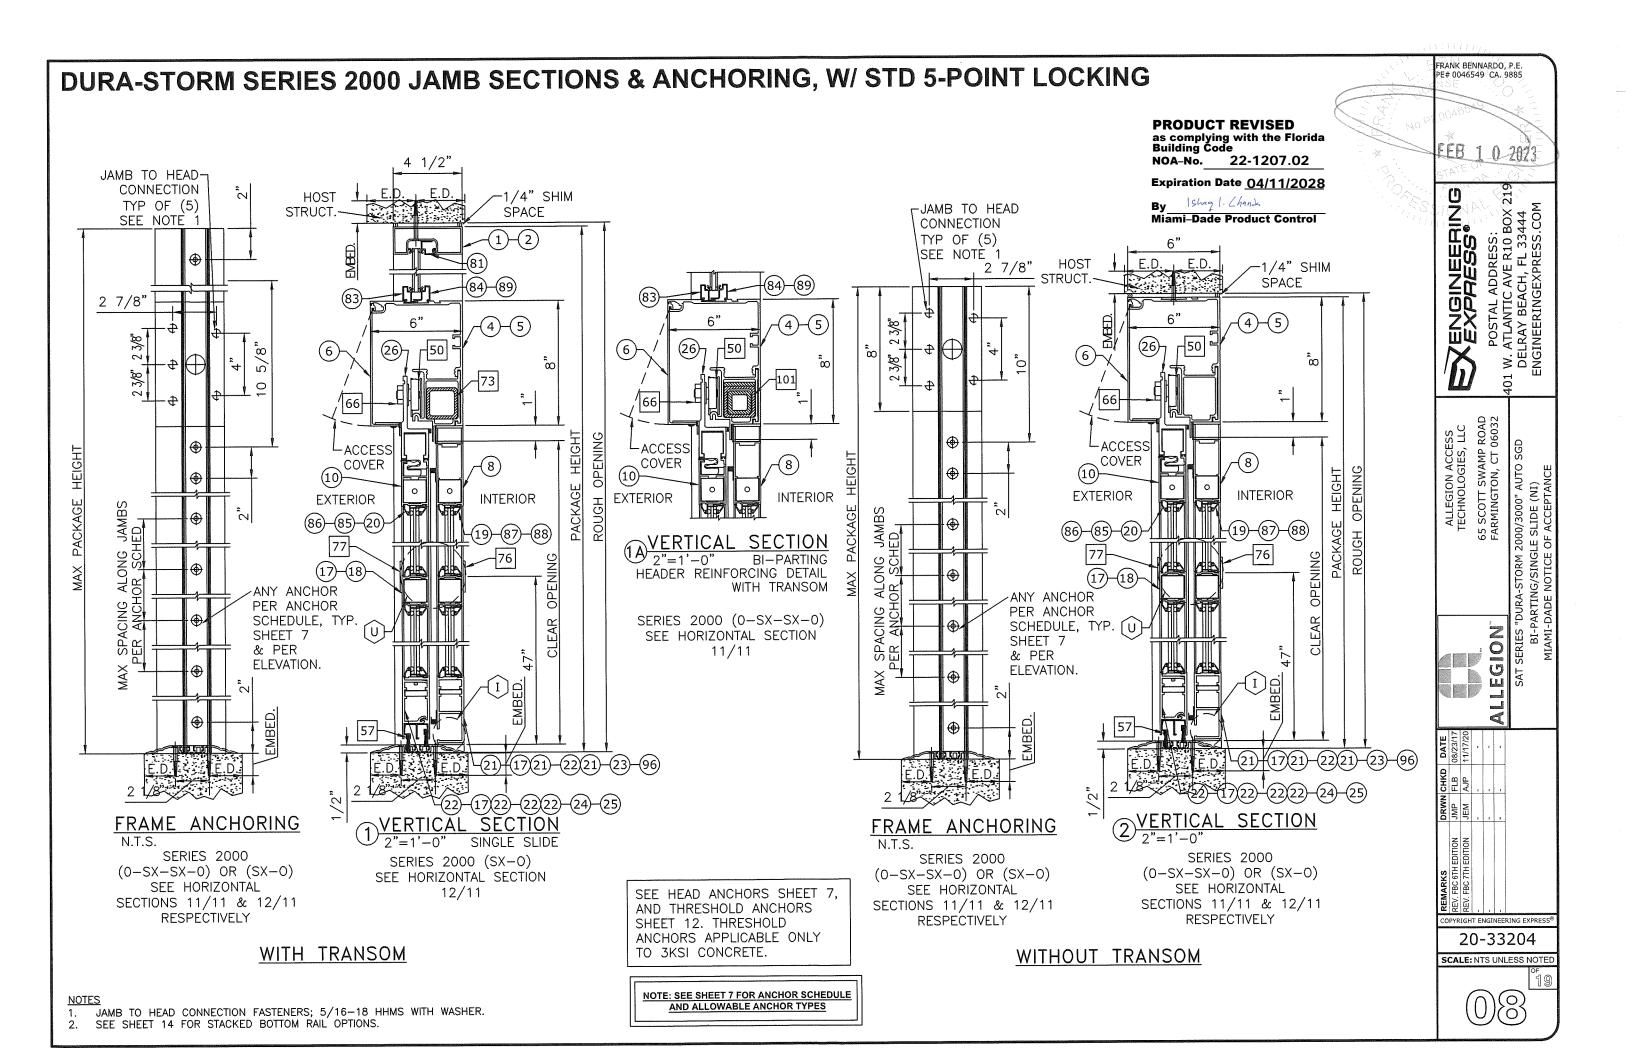


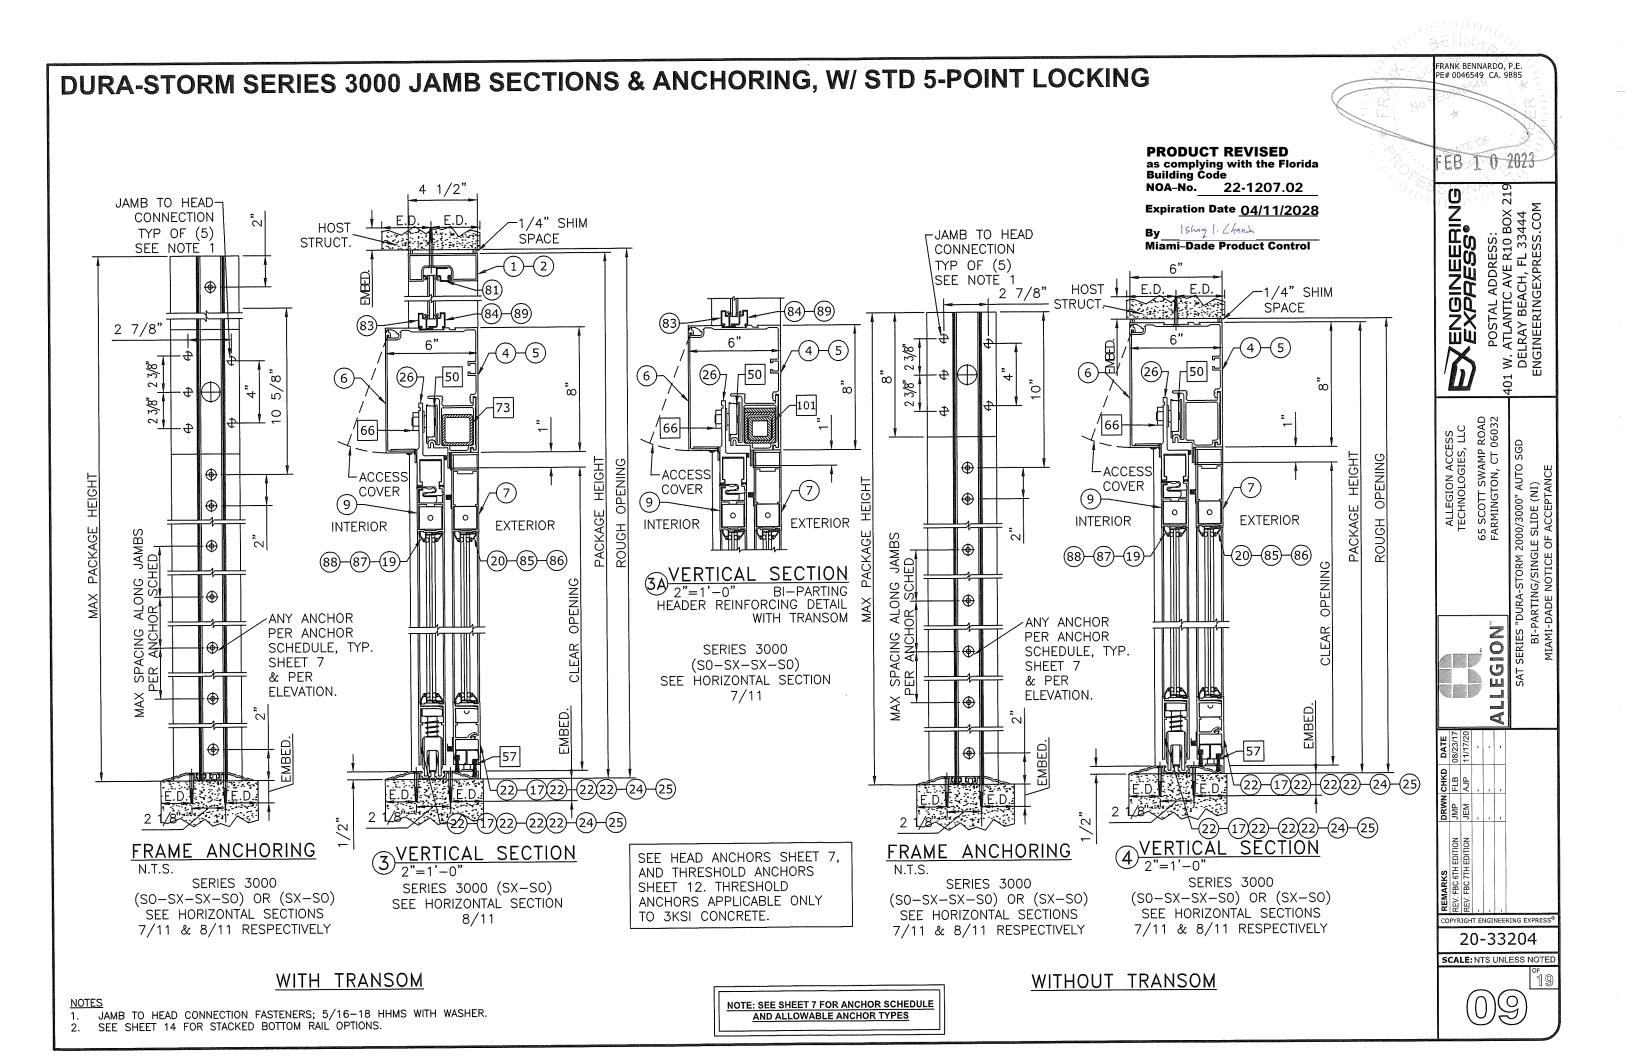


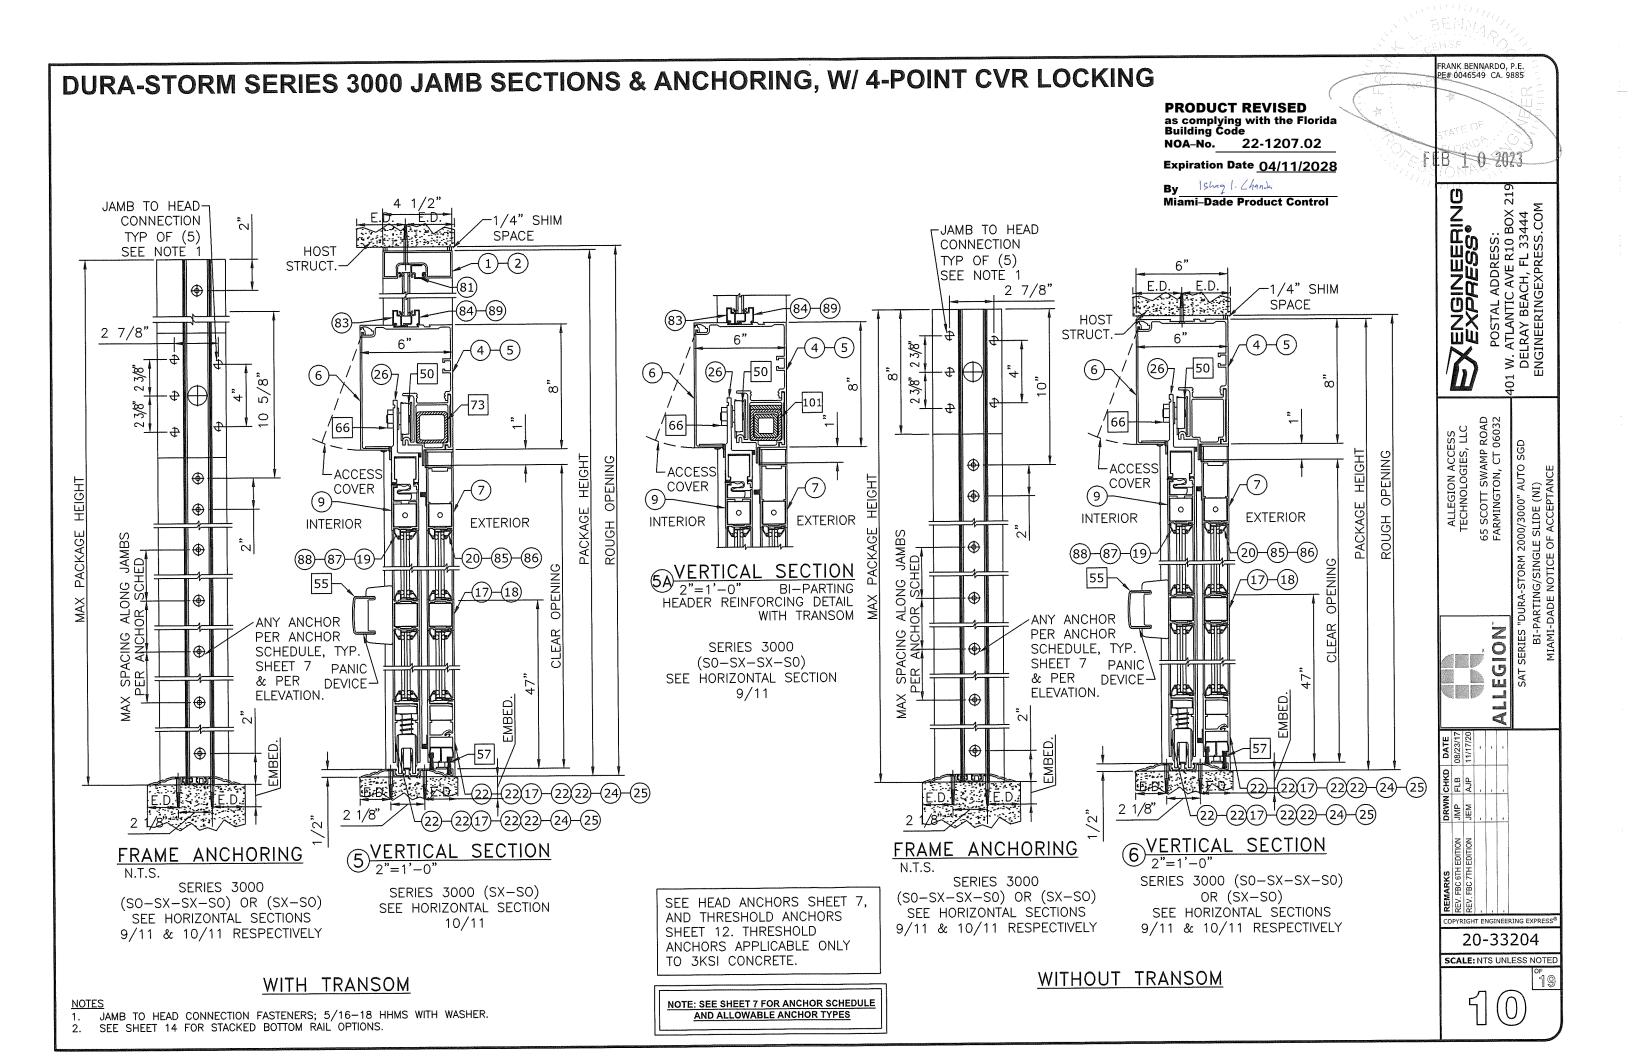


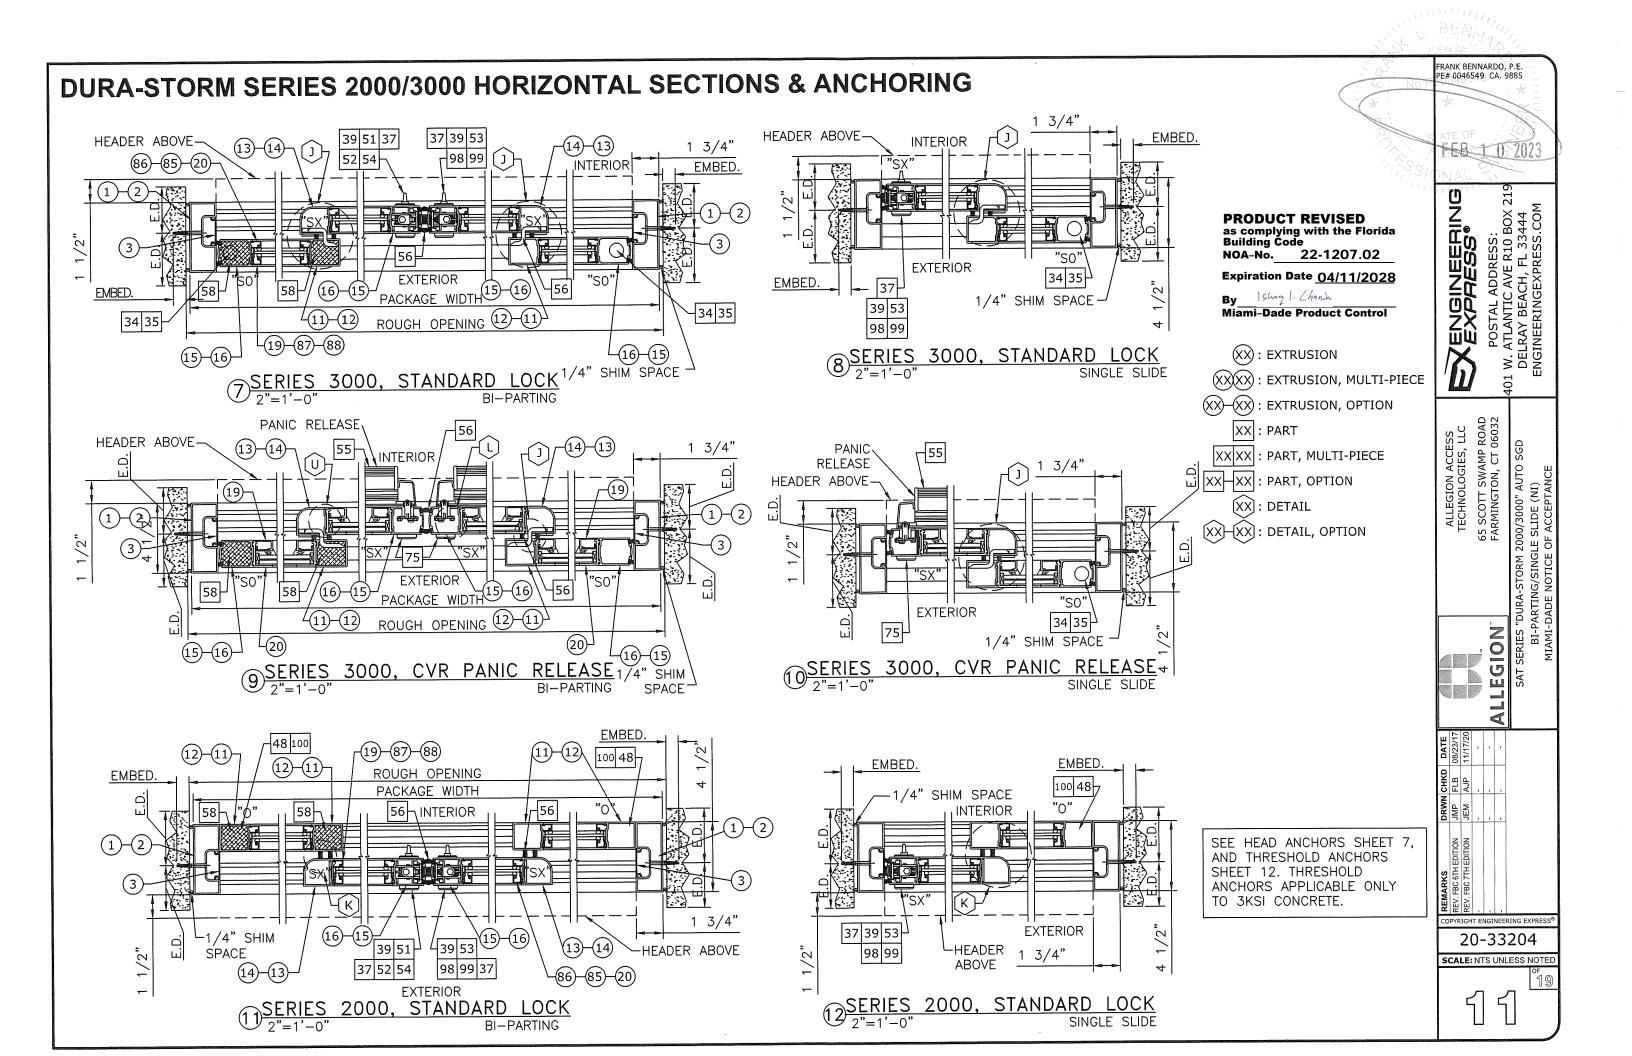


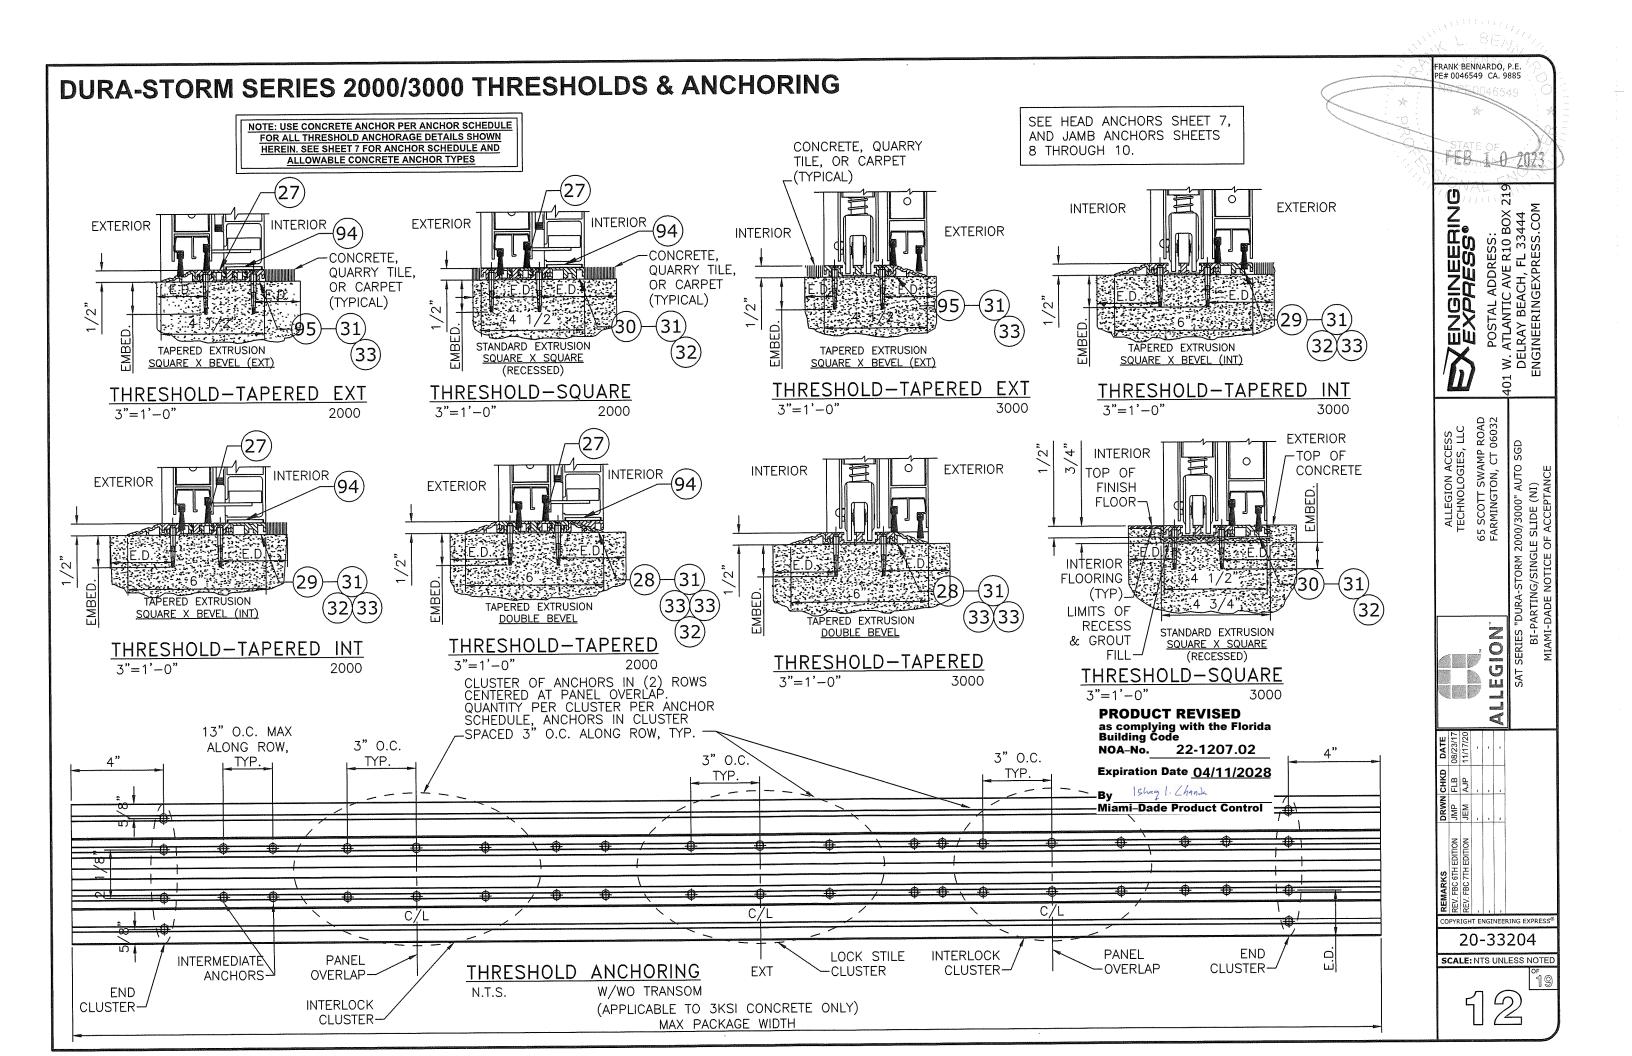


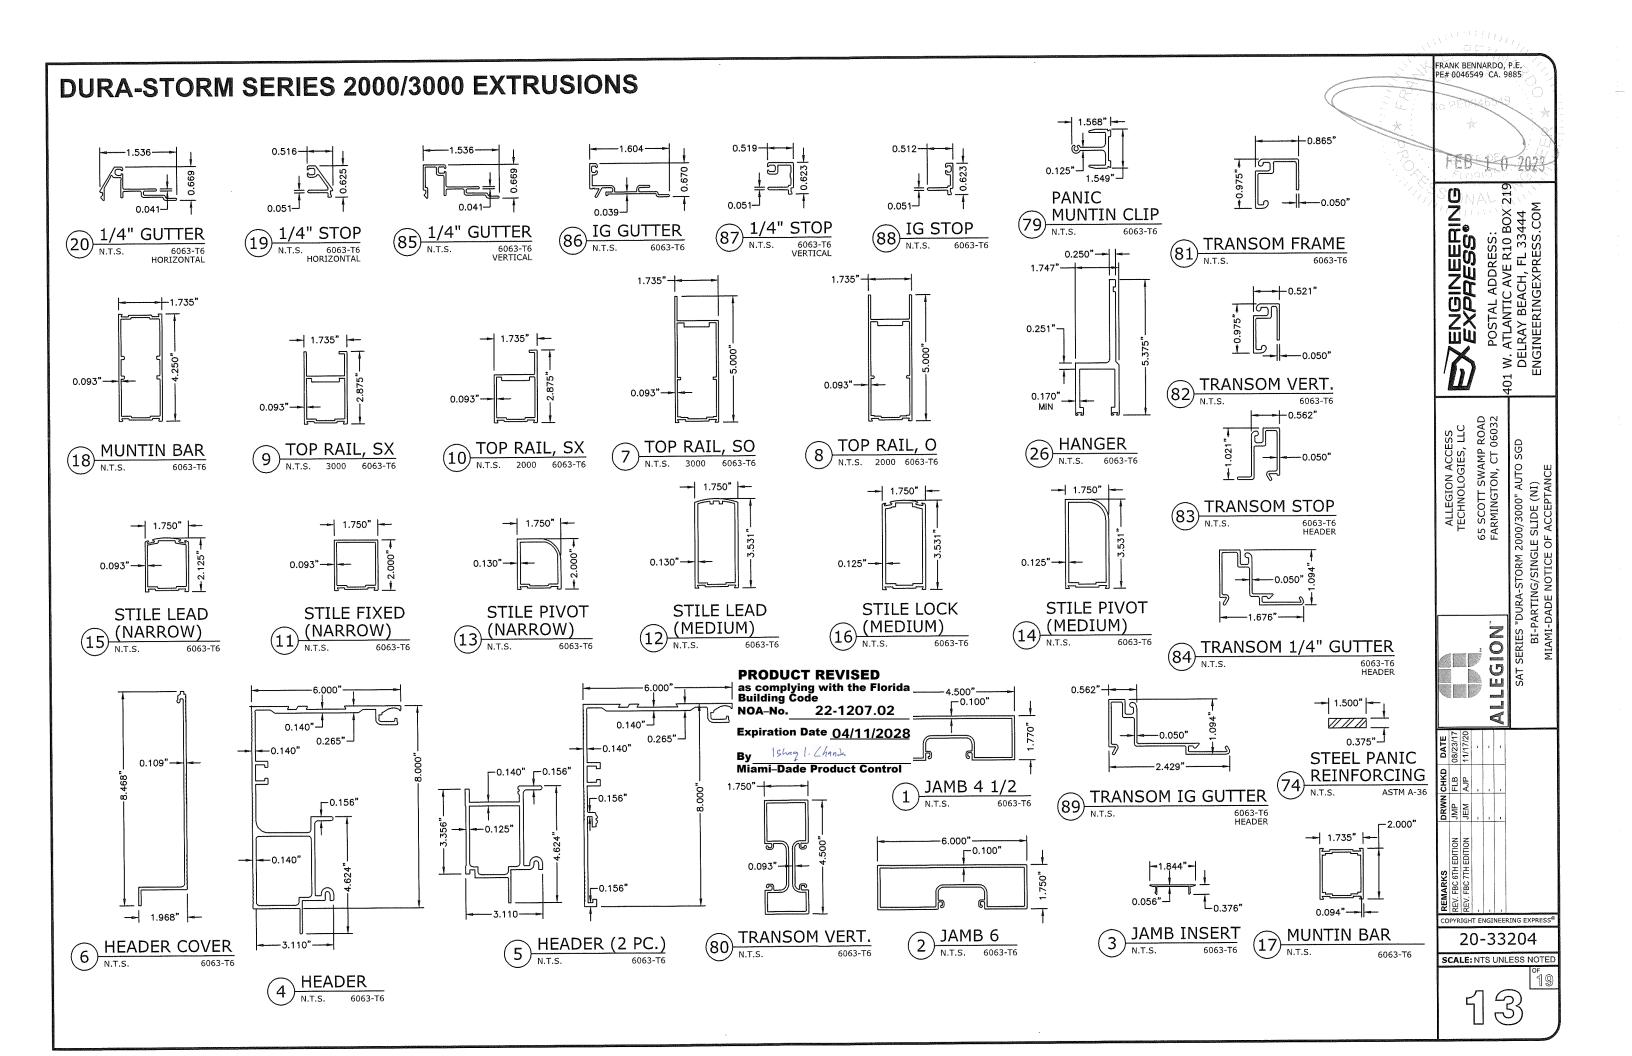

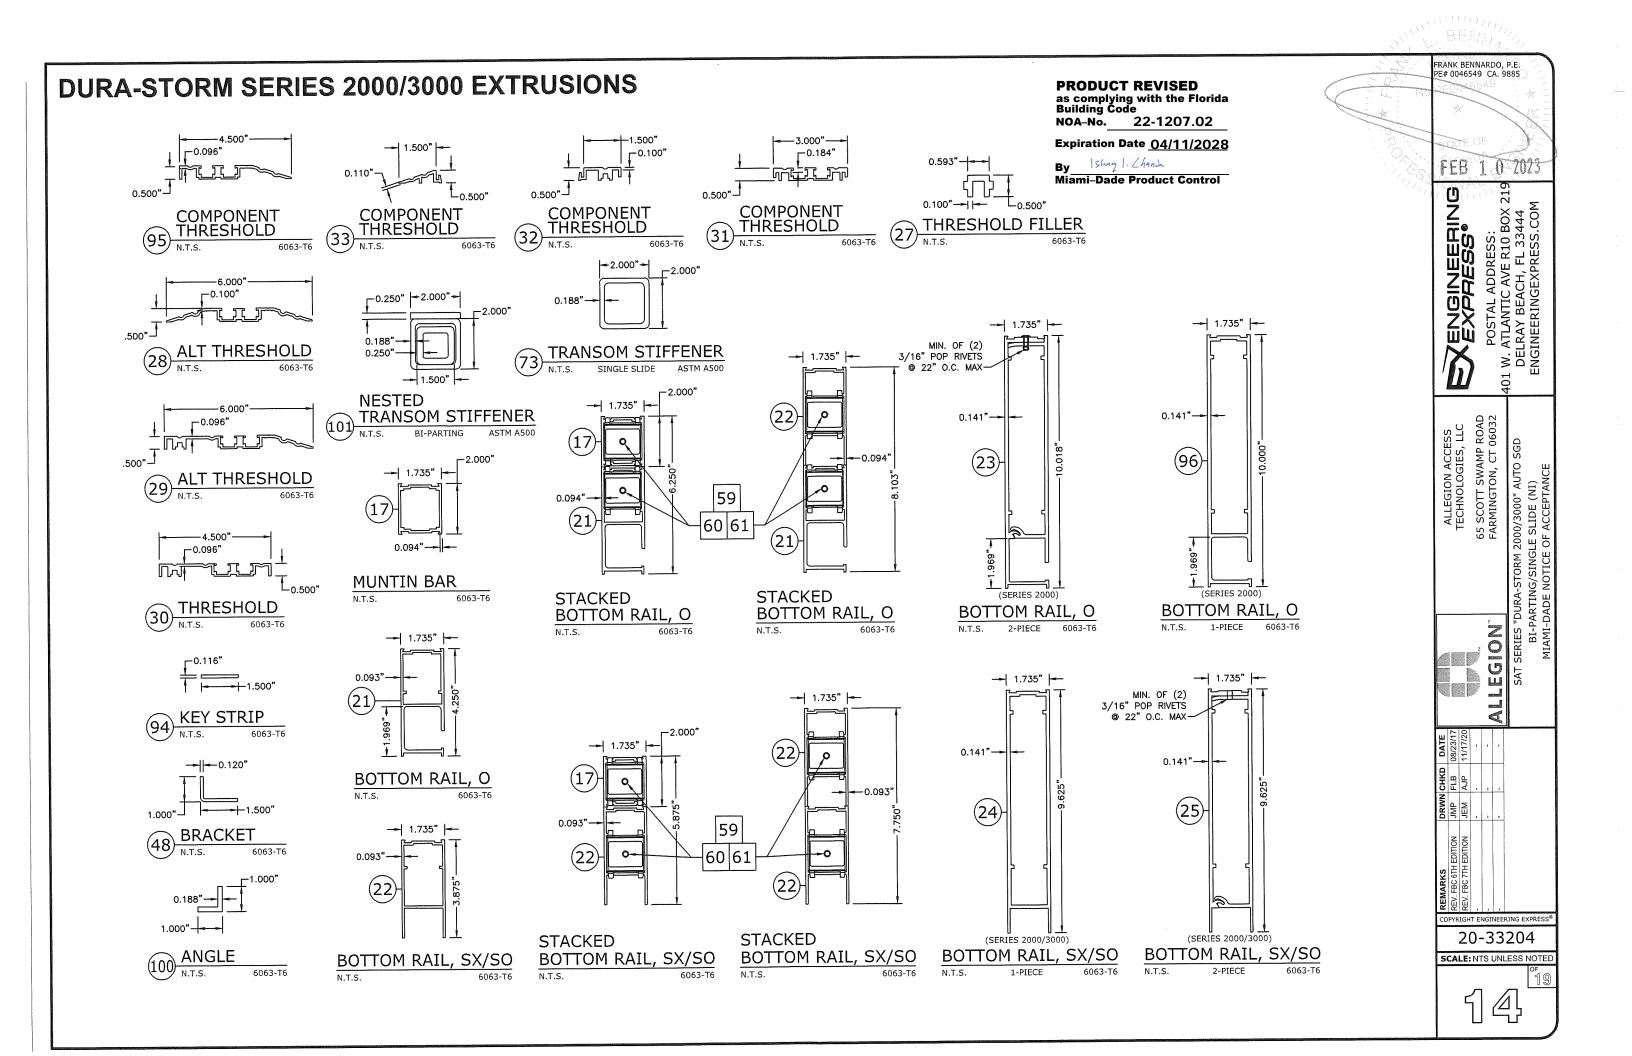


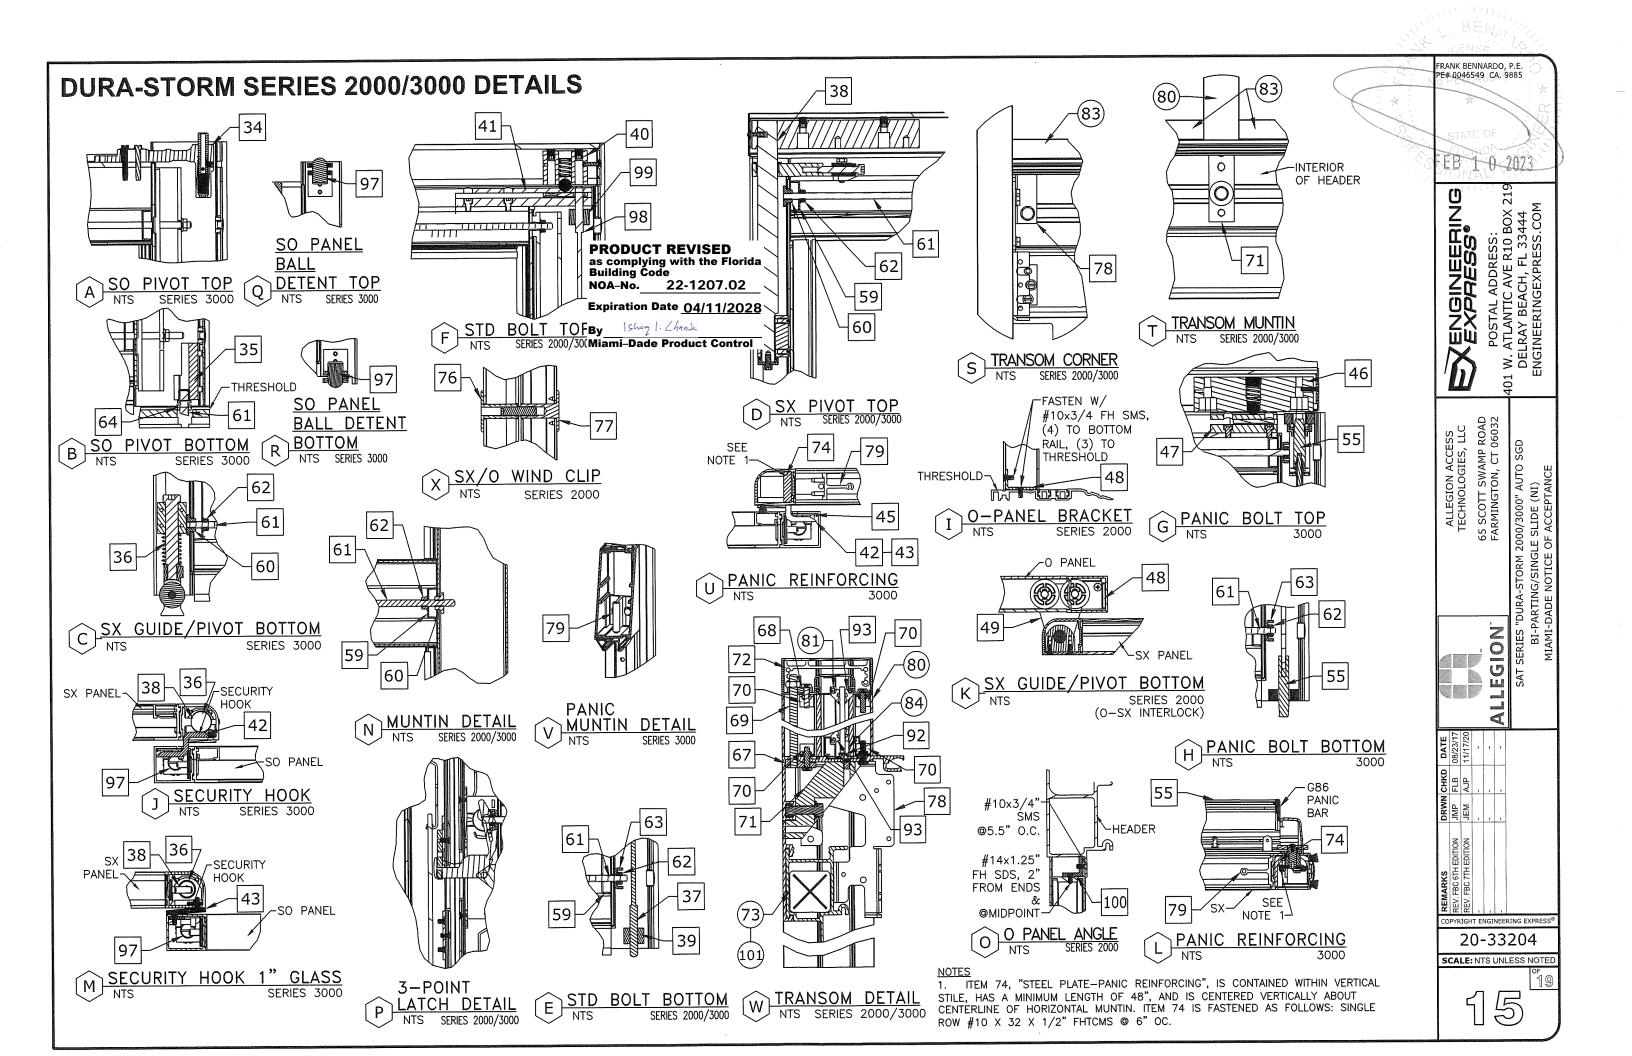

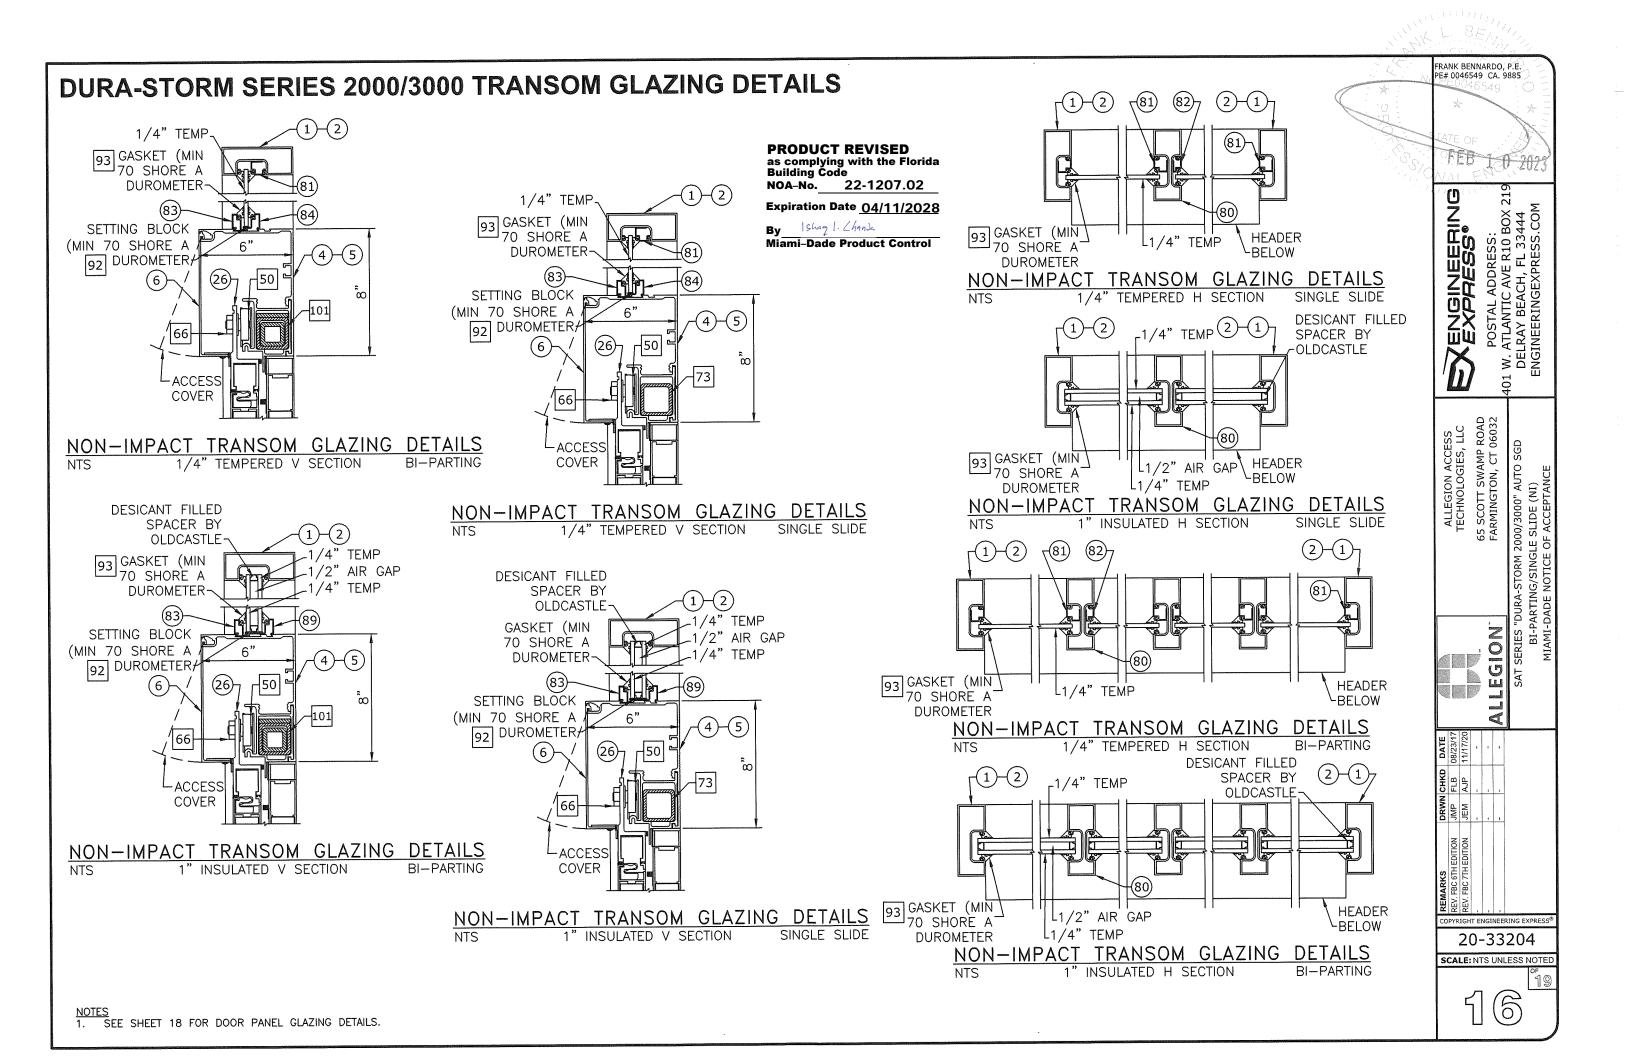

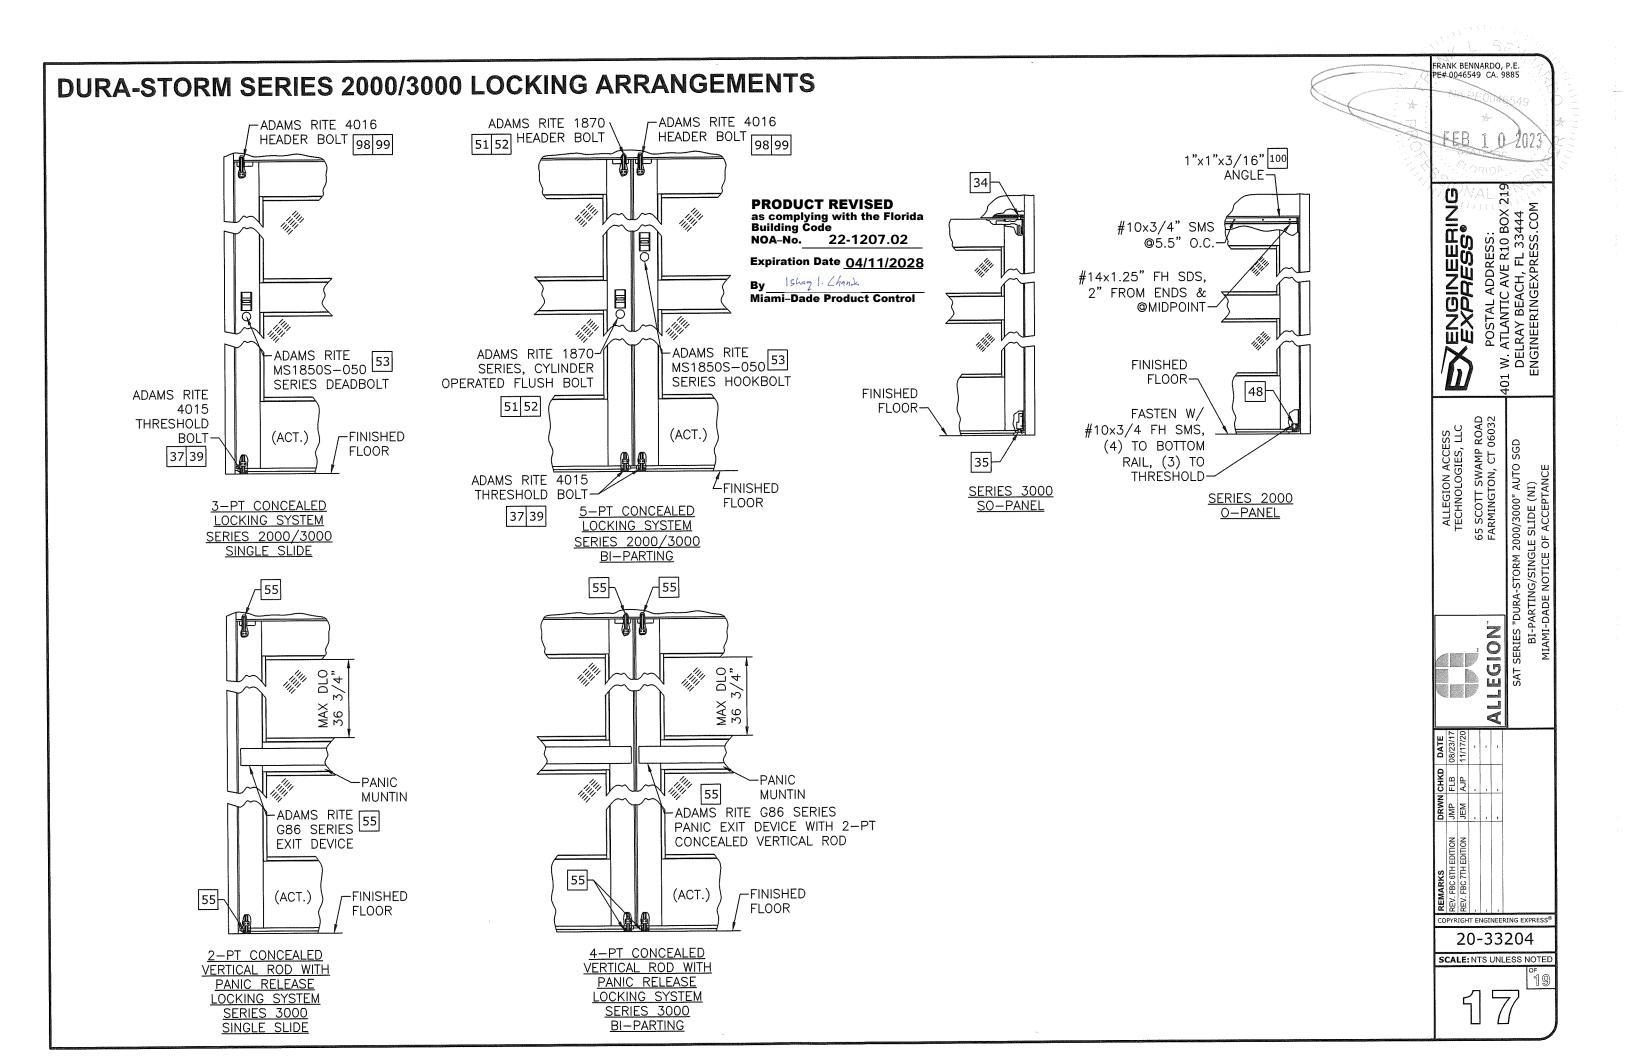

DURA-STORM SERIES 2000/3000 HORIZONTAL SECTION AND ANCHORING, TRANSOMS

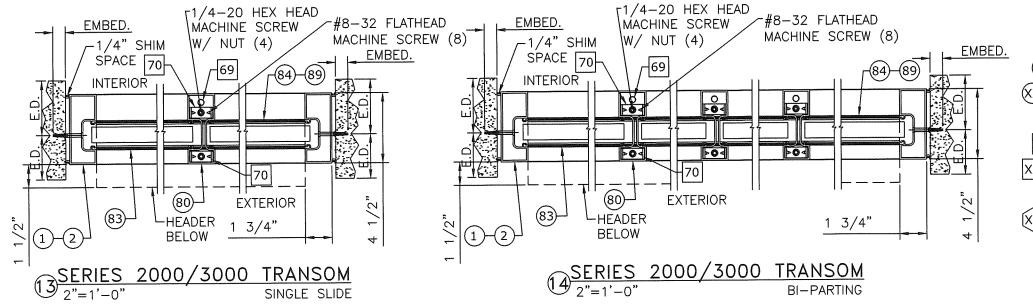

(XX): EXTRUSION

(XXXX): EXTRUSION, MULTI-PIECE

(XX)-(XX): EXTRUSION, OPTION

XX : PART

XX XX : PART, MULTI-PIECE

XX XX : PART, OPTION

(XX): DETAIL

[XX]—[XX] : DETAIL, OPTION

SEE HEAD ANCHORS SHEET 7, AND THRESHOLD ANCHORS SHEET 12. THRESHOLD ANCHORS APPLICABLE ONLY TO 3KSI CONCRETE.


PRODUCT REVISED as complying with the Florida Building Code NOA-No. 22-1207.02

Expiration Date 04/11/2028

Ishag 1. Chands

Miami-Dade Product Control

DURA-STORM SERIES 2000/3000 DOOR PANEL GLAZING DETAILS

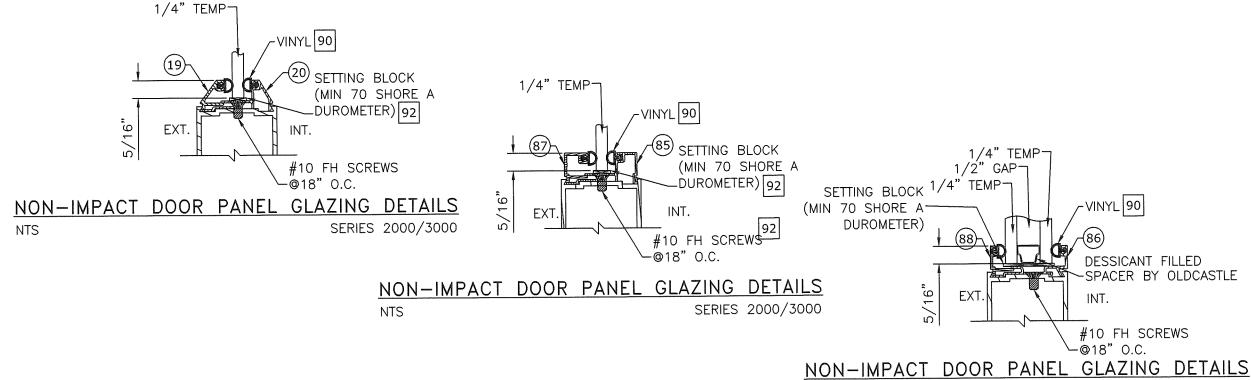

FRANK BENNARDO, P.E. PE# 0046549 CA. 9885 ENGINEERING EXPRESS® 216 2000/3000" AUTO SGD LE SLIDE (NI)

65 SCOTT SWAMP ROAD FARMINGTON, CT 06032

ALLEGION

20-33204

SCALE: NTS UNLESS NOTED 8

NOTES

1. SEE SHEET 16 FOR TRANSOM GLAZING DETAILS.

NTS

SERIES 2000/3000

DURA-STORM SERIES 2000/3000 BILL OF MATERIALS

	BILL OF MATERIALS
REFERENCE	DESCRIPTION
1	Extrusion - Jamb - 4 1/2"
2	Extrusion - Jamb - 6"
3	Extrusion - Jamb - Insert
4	Extrusion - Header - 1 PC
5	Extrusion - Header - 2 PC
6	Extrusion - Header Cover -
7	Extrusion - Top Rail - O, SO
8	Extrusion - Top Rail - O, SO
9	Extrusion - Top Rail - SX
10	Extrusion - Top Rail - SX
11	Extrusion - Stile - Fixed
12	Extrusion - Stile - Lead
14	Extrusion - Stile - Pivot Extrusion - Stile - Pivot
15	Extrusion - Stile - Lead
16	Extrusion - Stile - Lock
17	Extrusion - Muntin Bar/Stacked Bottom Rail Part - 2"
18	Extrusion - Muntin Bar - 4 1/4"
19	Extrusion - Panel Glass Stop - 1/4" - Horizontal
20	Extrusion - Panel Glass Gutter - 1/4" - Horizontal
21	Extrusion - Bottom Rail O - 4"
22	Extrusion - Bottom Rail SO/SX4"
23	Extrusion - Bottom Rail O - 10" - 2 PC
24	Extrusion - Bottom Rail SX/SO - 1 PC - 10"
25	Extrusion - Bottom Rail SX/SO - 2 PC - 10"
26	Extrusion - Hanger -
27	Extrusion - Threshold - Filler
28	Extrusion - Threshold - Dbl bevel - 6"
29	Extrusion - Threshold - Sq/Bvl - 6"
30	Extrusion - Threshold - Recessed - 4.5"
31	Extrusion - Threshold - Core
32	Extrusion - Threshold - Square
33	Extrusion - Threshold - Bevel
34	Component - Top Pivot - SO - 3000 Component - Bottom Pivot - SO - 3000
35 36	Component - Bottom Fivot - 30 - 3000 Component - Bottom Guide - SX- 2000/3000
	Component - Throw Bolt - Std - Adams Rite 4015
37	Component - Top pivot - SX
38	
39	Component - Guide - Throw Bolt - Adams Rite 4015
40	Component - Ball Detent - Std
41	Component - Detent Block - Std
42	Component - Security Hook - Std
43	Component - Security Hook - 1" Glass
45	Component - Backing Plate - Security Hook
46	Component - Ball Detent
47	Component - Detent Block
	Component - Bracket - O Panel
48	
49	Component - Bottom Guide - SX - 2000
50	Component - Load Wheel - Steel/Aluminum/Plastic
51	Component - Lock - Cylinder - Adams Rite 1870 (2-PT Lock) or Adams Rite MS1850S-050 (3-PT Lock)
52	Component - Lock - Thumb Turn - Adams Rite 1870 (2-PT Lock) or Adams Rite MS1850S-050 (3-PT Lock)

59	Indiawale - He Rou - Flate
60	Hardware - Tie Rod - Nut - 5/16-18 - Steel
61	Hardware - Threaded Rod - 5/16-18 - Steel
62	Hardware - 5/16 - 18 - Nut - Steel
63	Hardware - Tie Rod / Rail - Plate - Steel
64	Hardware - 7/16-20 Jamb Nut - Steel
65	Hardware - 7/16 SO Pivot Pin - Steel
66	Hardware - 5/8-11 Nut - Steel
67	Hardware - Tie Rod - Nut Plate
68	Hardware - Tie Rod - Top Clip
69	Hardware - Tie Rod - 3/8-16
70	Hardware - Transom Clip - Steel
71	Hardware - Stiffener - Steel - A500 Hardware - Transom Clip - Aluminum
72	Tube - Transom Stiffener - Single Slide - Steel (w/
73	Optional Transom)
74	Component - Steel Plate - Panic Reinforcing (48" Min.)
75	Component - Key Operator - Adams Rite
76	Component - Lock Flange (Int) - "Wind Clip"
77	Component - Lock Flange (Ext) - "Wind Clip"
78	Component - Header End Plate
79	Component - Muntin Clip (with Panic)
80	Extrusion - Transom - Vertical Muntin
81	Extrusion - Transom - Frame Stop - 1/4"
82	Extrusion - Transom - Vertical Muntin Stop - 1/4"
83	Extrusion - Transom - Header Stop
84	Extrusion - Transom - Header Gutter - 1/4"
85	Extrusion - Panel Glass Gutter - 1/4" - Vertical
86	Extrusion - Panel Glass Gutter - 1"
87	Extrusion - Panel Glass Stop - 1/4" - Vertical
88	Extrusion - Panel Glass Stop - 1"
89	Extrusion - Transom - Header Gutter - 1"
90	Glazing - Vinyl Bulb - 0.200"
91	Glazing - Vinyl Bulb - 0.262"
92	Glazing - Setting Block -
	Glazing - Gasket - Transom
93	Extrusion - Key Strip
94	Extrusion - Threshold - Sq/Bvl - 4.5"
95	The second secon
96	Extrusion - Bottom Rail O - 10"
97	Component - Ball Detent - SO
98	Component - Throw Bolt - Std - Adams Rite 4016
99	Component - Guide - Throw Bolt - Adams Rite 4016
100	Extrusion - 1"x1"x3/16" Angle
101	Nested Tube - Transom Stiffener - Bi-Parting - Steel (w Optional Transom)

BILL OF MATERIALS

Rite 4015 and 4016 Bolts

Component - Exit Indicator -

Component - Brush - Sweep

Component - Foam Block -

Hardware - Tie Rod - Plate

REFERENCE

53

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55

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58

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DESCRIPTION

Adams Rite MS1850S-050 (Deadbolt), Used w/ Adams

Component - 2-Pt Panic Device - Adams Rite G86 with

concealed vertical rod (top/bottom) and latch assembly. Component - Pile - Adhesive/non Adhesive backed

Component - 8 Ply Multipoint Lock - Single Action -

PRODUCT REVISED as complying with the Florida Building Code NOA-No. 22-1207.02

Expiration Date <u>04/11/2028</u>

By Ishaq 1. Chank Miami-Dade Product Control RANK BENNARDO, P.E. PE# 0046549 CA. 9885



POSTAL ADDRESS:
401 W. ATLANTIC AVE R10 BOX 219
DELRAY BEACH, FL 33444
ENGINEERINGEXPRESS.COM EXPRESS.

ALLEGION ACCESS
TECHNOLOGIES, LLC
65 SCOTT SWAMP ROAD
FARMINGTON, CT 06032

SAT SERIES "DURA-STORM 2000/3000" AUTO SGD BI-PARTING/SINGLE SLIDE (NI) MIAMI-DADE NOTICE OF ACCEPTANCE

ALLEGION

20-33204

SCALE: NTS UNLESS NOTED



NON-CALL OUT PART # 44 IS NOT PART OF BOM