

MIAMI-DADE COUNTY PRODUCT CONTROL SECTION

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www.miamidade.gov/building

DEPARTMENT OF REGULATORY AND ECONOMIC RESOURCES (RER) BOARD AND CODE ADMINISTRATION DIVISION

NOTICE OF ACCEPTANCE (NOA)

Diebold Nixdorf, Inc. 818 Mulberry Road S.E. Canton, OH 44707

SCOPE:

This NOA is being issued under the applicable rules and regulations governing the use of construction materials. The documentation submitted has been reviewed and accepted by Miami-Dade County RER - Product Control Section to be used in Miami Dade County and other areas where allowed by the Authority Having Jurisdiction (AHJ).

This NOA shall not be valid after the expiration date stated below. The Miami-Dade County Product Control Section (In Miami Dade County) and/or the AHJ (in areas other than Miami Dade County) reserve the right to have this product or material tested for quality assurance purposes. If this product or material fails to perform in the accepted manner, the manufacturer will incur the expense of such testing and the AHJ may immediately revoke, modify, or suspend the use of such product or material within their jurisdiction. RER reserves the right to revoke this acceptance if it is determined by Miami-Dade County Product Control Section that this product or material fails to meet the requirements of the applicable building code.

This product is approved as described herein and has been designed to comply with the Florida Building Code, including the High Velocity Hurricane Zone.

DESCRIPTION: Series "SV23185B" Aluminum Horizontal Sliding Window – L.M.I.

APPROVAL DOCUMENT: Drawing No. **1909** titled "Series SV23185B HW Aluminum Horizontal Sliding BR Window (LMI)" sheets 1 through 5 of 5, dated 12/15/15, with revision **A** dated 07/31/18, prepared by W. W. Schaefer Engineering & Consulting, P.A., signed and sealed by Warren W. Schaefer, P.E., bearing the Miami-Dade County Product Control Revision stamp with the Notice of Acceptance number and expiration date by the Miami-Dade County Product Control Section.

MISSILE IMPACT RATING: Large and Small Missile Impact Resistant.

LABELING: Each unit shall bear a permanent label with the manufacturer's name or logo, Kall, Germany, model/series, and following statement: "Miami-Dade County Product Control Approved", unless otherwise noted herein.

RENEWAL of this NOA shall be considered after a renewal application has been filed and there has been no change in the applicable building code negatively affecting the performance of this product.

TERMINATION of this NOA will occur after the expiration date or if there has been a revision or change in the materials, use, and/or manufacture of the product or process. Misuse of this NOA as an endorsement of any product, for sales, advertising or any other purposes shall automatically terminate this NOA. Failure to comply with any section of this NOA shall be cause for termination and removal of NOA.

ADVERTISEMENT: The NOA number preceded by the words Miami-Dade County, Florida, and followed by the expiration date may be displayed in advertising literature. If any portion of the NOA is displayed, then it shall be done in its entirety.

INSPECTION: A copy of this entire NOA shall be provided to the user by the manufacturer or its distributors and shall be available for inspection at the job site at the request of the Building Official.

This NOA revises NOA No. 21-0312.08 and consists of this page 1 and evidence pages E-1, E-2 and E-3, as well as approval document mentioned above.

The submitted documentation was reviewed by Manuel Perez, P.E.



NOA No. 23-0713.17 Expiration Date: July 21, 2026 Approval Date: August 10, 2023 Page 1

Diebold Nixdorf, Inc.

NOTICE OF ACCEPTANCE: EVIDENCE SUBMITTED

1. EVIDENCE SUBMITTED UNDER PREVIOUS NOA's

A. DRAWINGS

- 1. Manufacturer's die drawings and sections. (Submitted under NOA No. 16-0519.09)
- 2. Drawing No. 1909 titled "Series SV23185B HW Aluminum Horizontal Sliding BR Window (LMI)" sheets 1 through 5 of 5, dated 12/15/15, with revision A dated 07/31/18, prepared by W. W. Schaefer Engineering & Consulting, P.A., signed and sealed by Warren W. Schaefer, P.E

(Submitted under NOA No. 18-0905.05)

B. TESTS

- 1. Test reports on: 1) Air Infiltration Test, per FBC, TAS 202-94
 - 2) Uniform Static Air Pressure Test, Loading per FBC, TAS 202-94
 - 3) Large Missile Impact Test per FBC, TAS 201-94
 - 4) Cyclic Wind Pressure Loading per FBC, TAS 203-94

along with marked-up drawings and installation diagram of an aluminum horizontal slider w/transaction drawer opening, prepared by Intertek, Inc. Test Report No. **103536819MI-002R1D**, dated 08/15/18, signed and sealed by Gary Hartman, P.E.

(Submitted under NOA No. 18-0905.05)

- 2. Test reports on: 1) Air Infiltration Test, per FBC, TAS 202-94
 - 2) Uniform Static Air Pressure Test, Loading per FBC, TAS 202-94
 - 3) Water Resistance Test, per FBC, TAS 202-94
 - 4) Large Missile Impact Test per FBC, TAS 201-94
 - 5) Cyclic Wind Pressure Loading per FBC, TAS 203-94

along with marked-up drawings and installation diagram of an aluminum horizontal slider, prepared by Architectural Testing, Inc. Test Report No. **F3687-02-201-18**, dated 04/14/16, signed and sealed by Joseph A. Reed, P.E.

(Submitted under NOA No. 16-0519.09)

C. CALCULATIONS

- 1. Anchor verification calculations and structural analysis, complying with **FBC** 6th **Edition (2017)**, dated 07/31/18, prepared by W.W. Schaefer Engineering & Consulting, P.A., signed and sealed by Warren W. Schaefer, P.E. (Submitted under NOA No. 18-0905.05)
- 2. Glazing complies with ASTM E1300-04.

D. **QUALITY ASSURANCE**

1. Miami-Dade Department of Regulatory and Economic Resources (RER)

Manuel Perez, P.E. Product Control Examiner NOA No. 23-0713.17

Expiration Date: July 21, 2026 Approval Date: August 10, 2023

Diebold Nixdorf, Inc.

NOTICE OF ACCEPTANCE: EVIDENCE SUBMITTED

- 1. EVIDENCE SUBMITTED UNDER PREVIOUS NOA'S (CONTINUED)
- E. MATERIAL CERTIFICATIONS
 - 1. Notice of Acceptance No. 19-0305.02 issued to Kuraray America, Inc. for their "Trosifol® Ultraclear, Clear and Color PVB Glass Interlayers" dated 05/09/19, expiring on 07/08/24.

F. STATEMENTS

- 1. Statement letter of conformance, complying with **FBC** 7th **Edition** (2020), and of no financial interest, dated 06/04/20, prepared by W. W. Schaefer Engineering & Consulting, P.A., signed and sealed by Warren W. Schaefer, P.E. (Submitted under NOA No. 20-0923.19)
- 2. Proposal No. **18-0697** issued by the Product Control Section, dated May 7, 2018, signed by Ishaq Chanda, P.E.
 - (Submitted under NOA No. 07-0403.09)
- 3. Distributor Agreement between Schneiders-Vetter Glass (manufacturer) and Diebold Nixdorf, Inc. (distributor), dated 10/01/18, signed by Lita Patek(president) and Jaime Howell (VP) for respective companies.

 (Submitted under NOA No. 18-0905.05)

G. OTHERS

1. Notice of Acceptance No. **20-0623.19** issued to Diebold Nixdorf, Inc. for their Series "SV23185B" Aluminum Horizontal Sliding Window – L.M.I., approved on 08/20/20 and expiring on 07/21/21.

Manuel Perez, P.E. Product Control Examiner NOA No. 23-0713.17

Expiration Date: July 21, 2026 Approval Date: August 10, 2023

Diebold Nixdorf, Inc.

NOTICE OF ACCEPTANCE: EVIDENCE SUBMITTED

- 2. NEW EVIDENCE SUBMITTED
- A. DRAWINGS
 - 1. None.
- B. TESTS
 - 1. None
- C. CALCULATIONS
 - 1. None
- D. QUALITY ASSURANCE
 - 1. Miami-Dade Department of Regulatory and Economic Resources (RER)

E. MATERIAL CERTIFICATIONS

1. Notice of Acceptance No. 20-0915.22 issued to Kuraray America, Inc. for their "Trosifol® Ultraclear, Clear and Color PVB Glass Interlayers" dated 11/19/20, expiring on 07/08/24.

F. STATEMENTS

1. Statement letter of conformance, complying with FBC 8th Edition (2023) and with FBC 7th Edition (2020), dated July 1, 2023, issued by W. W. Schaefer Engineering & Consulting, P.A. and signed and sealed by Warren W. Schaefer, P.E.


G. OTHERS


1. Notice of Acceptance No. **21-0312.17** issued to Diebold Nixdorf, Inc. for their Series "SV23185B" Aluminum Horizontal Sliding Window – L.M.I., approved on 05/06/21 and expiring on 07/21/26.


Manuel Perez, P.E. Product Control Examiner NOA No. 23-0713.17

Expiration Date: July 21, 2026 Approval Date: August 10, 2023


HECKED BY W.W.S. W.W.S. **GENERAL NOTES: PRODUCT RENEWED** - 71 1/2" MAX. FRAME WIDTH as complying with the Florida Building Code 1. THIS PRODUCT HAS BEEN TESTED, ANALYZED & APPROVED FOR DESIGN PRESSURES NOT TO EXCEED THOSE SHOWN IN ATE: 12/15/15 THE "ALLOWABLE DESIGN PRESSURE TABLE(S)". INSTALLATION CLIPS WHERE SHOWN AT HEAD. SEE 2. OPENINGS, BUCKING & BUCKING FASTÈNÉRS MUST BE PROPERLY DESIGNED & INSTALLED TO TRANSFER WIND LOADS TO NOA-No. 21-0312.08 "FRAME ANCHOR REQUIREMENTS TABLE" ON THIS SEE "CORNER Expiration Date-07/21/2026 3. ALL HARDWARE & FASTENERS SHALL BE IN ACCORDANCE WITH THESE DRAWINGS & SHALL NOT VARY UNLESS SHEET FOR CLIP SCREW REQUIREMENTS. CONSTRUCTION" SPECIFICALLY MENTIONED ON THE DRAWINGS. SPECIFIED ANCHOR EMBED TO BASE MATERIAL SHALL BE BEYOND WALL FINISH DESCRIPTION ON 21 3/4" Manuel Peses OR STUCCO. 4" MAX. -THIS SHEET 4. THE DETAILS & SPECIFICATIONS SHOWN HEREIN REPRESENT THE PRODUCTS TESTED & PROPOSED FOR CONFORMANCE MAX. O.C. Miami-Dade Product Control WITH THE FLORIDA BUILDING CODE PROTOCOLS TAS-201, 202 & 203 FOR LARGE MISSILE IMPACT PRODUCTS. 5. THIS PRODUCT HAS BEEN DESIGNED IN ACCORDANCE WITH AND MEETS THE REQUIREMENTS OF THE FLORIDA BUILDING 5" MAX. CODE (FBC) INCLUDING HIGH VELOCITY HURRICANE ZONES (HVHZ). (22)(23 6. IMPACT SHUTTERS ARE NOT REQUIRED WITH THIS PRODUCT. 7. ALL ANCHORS SECURING PRODUCT FRAMES TO PRESSURE TREATED BUCKS OR WOOD FRAMING SHALL BE CAPABLE OF NIGHT LOCK AND RESISTING CORROSION CAUSED BY THE PRESSURE TREATING CHEMICALS IN THE WOOD. KEYED CYLINDER 30 5/8" 8. DETERMINE THE POSITIVE & NEGATIVE DESIGN LOADS TO USE WHEN REFERENCING THESE DOCUMENTS IN ACCORDANCE 26 15/16" 35 1/2" MAX. FRAME HEIGHT AT INTERIOR WITH THE GOVERNING CODE AND GOVERNING WIND VELOCITY. FOR WIND LOAD CALCULATIONS IN ACCORDANCE WITH THE MAX. D.L.O. MAX. D.L.O. 3/4" D.L.O. FLORIDA BUILDING CODE. A DIRECTIONALTY FACTOR OF Kd = 0.85 MAY BE APPLIED PER THE ASCE-7 STANDARD. 9. NO INCREASE IN ALLOWABLE STRESS HAS BEEN USED IN THE CERTIFICATION OF THIS PRODUCT. WIND LOAD DURATION FACTOR Cd = 1.6 WAS USED FOR WOOD SCREW ANALYSIS ONLY. 10. MATERIALS, INCLUDING BUT NOT LIMITED TO STEEL SCREWS, THAT COME INTO CONTACT WITH OTHER DISSIMILAR 24 MAX. 23 3/4" MATERIALS SHALL MEET THE REQUIREMENTS OF FLORIDA BUILDING CODE. (3) 13 3/4" 24 (25 (26) MAX. D.L.O. CORNER CONSTRUCTION: MAX. O.C. HANDLE AT INTERIOR FRAME AT HEAD: HEAD IS BUTTED TO THE SIDE MEMBERS, SEALED WITH SEALANT AND SECURED WITH 4 NO. 10 X 3" & 2 NO. 10 X 2" FL HD PH SMS SCREWS INTO THE HEAD MEMBER SCREW SPLINES. WINDOW FRAME AT SILL: SILL IS BUTTED TO THE SIDE MEMBERS, SEALED WITH SEALANT AND SECURED WITH 2 NO. 10 X 3" & 4" MAX. NO. 10 X 2" FL HD PH SMS SCREWS INTO THE SILL SCREW SPLINES. DIEBOLD NIXDORF, INC. 818 MULBERRY ROAD SE CANTON, OH 44707 330-489-4114 SASH: VERTICAL MEMBERS ARE COPED. HORIZONTAL MEMBERS ARE BUTTED TO THE VERTICAL MEMBERS, SEALED WITH Δ SEALANT, AND SECURED WITH 4 NO. 10 X 3" FL HD PH SMS SCREWS INTO THE HORIZONTAL MEMBER SCREW SPLINES 16" 4" MAX. 4" MAX. MAX. O.C. BR NOTE: WHEN THE STANDARD SILL PAN PART NUMBER 11 IS USED, THE WINDOWS ARE NOT 1/4" DIAMETER WEEP HOLES WITHIN SLIDING FRAME SCREWS WHERE SHOWN AT APPROVED FOR USE WHERE WATER INFILTRATION RESISTANCE IS REQUIRED BY THE WINDOW 2" OF CORNERS AND MAX. 23" O.C. **EXTERIOR ELEVATION:** SIDES AND SILL, SEE "FRAME UNLESS THE UNITS ARE INSTALLED IN NON-HABITABLE AREAS WHERE THE UNIT & THE SINGLE WINDOW IN STANDARD OPENING AREA ARE DESIGNED TO ACCEPT WATER INFILTRATION OR THE UNITS ARE INSTALLED AT ANCHOR REQUIREMENTS TABLE" ON SCALE: 3/4" = 1'-0"THIS SHEET FOR REQUIREMENTS. LOCATIONS PROTECTED BY A CANOPY OR OVERHANG WHERE-BY THE OVERHANG(OH) RATIO SCODUCT REVIEW HORIZONTAL IS EQUAL TO OR MORE THAN 1.0 PER FBC. WHEN THE TALL SILL PAN PART NUMBER 12 is manufring with the Plevid **PRODUCT REVISED** As complying with the Florida Building Code IS USED, THE WINDOW IS WATER RATED Asceptance No. 18-0905-03 71 1/2" MAX. FRAME WIDTH Expiration Date TULZ 12/2 NOA-No. 23-0713.17 ALLOWABLE DESIGN PRESSURE Expiration Date: 07/21/2026 By: Manuel Peres ALUMINUM +65/-75 PSF W. SCHAEFER ENGINEERING CONSULTING, P.A. (CA 6809) 7480 150TH COURT NORTH PALM BEACH GARDENS, FL 33418 PHONE: 551-744-3424 Miami-Dade Product Control PRODUCT REVISED 2" MAX. HEIGHT FRAME SCREWS WHERE as complying with the Florida Building Code FRAME ANCHOR REQUIREMENTS TABLE SHOWN AT SIDES AND SILL. 20-0623.19 SEE "FRAME ANCHOR NOA-No. ₹ MINIMUM OPENING TYPE FRAME/CLIP TO OPENING MINIMUM REQUIREMENTS TABLE" ON -SILL & PAN EMBED EDGE DIST Expiration Date: 07/21/2021 FASTENER TYPE (SUBSTRATE) FULLY SPAN THIS SHEET FOR SV23185B By: _ Ishag 1. Chande FRAME SCREWS REQUIREMENTS. THE OPENING. Miami-Dade Product Control (2) MIN. 2X_ WOOD FRAME OR BUCK 1 1/4" 7/8" NO. 12 SMS OR WOOD SCREW (MIN. GR. 3 & G=0.55) 1/2 MIN. 18 GA. 33 KSI METAL STUD NO. 12 GR. 5 SELF TAP/DRILL SCREW **FULL** SERIES NO. 12 GR. 5 SELF TAP/DRILL SCREW FULL 1/2" MIN. 1/8" THK A36 STEEL NEFER X 1/2" NO. 12 GR. 5 SELF TAP/DRILL SCREW MIN. 1/8" THK 6063-T5 ALUM FULL ું ×ું શ્ર **EQUAL SPACE** 1 1/4" (1) 1/4" CONCRETE SCREW 2" MIN. C-90 CMU OR 2500 PSI CONCRETE (MAX. 16") INSTALLATION CLIP SCREWS 2 3/4" 30" MAX. 2018 SCHAEFER, NO. 44135 (2) MIN. 2X_ WOOD FRAME OR BUCK 1 1/4' 7/8" NO. 12 SMS OR WOOD SCREW **EXTERIOR ELEVATION:** (MIN. GR. 3 & G=0.55) SINGLE WINDOW WITH ACCESS DRAWER OPENING 1/2" NO. 12 GR. 5 SELF TAP/DRILL SCREW **FULL** MIN. 18 GA. 33 KSI METAL STUD SCALE: 3/4" = 1'-0"Х<u>о</u> Э́й OCT 1/2" NO. 12 GR. 5 SELF TAP/DRILL SCREW **FULL** MIN. 1/8" THK A36 STEEL (FOR ALL DETAIL NOT SHOWN OR SPECIFIED, SEE OTHER ELEVATION) FULL 1/2" NO. 12 GR. 5 SELF TAP/DRILL SCREW MIN. 1/8" THK 6063-T5 ALUM (1) 1/4" CONCRETE SCREW 1 1/4" 2" MIN. C-90 CMU OR 2500 PSI CONCRETE TYPICAL SPACE IN OPENING FOR INSTALLATION OF (1) CONCRETE SCREWS SHALL BE ELCO ULTRACONS (C.S.), ELCO CRETE-FLEX (S.S.), ITW A TRANSACTION DRAWER (TRANSACTION DRAWER IS THESE DRAWINGS ARE APPLICABLE ONLY TO THE PRODUC SPECIFIED. THEY MAY NOT BE USED FOR THE ASSEMBLY RAMSET/RED HEAD TAPCONS (C.S. OR S.S.) OR HILTI KWIK-CON II (C.S OR S.S.). SUPPLIED BY OTHERS, IS NOT PART OF THIS 1909 ND/OR INSTALLATION OF ANY OTHER PRODUCT NOR MAY APPROVAL, AND MUST BE INSTALLED WATER TIGHT (2) 2X_ BUCKS SHALL BE OF A MINIMUM DEPTH REQUIRED TO MEET ANCHOR EDGE DISTANCE SHEET NO THEY BE USED FOR RATIONAL AND/OR LOCAL APPROVAL OF ANY PRODUCT NOT PRODUCED BY THE MANUFACTURER TO THE OPENING AND WINDOW) REQUIREMENTS AND ALLOW NEAR FULL BEARING OF WINDOW FRAME. OF

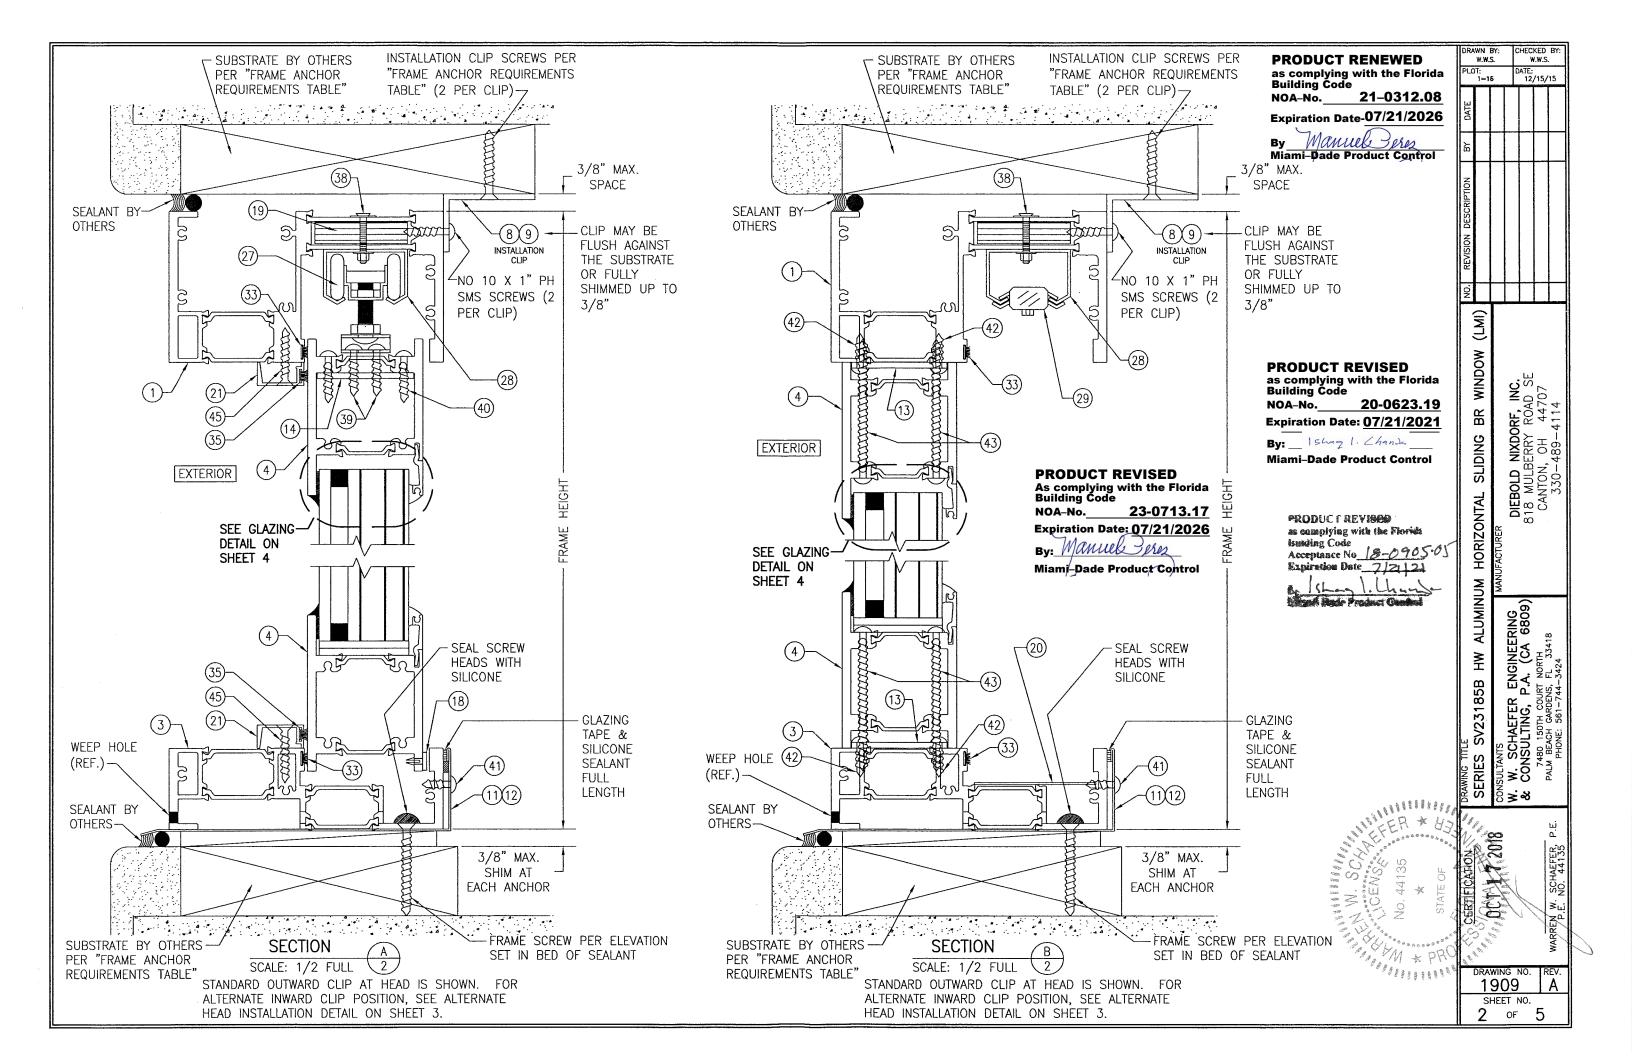

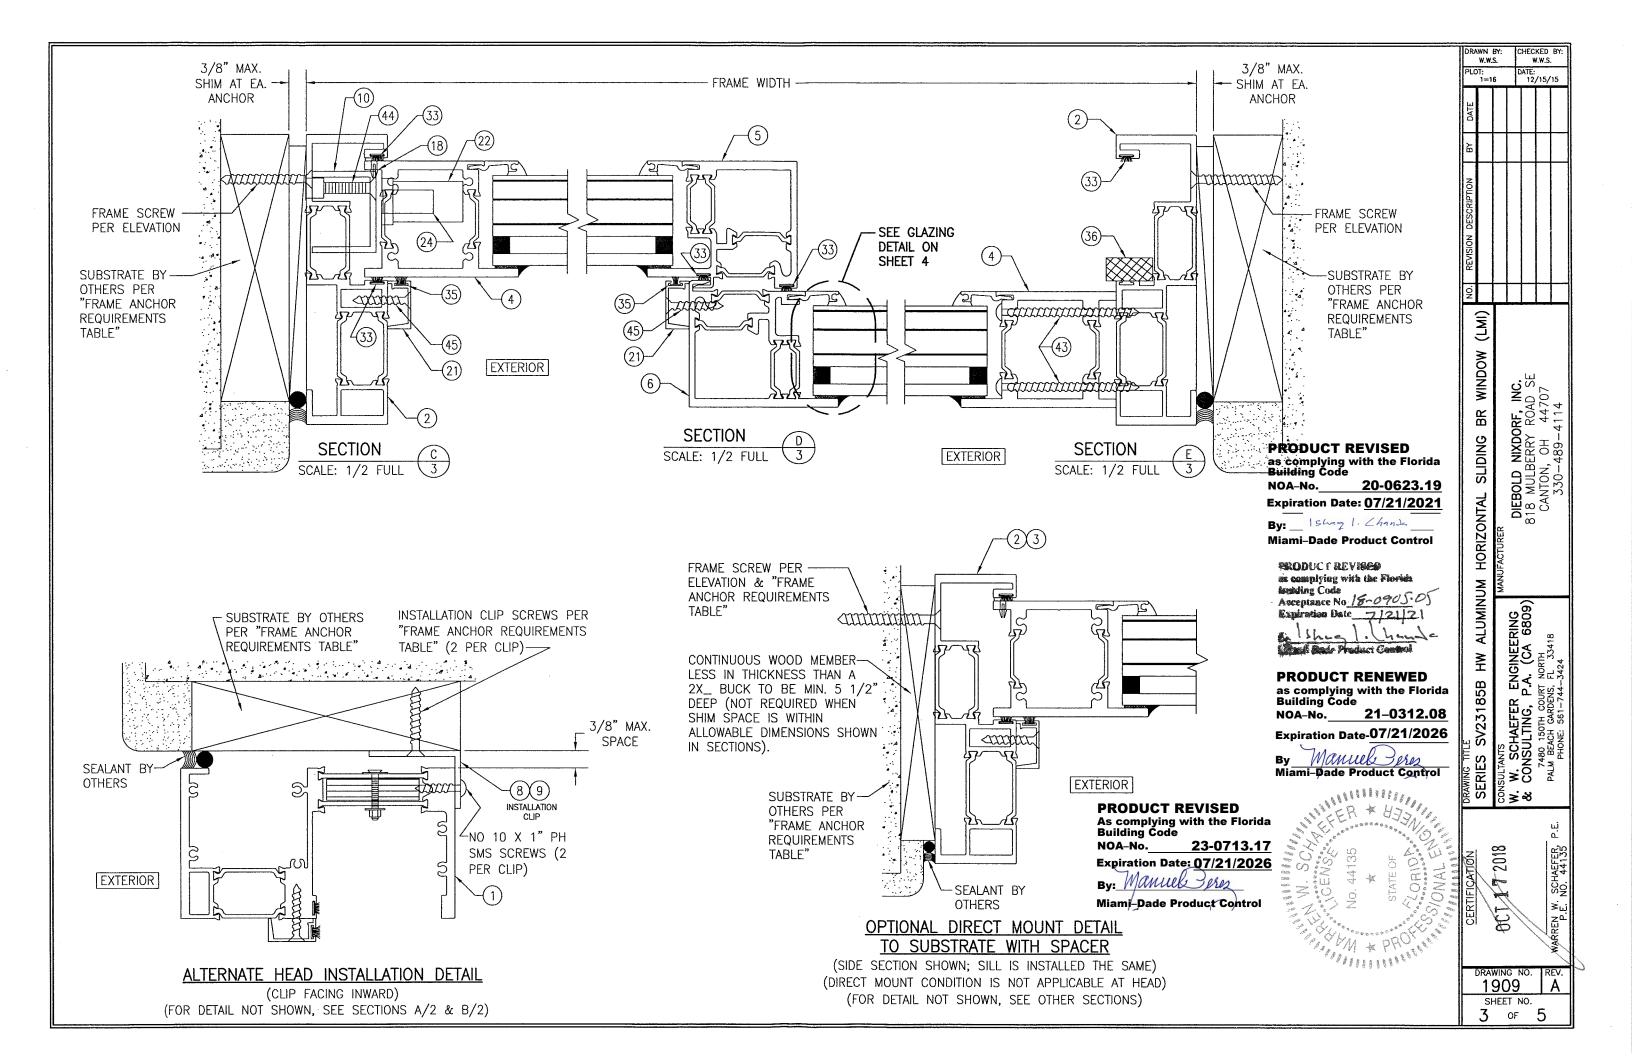


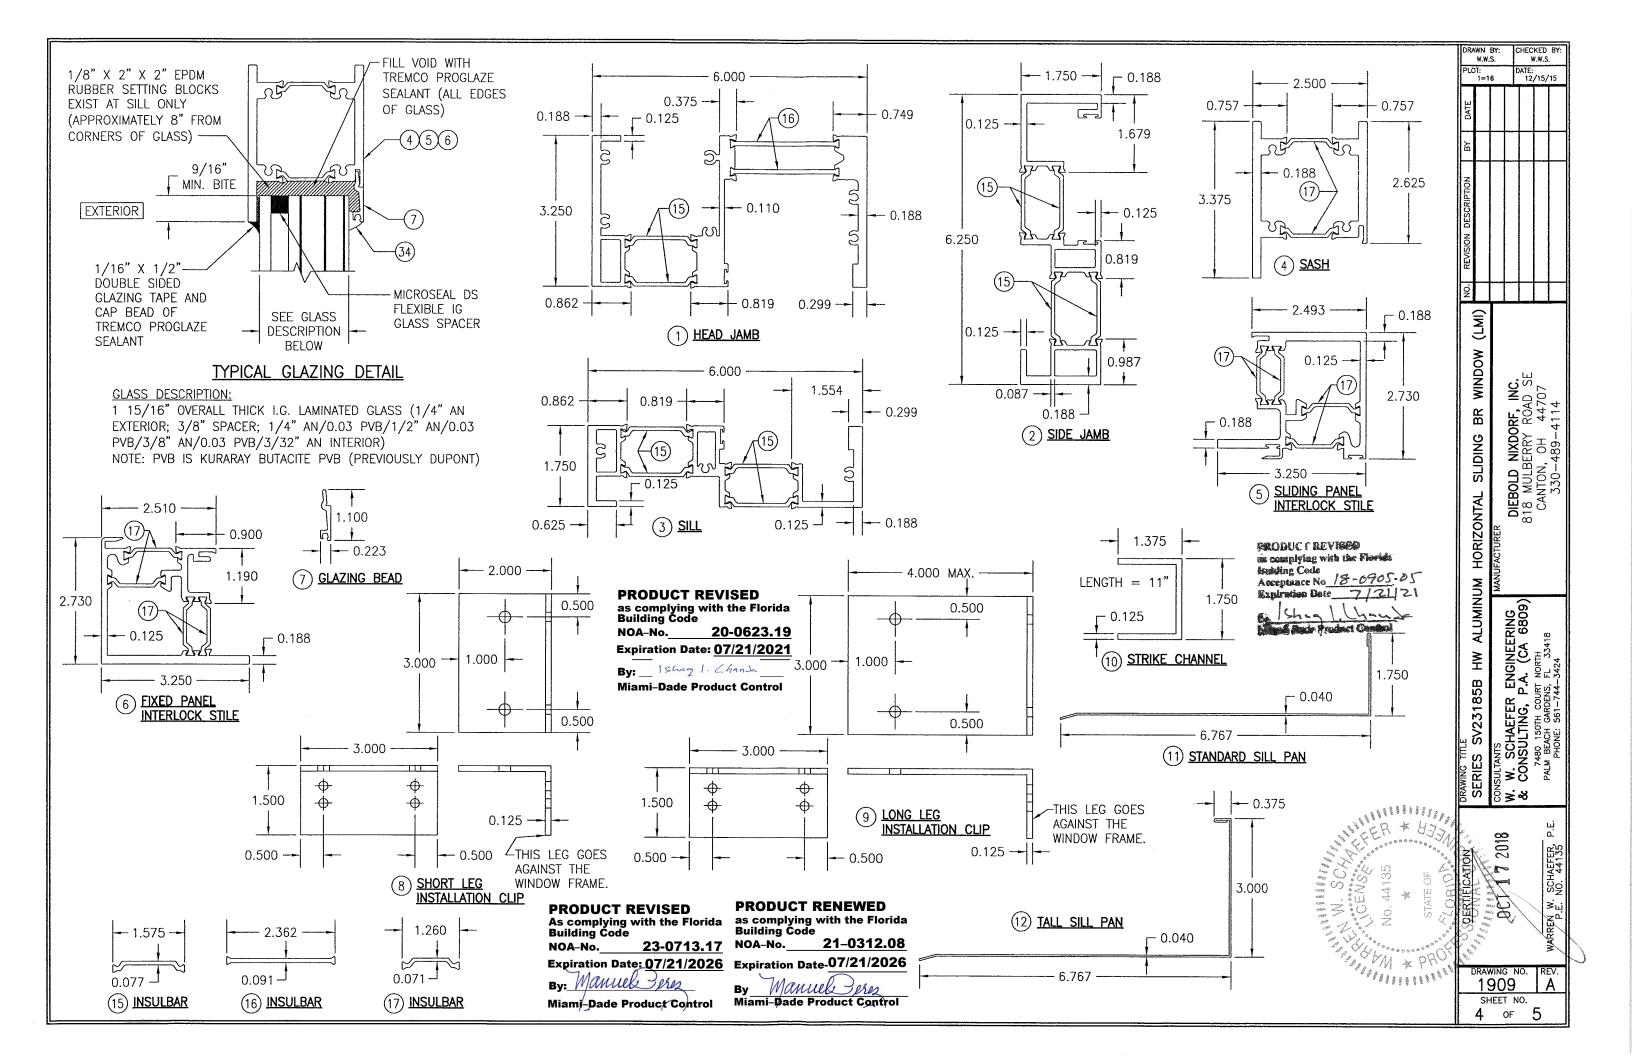

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20 ALUMINUM SILL COVER

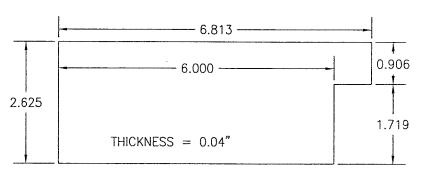

PRODUCT REVISED As complying with the Florida Building Code 23-0713.17 NOA-No. **Expiration Date: 07/21/2026**

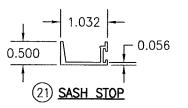By: Manuel Perez Miami-Dade Product Control **PRODUCT RENEWED** as complying with the Florida Building Code 21-0312.08 NOA-No.

Expiration Date-07/21/2026

Miami-Pade Product Control

PRODUCT REVISED as complying with the Florida Building Code NOA-No. 20-0623.19 **Expiration Date: 07/21/2021**

By: _ Ishaq I. Chanda_ Miami-Dade Product Control

> PRODUCT REVISED as complying with the Florida Souding Code Acceptance No 18-0905.05 Basis Basis Product Control

DIEBOLD NIXDORF, INC. 818 MULBERRY ROAD SE CANTON, OH 44707 330-489-4114 BR SLIDING HORIZONTAL ALUMINUM NSULTANTS

/, W. SCHAEFER ENGINEERING

c CONSULTING, P.A. (CA 6809)

7480 150TH COURT NORTH
PALM BEACH GARDENS, FL 33418 Ž SV23185B

(LMI)

WINDOW

CHECKED BY: W.W.S. DATE: 12/15/15

2018

1909 SHEET NO.

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