

DEPARTMENT OF REGULATORY AND ECONOMIC RESOURCES (RER) BOARD AND CODE ADMINISTRATION DIVISION

MIAMI-DADE COUNTY
PRODUCT CONTROL SECTION

11805 SW 26 Street, Room 208 Miami, Florida 33175-2474 T (786) 315-2590 F (786) 315-2599

www.miamidade.gov/economy

NOTICE OF ACCEPTANCE (NOA)

York / Johnson Controls, Inc. 100 JCI Way York, PA 17406

SCOPE:

This NOA is being issued under the applicable rules and regulations governing the use of construction materials. The documentation submitted has been reviewed and accepted by Miami-Dade County RER- Product Control Section to be used in Miami Dade County and other areas where allowed by the Authority Having Jurisdiction (AHJ).

This NOA shall not be valid after the expiration date stated below. The Miami-Dade County Product Control Section (In Miami Dade County) and/or the AHJ (in areas other than Miami Dade County) reserve the right to have this product or material tested for quality assurance purposes. If this product or material fails to perform in the accepted manner, the manufacturer will incur the expense of such testing and the AHJ may immediately revoke, modify, or suspend the use of such product or material within their jurisdiction. RER reserves the right to revoke this acceptance if it is determined by Miami-Dade County Product Control Section that this product or material fails to meet the requirements of the applicable building code.

This product is approved as described herein and has been designed to comply with the High Velocity Hurricane Zone of the Florida Building Code.

DESCRIPTION: "York Custom", "PACE", "Miller-Picking", Air Handling Units

APPROVAL DOCUMENT: Drawing No. 12-06, titled "York Custom (PACE & Miller-Picking) Air Handling Unit", sheets 1 through 19 of 19, and 7.1, 11.1, 11.2, 19.1, 19.2 prepared by Al-Farooq Corporation, dated December 10, 2012, Last revision #H dated August 02, 2023, signed and sealed by Jalal Farooq, P.E., on August 03, 2023, bearing the Miami-Dade County Product Control Revision stamp with the Notice of Acceptance number and the expiration date by the Miami-Dade County Product Control Section.

MISSILE IMPACT RATING: Large and Small Missile Impact Resistant

LABELING: Each unit shall bear a permanent label with the manufacturer's name or logo, York, PA or Albany, MO or Hattiesburg, MS and the following statement: "Miami-Dade County Product Control Approved", unless otherwise noted herein.

RENEWAL of this NOA shall be considered after a renewal application has been filed and there has been no change in the applicable building code negatively affecting the performance of this product.

TERMINATION of this NOA will occur after the expiration date or if there has been a revision or change in the materials, use, and/or manufacture of the product or process. Misuse of this NOA as an endorsement of any product, for sales, advertising or any other purposes shall automatically terminate this NOA. Failure to comply with any section of this NOA shall be cause for termination and removal of NOA.

ADVERTISEMENT: The NOA number preceded by the words Miami-Dade County, Florida, and followed by the expiration date may be displayed in advertising literature. If any portion of the NOA is displayed, then it shall be done in its entirety.

INSPECTION: A copy of this entire NOA shall be provided to the user by the manufacturer or its distributors and shall be available for inspection at the job site at the request of the Building Official.

This NOA revises & renews NOA #21-0615.09 and consists of this page 1, evidence submitted pages E-1, E-2, E-3 & E-4 as well as approval document mentioned above.

The submitted documentation was reviewed by Helmy A. Makar, P.E., M.S.

MIAMI-DADE COUNTY
APPROVED

Heg A. Mhr 02/22/24

NOA No. 23-1107.01 Expiration Date: 12/26/2028 Approval Date: 02/22/2024

Page 1

NOTICE OF ACCEPTANCE: EVIDENCE SUBMITTED

1. EVIDENCE SUBMITTED UNDER PREVIOUS APPROVAL #12-1213.01

A. DRAWINGS

1. Drawing No. 12-06, titled "Solution Air Handling Unit", sheets 1 through 19 of 19, and 7.1, 11.1, 11.2, prepared by Al-Farooq Corporation, dated December 10, 2012, last revision #C dated October 01, 2013, signed and sealed by Javad Ahmad, P.E., on November 22, 2013.

B. TESTS

1. Test reports on 1) Uniform Static Air Pressure Test, Loading per TAS 202-94, 2) Large Missile Impact Test per TAS 201-94, 3) Cyclic Wind Pressure Loading per TAS 203-94, along with marked-up drawings and installation diagram of Solution Air Handling Unit, prepared by Architectural Testing, Test Report No. C0445.01-801-18, dated 05/30/2013, signed and sealed by Vinu J. Abraham, P.E.

C. CALCULATIONS

1. Panel and fasteners analysis prepared by Al-Farooq Corporation, dated December 13, 2012, signed and sealed by Javad Ahmad, P.E., on January 22, 2013.

D. QUALITY ASSURANCE

I. By Miami-Dade County Department of Regulatory and Economic Resources (RER).

E. MATERIAL CERTIFICATIONS

1. Test report on foam, per ASTM D 1929 and ASTM E 84 of Solution Air Handler Unit, prepared by Architectural Testing, Test Report No. D3012.02-106-18, dated 11/20/2013, signed and sealed by Gary T. Hartman, P.E.

2. EVIDENCE SUBMITTED UNDER PREVIOUS APPROVAL #14-0903.01

A. DRAWINGS

1. Drawing No. 12-06, titled "Solution Air Handling Unit", sheets 1 through 19 of 19, and 7.1, 11.1, 11.2, prepared by Al-Farooq Corporation, dated December 10, 2012, Last revision #D dated August 22, 2014, signed and sealed by Javad Ahmad, P.E.

B. TESTS

1. Test reports on 1) Uniform Static Air Pressure Test, Loading per TAS 202-94, 2) Large Missile Impact Test per TAS 201-94, 3) Cyclic Wind Pressure Loading per TAS 203-94, along with marked-up drawings and installation diagram of Solution Air Handling Unit, prepared by Architectural Testing, Test Report No. D9362.01-109-18, dated 08/19/2014, signed and sealed by Michael D. Stremmel, P.E.

C. CALCULATIONS

1. Panel and fasteners analysis, 8 pages, prepared by Al-Farooq Corporation, dated August 22, 2014, signed and sealed by Javad Ahmad, P.E., on August 29, 2014.

Helmy A. Makar, P.E., M.S. Product Control Section Supervisor

NOA No. 23-1107.01

Expiration Date: 12/26/2028 Approval Date: 02/22/2024

NOTICE OF ACCEPTANCE: EVIDENCE SUBMITTED

D. QUALITY ASSURANCE

1. By Miami-Dade County Department of Regulatory and Economic Resources (RER).

E. MATERIAL CERTIFICATIONS

1. None.

F. OTHERS

1. Florida Building Code, 2014 Edition, compliance letter, dated August 26, 2014, prepared by Al-Farooq Corporation, signed and sealed by Javad Ahmad, P.E., on August 29, 2014.

3. EVIDENCE SUBMITTED UNDER PREVIOUS APPROVAL #16-0614.07

A. DRAWINGS

1. Drawing No. 12-06, titled "York Custom (PACE & Miller-Picking) Air Handling Unit", sheets 1 through 19 of 19, and 7.1, 11.1, 11.2, prepared by Al-Farooq Corporation, dated December 10, 2012, Last revision #E dated June 09, 2016, signed and sealed by Javad Ahmad, P.E.

B. TESTS

1. None.

C. CALCULATIONS

1. None.

D. QUALITY ASSURANCE

1. By Miami-Dade County Department of Regulatory and Economic Resources (RER).

E. MATERIAL CERTIFICATIONS

1. None.

F. OTHERS

1. Florida Building Code, 2014 Edition, compliance letter, dated June 09, 2016, prepared by Al-Farooq Corporation, signed and sealed by Javad Ahmad, P.E., on June 10, 2016.

4. EVIDENCE SUBMITTED UNDER PREVIOUS APPROVAL #19-0213.04

A. DRAWINGS

1. Drawing No. 12-06, titled "York Custom (PACE & Miller-Picking) Air Handling Unit", sheets 1 through 19 of 19, and 7.1, 11.1, 11.2, prepared by Al-Farooq Corporation, dated December 10, 2012, Last revision #F dated Sep. 19, 2018, signed and sealed by Javad Ahmad, P.E.

Helmy A. Makar, P.E., M.S. Product Control Section Supervisor

NOA No. 23-1107.01

Expiration Date: 12/26/2028 Approval Date: 02/22/2024

NOTICE OF ACCEPTANCE: EVIDENCE SUBMITTED

- B. TESTS
 - 1. None.
- C. CALCULATIONS
 - 1. None.
- D. QUALITY ASSURANCE
 - 1. By Miami-Dade County Department of Regulatory and Economic Resources (RER).
- E. MATERIAL CERTIFICATIONS
 - 1. None.
- F. OTHERS
 - 1. Florida Building Code, 2017 Edition, compliance letter, dated Sep. 07, 2018, prepared by Al-Farooq Corporation, signed and sealed by Javad Ahmad, P.E., on October 15, 2018.
- 5. EVIDENCE SUBMITTED UNDER PREVIOUS APPROVAL #21-0615.09
- A. DRAWINGS
 - 1. Drawing No. 12-06, titled "York Custom (PACE & Miller-Picking) Air Handling Unit", sheets 1 through 19 of 19, and 7.1, 11.1, 11.2, 19.1, 19.2 prepared by Al-Farooq Corporation, dated December 10, 2012, Last revision #G dated May 20, 2021, signed and sealed by Jalal Farooq, P.E., on May 24, 2021.
- B. TESTS
 - 1. None.
- C. CALCULATIONS
 - 1. None.
- D. OUALITY ASSURANCE
 - 1. By Miami–Dade County Department of Regulatory and Economic Resources (RER).
- E. MATERIAL CERTIFICATIONS
 - 1. None.
- F. OTHERS
 - 1. Florida Building Code, 2020 Edition, compliance letter, dated May 17, 2021, prepared by Al-Farooq Corporation, signed and sealed by Jalal Farooq, P.E., on May 24, 2021.

Helmy A. Makar, P.E., M.S. Product Control Section Supervisor

NOA No. 23-1107.01

Expiration Date: 12/26/2028 Approval Date: 02/22/2024

E-3

NOTICE OF ACCEPTANCE: EVIDENCE SUBMITTED

6. NEW EVIDENCE SUBMITTED

A. DRAWINGS

1. Drawing No. 12-06, titled "York Custom (PACE & Miller-Picking) Air Handling Unit", sheets 1 through 19 of 19, and 7.1, 11.1, 11.2, 19.1, 19.2 prepared by Al-Farooq Corporation, dated December 10, 2012, Last revision #H dated August 02, 2023, signed and sealed by Jalal Farooq, P.E., on August 03, 2023.

B. TESTS

1. None.

C. CALCULATIONS

1. None.

D. QUALITY ASSURANCE

1. By Miami–Dade County Department of Regulatory and Economic Resources (RER).

E. MATERIAL CERTIFICATIONS

1. None.


F. OTHERS

1. Florida Building Code, 2023 Edition, compliance letter, dated August 03, 2023, prepared by Al-Farooq Corporation, signed and sealed by Jalal Farooq, P.E., on August 03, 2023.

Helmy A. Makar, P.E., M.S. Product Control Section Supervisor NOA No. 23-1107.01

Expiration Date: 12/26/2028 Approval Date: 02/22/2024

Housing Material Exterior Walls: 18 GA Steel or 0.08" Thk Alum Min Exterior Roof: 20 GA Steel Min Interior Walls & Roof: 22 GA Steel Min

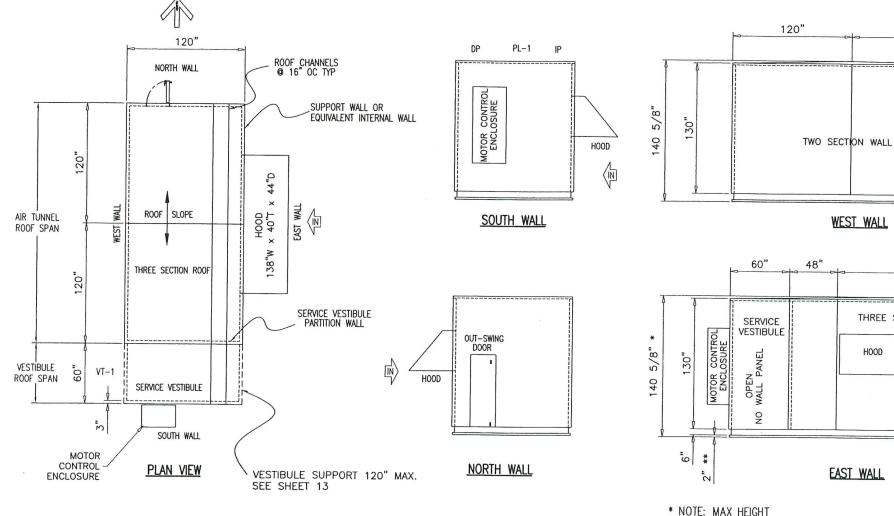

WEST WALL 144" 48" THREE SECTION WALL HOOD

120"

WALL CHANNELS

AT 16" O.C. TYP.

SERVICE VESTIBULE

OPEN WALL PAN

9

* NOTE: MAX HEIGHT TO PEAK OF SLOPED ROOF ** NOTE: 2" CURB ANGLE

MAXIMUM DESIGN LOAD RATING = + 80.0 PSF (FOR SIZES SHOWN ABOVE OR SMALLER) - 80.0 PSF

GENERAL NOTES

- 1. THIS PRODUCT HAS BEEN DESIGNED AND TESTED TO COMPLY WITH THE REQUIREMENTS OF THE 2020 (7TH EDITION)/2023 (8TH EDITION) FLORIDA BUILDING CODE INCLUDING HIGH VELOCITY HURRICANE ZONE (HVHZ).
- 2. STRUCTURAL STEEL SHALL CONFORM TO ASTM DESIGNATION A-36AND STEEL SHEET SHALL CONFORM TO ASTM DESIGNATION A-653, GALVANIZED WITH A COATING DESIGNATION OF G90. MIN. Fy = 48,380 PSI.
- 3. ALL CONCRETE SHALL HAVE A 28 DAY COMPRESSIVE STRENGTH OF 3000 PSI.
- 4. ELECTRICAL AND MECHANICAL DETAILS ARE NOT PART OF THIS APPROVAL.
- 5. POLYURETHANE SHALL BE RIGID FOAM MIN. DENSITY #2 C.F.
- 6. MAX. FLAME SPREAD RATING = 0 AS PER ASTM E-84SMOKE DEVELOPED INDEX = 135.
- SPONTANEOUS-IGNITION TEMPERATURE = 860°F. 7. ALL STEEL TO BE SHOP PRIMED BEFORE ASSEMBLY.
- 8. MIN. SOIL BEARING CAPACITY = 2500 PSF.
- 9. A LOAD DURATION INCREASE IS USED IN DESIGN OF ANCHORS INTO WOOD ONLY.
- 10. MATERIALS INCLUDING BUT NOT LIMITED TO STEEL/METAL SCREWS, THAT COME INTO CONTACT WITH OTHER DISSIMILAR MATERIALS SHALL MEET THE REQUIREMENTS OF THE 2020/2023 FLORIDA BLDG. CODE & ADOPTED STANDARDS.

PRODUCT REVISED as complying with the Florida

AUG 0 3 2023

SIONAL

AL-FAROOQ CORPORATION
ENGINEERS & PRODUCT DEVELOPMENT
9360 SUNSET DRIVE, SUITE 220
MIAMI, FLORIDA 33173 (C.A.N. 3538)
TEL. (305) 264-8100 FAX. (305) 262-6978

U

UNIT CONSTRUCTION

6.0" X 1.92" X 8.2#/ft structural steel channel

Wolls: 18 GA G-90 Golv Steel or 0.08" Thk Alum

C-Channels 16 GA G-90 Galv at 16" Spacing MAX Polyurethane Foom

FOR ACTUAL OVERALL CABINET WIDTH DIMENSIONS ADD:

LIGHT SWITCHES, CONVENIENCE OUTLETS: 4"

72 None / Std

72 None / Std

DESCRIPTION

INLET PLENUM

PLENUM

ACCESS DOOR LIST

Width Height Window / Options FST Mount.

SECTION LIST

DISCHARGE PLENUM

SERVICE VESTIBULE/CORRIDOR

SS Vert.

SS Vert.

Walls: 3.0" Thk Roof: 2.0" Thk at side & 4.63" Thk at Peek

Roof: 20 GA G-90 Galv Steel

Finish: Galvanized or Painted Steel

Model: YC-IPI

Construction:

Weather Proof

Base Insulation: 2.0" Polyurethane Foam Exterior Material:

Wall & Roof Material:

22 GA Steel Liner/Interior

Screw Spacing: See Wall and Roof Details

DOOR HANDLES: 3" WATER COIL CONNECTIONS: 5"

ROOF OVERHANG: 2" OPENING FLANGES: 1.5"

1 24

2 24

SECT #

IP

PL-1

DP

VT-1

YORK/JOHNSON CONTROLS INC. 1499 EAST PHILADELPHIA STREET YORK, PA. 17403 Air ઝ Custom (PACE

(717)

81

description SERIES NAME RE 2017 UPDATE, DO UPDATED TO 2020 UPDATED TO 2020 e C n r o r


1/8"=1 by: | | | |

drawing no. 12 - 06

sheet 1 of 19

1. TH	HE AIR HANDLING UNIT ASSEMBLY HAS BEEN TESTED AND ANALYZED FOR DESIGN PRESSURES NOT TO EXCEED THOSE SHOWN IN
TH	HE "ALLOWABLE DESIGN LOADS" TABLE FOR THE MAXIMUM SIZED PANEL DIMENSIONS AND FRAMING DISTANCE SPACING INDICATED ON
TH	E DRAWINGS.
O TI	IF DETAILS AND CONCURRENCE CON


- 2. THE DETAILS AND SPECIFICATIONS SHOWN ON ALL SHEETS INDICATED REPRESENT THE PRODUCTS AND MATERIALS TESTED AND PROPOSED FOR IMPACT, CYCLIC, AND UNIFORM STATIC AIR PRESSURE TESTING IN ACCORDANCE WITH FLORIDA BUILDING CODE PROTOCOLS TAS 201, TAS 202, AND TAS 203 FOR LARGE MISSILE IMPACT. ADDITIONALLY THE PRODUCT WAS TESTED IN ACCORDANCE WITH ASTM E72 FOR COMPONENT SYSTEM RACKING AND ASTM E8 FOR TENSION TESTING OF THE MATERIAL COMPONENTS
- 3. ATTACHMENT TO THE ROOF AND THE ROOF CURB TO PREVENT SLIDING AND OVERTURNING OF THE AIR HANDLING UNIT IS NOT PART OF THE SCOPE OF THIS PRODUCT APPROVAL, THESE ELEMENTS SHALL BE REVIEWED BY THE CORRESPONDING BUILDING DEPARTMENT. 4. IT SHALL BE THE RESPONSIBILITY OF THE PERMIT HOLDER TO VERIFY STRUCTURAL INTEGRITY OF THE ROOF/BUILDING STRUCTURE TO
- SUPPORT ALL LOADS (WIND AND STATIC) SUPERIMPOSED ON THE STRUCTURE BY THE AIR HANDLING UNIT 5. INTERIOR MOUNTED MECHANICAL EQUIPMENT IS NOT PART OF THIS PRODUCT APPROVAL AND SHALL BE DESIGNED AND INSTALLED BY YORK/JOHNSON CONTROLS IN ACCORDANCE WITH ALL APPLICABLE CODES AND STANDARDS. INTERNAL SUPPORT OF THESE INTERIOR COMPONENTS IS ALSO OUTSIDE THE SCOPE OF THIS PRODUCT APPROVAL.
- 6. ALL HARDWARE & FASTENERS SHALL BE IN ACCORDANCE WITH THESE DRAWINGS AND SHALL NOT VARY UNLESS SPECIFICALLY STATED
- 7. ALL METAL THICKNESSES FOR PANELS, STRUCTURAL SUPPORT ELEMENTS AND OTHER COMPONENTS SHALL BE THE MINIMUM SPECIFIED GAGES DIMENSIONS INDICATED ON THE DRAWINGS.
- 8. ALL SHEET STEEL COMPONENTS SHALL BE MINIMUM 44 KSI SHEET STEEL AT THE SPECIFIED THICKNESS THAT CONFORMS TO ASTM A653, WITH G90U GALVANIZED FINISH.

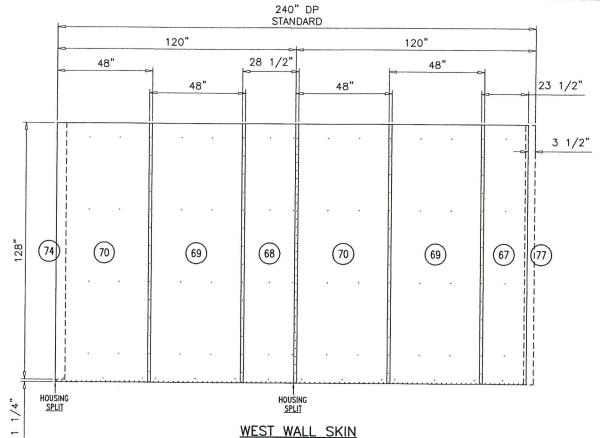


WEST WALL SKIN

18 GA (.045 THK.) MIN. STEEL OR .080" THK. MIN. ALUMINUM EXTERIOR SKIN

- SKINS HELD BACK .125 FROM ALL OPENINGS FRAMED BY 4 CHANNELS.
 HEADER/FOOTER PIECES AT OPENINGS PLACED UNDER FULL LENGTH PIECES.
- 3. STANDARD EXTERIOR SKIN OVERLAP IS 1.50".

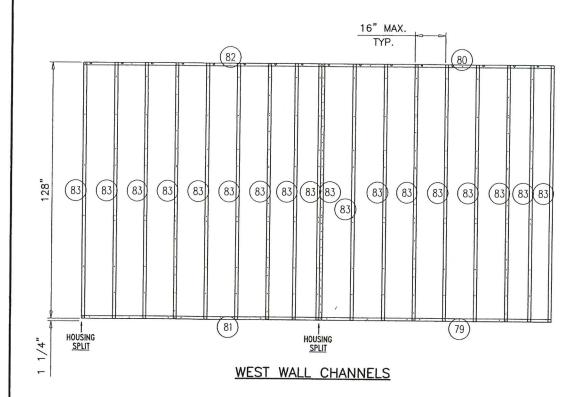

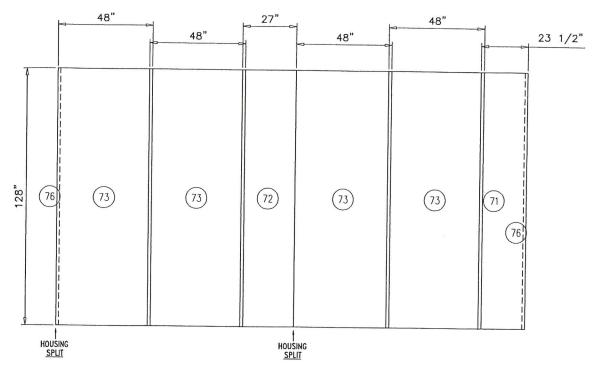

WEST WALL LINERS

22 GA (.028 THK.) MIN. G90 GALV. STEEL SKIN ON THE INTERIOR SIDE

- 1. LINERS HELD BACK .125 FROM ALL OPENINGS FRAMED BY 4 CHANNELS.
- 2. HEADER/FOOTER PIECES AT OPENINGS PLACED UNDER FULL LENGTH PIECES.
- 3. STANDARD INTERIOR LINER OVERLAP IS 1.50".

LEVEL	ITEM	PART NO. *=Stocked	TOTAL QTY.	SORT FIELD	DESCRIPTION SHEET/REF.	QTY. ONE
	66		1	WALL ASSEMBLY	WEST WALL: 240.00 X 128.00	1
	74		1	C: CORNER-CAP3	9.44W X 128.00L X AL,3105H14,.040	1
	77		1	C: CORNER-CAP3	9.44W X 129.25L X AL,3105H14,.040	1
	76		2	C: CORNER-LINER	2.65W X 127.94L X SHEET,GLV,G90,16GA	2
	67		1	C:EXT-SKIN-0	23.50W X 129.25L X AL,3105H14,.040	1
	68		1	C:EXT-SKIN-O	28.50W X 129.25L X AL,3105H14,.040	1
	69		2	C: EXT-SKIN-0	48.00W X 129.25L X AL,3105H14,.040	2
	70		2	C: EXT-SKIN-0	48.00W X 129.25L X AL,3105H14,.040	2
	71		1	C: INT-LINER-O	23.47W X 127.94L X SHEET,GLV,G90,22GA	1
	72		1	C: INT-LINER-O	26.97W X 127.94L X SHEET,GLV,G90,22GA	1
	73		4	C: INT-LINER-O	48.00W X 127.94L X SHEET,GLV,G90,22GA	4
	79		1	C: SC1.41X3.13-0	5.75W X 116.50L X CHANNEL, RF, 16GA, GLV, 5.67W_F	1
	80		1	C: SC1.41X3.13-0	5.75W X 116.50L X CHANNEL, RF, 16GA, GLV, 5.67W_F	1
	81		1	C: SC1.41X3.13-0	5.75W X 120.00L X CHANNEL, RF, 16GA, GLV, 5.67W_F	1
	82		1	C: SC1.41X3.13-0	5.75W X 120.00L X CHANNEL, RF, 16GA, GLV, 5.67W_F	1.
	83		18	C: SC1.50X2.94-0	5.74W X 127.75L X CHANNEL, RF, 16GA, GLV, 5.67W F	18

PRODUCT REVISED as complying with the Florida

Building Code

Acceptance No 23-1107.01



scale: dr. by:

AL-FAROOQ CORPORATION
ENGINEERS & PRODUCT DEVELOPMENT
9360 SUNSET DRIVE, SUITE 220
MIAMI, FLORIDA 33173 (C.A.N. 3538)
TEL. (305) 264-8100 FAX. (305) 262-6978


815-


(717)

YORK Custom (PACE & Miller-Picking) Air Handler Un YORK/JOHNSON CONTROLS INC. 1499 EAST PHILADELPHIA STREET YORK, PA. 17403 TEL. (717) 815–4218 FAX. (717) 815–4198

drawing no. 12 - 06

sheet 2 of 19

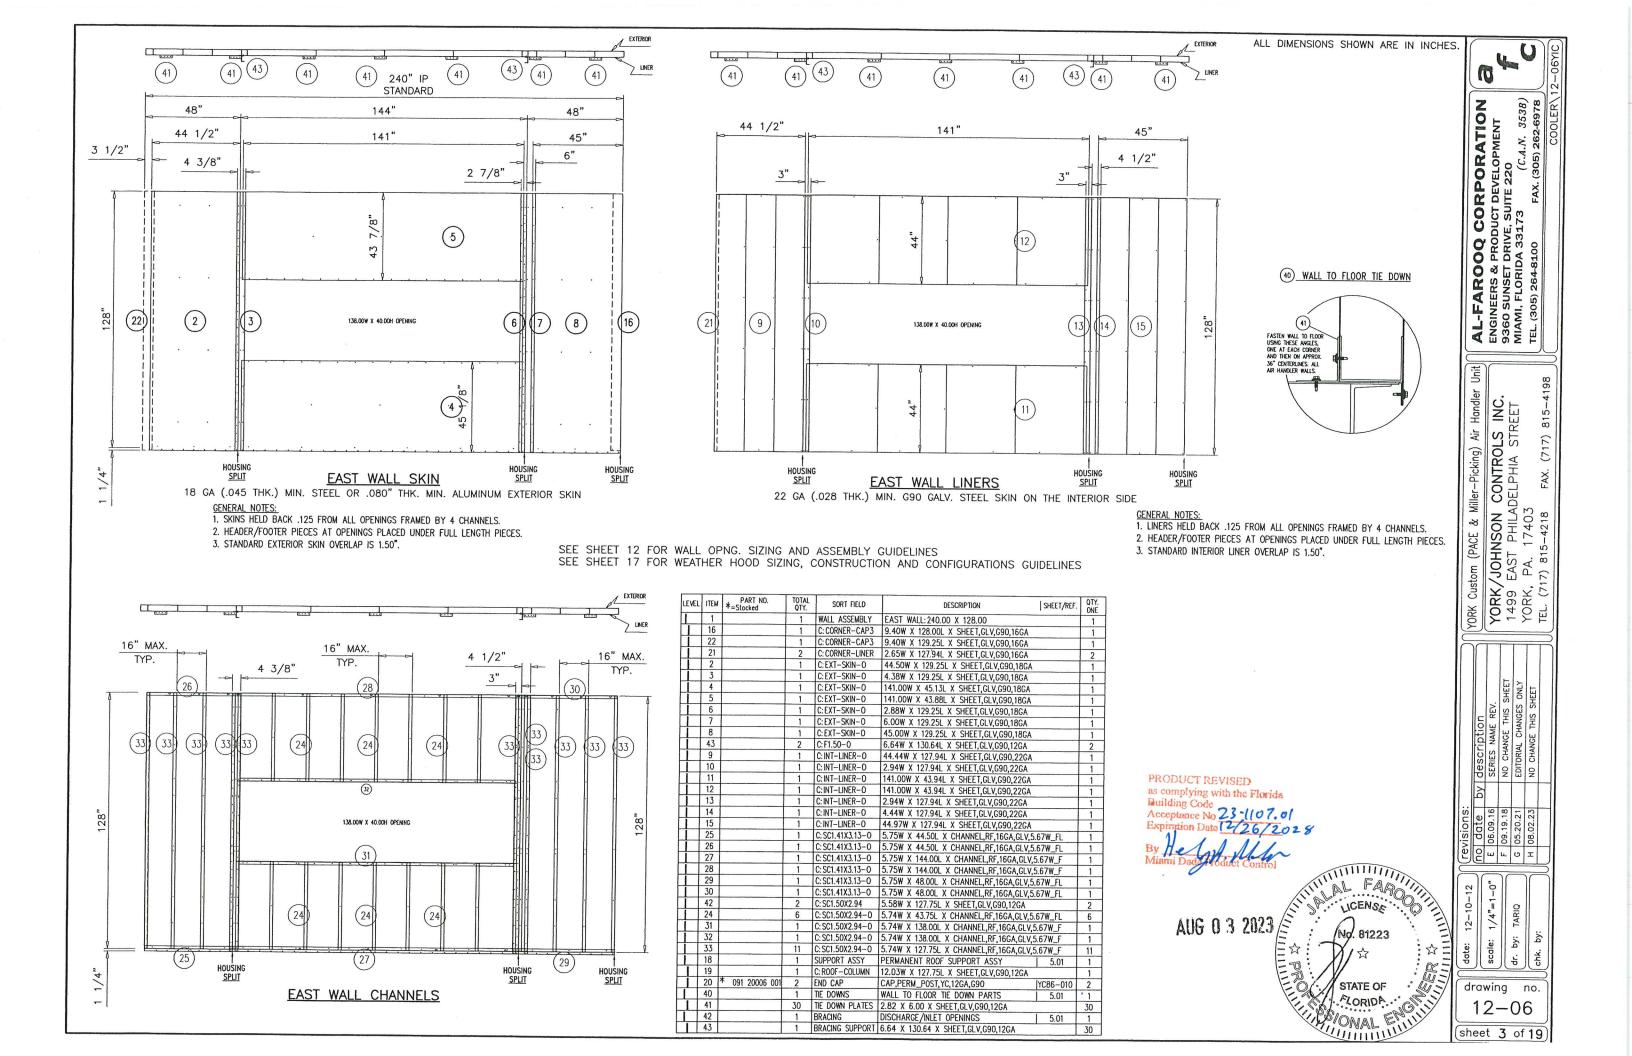

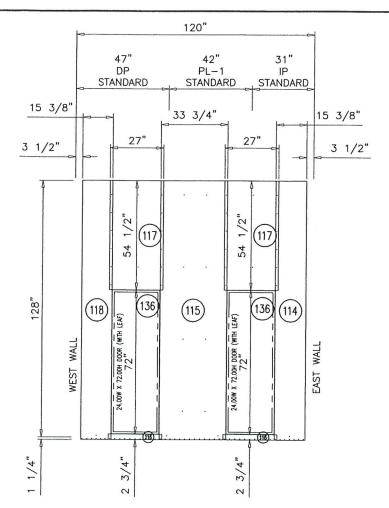



NORTH WALL SKIN

18 GA (.045 THK.) MIN. STEEL OR .080" THK. MIN. ALUMINUM EXTERIOR SKIN

GENERAL NOTES:

- 1. SKINS HELD BACK .125 FROM ALL OPENINGS FRAMED BY 4 CHANNELS.
- 2. HEADER/FOOTER PIECES AT OPENINGS PLACED UNDER FULL LENGTH PIECES.
- 3. STANDARD EXTERIOR SKIN OVERLAP IS 1.50".

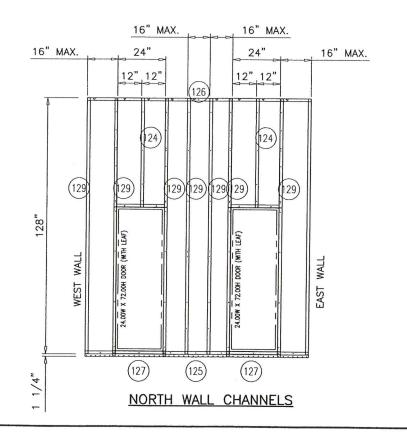

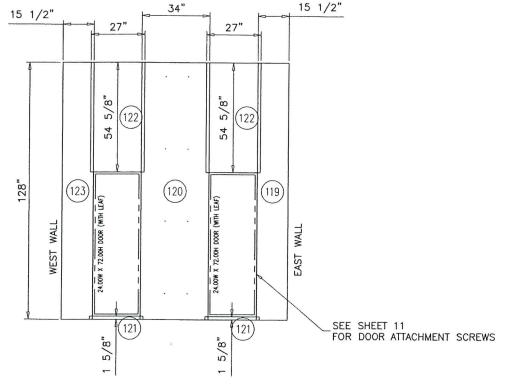

NORTH WALL LINERS


22 GA (.028 THK.) MIN. G90 GALV. STEEL SKIN ON THE INTERIOR SIDE

- 1. LINERS HELD BACK .125 FROM ALL OPENINGS FRAMED BY 4 CHANNELS.
- 2. HEADER/FOOTER PIECES AT OPENINGS PLACED UNDER FULL LENGTH PIECES.
- 3. STANDARD INTERIOR LINER OVERLAP IS 1.50".

LEVEL	ITEM	PART NO. *=Stocked	TOTAL QTY.	SORT FIELD	DESCRIPTION SHEET/REF.	QTY. ONE
	113		1	WALL ASSEMBLY	NORTH WALL: 120.00 X 128.00	1
	114		1	C: EXT-SKIN-0	15.38W X 129.25L X AL,3105H14,.040	1
	115		1	C: EXT-SKIN-0	33.75W X 129.25L X AL,3105H14,.040	1
	116		2	C: EXT-SKIN-0	27.00W X 2.75L X AL,3105H14,.040	2
	117		2	C: EXT-SKIN-0	27.00W X 54.50L X AL,3105H14,.040	2
	118		1	C: EXT-SKIN-0	15.38W X 129.25L X AL,3105H14,.040	1
	119		1	C: INT-LINER-O	15.44W X 127.94L X SHEET,GLV,G90,22GA	1
	120		1	C: INT-LINER-0	33.94W X 127.94L X SHEET,GLV,G90,22GA	1
	121		2	C: INT-LINER-0	27.00W X 1.56L X SHEET,GLV,G90,22GA	2
	122		2	C: INT-LINER-0	27.00W X 54.56L X SHEET,GLV,G90,22GA	2
	123		1	C: INT-LINER-0	15.44W X 127.94L X SHEET,GLV,G90,22GA	1
	136		2	C: RAIN-LIP	2.57W X 25.75L X AL,3105H14,.040	2
	125		1	C: SC1.41X3.13-0	5.75W X 113.00L X CHANNEL,RF,16GA,GLV,5.67W_F	1
	126		1	C: SC1.41X3.13-0	5.75W X 113.00L X CHANNEL,RF,16GA,GLV,5.67W_F	1
	124		2	C: SC1.50X2.94-0	5.74W X 54.38L X CHANNEL,RF,16GA,GLV,5.67W_FL	2
	127		2	C: SC1.50X2.94-0	5.74W X 24.00L X CHANNEL,RF,16GA,GLV,5.67W_FL	2
	128		2	C: SC1.50X2.94-0	5.74W X 24.00L X CHANNEL,RF,16GA,GLV,5.67W_FL	2
	129		8	C: SC1.50X2.94-0	5.74W X 127.75L X CHANNEL,RF,16GA,GLV,5.67W_F	8

PRODUCT REVISED

AUG 0 3 2023

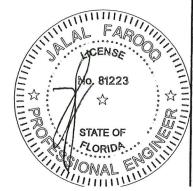

 AL-FAROOQ CORPORATION

 ENGINEERS & PRODUCT DEVELOPMENT

 9360 SUNSET DRIVE, SUITE 220

 MIAMI, FLORIDA 33173
 (C.A.N. 3538)


 TEL. (305) 264-8100
 FAX. (305) 262-6978

YORK Custom (PACE & Miller-Picking) Air Handler Un YORK/JOHNSON CONTROLS INC. 1499 EAST PHILADELPHIA STREET YORK, PA. 17403
TEL. (717) 815–4218 FAX. (717) 815–4198

revisions:
no date
E 06.09.16
F 09.19.18
G 05.20.21
H 08.02.23

| \f drawing no. 12 - 06

sheet 4 of 19

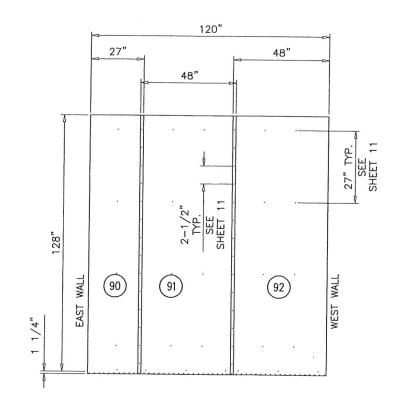

SOUTH WALL SKIN


18 GA (.045 THK.) MIN. STEEL OR .080" THK. MIN. ALUMINUM EXTERIOR SKIN


GENERAL NOTES:

1. SKINS HELD BACK .125 FROM ALL OPENINGS FRAMED BY 4 CHANNELS.

2. HEADER/FOOTER PIECES AT OPENINGS PLACED UNDER FULL LENGTH PIECES.

3. STANDARD EXTERIOR SKIN OVERLAP IS 1.50".

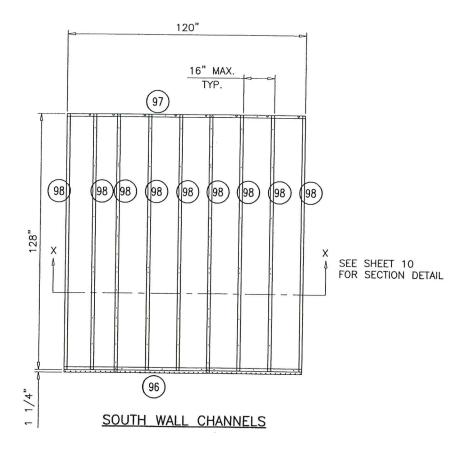

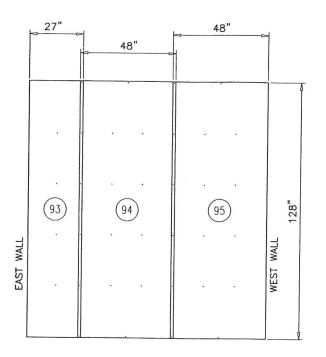

SOUTH WALL LINERS

22 GA (.028 THK.) MIN. G90 GALV. STEEL SKIN ON THE INTERIOR SIDE

1. LINERS HELD BACK .125 FROM ALL OPENINGS FRAMED BY 4 CHANNELS.

2. HEADER/FOOTER PIECES AT OPENINGS PLACED UNDER FULL LENGTH PIECES.

3. STANDARD INTERIOR LINER OVERLAP IS 1.50".

LEVEL	ITEM	PART NO. *=Stocked	TOTAL QTY.	SORT FIELD	DESCRIPTION SHEET/REF.	QTY. ONE
	89		1	WALL ASSEMBLY	SOUTH WALL: 120.00 X 128.00	1
	103	391 20002 002	29CF	OCR #574	FOAM MIX, PART A,B, & FREON	29CF
	90		1	C:EXT-SKIN-0	27.00W X 129.25L X SHEET,GLV,G90,18GA	1
	91		1	C: EXT-SKIN-0	48.00W X 129.25L X SHEET,GLV,G90,18GA	1
	92		1	C: EXT-SKIN-0	48.00W X 129.25L X SHEET,GLV,G90,18GA	1
	93		1	C: INT-LINER-0	26.94W X 127.94L X SHEET,GLV,G90,22GA	1
	94		1	C: INT-LINER-0	47.97W X 127.94L X SHEET,GLV,G90,22GA	1
	95		1	C: INT-LINER-0	47.97W X 127.94L X SHEET,GLV,G90,22GA	1
	96		1	C: SC1.41X3.13-0	5.75W X 120.00L X CHANNEL, RF, 16GA, GLV, 5.67W_F	1
	97		1	C: SC1.41X3.13-0	5.75W X 120.00L X CHANNEL, RF, 16GA, GLV, 5.67W_F	1
	98		9	C: SC1.50X2.94-0	5.74W X 127.75L X CHANNEL, RF, 16GA, GLV, 5.67W_F	9

AUG 0 3 2023

as complying with the Florida

PRODUCT REVISED

(C.A.N. 3538) FAX. (305) 262-6978

AL-FAROOQ CORPORATION
ENGINEERS & PRODUCT DEVELOPMENT
9360 SUNSET DRIVE, SUITE 220
MIAMI, FLORIDA 33173 (C.A.N. 3538)


(717) 815-4198

YORK Custom (PACE & Miller-Picking) Air Handler Un YORK/JOHNSON CONTROLS INC. 1499 EAST PHILADELPHIA STREET YORK, PA. 17403 TEL. (717) 815–4218 FAX. (717) 815–4198

by:

drawing no. 12 - 06

(sheet 5 of 19)

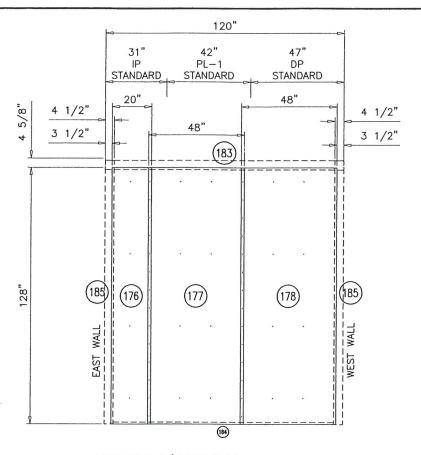


VESTIBULE/CORRIDOR WALL SKIN

18 GA (.045 THK.) MIN. STEEL OR .080" THK. MIN. ALUMINUM EXTERIOR SKIN

GENERAL NOTES:

- 1. SKINS HELD BACK .125 FROM ALL OPENINGS FRAMED BY 4 CHANNELS.
- 2. HEADER/FOOTER PIECES AT OPENINGS PLACED UNDER FULL LENGTH PIECES.
- 3. STANDARD EXTERIOR SKIN OVERLAP IS 1.50".

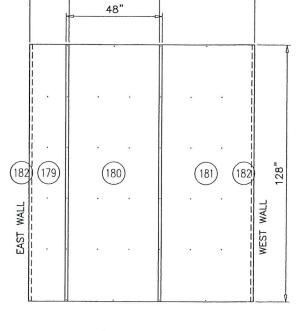

48"

VESTIBULE/CORRIDOR WALL LINERS

22 GA (.028 THK.) MIN. G90 GALV. STEEL SKIN ON THE INTERIOR SIDE

GENERAL NOTES:

20"

- 1. LINERS HELD BACK .125 FROM ALL OPENINGS FRAMED BY 4 CHANNELS.
- 2. HEADER/FOOTER PIECES AT OPENINGS PLACED UNDER FULL LENGTH PIECES.
- 3. STANDARD INTERIOR LINER OVERLAP IS 1.50".

					16" T	MAX. YP.	10-	7	
T					(187)-		<u> </u>	<u> </u>	
128"	188	188	188	188	188	(188)	188	188	(88)
				((186)				

VESTIBULE/CORRIDOR WALL CHANNELS

LEVEL	ITEM	PART NO. *=Stocked	TOTAL QTY.	SORT FIELD	DESCRIPTION SHEET/REF.	QTY. ONE
	175		1	WALL ASSEMBLY	CORRIDOR WALL: 120.00 X 128.00	1
	184		1	C: ATTACH-ANGLE	1.94W X 111.00L X SHEET,GLV,G90,20GA	1
	182		2	C: CORNER-LINER	2.65W X 127.94L X SHEET,GLV,G90,16GA	2
	176		1	C:EXT-SKIN-0	20.00W X 128.00L X SHEET,GLV,G90,20GA	1
	177		1	C: EXT-SKIN-0	48.00W X 128.00L X SHEET,GLV,G90,20GA	1
	178		1	C: EXT-SKIN-0	48.00W X 128.00L X SHEET,GLV,G90,20GA	1
	179		1	C: INT-LINER-O	19.94W X 127.94L X SHEET,GLV,G90,22GA	1
	180		1	C:INT-LINER-O	47.97W X 127.94L X SHEET,GLV,G90,22GA	1
	181		1	C: INT-LINER-O	47.97W X 127.94L X SHEET,GLV,G90,22GA	1
	186		1	C: SC1.41X3.13-0	5.75W X 113.00L X CHANNEL, RF, 16GA, GLV, 5.67W_F	1
	187		1	C: SC1.41X3.13-0	5.75W X 113.00L X CHANNEL, RF, 16GA, GLV, 5.67W_F	1
	188		9	C: SC1.50X2.94-0	5.74W X 127.75L X CHANNEL, RF, 16GA, GLV, 5.67W_F	9
	185		2	C: SEAL-ANGLE	5.94W X 131.63L X SHEET,GLV,G90,20GA	2
	183		1	C: SEAL-ANGLE-2	6.57W X 120.00L X SHEET,GLV,G90,20GA	1

AUG 0 3 2023

PRODUCT REVISED as complying with the Florida



AL-FAROOQ CORPORATION
ENGINEERS & PRODUCT DEVELOPMENT
9360 SUNSET DRIVE, SUITE 220
MIAMI, FLORIDA 33173 (C.A.N. 3538)
TEL. (305) 2648100 FAX. (305) 262-6978


YORK Custom (PACE & Miller-Picking) Air Handler Un YORK/JOHNSON CONTROLS INC. 1499 EAST PHILADELPHIA STREET YORK, PA. 17403
TEL. (717) 815-4218 FAX. (717) 815-4198 815-FAX.

revisions:
no date
E 06.09.16
F 09.19.18
G 05.20.21
H 08.02.23


by: d.

drawing no. 12 - 06

sheet 6 of 19

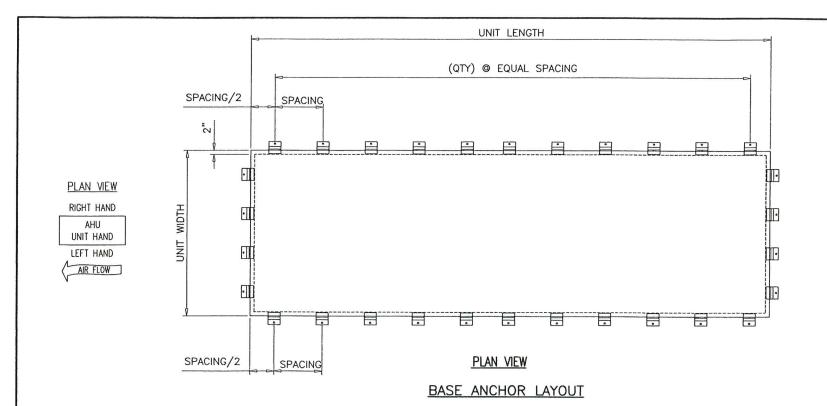

NOTE: ANCHOR SPACING WILL VARY BASED ON UNIT LENGTH BUT SHALL NOT EXCEED 16" O.C.

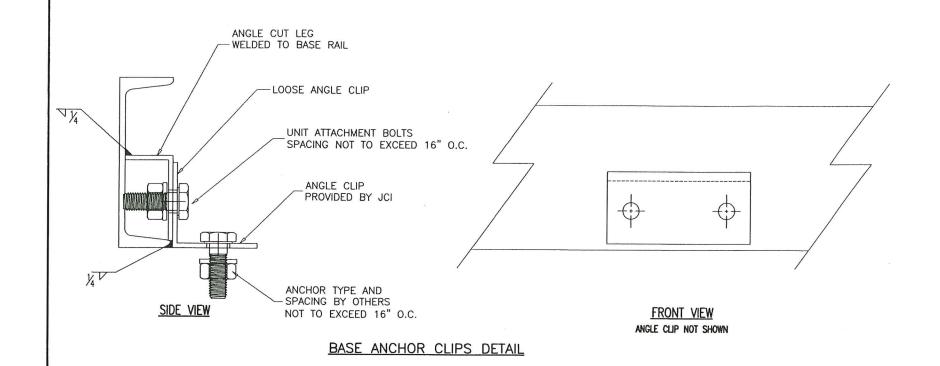

UNIT CONSTRUCTION

6" X 1.92" X 8.2#/ft structural steel channel 8" X 2.26" X 11.5#/ft structural steel channel 10" X 2.60" X 15.3#/ft structural steel channel 12" X 2.94" X 20.7#/ft structural steel channel painted w/ 6 to 8 mil DFT Champagne Epoxy. Base Insulation:

2" Polyurethane Foam Base Skin:

16 Ga Minimum.

1. Unit base frame is bolted C-channel structural steel.

PRODUCT REVISED

- 2. Air Handling Unit can vary in size however, spacing of the structural support elements such as the base frame, roof/wall panels, hardware spacing, hardware sizes, shall not exceed the dimensions or material gages indicated.
- 3. It shall be the responsibility of the permit holder to verify the strucutal integrity of the existing structure to support the loads superimposed by the Air Handling Unit.
- 4. Attachment to the concrete/steel structure to prevent sliding and overturning of the air handling unit is not part of the scope of this product approval. These elements shall be reviewed by the corresponding building department.



STATE OF SIONAL S

12 - 06

sheet 7 of 19

AL-FAROOQ CORPORATION
ENGINEERS & PRODUCT DEVELOPMENT
9360 SUNSET DRIVE, SUITE 220
MIAMI, FLORIDA 33173 (C.A.N. 3538)
TEL. (305) 264-8100 FAX. (305) 262-6978

YORK Custom (PACE & Miller-Picking) Air Handler Un YORK/JOHNSON CONTROLS INC. 1499 EAST PHILADELPHIA STREET YORK, PA. 17403
TEL. (717) 815–4218 FAX. (717) 815–4198


description SERIES NAME REV. NO CHANGE THIS SHEET EDITORIAL CHANGES ONLY NO CHANGE THIS SHEET


drawing no.

INTERIOR BASE CHANNELS

-INTERIOR BASE CHANNELS WILL BE FABRICATED FROM 10 GAUGE HR MATERIAL. WHEN THE MAXIMUM SPAN FOR FORMED CHANNEL IS EXCEEDED, STRUCTURAL CHANNEL WILL BE USED.)

-IN GENERAL, THE INTERIOR BASE CHANNELS WILL SPAN THE SHORTEST DIRECTION (SEE EXAMPLES BELOW). SOME EXCEPTIONS TO THIS RULE ARE COIL DRAIN PANS, RECESSED FLOORS AND Evap-Pak SUMP SUPPORTS.

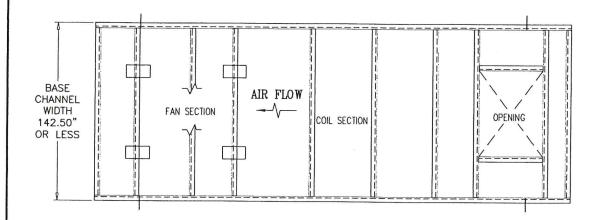

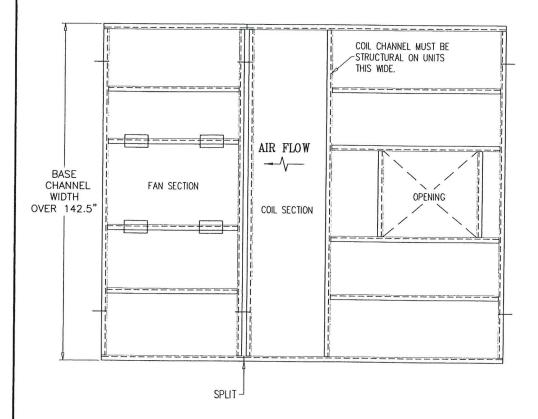



TYPICAL BASE CHANNEL LAYOUT

BASE SKIN LAYOUT

-IN GENERAL THE BASE SKINS WILL BE SIZED WITH THEIR LONGEST DIMENSION PARALLEL TO THE SKIN SUPPORT CHANNEL.

-ALL BASE SKIN SEAMS MUST BE SUPPORTED BY EITHER A FORMED OR STRUCTURAL CHANNEL.

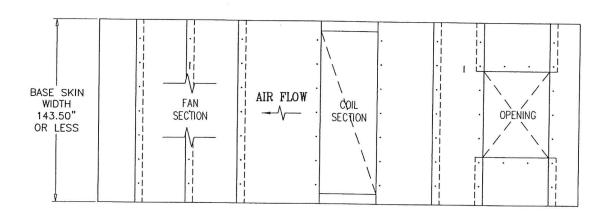

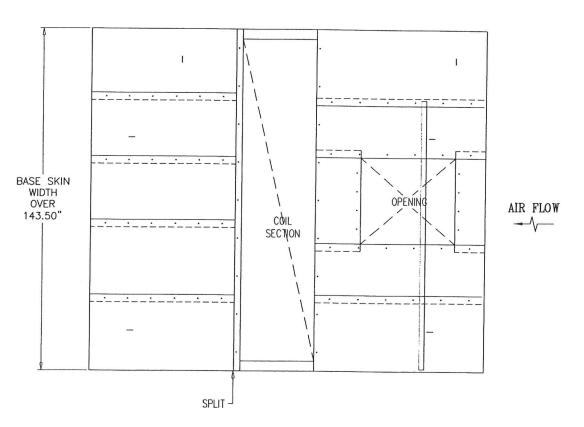


TYPICAL BASE SKIN LAYOUT

AUG 0 3 2023

PRODUCT REVISED as complying with the Florida Building Code
Acceptance No 23-(107.0)

Acceptance No 23-1107.01
Expiration Date 12/26/202

By Hold Hold Control

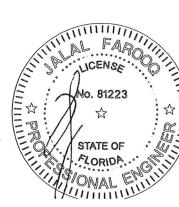


AL-FAROOQ CORPORATION
ENGINEERS & PRODUCT DEVELOPMENT
9360 SUNSET DRIVE, SUITE 220
MIAMI, FLORIDA 33173 (C.A.N. 3538)
TEL. (305) 264-8100 FAX. (305) 262-6978
COOLER/12 YORK Custom (PACE & Miller-Picking) Air Handler Un
YORK/JOHNSON CONTROLS INC.
1499 EAST PHILADELPHIA STREET
YORK, PA. 17403
TEL. (717) 815-4218 FAX. (717) 815-4198


by:

Ą.

drawing no. 12-06

sheet 7.1 of 19

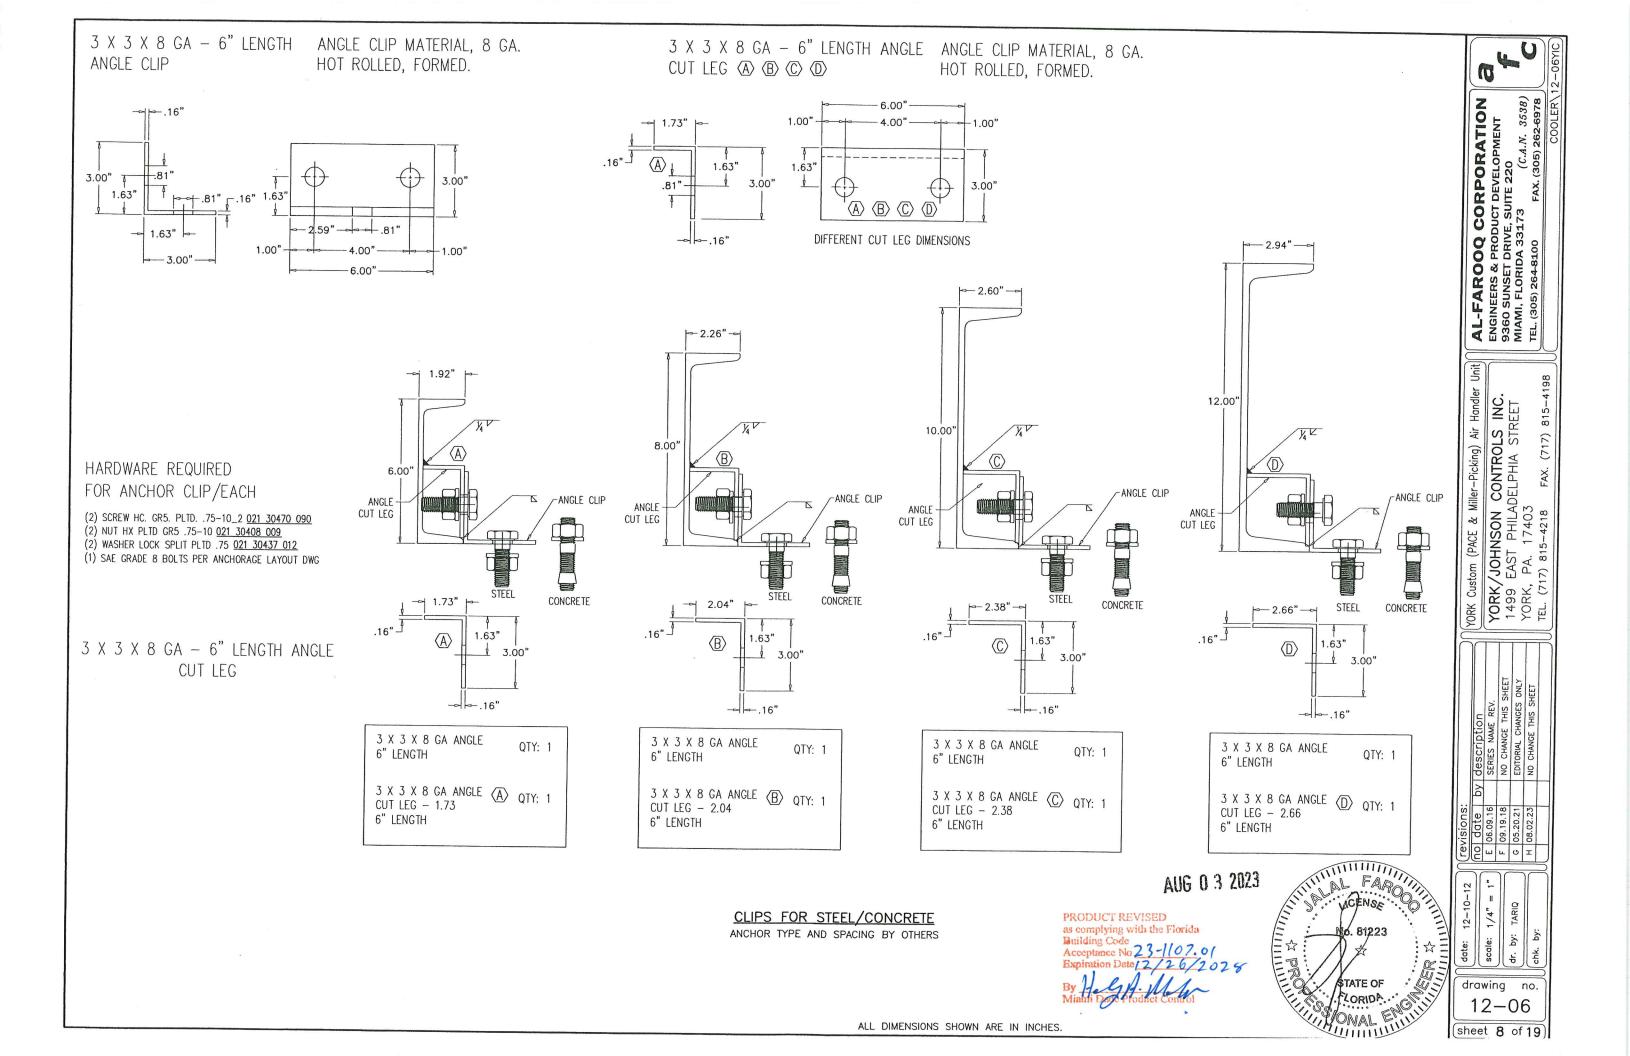

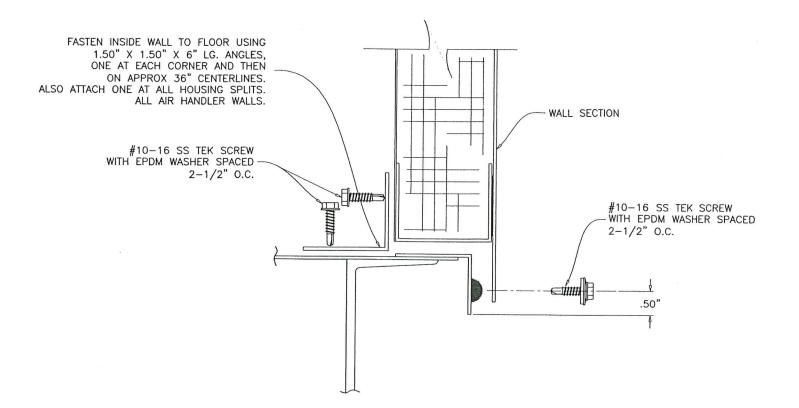

WALLS TO BASE
WALL ATTACHMENT
TO PERIMETER ANGLE

AUG 0 3 2023

PRODUCT REVISED as complying with the Florida Building Code

GENSE

D. 81223

STATE OF

ACORDA

MONAL ENTITY

MONAL ENT


YORK Custom (PACE & Miller-Picking) Air Handler Unit
YORK/JOHNSON CONTROLS INC.
1499 EAST PHILADELPHIA STREET
YORK, PA. 17403
TEL. (717) 815-4218 FAX. (717) 815-4198


AL-FAROOQ CORPORATION
ENGINEERS & PRODUCT DEVELOPMENT
9360 SUNSET DRIVE, SUITE 220
MIAMI, FLORIDA 33173 (C.A.N. 3538)
TEL. (305) 264-8100 FAX. (305) 262-6978

scale: dr. by:

drawing no. 12 - 06


sheet 9 of 19

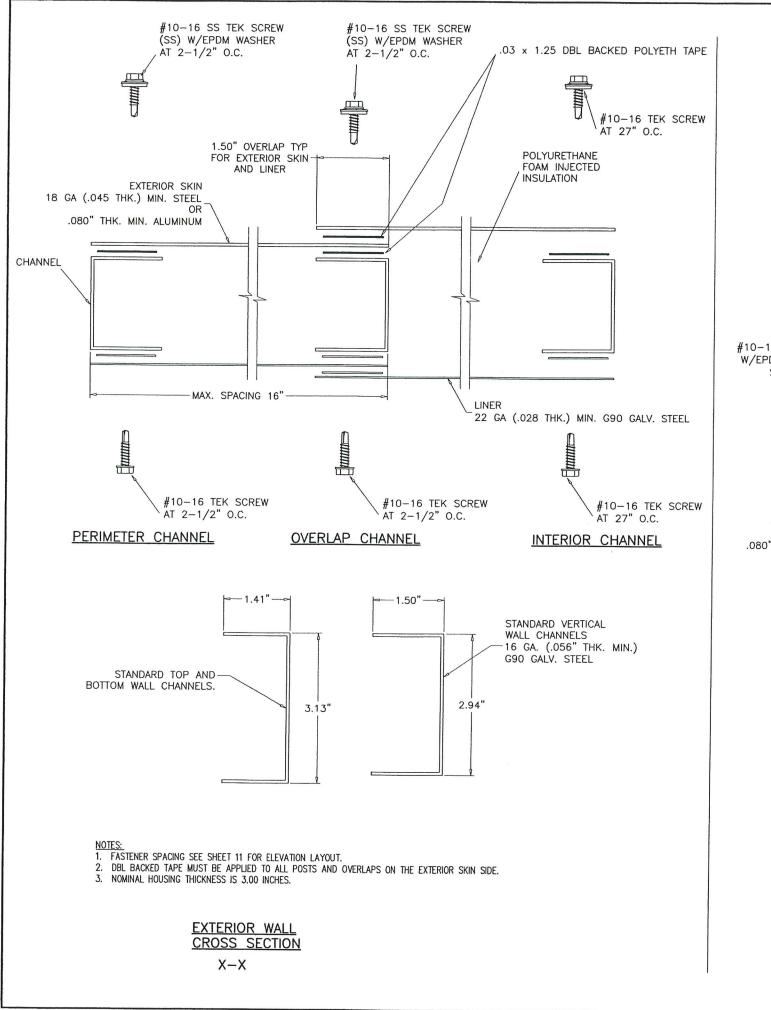

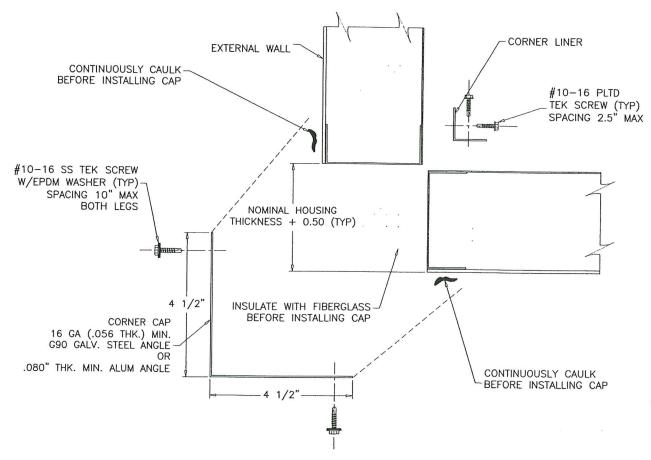

NOTES:

1. THIS DETAIL IS FOR ALL CORNERS.

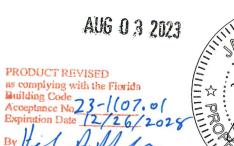

CENSE CONTROL STATE OF CORIDA CONTROL CONTROL

AL-FAROOQ CORPORATION
ENGINEERS & PRODUCT DEVELOPMENT
9360 SUNSET DRIVE, SUITE 220
MIAMI, FLORIDA 33173 (C.A.N. 3538)
TEL. (305) 264-8100 FAX. (305) 262-6978


YORK Custom (PACE & Miller-Picking) Air Handler Un YORK/JOHNSON CONTROLS INC. 1499 EAST PHILADELPHIA STREET YORK, PA. 17403 TEL. (717) 815-4198

drawing no. 12-06 sheet 10 of 19

ALL DIMENSIONS SHOWN ARE IN INCHES.

& LINER INSTALLATION

CORNER CAP

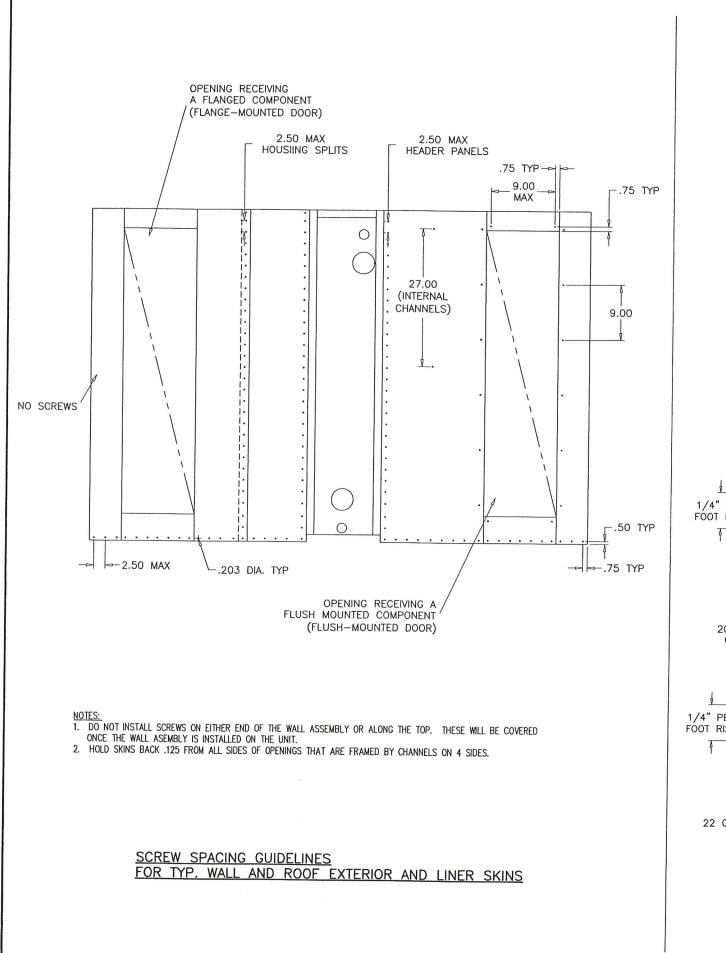


CONSTRUCTION

THE CONSTRUCTION OF THE OUTDOOR ROOF IS SIMILAR TO THE EXTERIOR WALL CONSTRUCTION WITH THE EXCEPTION THAT THE POST IS A SLOPED CHANNEL AND WILL BE REFERRED TO AS A TRUSS. REFER TO THE EXTERNAL WALL SECTION FOR GENERAL CONSTRUCTION DETAILS AND MATERIAL STANDARDS ACU-SHIELD SHOULD BE APPLIED AS A STANDARD. USE SAME GAGE EXTERIOR MATERIAL FOR THE ROOF THAT IS ON EXTERIOR OF THE WALL OF THE UNIT. USE G90 GALV. FOR ALL ROOF EXTERIORS GETTING COATED WITH ACU-SHIELD.

THE OUTDOOR ROOF WILL EITHER HAVE A SINGLE OR DOUBLE SLOPE WITH THE RISE BEING 1/4" PER FOOT (SEE DETAILS BELOW). SLOPE DIRECTION WILL BE INDICATED ON THE SUBMITTAL DRAWING. IF A SINGLE SLOPED ROOF IS REQUIRED, PITCH WILL TYPICALLY BE AWAY FROM THE ACCESS SIDE OF THE UNIT.

IF AN SQ IS GENERATED REQUIRING R14 MIN INSULATION, DETAILING WILL BE RESPONSIBLE FOR MAKING THE NECESSARY CHANGES TO THE PRODUCTION DRAWINGS TO MEET THIS REQUIREMENT AS SHOWN BELOW.

ROOF SECTIONS ARE ONLY TO BE SPLIT DOWN THE LENGTH OF THE SERVICE CORRIDOR WHEN A SHIPPING SPLIT IS REQUIRED. THE STANDARD DESIGN FOR DOUBLE SLOPED ROOFS WILL BE WITH THE RIDGE FALLING ON THE CENTER UNE OF THE UNIT. EXCEPTION TO STANDARD DESIGN: ALL UNITS WITH A SHIPPING SPLIT AT THE CORRIDOR WALL THAT REQUIRE A DOUBLE SLOPE ROOF MUST HAVE THE ROOF PEAK LOCATED AT THE CORRIDOR WALL. SEE DRAWINGS IN THIS SECTION FOR HOW THIS IS ACCOMPLISHED.

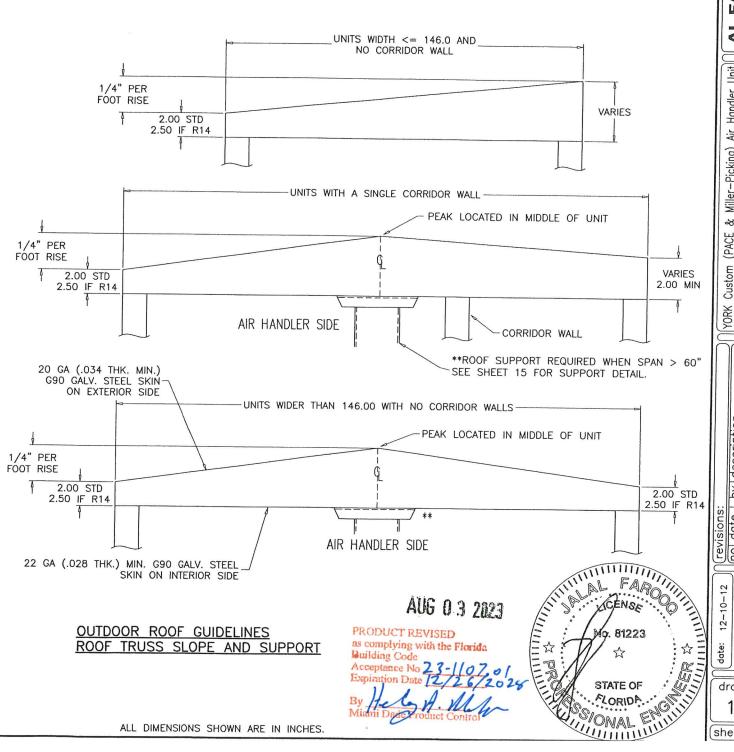

AL-FAROOQ CORPORATION
ENGINEERS & PRODUCT DEVELOPMENT
9360 SUNSET DRIVE, SUITE 220
MIAMI, FLORIDA 33173 (C.A.N. 3538)
TEL. (305) 264-8100 FAX. (305) 262-6978


Miller-Picking) Air Handler

YORK/JOHNSON CONTROLS INC. 1499 EAST PHILADELPHIA STREET YORK, PA. 17403
TEL. (717) 815-4218 FAX. (717) 815-4 ઝ (PACE Custom YORK

SERIE NO C EDITOR NO C

drawing


12 - 06sheet 11 of 19

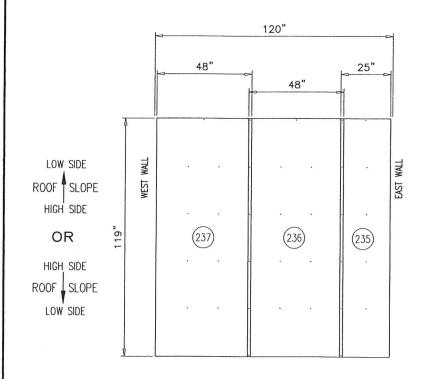

ROOF LINERS (VIEWED FROM LINER SIDE)


\$ AIR FLOW \$

- 1. LINERS HELD BACK .125 FROM ALL OPENINGS FRAMED BY 4 CHANNELS.
- 2. HEADER/FOOTER PIECES AT OPENINGS PLACED UNDER FULL LENGTH PIECES.
- 3. STANDARD INTERIOR LINER OVERLAP IS 1.50".

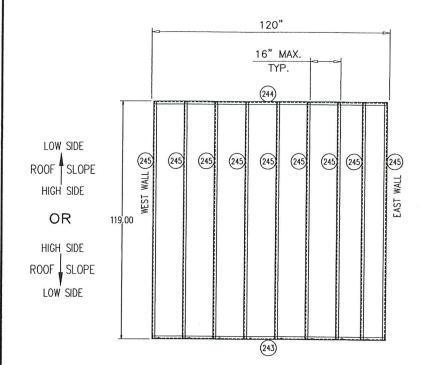

ROOF CHANNELS (VIEWED FROM LINER SIDE)

AIR FLOW

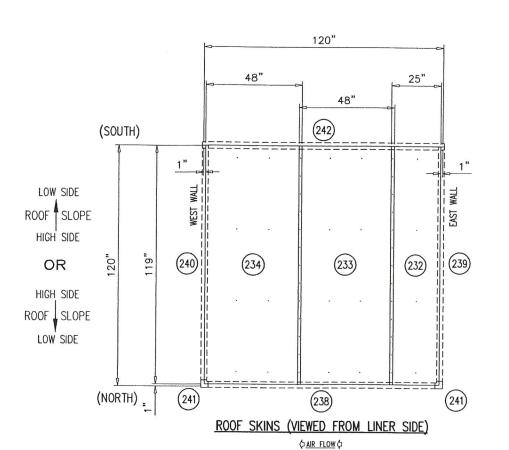

1. SKINS HELD BACK .125 FROM ALL OPENINGS FRAMED BY 4 CHANNELS.

3. STANDARD EXTERIOR SKIN OVERLAP IS 1.50".

2. HEADER/FOOTER PIECES AT OPENINGS PLACED UNDER FULL LENGTH PIECES.

LEVEL ITEM *=Stocked SHEET/REF. ONE SORT FIELD DESCRIPTION ROOF ASSEMBLY: 120.00 X 120.00 4.03 40CF -10% OFFAL - OCT #3XM MIX, PART A,B, & FREON 1 C:ANGLED-COVER 3.25W X 121.50L X SHEET,GLV,G90,20GA 40CF 25.00W X 119.00L X SHEET,GLV,G90,20GA 48.00W X 119.00L X SHEET,GLV,G90,20GA C: EXT-SKIN-0 48.00W X 119.00L X SHEET, GLV, G90, 20GA 1 1 1 1 1 1 10.70W X 117.00L X SHEET, GLV, G90, 16GA 24.94W X 118.94L X SHEET,GLV,G90,22GA 47.97W X 118.94L X SHEET,GLV,G90,22GA C: INT-LINER-O C:INT-LINER-0 47.97W X 118.94L X SHEET,GLV,G90,22GA 239 C: LH6.25X3.75 10.70W X 117.00L X SHEET,GLV,G90,16GA 1 2 9 1 1 8.20W X 113.94L X SHEET,GLV,G90,16GA C:ROOF-CNR-CAP 9.90W X 8.33L X SHEET,GLV,G90,16GA C:RT5.69X3.19 8.49W X 118.75L X SHEET,GLV,G90,16GA C:SC1.50X3.38-0 6.18W X 118.00L X SHEET,GLV,G90,16GA 244 246 C: SC1.50X5.88-0 8.68W X 118.00L X SHEET,GLV,G90,16GA 9.90Z 0.67GL 222 52 013 03317 050 9.90Z CAULK 013 01412 010 0.67GL COATING CAULK, AL_GRAY, SIKAFLEX_221 COATING, ACU-SHIELD, WHITE 021 30531 011 222 SCREW SCREW, TEK, 410SS, EPDM, 10-16_.75 251 * 021 30530 001 52 SCREW 253 * 091 20014 001 12 SUPER ANGLE SCREW, TEK, PLTD, 10-16_.75 YC86-033 12 2677IN 243IN ANGLE, WALL_TO_ROOF, GLV

TAPE, POLYETH, DBL, .03W_1.25THK

TAPE, BUTYL, 1.25W_.13THK

247 | 028 14900 010 2677IN TAPE

248 028 07417 010 243IN TAPE

AUG 0 3 2023

PRODUCT REVISED as complying with the Florida

HO 81223

STATE OF CORIDA

CONAL ENTITY

CON

	1	1		_	1 -	_	
		by					
	revisions:	date	06.09.16	09.19.18	05.20.21	н 08.02.23	
	1	no	ш	ы	ပ	I	
i							
	date: 12-10-12		scale: -		dr. by: TARIQ)(cnk. by:
· 1/11-/	_						
(1/2 P)	d	ra	wir	ng		no	
27	1	4	\sim		\sim	_	

AL-FAROOQ CORPORATION
ENGINEERS & PRODUCT DEVELOPMENT
9360 SUNSET DRIVE, SUITE 220
MIAMI, FLORIDA 33173 (C.A.N. 3538)
TEL. (305) 264-8100 FAX. (305) 262-6978
COOLER | 12 Unit


U

YORK/JOHNSON CONTROLS INC. 1499 EAST PHILADELPHIA STREET YORK, PA. 17403
TEL. (717) 815-4218 FAX. (717) 815-4

YORK Custom (PACE & Miller—Picking) Air Handler

12-06

sheet 11.1of19

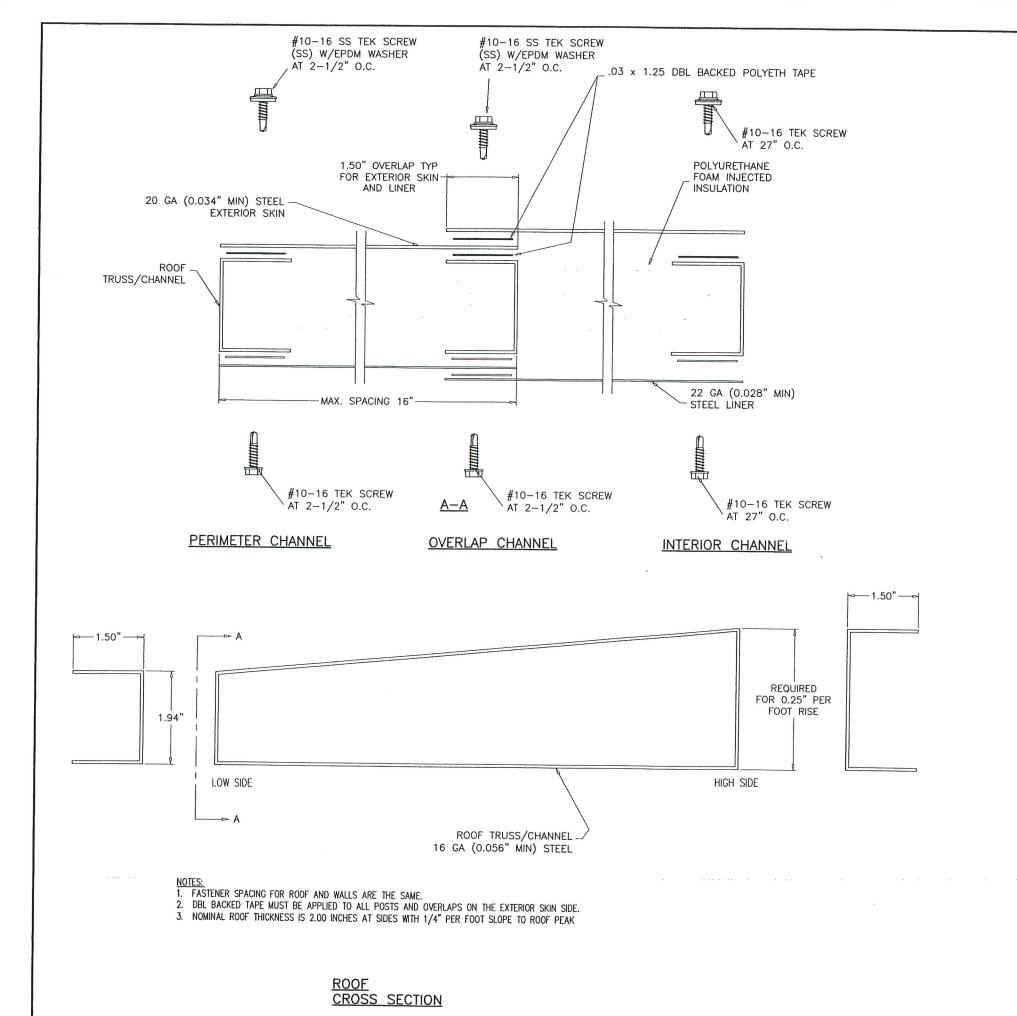

YORK Custom (PACE & Miller-Picking) Air Handler Uni YORK/JOHNSON CONTROLS INC. 1499 EAST PHILADELPHIA STREET YORK, PA. 17403 TEL. (717) 815-4218 FAX. (717) 815-4198 STATE OF STA drawing no. 12 - 06(sheet 11.2 of 19)


AL-FAROOQ CORPORATION
ENGINEERS & PRODUCT DEVELOPMENT
9360 SUNSET DRIVE, SUITE 220
MIAMI, FLORIDA 33173 (C.A.N. 3538)
TEL. (305) 2648100 FAX. (305) 262-6978


AUG 0 3 2023

PRODUCT REVISED
as complying with the Florida
Building Code
Acceptance No 23 - 107. 01
Expiration Date 12/26/2029

Expiration Date 12/26/202

By He Hold Miami Description Control

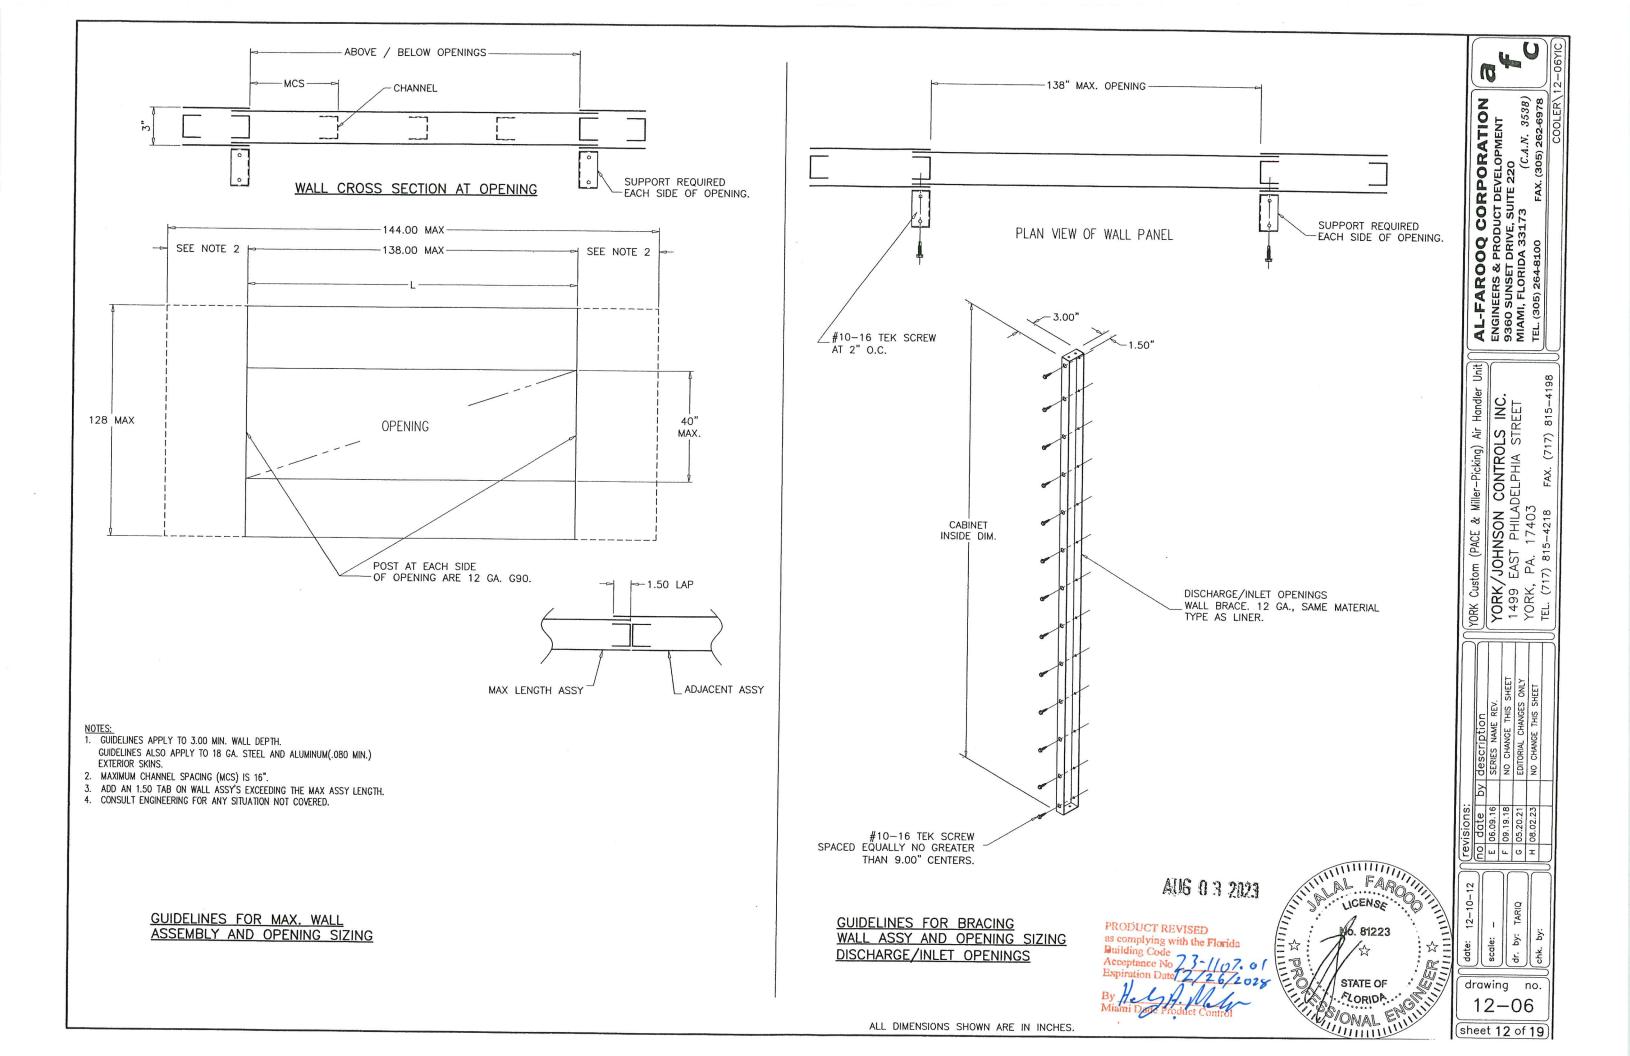

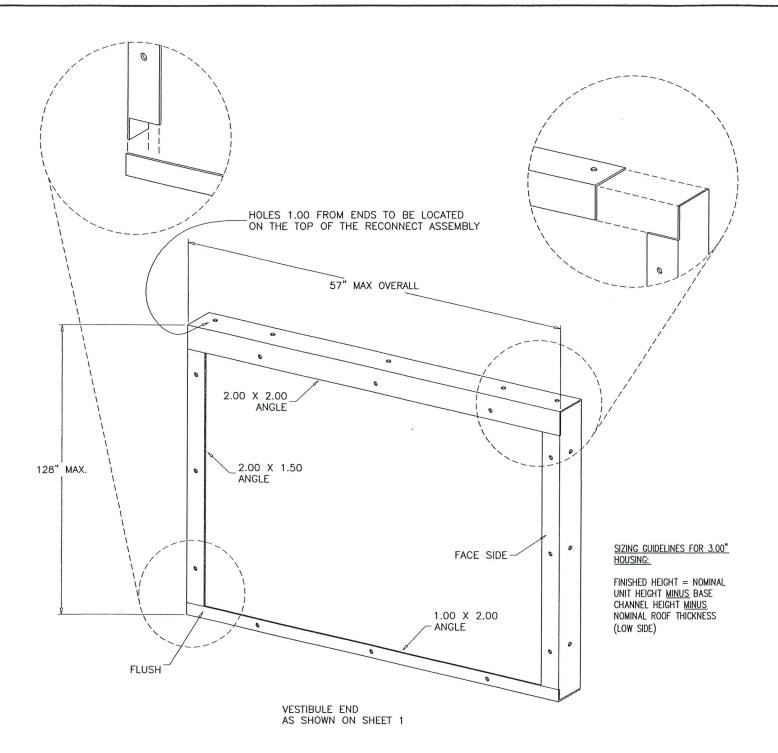

NOTES:

- 1. WELD INTO ASSY. WHERE APPLICABLE, ALL WELDS ARE CONTINUOUS 0.18" FILLET TYPE. DO NOT WELD ON THE FACE SIDE UNDER ANY CIRCUMSTANCES. IF SPLIT ASSY, BUTT WELD ON INSIDE OF ANGLE.
- THERE MAY BE TIMES WHEN COMPONENTS MAY INTERFERE WITH THE INTERIOR SUPPORT(S). THIS WOULD TYPICALLY
 HAPPEN AT FAN DISCHARGE/INTAKE WALLS AND WHEN FILTERS ARE LOADED ACROSS A SPLIT. IN THESE SITUATIONS,
 THE DETAILER IS RESPONSIBLE FOR PROVIDING THE SHOP A LAYOUT SPECIFYING THE LOCATION OF THE SUPPORT(S).
- 3. THE STANDARD MATERIAL TYPE IS 12 GA G90.

4. PART LENGTH = FINISHED ASSY HEIGHT - 0.25".


INTERNAL RECONNECT ASSEMBLY FOR AIRWAY WIDTHS AND CORRIDOR UNIT LENGTHS

AUS 0 3 2023

PRODUCT REVISED
as complying with the Florida
Building Code
Acceptance No 3-//02

Expiration Date 12/26/2e

By He A Miami Dada roduct Control

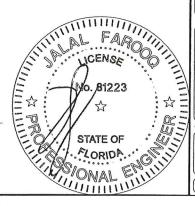

 AL-FAROOQ CORPORATION

 ENGINEERS & PRODUCT DEVELOPMENT

 9360 SUNSET DRIVE, SUITE 220


 MIAMI, FLORIDA 33173
 (C.A.N. 3538)

 TEL. (305) 264-8100
 FAX. (305) 262-6978

YORK Custom (PACE & Miller-Picking) Air Handler Un
YORK/JOHNSON CONTROLS INC.
1499 EAST PHILADELPHIA STREET
YORK, PA. 17403
TEL. (717) 815–4218 FAX. (717) 815–4198

drawing no.

sheet 13 of 19

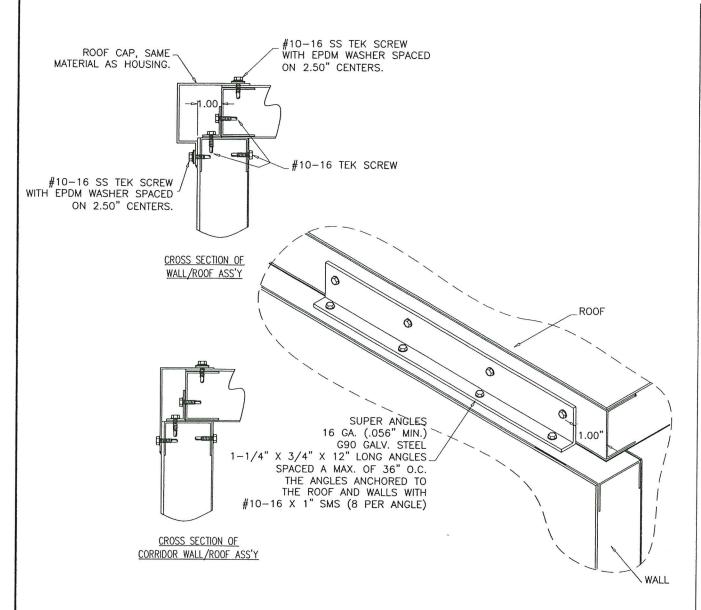





- NOTES:

 1. THE PURPOSE OF THE ANGLE IS TWO-FOLD. TO LIMIT LATERAL MOVEMENT OF THE WALL WHEN UNDER PRESSURE AND TO
- 2. ROOF SIDES REQUIRE ANGLES ON 36" MAX. CENTERS.
- 3. ANGLES ARE REQUIRED AT EVERY COIL PANEL, HOUSING SPLIT(1" FROM SPLIT ON EACH SIDE OF SPLIT), AND 6" FILTER DOOR


WALL TO ROOF ATTACHMENT GUIDELINES

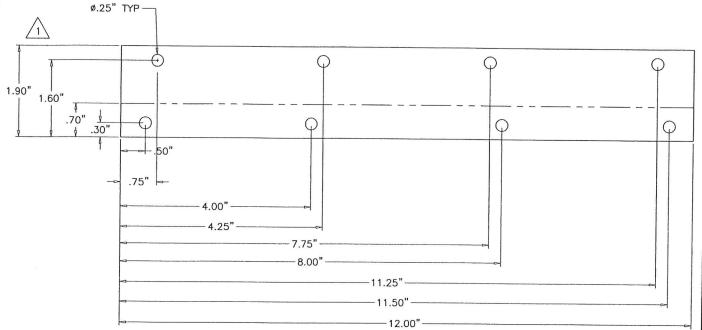

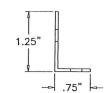

WALL TO ROOF ATTACHMENT ANGLE AUG 0 3 2023

PRODUCT REVISED as complying with the Florida

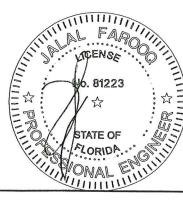

	revisio	dat	06.09	09.19	05.20	08.02	
		no n	ш	L.	ပ	I	L
	date: 12-10-12		scale: -		dr. by: TARIQ	11.	CUK. DV:
3/	dr	a	wir	ng		no	


AL-FAROOQ CORPORATION
ENGINEERS & PRODUCT DEVELOPMENT
9360 SUNSET DRIVE, SUITE 220
MIAMI, FLORIDA 33173 (C.A.N. 3538)
TEL. (305) 264-8100 FAX. (305) 262-6978


YORK Custom (PACE & Miller-Picking) Air Handler
YORK/JOHNSON CONTROLS INC.
1499 EAST PHILADELPHIA STREET
YORK, PA. 17403
TEL. (717) 815-4218 FAX. (717) 815-419

& Miller-Picking) Air Handler

12-06

sheet 14 of 19

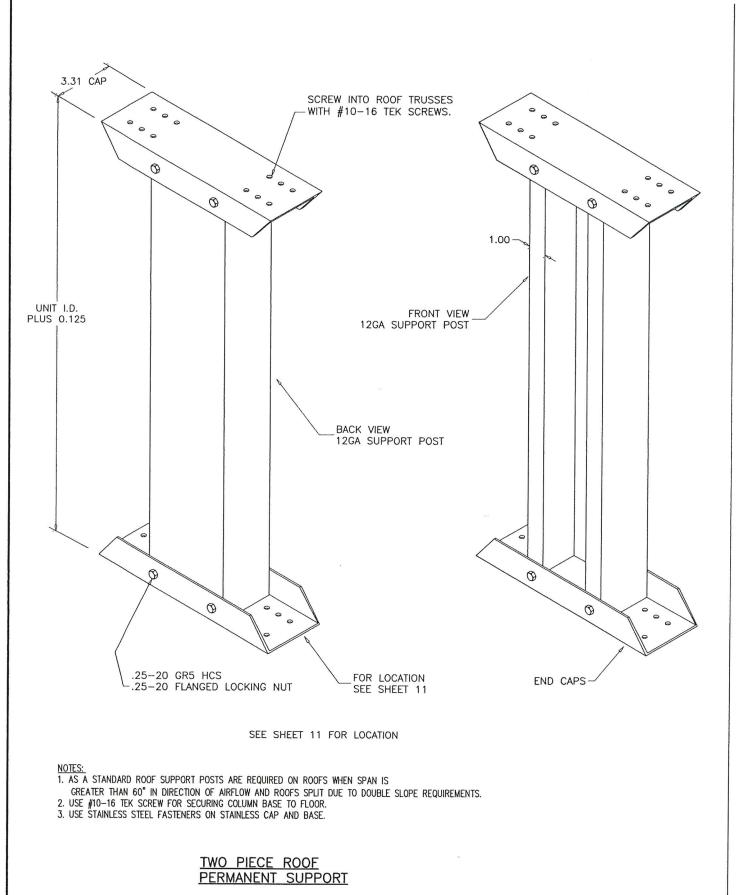

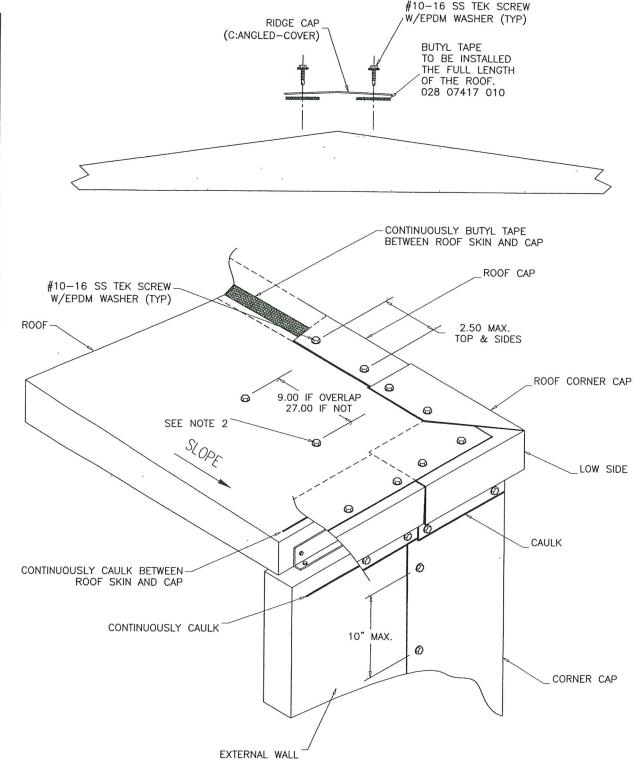

1. ALL LAP JOINTS MUST HAVE CAULK BETWEEN THE LAP. SURFACE CAULKING ONLY IS NOT ACCEPTABLE.
2. UNIT ASSEMBLY TO INSTALL SCREWS INTENTIONALLY LEFT OUT BY ROOF BUILDERS
3. HIGH SIDE INSTALLATION IS THE SAME AS ON INDOOR ROOFS.

OUTDOOR UNIT ROOF CAP INSTALLATION

PRODUCT REVISED as complying with the Florida

AUG 0 3 2023

date:	date: 12-10-12	e)	revisions:		
		2	no date	λq	by description
scale:	1	ш	E 06.09.16		SERIES NAME
		ഥ	F 09.19.18		NO CHANGE TH
dr. by: TARIQ	TARIQ	ပ	G 05.20.21		EDITORIAL CHAN
		I	н 08.02.23		NO CHANGE THI
crik. by:					

AL-FAROOQ CORPORATION
ENGINEERS & PRODUCT DEVELOPMENT
9360 SUNSET DRIVE, SUITE 220
MIAMI, FLORIDA 33173 (C.A.N. 3538)
TEL. (305) 264-8100 FAX. (305) 262-6978

Unit

Picking) Air Handler

ઝ


YORK/JOHNSON CONTROLS INC. 1499 EAST PHILADELPHIA STREET YORK, PA. 17403
TEL. (717) 815-4218 FAX. (717) 815-4

815-

(717)


drawing no. 12 - 06

sheet 15 of 19

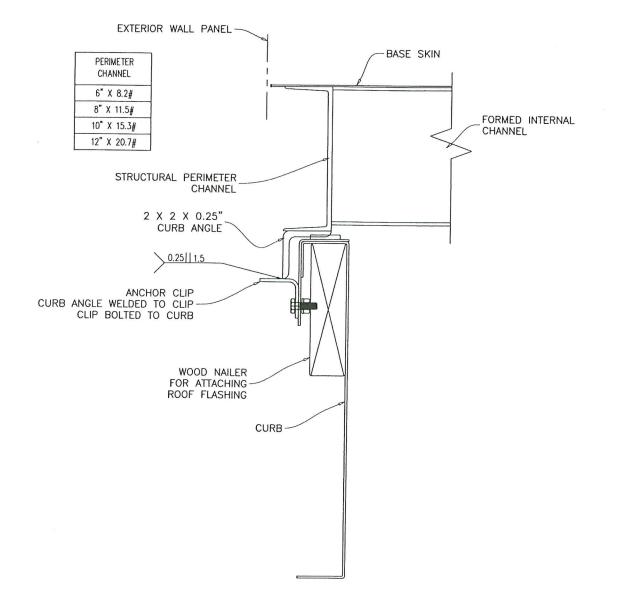

ROOF CURB HOLD DOWN DETAIL


SHALL BE DESIGNED FOR EACH SITE SPECIFIC BY A FLORIDA P.E. AND REVIEWED BY THE CORRESPONDING BUILDING DEPARTMENT.

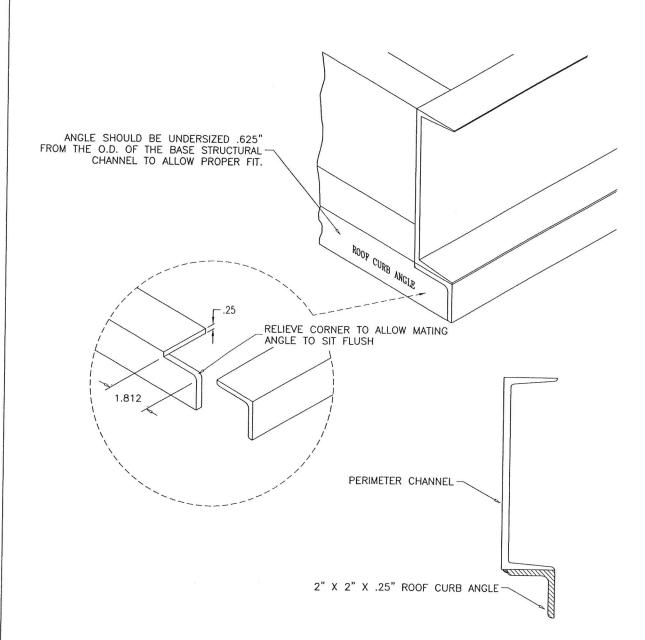

ROOF CURB ANGLE MOUNTING GUIDELINES AT BASE

AUG 0 3 2023

PRODUCT REVISED as complying with the Florida

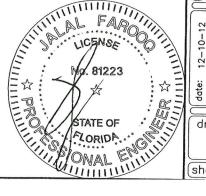



OVODY CONTRACTOR OF TOTAL MINISTER CONTRACTOR OF THE CONTRACTOR OF		YORK / JOHNSON CONTROL / NOSK	1400 TABLE BUILTING CONTROLS INC.	1488 EAST PHILADELPHIA STREET	YOKK, PA. 17403	TEL. (717) 815-4218 FAX. (717) 815-4198	
	e by description	SERIES NAME REV.	NO CHANGE THIS SHEET	EDITORIAL CHANGES ONLY	NO CHANGE THIS SHEET		
JS:	P	16	18	21	23		

AL-FAROOQ CORPORATION
ENGINEERS & PRODUCT DEVELOPMENT
9360 SUNSET DRIVE, SUITE 220
MIAMI, FLORIDA 33173 (C.A.N. 3538)
TEL. (305) 264-8100 FAX. (305) 262-6978

drawing no. 12 - 06

sheet 16 of 19

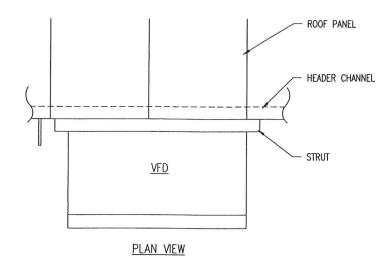

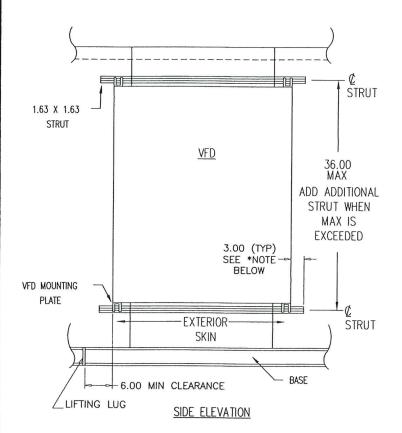

*OVERHANG TO BE MAINTAINED IF POSSIBLE ON NEMA 1 BOXES. *OVERHANG MUST BE MET OR EXCEEDED WHEN BOX IS NEMA 3R

SEE NOTE# 7


SURFACE MOUNT VFD MOUNTING DETAILS


DETAILING NOTES: 1. STRUTS FOR VFD'S WEIGHING MORE THAN 250Ibs WILL BE MOUNTED WITH #12-16 TEK SCREW. DETERMINE FASTENER QTY PER STRUT USING THE FOLLOWING FORMULA: ROUND UP (WEIGHT OF PANEL DIVIDED BY 40), ADDITIONAL CHANNELS ADDED IN WALL PANEL BEHIND VFD'S.

2. STRUTS FOR VFD'S WEIGHING LESS THAN 250lbs WILL BE MOUNTED WITH #10-16 TEK SCREW. DETERMINE FASTENER QTY PER STRUT USING THE FOLLOWING FORMULA: ROUND UP (WEIGHT OF PANEL DIVIDED BY 30)

ASSEMBLY NOTES:

- 1. ELECTRIC DEPT. TO DRILL .313" DIAMETER HOLES IN THE UNISTRUT TO MATCH THE ABOVE SPACING FOR 250lbs AND OVER VFD'S.
- 2. CAULK PANEL SEAMS THAT WILL BE COVERED BY STRUT AND POWER PANEL.
- 3. ADD .13 X .75 GASKET TAPE TO BACK SIDE OF BOTH UPPER AND LOWER STRUTS, GASKET TAPE SHOULD BE CENTERED ON HOLE AND RUN THE FULL LENGTH OF THE STRUT.
- 4. FOR VFD'S 250lbs AND OVER, SCREW UPPER AND LOWER STRUTS TO WALL WITH #12-16 TEK SCREWS. FOR VFD UNDER 250lbs SCREW UPPER AND LOWER STRUT TO EXTERIOR USING #12-16 TEK SCREW.
- 5. DRILL TWO .4375 INCH DIAMETER HOLES FOR EACH PIECE OF STRUT IN THE BACK OF PANEL TO MATCH STRUTS LOCATIONS.
- 6. BOLT POWER PANEL/CONTROL PANEL TO STRUT USING .38 ELECTRIC SPRINGS NUTS AND .38 X 1.0 NC GRADE 2 HCS.
- 7. CAULKING STRUT IS NOT REQUIRED, BUT DRIVE SCREW HEADS SHOULD BE CAULKED ON OUTDOOR UNITS.

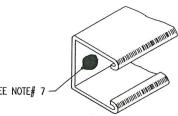

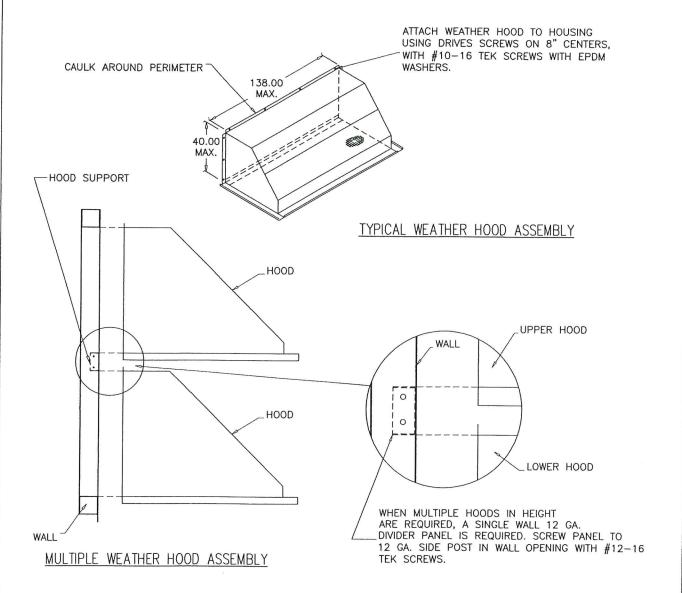

40" MAX. HOOD HEIGHT WHEN SINGLE HOOD IS USED LIMIT MAX. HEIGHT TO 20" WHEN MULTIPLE HOODS ARE USED.

SIZING GUIDELINES:

- 1. 60' WEATHER HOODS ARE AVAILABLE IN ANY HEIGHT FROM 12.00 INCHES TO 45.00 INCHES. ONLY BY SQ.
- 2. 90° WEATHER HOODS ARE AVAILABLE IN HEIGHTS UP TO 40".
- 3. WEATHER HOODS ARE AVAILABLE IN WHOLE NUMBER WIDTHS FROM 16.00 INCHES TO 138.00 INCHES.

MATERIAL:

1. STANDARD WEATHER HOOD MATERIAL IS 16GA PRE-PAINTED.

WEATHER HOOD SIZING & CONSTRUCTION GUIDELINES AUG 1 3 2023

PRODUCT REVISED as complying with the Florida



YORK Chetom (DACE & Willer District All and al	TOTAL SESSION (1 ACE & MINISH - FICKING) AN HONOIGE	YORK / JOHNSON CONTROL & INC	1400 FAST DELL AND DIES CHARTE	NOBY DE 13:03	10KK, FA. 1/40S	TEL. (717) 815-4218 FAX. (717) 815-419
	no date by description	E 06.09.16 SERIES NAME REV.	F 09.19.18 NO CHANGE THIS SHEET	G 05.20.21 EDITORIAL CHANGES ONLY	H 08.02.23 NO CHANGE THIS SHEET	


AL-FAROOQ CORPORATION
ENGINEERS & PRODUCT DEVELOPMENT
9360 SUNSET DRIVE, SUITE 220
MIAMI, FLORIDA 33173 (C.A.N. 3538)
TEL. (305) 264-8100 FAX. (305) 262-6978

Unit

dr. drawing 12 - 06

(sheet 17 of 19)


by:

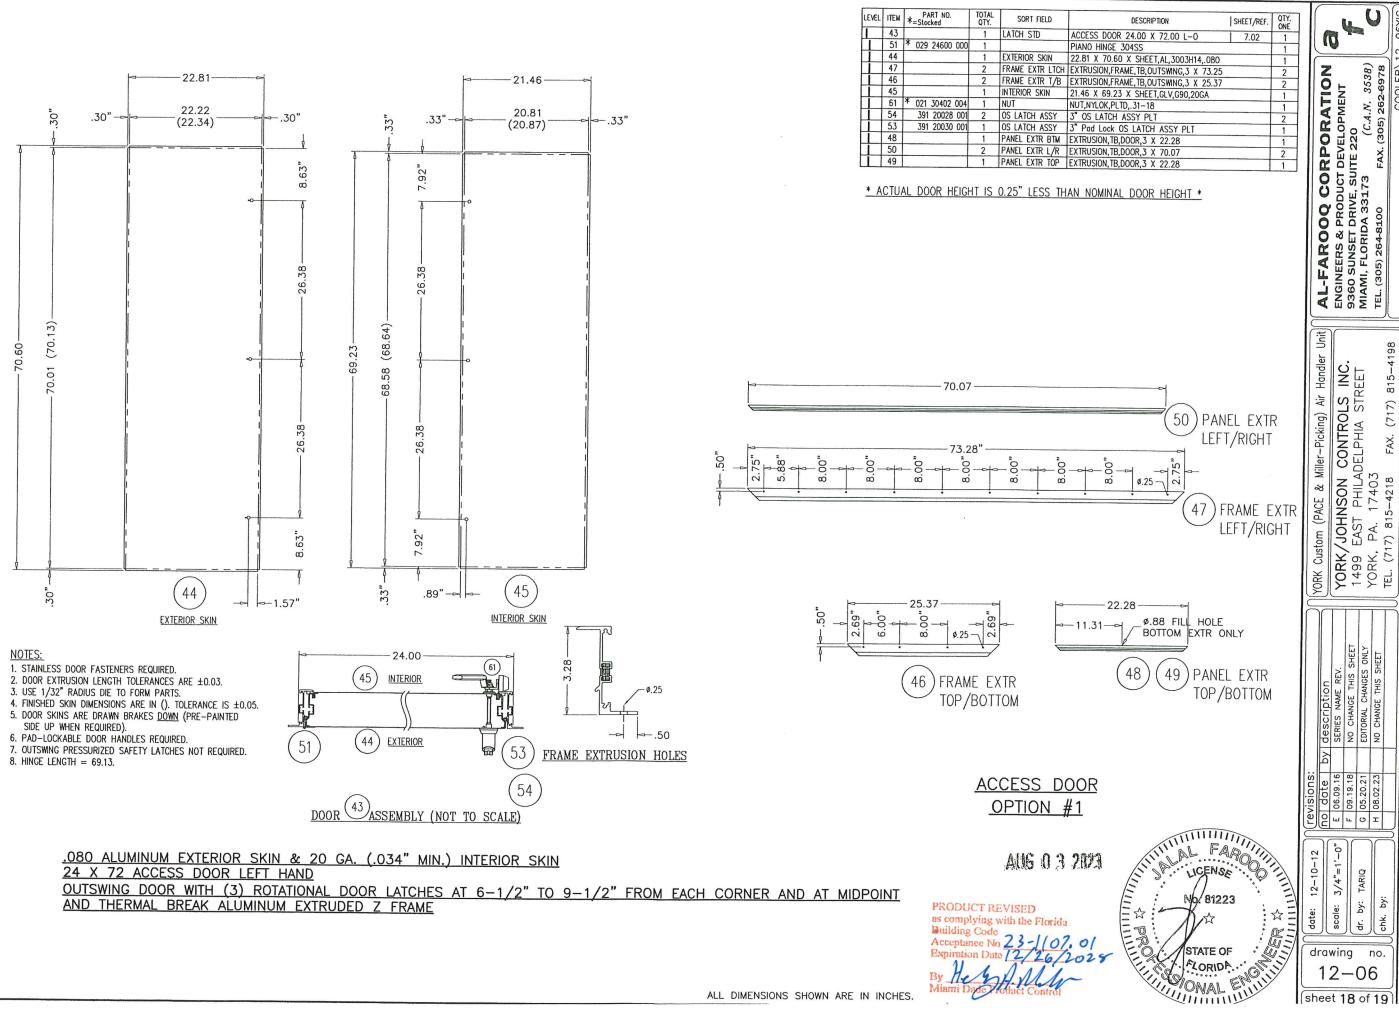


ALL DIMENSIONS SHOWN ARE IN INCHES.

drawing no.


(sheet 18 of 19)

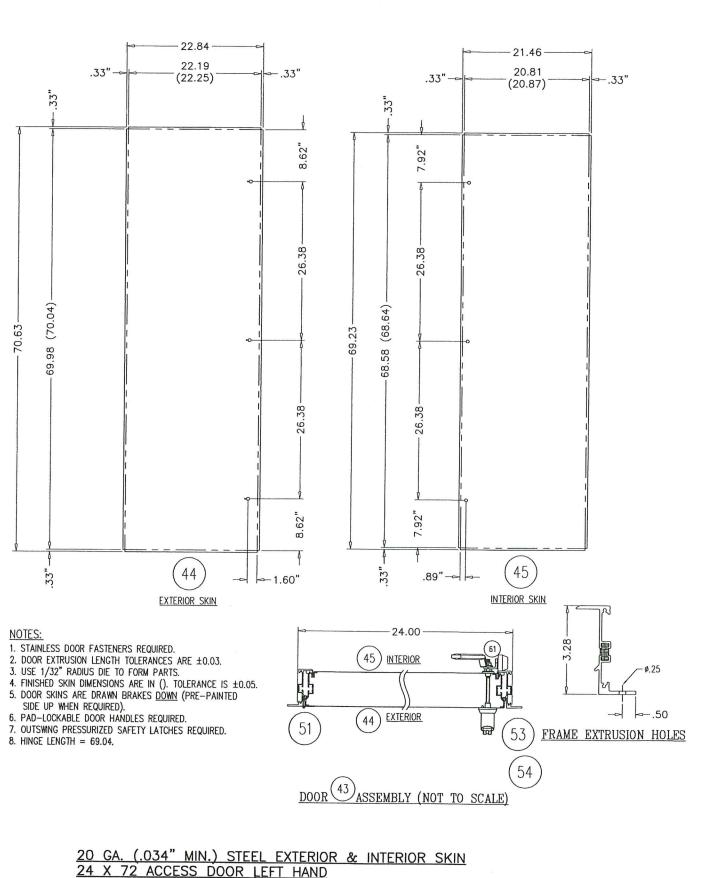


OUTSWING DOOR WITH (3) ROTATIONAL DOOR LATCHES AT 6-1/2" TO 9-1/2" FROM EACH CORNER AND AT MIDPOINT AND THERMAL BREAK ALUMINUM EXTRUDED Z FRAME

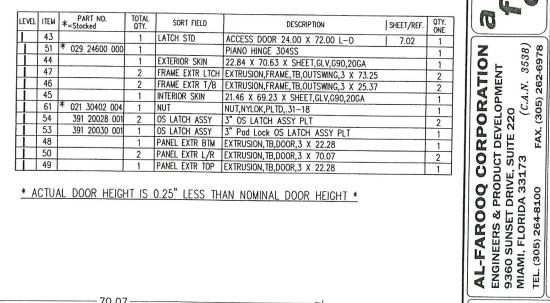

* ACTUAL DOOR HEIGHT IS 0.25" LESS THAN NOMINAL DOOR HEIGHT *

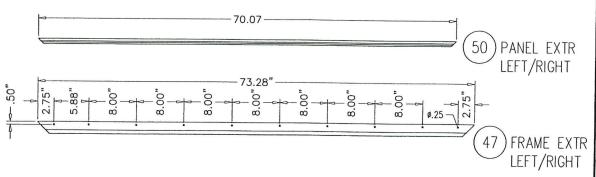

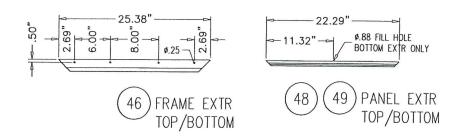

ACCESS DOOR OPTION #2

AUG 0 3 2023

PRODUCT REVISED as complying with the Florida

-		مَ					
	revisions:	date	06.09.16	09.19.18	G 05.20.21	08.02.23	
	<u>e</u>	no	ш	L	ပ	I	
	\subseteq	5	_	5	_	_	_
	12-10-12		scale: 3/4"=1'-0"		dr. by: TARIQ		
3 = 3	date:		scale:		dr. by:	140	CIIN. US.
3/	di	ra	wir	ng		no	

U

YORK/JOHNSON CONTROLS INC. 1499 EAST PHILADELPHIA STREET YORK, PA. 17403 TEL. (717) 815-4218 FAX. (717) 815-419

YORK Custom (PACE & Miller—Picking) Air Handler

12 - 06sheet 19 of 19

