

DEPARTMENT OF REGULATORY AND ECONOMIC RESOURCES (RER) BOARD AND CODE ADMINISTRATION DIVISION

NOTICE OF ACCEPTANCE (NOA)

MIAMI-DADE COUNTY PRODUCT CONTROL SECTION

11805 SW 26 Street, Room 208 Miami, Florida 33175-2474 T (786) 315-2590 F (786) 315-2599

www.miamidade.gov/building

Allegion Access Technologies, LLC 65 Scott Swamp Road Farmington, CT 06032

SCOPE:

This NOA is being issued under the applicable rules and regulations governing the use of construction materials. The documentation submitted has been reviewed and accepted by Miami-Dade County RER -Product Control Section to be used in Miami Dade County and other areas where allowed by the Authority Having Jurisdiction (AHJ).

This NOA shall not be valid after the expiration date stated below. The Miami-Dade County Product Control Section (In Miami Dade County) and/or the AHJ (in areas other than Miami Dade County) reserve the right to have this product or material tested for quality assurance purposes. If this product or material fails to perform in the accepted manner, the manufacturer will incur the expense of such testing and the AHJ may immediately revoke, modify, or suspend the use of such product or material within their jurisdiction. RER reserves the right to revoke this acceptance, if it is determined by Miami-Dade County Product Control Section that this product or material fails to meet the requirements of the applicable building code.

This product is approved as described herein and has been designed to comply with the Florida Building Code, including the High Velocity Hurricane Zone.

DESCRIPTION: Series "Dura Storm" Aluminum Automatic Sliding Glass Door: O-Sx-Sx-O, Sx-O w/ wo Transom, So-Sx-Sx-So and Sx-So w/wo Transom & Breakout –NI

APPROVAL DOCUMENT: Drawing No. **23-67902** (former **20-33204**), titled "Dura-Storm 2000/3000 Auto SGD Bi-Parting /Single Slide-NI", sheets 1 through 19 of 19, prepared by Engineering Express, dated January 09, 2024, signed and sealed by Frank L. Bennardo, P.E., bearing the Miami-Dade County Product Control Revision stamp with the Notice of Acceptance number and expiration date by the Miami-Dade County Product Control Section.

MISSILE IMPACT RATING: None. Approved Hurricane Protection devices are required per FBC, as applicable.

LIMITATIONS:

- 1. See elevation for anchors requirements in sheets 1, 2 & 3 and Header clusters details in sheet 7 and Threshold clusters in sheet 12. The 1/4" Power Tapper anchors at head/Jamb & Sill to be in min 3 Ksi concrete. See sheets 4, 5 & 6 for concealed 3-point locking (active panel) & 2-point (in-active). Also see applicable 2-point G-86 CVR panic devices (active/inactive panels) for series 3000 in sheets 5 & 6 to be used w/ Horizontal muntin bars (detail V, sheet 15) and DLO height not to exceed 36-3/4" max.
- 2. See details 1A/8, 3A/9 & 5A/10 for Transom nested reinforcements item #101 for Bi-Parting series 2000 (O-Sx-Sx-O) and series 3000 (So-Sx-Sx-So). The Single Slide O-Sx and So-Sx require light reinforcement item #73.
- 3. Electrical devices, functions and installation is not part of this approval and to be reviewed and approved by Authority Having Jurisdiction (AHJ)
- 4. See Door panel and Transom glazing details in sheets **16** & **18**. Fixed glass more than 36" wide must be supported with approved setting blocks per FBC requirements.
- 5. Not approved where water infiltration is required.

MIAMI-DADE COUNTY
APPROVED

Ishaq I. Chands

NOA No. 23-1127.02 Expiration Date: April 11, 2028 Approval Date: February 08, 2024

Page 1 of 2



DEPARTMENT OF REGULATORY AND ECONOMIC RESOURCES (RER) BOARD AND CODE ADMINISTRATION DIVISION

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MIAMI-DADE COUNTY

Stanley Access Technologies, LLC 65 Scott Swamp Road Farmington, CT 06032

LABELING: Each unit shall bear a permanent label with the manufacturer's name or logo, city, state and series and following statement: "Miami-Dade County Product Control Approved", unless otherwise noted herein.

RENEWAL of this NOA shall be considered after a renewal application has been filed and there has been no change in the applicable building code negatively affecting the performance of this product

TERMINATION of this NOA will occur after the expiration date or if there has been a revision or change in the materials, use, and/or manufacture of the product or process. Misuse of this NOA as an endorsement of any product, for sales, advertising or any other purposes shall automatically terminate this NOA. Failure to comply with any section of this NOA shall be cause for termination and removal of NOA.

ADVERTISEMENT: The NOA number preceded by the words Miami-Dade County, Florida, and followed by the expiration date may be displayed in advertising literature. If any portion of the NOA is displayed, then it shall be done in its entirety.

INSPECTION: A copy of this entire NOA shall be provided to the user by the manufacturer or its distributors and shall be available for inspection at the job site at the request of the Building Official.

This NOA revises # 22-0830.08 (former Stanley Access Technologies, LLC), consists of pages 1 and 2 as well as evidence pages E-1, E-2, E-3, E-4 and E-5.

The submitted documentation was reviewed by Ishaq I. Chanda, P.E.



Ishaq I. Chands

NOA No. 23-1127.02 Expiration Date: April 11, 2028 Approval Date: February 08, 2024

Page 2 of 2

NOTICE OF ACCEPTANCE: EVIDENCE SUBMITTED

1. EVIDENCE SUBMITTED UNDER PREVIOUS NOA'S

A. DRAWINGS

- 1. Manufacturer's die drawings and sections (submitted under files below)
- 2. Drawing No. **14-1854** (former **12-SAT-15**), titled "Dura-Storm 2000/3000 Bi-Parting /Single slide-NI", sheets 1 through 19 of 19, prepared by Engineering Express, dated 07-01-12 and last revised on 10/14/2014, signed and sealed by Frank L. Bennardo, P.E.
- **B.** TESTS (submitted under files # 13-0529.21/#12-0807.05)
 - 1. Test reports on: 1) Air Infiltration Test, per FBC, TAS 202-94
 - 2) Uniform Static Air Pressure Test, Loading per FBC TAS 202-94
 - 3) Water Resistance Test, per FBC, TAS 202-94 (Not conducted)
 - 4) Forced Entry Test, per FBC 2411 3.2.1, TAS 202-94

Along with installation diagram of aluminum automatic entrance doors Sx-So w/ G-86 CVR Panic and So-Sx-Sx-So w/ Transom & G-86 CVR Panic, prepared by Fenestration Testing Laboratory, Inc. Test Report No. FTL-7247, dated 03/08/13, signed and sealed by Marlin D. Brinson, P. E.

- 2. Test reports on: 1) Air Infiltration Test, per FBC, TAS 202-94
 - 2) Uniform Static Air Pressure Test, Loading per FBC TAS 202-94
 - 3) Water Resistance Test, per FBC, TAS 202-94 (Not conducted)
 - 4) Forced Entry Test, per FBC 2411 3.2.1, TAS 202-94

Along with installation diagram of aluminum automatic entrance doors, prepared by Fenestration Testing Laboratory, Inc. Test Report No. **FTL-6803**, dated 05/11/12 and last revised on 03/21/13, signed and sealed by Marlin D. Brinson, P. E.

Note: This test report has been revised by an addendum letter dated Nov 21, 2012 and April 03, 2013, issued by Fenestration Testing Lab, signed and sealed by Marlin D. Brinson, P. E. (submitted under file # **12-0807.05**)

C. CALCULATIONS

- 1. Anchor verification calculations and structural analysis, complying with FBC-2014 (5th Edition), prepared by Engineering Express, dated 05-13-15, signed and sealed by Frank L. Bennardo, P.E.
- 2. Glazing complies w/ ASTME-1300-02, -04 & -09.

D. QUALITY ASSURANCE

1. Miami Dade Department of Regulatory and Economic Resources (RER).

E. MATERIAL CERTIFICATIONS (submitted under file # 12-0807.05)

1. Technical strength data of Trelleborg EPDM per ASTM C864.

F. STATEMENTS

- 1. Statement letter of conformance to FBC 2014(5th Edition), prepared by Engineering Express, dated May 13, 2015, signed and sealed by Frank L. Bennardo, P.E.
- 2. Statement letter of no financial interest, prepared by Engineering Express, dated 08-02-12, signed and sealed by Frank L. Bennardo, P.E. (submitted under file # 12-0807.05)
- 3. Lab compliance as part of the above referenced test report.

Ishaq 1. Chands

Stanley Access Technologies, LLC

NOTICE OF ACCEPTANCE: EVIDENCE SUBMITTED

G. OTHER

- 1. This NOA revises NOA #13-0529.21, expiring 04/18/18.
- 2. Test proposals # 13-0006 dated 01/14/13 approved by RER and # 11-1016, dated NOV 11, 2011 approved by PERA.
- 3. Manufacture supplied Adam Rites deadbolt/hook & bolts mechanism & G-86 panic brochures.

2. EVIDENCE SUBMITTED UNDER PREVIOUS APPROVAL # 17-0828.09

A. DRAWINGS

1. Drawing No. **14-1854**, titled "Dura-Storm 2000/3000 Auto SGD Bi-Parting /Single Slide-NI", sheets 1 through 19 of 19, prepared by Engineering Express, dated 07/01/12 and last revised on 08/23/17, signed and sealed by Frank L. Bennardo, P.E.

B. TESTS

1. None.

C. CALCULATIONS

1. Anchor verification calculations and structural analysis, complying with **FBC** 6th **Edition (2017)**, prepared by manufacturer, dated 08/01/17, signed and sealed by Frank L. Bennardo, P.E.

D. QUALITY ASSURANCE

1. Miami Dade Department of Regulatory and Economic Resources (RER).

E. MATERIAL CERTIFICATIONS

1. None.

F. STATEMENTS

- 1. Statement letter of conformance to **FBC 6th Edition (2017)**, dated 07/31/17, prepared by Engineering Express, signed and sealed by Frank L. Bennardo, P.E.
- 2. Statement letter of no financial interest, prepared by Engineering Express, dated 07/28/17, signed and sealed by Frank L. Bennardo, P.E.

G. OTHER

1. This NOA revises NOA #15-0127.05, expiring on 04/11/2018.

Ishaq I. Chands

Ishaq I. Chanda, P.E. Product Control Unit Supervisor NOA No. 23-1127.02 Expiration Date: April 11, 2028

NOTICE OF ACCEPTANCE: EVIDENCE SUBMITTED

- 3. EVIDENCE SUBMITTED submitted under previous NOA(s)
- A. DRAWINGS
 - 1. None.
- B. TESTS
 - 1. None.
- C. CALCULATIONS
 - 1. None.
- D. QUALITY ASSURANCE
 - 1. Miami Dade Department of Regulatory and Economic Resources (RER).
- E. MATERIAL CERTIFICATIONS
 - 1. None.
- F. STATEMENTS
 - 1. None.
- G. OTHER
 - 1. This NOA **renews** NOA #**17-0828.09**, expiring on 04/11/2018.
- 4. EVIDENCE SUBMITTED submitted under previous NOA(s)
- A. DRAWINGS
 - 1. None.
- B. TESTS
 - 1. None.
- C. CALCULATIONS
 - 1. None.
- D. QUALITY ASSURANCE
 - 1. Miami Dade Department of Regulatory and Economic Resources (RER).
- E. MATERIAL CERTIFICATIONS
 - 1. None.
- F. STATEMENTS
 - 1. None.
- G. OTHER
 - 1. This NOA renews NOA #18-0221.09, expiring on 04/11/2023.

Ishaq 1. Chands

Ishaq I. Chanda, P.E.
Product Control Unit Supervisor
NOA No. 23-1127.02
Expiration Date: April 11, 2028
Approval Date: February 08, 2024

Allegion Access Technologies, LLC

NOTICE OF ACCEPTANCE: EVIDENCE SUBMITTED

5. **EVIDENCE SUBMITTED under previous approval**

DRAWINGS A.

1. Drawing No. 20-33204 (former 14-1854), titled "Dura-Storm 2000/3000 Auto SGD Bi-Parting /Single Slide-NI", sheets 1 through 19 of 19, prepared by Engineering Express, dated 08/23/17 and last revised on NOV 10, 2022, signed and sealed by Frank L. Bennardo, P.E.

В. **TESTS**

1. None.

C. **CALCULATIONS**

1. None.

D. **OUALITY ASSURANCE**

Miami Dade Department of Regulatory and Economic Resources (RER).

E. **MATERIAL CERTIFICATIONS**

1. Technical strength data of Trelleborg EPDM per ASTM C864.

F. **STATEMENTS**

- 1. Statement letter of conformance to FBC 2020 (7th Edition), prepared by Engineering Express, dated 11/10/2022, signed and sealed by Frank L. Bennardo, P.E.
- 2. Statement letter dated 11/10/22 requesting Renewal with no change and no changes have been made from previous approval, prepared by Engineering Express, dated 11/10/22, signed and sealed by Frank L. Bennardo, P.E.

G. **OTHER**

1. This NOA renews NOA #20-1216.25, expiring 04/11/28.

Allegion Access Technologies, LLC

NOTICE OF ACCEPTANCE: EVIDENCE SUBMITTED

6. New EVIDENCE SUBMITTED

A. DRAWINGS

1. Drawing No. **23-67902** (former **20-33204**), titled "Dura-Storm 2000/3000 Auto SGD Bi-Parting /Single Slide-NI", sheets 1 through 19 of 19, prepared by Engineering Express, dated January 09, 2024, signed and sealed by Frank L. Bennardo, P.E.

B. TESTS

1. None.

C. CALCULATIONS

1. None.

D. QUALITY ASSURANCE

1. Miami Dade Department of Regulatory and Economic Resources (RER).

E. MATERIAL CERTIFICATIONS

1. Technical strength data of Trelleborg EPDM per ASTM C864.


F. STATEMENTS (items #3 and #4 submitted under previous NOA)

- 1. Statement letter of conformance to FBC 2023 (8th Edition), prepared by Engineering Express, dated November 14, 2023, signed and sealed by Frank L. Bennardo, P.E.
- 2. Statement letter of conformance to FBC 2020 (7th Edition), prepared by Engineering Express, dated FEB 10, 2023, signed and sealed by Frank L. Bennardo, P.E.
- 3. Certificate of Amendment issued by State of Delaware dated September 01, 2022, Stanley Access Technologies, LLC, changed its name to Allegion Access Technologies, LLC signed by Jeffery W. Bullocks, Secretary of State, State of Delaware.
- 4. Certificate of Formation, issued by State of Delaware, dated September 01, 2022, amended **Stanley Access Technologies**, **LLC**, to **Allegion Access Technologies**, **LLC**, signed by Jeffrey W. Bullock, Secretary of State, State of Delaware

G. OTHER

1. This NOA revises # 22-0830.08 (former Stanley Access Technologies, LLC), expiring 04/11/28.

Ishaq 1. Chands

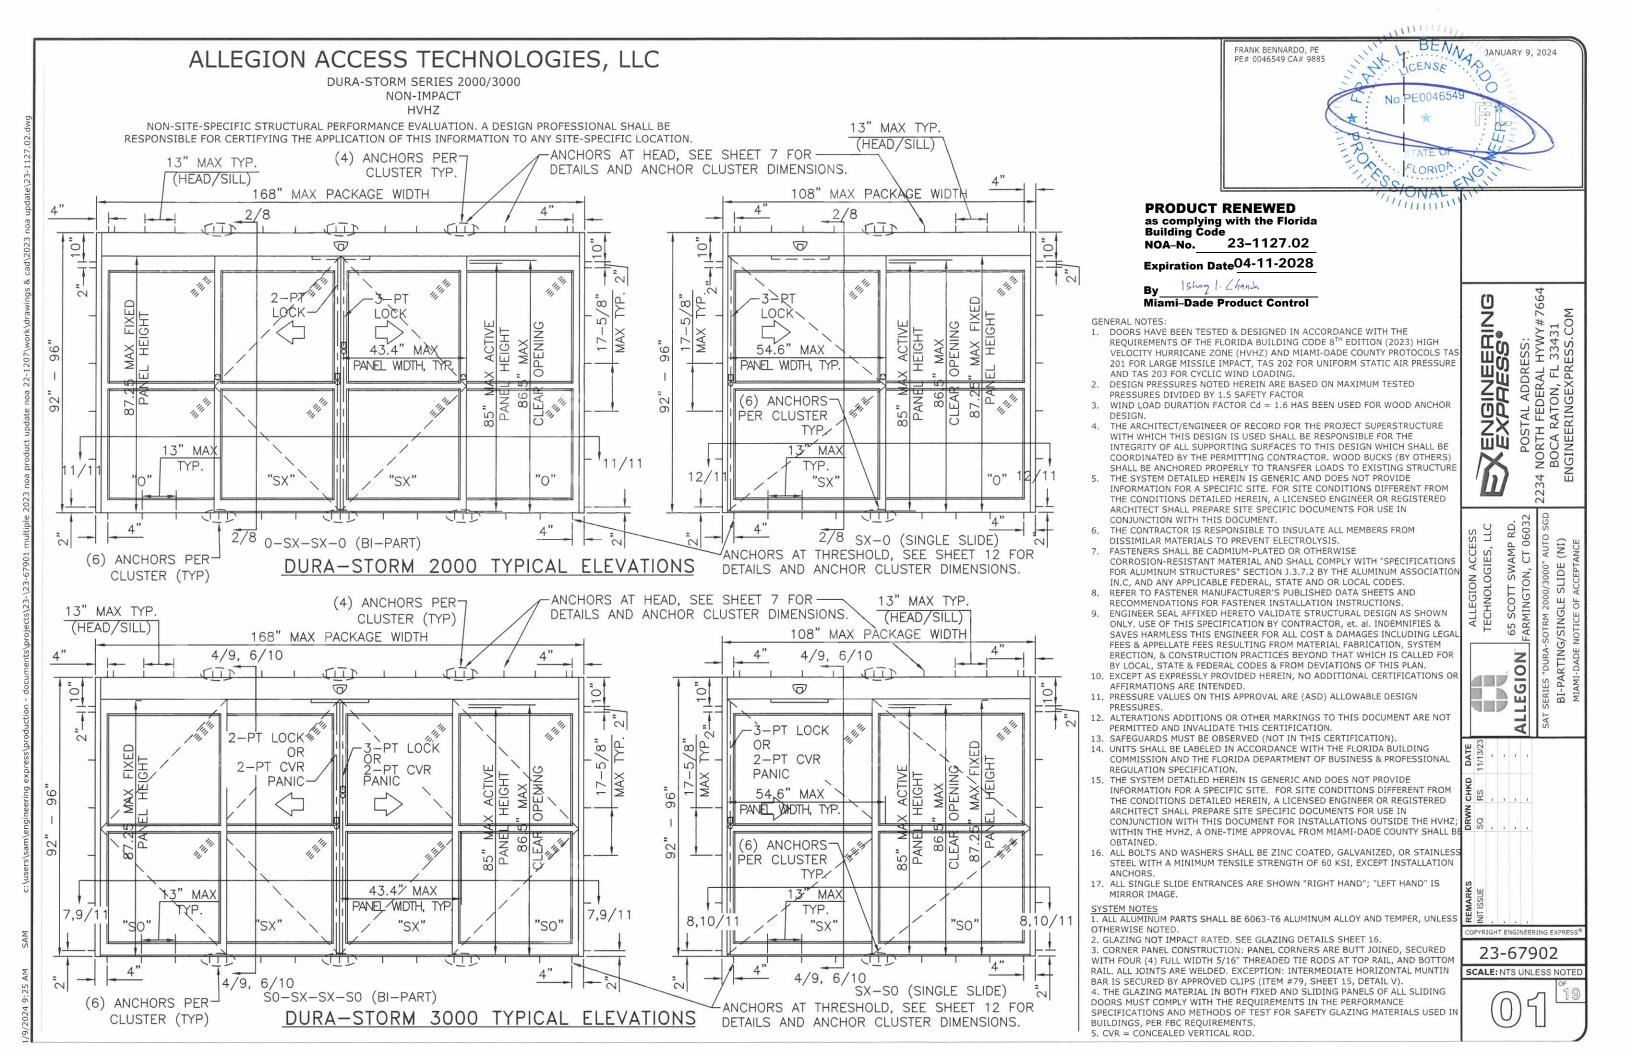

JANUARY 9, 2024 PE# 0046549 CA# 9885 **DURA-STORM SERIES 2000 W/ OPTIONAL TRANSOM, TYPICAL ELEVATIONS** PRODUCT RENEWED as complying with the Florida Building Code NOA-No. 23-1127.02 Expiration Date 04-11-2028 Ishaq 1. Chands ANCHORS AT HEAD, Miami-Dade Product Control SEE SHEET 7 FOR DETAILS AND ANCHOR T(4) ANCHORS PER (4) ANCHORS PER-ANCHORS AT HEAD, CLUSTER DIMENSIONS. 13" MAX TYP 13" MAX TYP. CLUSTER TYP. CLUSTER TYP. SEE SHEET 7 FOR (HEAD/SILL) ANCHORS AT-(HEAD/SILL) DETAILS AND ANCHOR 168" MAX\PACKAGE WIDTH 108" MAX PACKAGE WIDTH ENGINEERING EXPRESS® JAMBS, SEE POSTAL ADDRESS: 34 NORTH FEDERAL HYWY#766 BOCA RATON, FL 33431 ENGINEERINGEXPRESS.COM 4"CLUSTER DIMENSIONS. 1A/8 SHEET 8 FOR DETAILS AND **ANCHOR CLUSTER** TRANSOM MAX DIMENSIONS. 51 1/2" MAX 39 7/8" MAX TRANSOM 27 -REINF. 73 -REINF. 101 DLO TYP. DLO TYP. 13/18 14/18 10" 0 _Q * 15 3 HEIGHT 2, HEIGHT " MAX FIXED EL HEIGHT $\hat{\omega}$ ∞ LOCK 2 X ACTIVE HEIGHT 65 SCOTT SWAMP RD. FARMINGTON, CT 06032 PACKAGE ALLEGION ACCESS TECHNOLOGIES, LLC 17 54.6" MAX MAX PACKAGE PANEL WIDTH, TYP 85" N SE CLEAF 48.3" MAX 86 CLEA 87.2 P/ MAX 37" MAX MAX DLO DLO 43.4" MAX 13" MAX MAX PANEL/MDTH, TYP. TYP. TYP. 2/ 12/11 11/11 ALLEGION "0" "O" 1A/8 1/8 (6) ANCHORS PER-ANCHORS AT THRESHOLD, ∠ANCHORS AT THRESHOLD, (6) ANCHORS PER SEE SHEET 12 FOR CLUSTER (TYP) SEE SHEET 12 FOR CLUSTER TYP. DETAILS AND ANCHOR DETAILS AND ANCHOR CLUSTER DIMENSIONS. CLUSTER DIMENSIONS. DURA-STORM 2000 TYPICAL ELEVATIONS DURA-STORM 2000 TYPICAL ELEVATIONS 0-SX-SX-0 (BI-PART) SX-0 (SINGLE SLIDE) OPYRIGHT ENGINEERING EXPRESS MAX DLO AS SHOWN. 23-67902 1.1. BI-PARTING PANEL: 37" W X 77" H; TRANSOMS: 39 7/8" W X 26" H. . SINGLE SLIDE PANEL: 48 1/4" W X 77" H; TRANSOMS: 51 1/2" W X 26" H. 5-POINT LOCKING STANDARD (3-PT ACTIVE & 2-PT). SEE SHEET 17. SCALE: NTS UNLESS NOTED PRODUCT SHALL BE MANUFACTURED AND INSTALLED IN ACCORDANCE WITH PRODUCT APPROVALS. SEE SHEETS 7, 8, 11 AND 12 FOR REQUIRED ANCHORAGE. SEE SHEET 16 FOR GLAZING DETAILS.

FRANK BENNARDO, PE PE# 0046549 CA# 9885 **DURA-STORM SERIES 3000 W/ OPTIONAL TRANSOM, TYPICAL ELEVATIONS PRODUCT RENEWED** as complying with the Florida Building Code 23-1127.02 NOA-No. Expiration Date 04-11-2028 Ishaq I. Chands Miami-Dade Product Control 1,SIONAL ANCHORS AT HEAD, -(4) ANCHORS PER (4) ANCHORS PER-SEE SHEET 7 FOR 13" MAX TYP. 13" MAX TYP. CLUSTER TYP. CLUSTER TYP. DETAILS AND ANCHOR (HEAD/SILL) (HEAD/SILL) ANCHORS AT ANCHORS AT HEAD, CLUSTER DIMENSIONS. 168" MAX\PACKAGE WIDTH 108" MAX\PACKAGE WIDTH JAMBS, SEE SEE SHEET 7 FOR SHEET 9 FOR DETAILS AND ANCHOR 3A/9 3/9 DETAILS AND 4"CLUSTER DIMENSIONS 5A/10 5/10 ANCHOR CLUSTER DIMENSIONS. 15 2," 2, 4, W/TRANSOM 39 7/8" MAX 51 1/2" MAX 13/18 70 27 -REINF. 73 -REINF. 101 DLO TYP. 13/18 DLO TYP. 14/18 14/18 10" 0 0 2, 10 > 3-PT LOCK HEIGHT HEIGHT 2-PT LOCK OR PT LOČK 2-PT CVR œ OR PANIC 5 **CVR** " MAX OPEMING MAX PACKAGE PACKAGE **PANIC** .96 54.6" MAX PANEL WIDTH, TYP. 85" M 86 EAF 86. CLEAF 87.2 PA 48.3" MAX MAX 37" MAX DLO DLO / 3/4" 43.4" MAX 13" MAX 13" MAX PANEL WIDTH, TYP. TYP. 8,10/11 7,9/ 8,10/11 7,9/11 "SO" 'SO' "SX" "SX 3A/9 3/9 5A/10 5/10 ANCHORS AT THRESHOLD, (6) ANCHORS PER-(6) ANCHORS PER SEE SHEET 12 FOR ANCHORS AT THRESHOLD, CLUSTER (TYP) CLUSTER TYP. DETAILS AND ANCHOR SEE SHEET 12 FOR CLUSTER DIMENSIONS. DETAILS AND ANCHOR CLUSTER DIMENSIONS DURA-STORM 3000 TYPICAL ELEVATIONS DURA-STORM 3000 TYPICAL ELEVATIONS SX-SO (SINGLE SLIDE) SO-SX-SX-SO (BI-PART) COPYRIGHT ENGINEERING EXPRESS MAX DLO AS SHOWN. 23-67902 1.1. BI-PARTING PANEL: 37" W X 77" H, 36 3/4" H WITH PANIC MUNTIN; TRANSOMS: 39 7/8" W X 26" H.
1.2. SINGLE SLIDE PANEL: 48 1/4" W X 77" H, 36 3/4" H WITH PANIC MUNTIN; TRANSOMS: 51 1/2" W X 26" H.

4-POINT CVR LOCKING WITH G86 PANIC RELEASE (2-PT CVR ACTIVE & 2-PT CVR) AND 5-POINT LOCKING (3-PT ACTIVE & 2-PT) AVAILABLE. SEE SHEET 17. PRODUCT SHALL BE MANUFACTURED AND INSTALLED IN ACCORDANCE WITH PRODUCT APPROVALS.


SEE SHEETS 7, 9, 10, 11 AND 12 FOR REQUIRED ANCHORAGE.

SEE SHEET 16 FOR GLAZING DETAILS.

JANUARY 9, 2024 ENGINEERIN EXPRESS. 65 SCOTT SWAMP RD. FARMINGTON, CT 06032 ALLEGION ACCESS
TECHNOLOGIES, LLC SLIDE (NI) ALLEGION

SCALE: NTS UNLESS NOTED

DURA-STORM SERIES 2000 ELEVATION AND PLAN

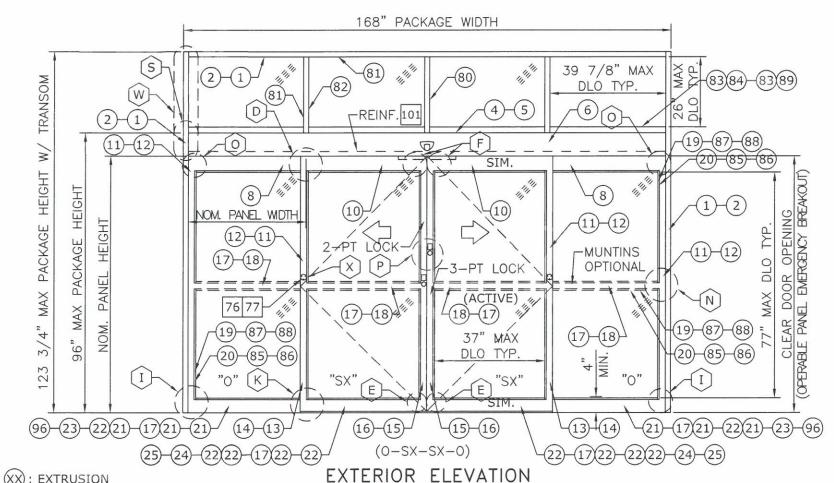

DESIGN RATINGS MISSILE IMPACT RATING \boxtimes NON-IMPACT RESISTANT DESIGN PRESSURE RATING (PSF[Pa]) WHERE WATER INFILTRATION RATING IS WHERE WATER INFILTRATION RATING IS REQUIRED NOT REQUIRED **POSITIVE** NOT APPROVED 55 PSF **NEGATIVE** NOT APPROVED 55 PSF

FRANK BENNARDO, PE PE# 0046549 CA# 9885

	SERIES	2000 AVAIL	ABLE PACK	AGE WIDTH	INFORMATION	*
PACKAGE WIDTH	ROUGH OPENING	STILE TYPE	NOMINAL CLEAR DOOR OPENING	NOMINAL PANEL WIDTH (SX)	NOMINAL PANEL WIDTH (0)	CAULKING ALLOWANCE
168.0"	168.5"	NARROW	70.6"	42.7"	42.7"	1/4" / SIDE
168.0"	168.5"	MEDIUM	66.3"	43.4"	43.4"	1/4" / SIDE

SERIE		/AILABLE PACKAGE FORMATION*	HEIGHT
PACKAGE HEIGHT	ROUGH OPENING	NOMINAL CLEAR DOOR OPENING	CAULKING ALLOWANCE
92.0"	92.3"	82.5"	1/4" TOP
96.0"	96.3"	86.5"	1/4" TOP

PRODUCT RENEWED as complying with the Florida Building Code NOA-No. 23-1127.02

Expiration Date 04-11-2028

Ishag 1. Chands Miami-Dade Product Control

(A). LATROSTON	EXTERIOR ELEVATION
(XXXX): EXTRUSION, MULTI-PIEC	
XX-XX: EXTRUSION, OPTION	168" PACKAGE WIDTH
XX : PART	INTERIOR
XX XX : PART, MULTI-PIECE	
XX-XX: PART, OPTION	<u> </u>
XX : DETAIL	EXTERIOR "SX" /\ "SX"
XX XX: DETAIL, OPTION	
OPERA EMERGENCY	BLE PANEL BREAKOUT
	CLEAR DOOR OPENING
	PLAN

TYPICAL DOOR SHOWN. STILE, RAIL AND MUNTIN OPTIONS AVAILABLE AS INDICATED.

HORIZONTAL MUNTIN BAR NOT REQUIRED AS INDICATED BY DASHED LINES. MAX DLO: 37" W X 77" H AS SHOWN


5-POINT LOCKING STANDARD (3-PT ACTIVE & 2-PT). SEE SHEET 17.
PRODUCT SHALL BE MANUFACTURED AND INSTALLED IN ACCORDANCE WITH PRODUCT APPROVALS. SEE SHEETS 7, 8, 11, AND 12 FOR REQUIRED ANCHORAGE.

SEE SHEET 16 FOR GLAZING DETAILS.

65 SCOTT SWAMP RD. FARMINGTON, CT 06032 ALLEGION 23-67902 SCALE: NTS UNLESS NOTED

JANUARY 9, 2024

ISTATE OF SIONAL ENGINEERING EXPRESS® POSTAL ADDRESS: ORTH FEDERAL HYWY OCA RATON, FL 3343

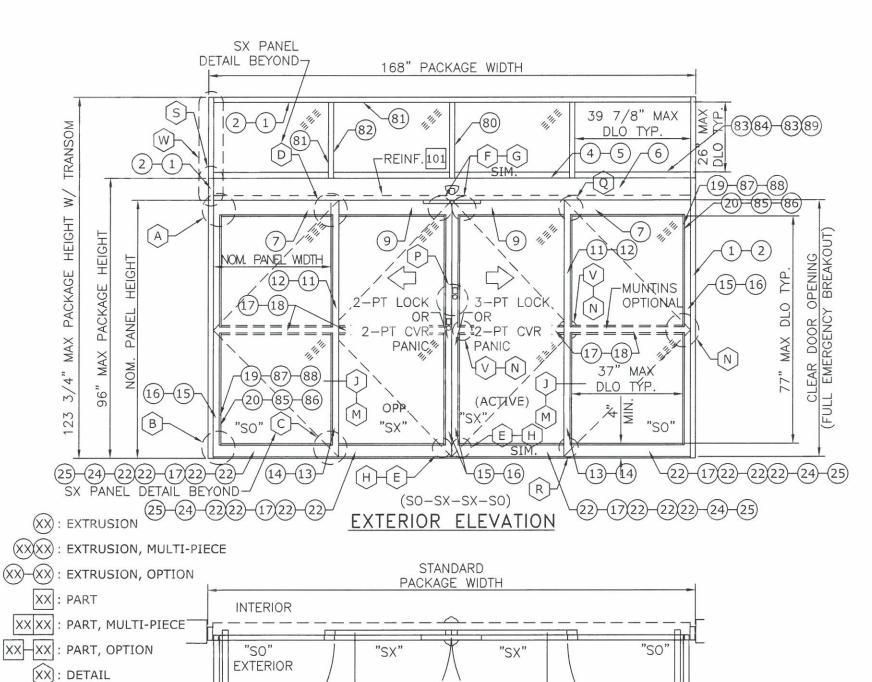

		1/11
	DESIGN RATING	<u>GS</u>
MISSILE IMPA	ACT RATING	
\boxtimes	NON-IMPACT RESISTANT	
DESIGN PRE	 SSURE RATING (PSF[Pa])	
	WHERE WATER INFILTRATION RATING IS REQUIRED	WHERE WATER INFILTRATION RATING IS NOT REQUIRED
POSITIVE	NOT APPROVED	55 PSF
NEGATIVE	NOT APPROVED	55 PSF

FRANK BENNARDO, PE

PE# 0046549 CA# 9885

	SERIES .	3000 AVAIL	ABLE PACK	AGE WIDTH	INFORMATION	*
PACKAGE WIDTH	ROUGH OPENING	STILE TYPE	NOMINAL CLEAR DOOR OPENING	NOMINAL PANEL WIDTH (SX)	NOMINAL PANEL WIDTH (0)	CAULKING ALLOWANCE
168.0"	168.5"	NARROW	70.6"	42.7"	42.7"	1/4" / SIDE
168.0"	168.5"	MEDIUM	66.3"	43.4"	43.4"	1/4" / SIDE

SERIE		/AILABLE PACKAGE FORMATION*	HEIGHT
PACKAGE HEIGHT	ROUGH OPENING	NOMINAL CLEAR DOOR OPENING	CAULKING ALLOWANCE
92.0"	92.3"	82.5"	1/4" TOP
96.0"	96.3"	86.5"	1/4" TOP

PRODUCT RENEWED as complying with the Florida Building Code 23-1127.02 NOA-No.

Expiration Date 04-11-2028

Ishaq 1. Chands

Miami-Dade Product Control

1. TYPICAL DOOR SHOWN. STILE, RAIL AND MUNTIN OPTIONS AVAILABLE AS INDICATED.

FULL **EMERGENCY**

BREAK OUT

2. HORIZONTAL MUNTIN BAR NOT REQUIRED EXCEPT AT PANIC DEVICE, AS INDICATED BY DASHED LINES. MAX PANEL DLO: 37" W X 77 3/8" H, 36 3/4" H WITH PANIC MUNTIN AS SHOWN.

CLEAR


DOOR OPENING PLAN

3. 4-POINT CVR LOCKING WITH G86 PANIC RELEASE (2-PT CVR ACTIVE & 2-PT CVR) AND 5-POINT LOCKING (3-PT ACTIVE & 2-PT) AVAILABLE. SEE SHEET 17.
4. PRODUCT SHALL BE MANUFACTURED AND INSTALLED IN ACCORDANCE WITH PRODUCT APPROVALS.

SEE SHEETS 7, 9, 10, 11, AND 12 FOR REQUIRED ANCHORAGE.

(XX)-(XX): DETAIL, OPTION


6. SEE SHEET 16 FOR GLAZING DETAILS.

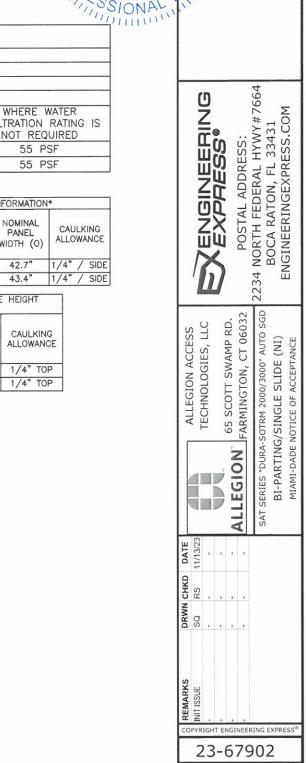



JANUARY 9, 2024


BENNAS


SCALE: NTS UNLESS NOTED

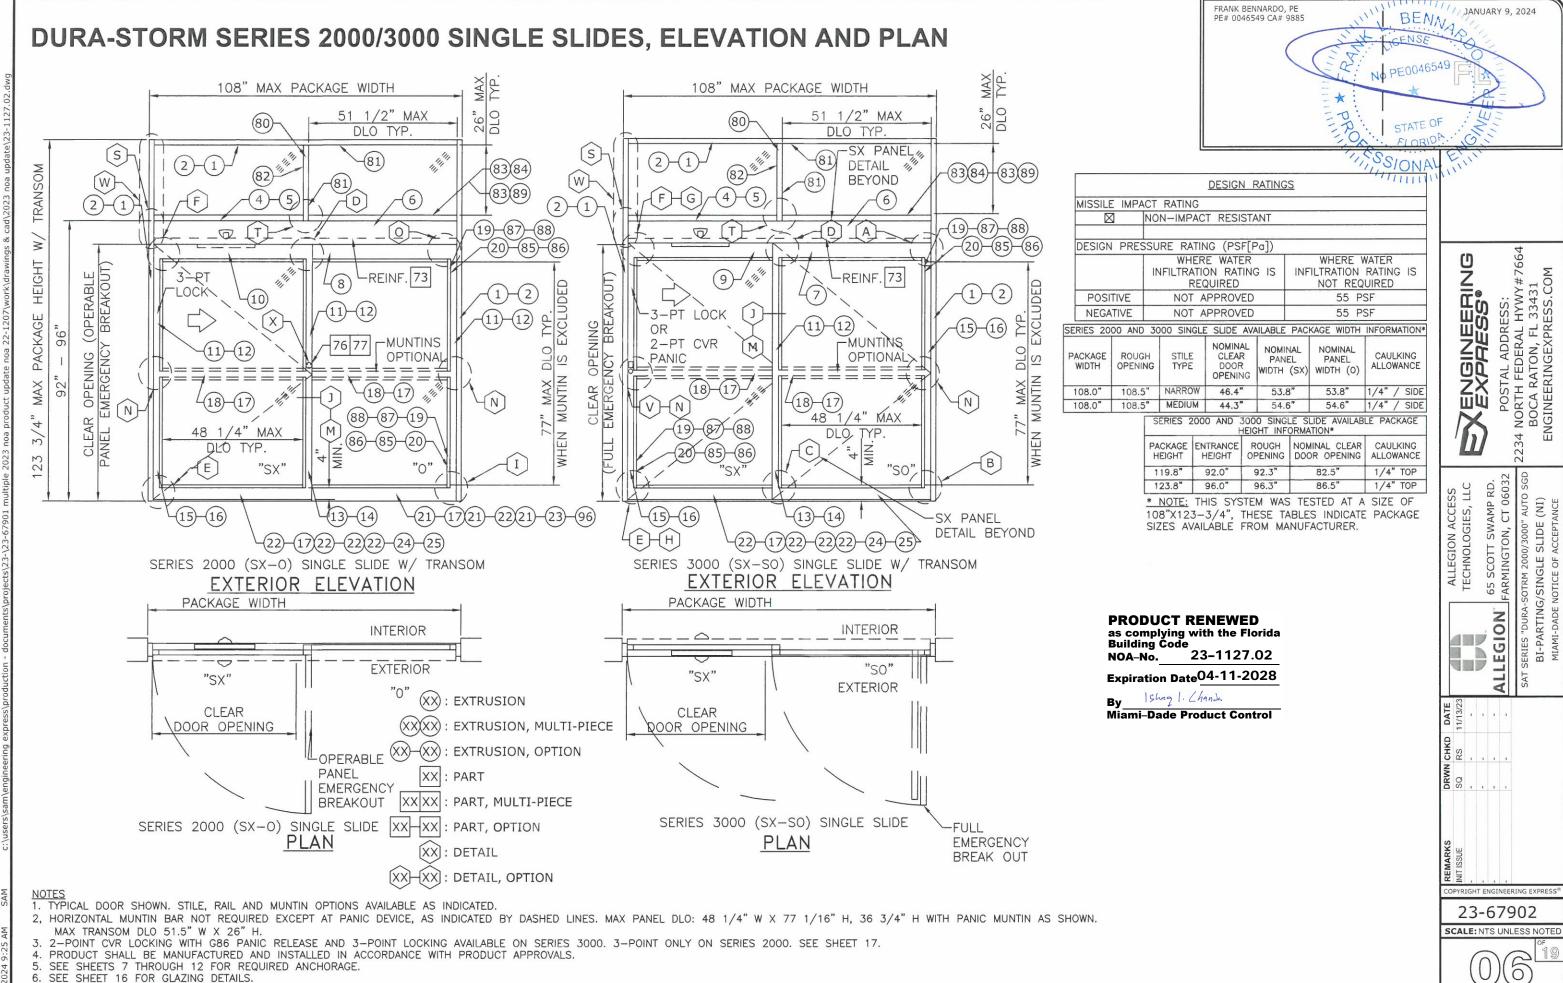


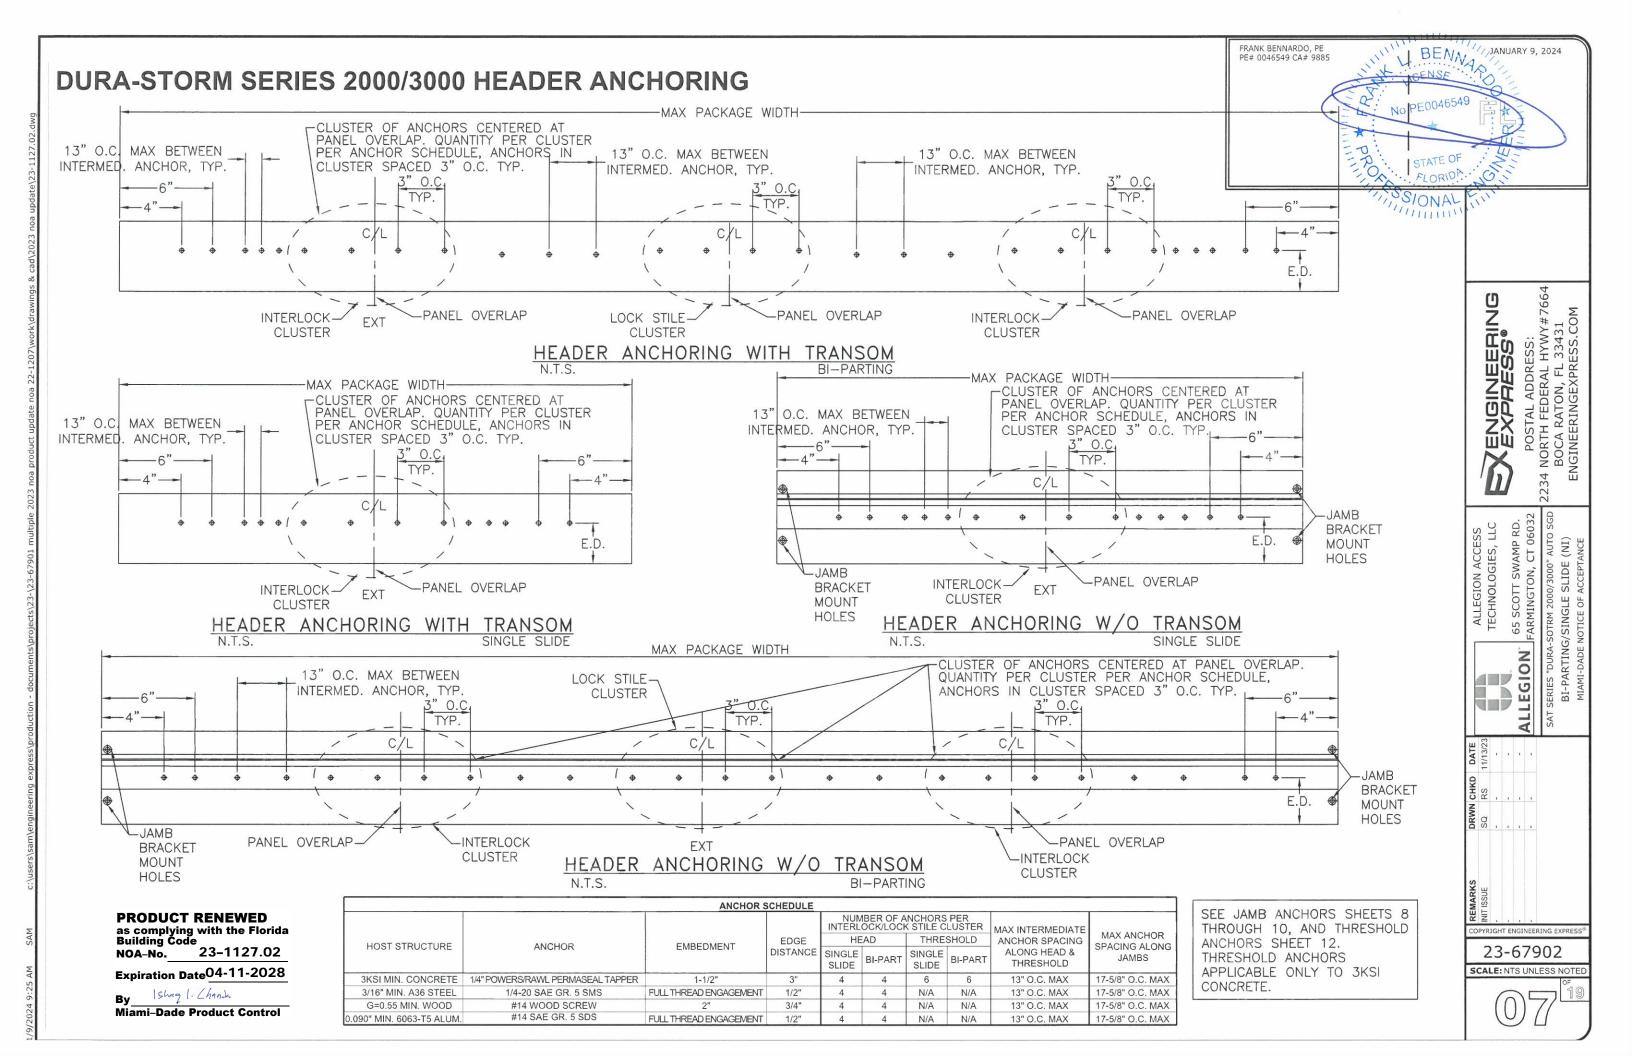


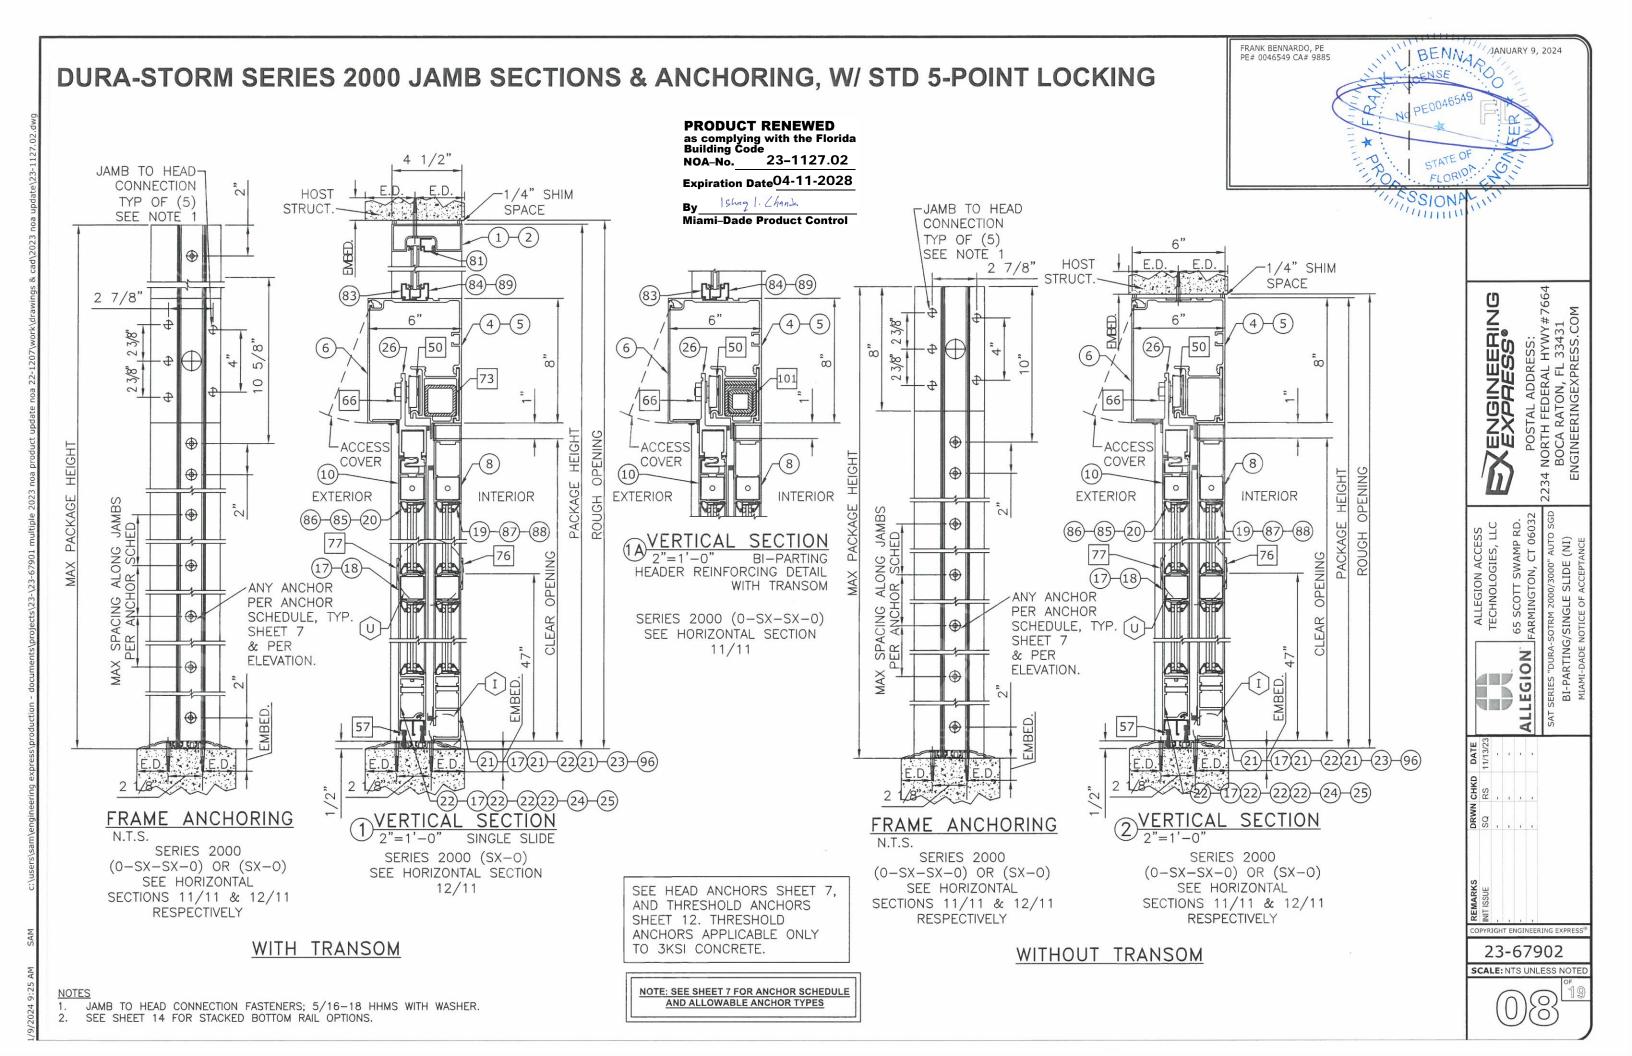


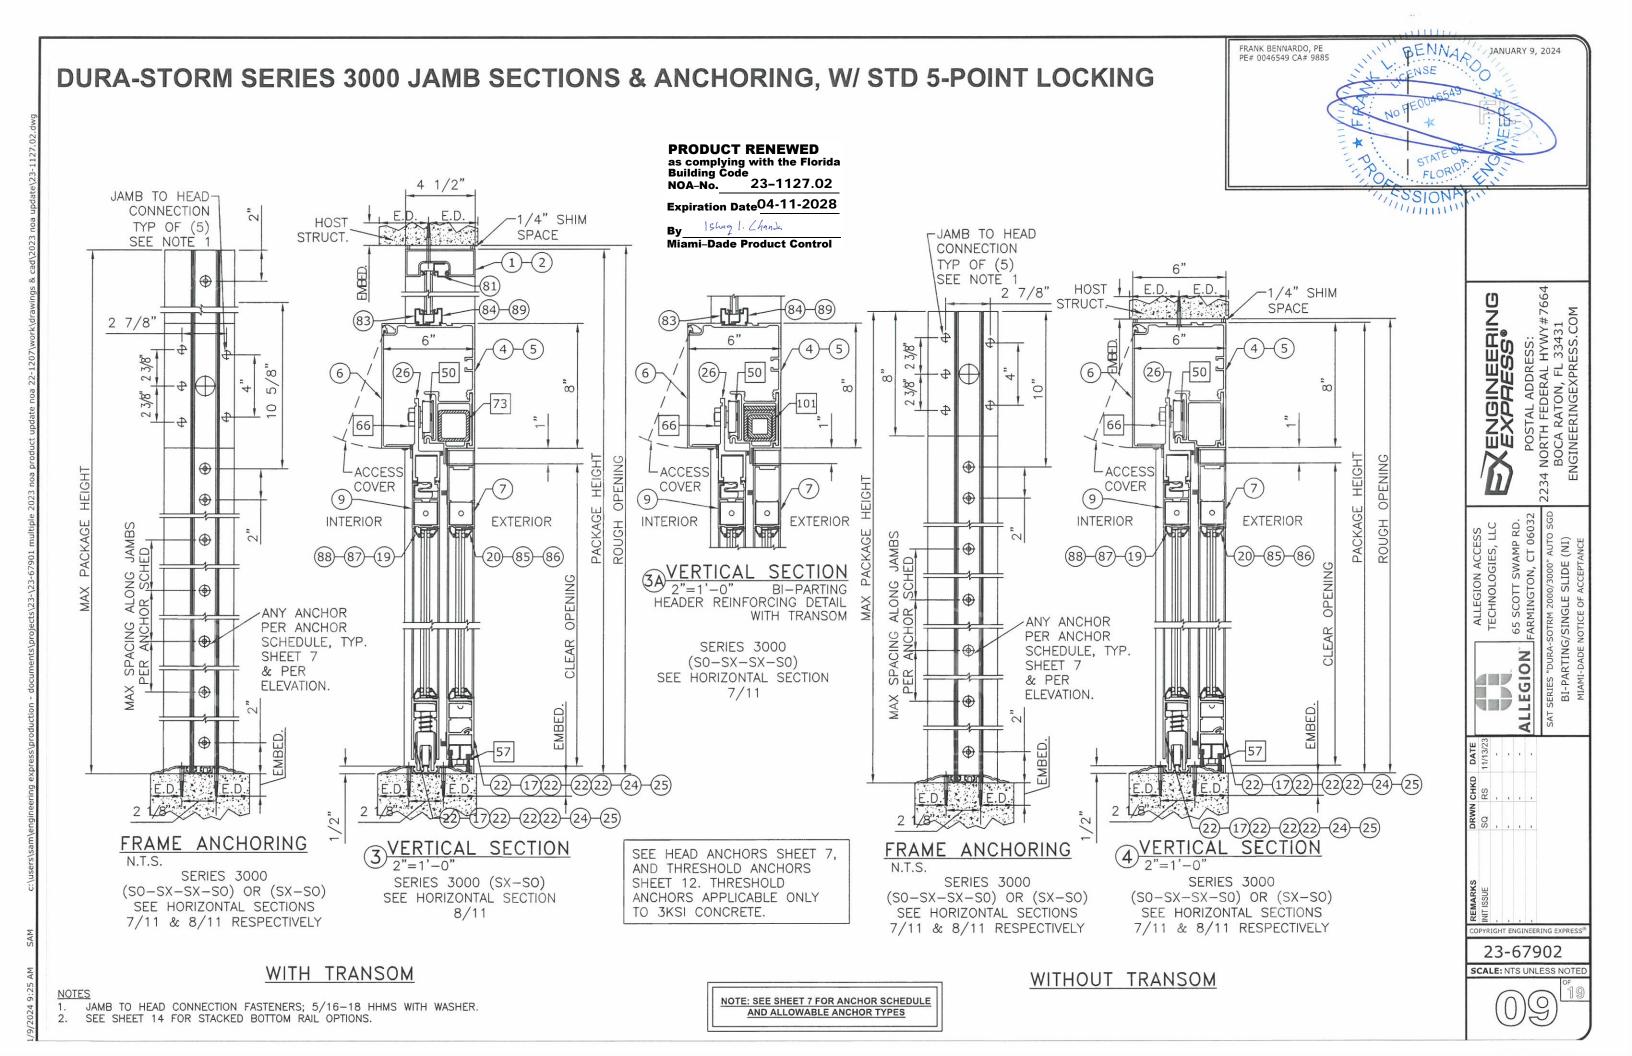


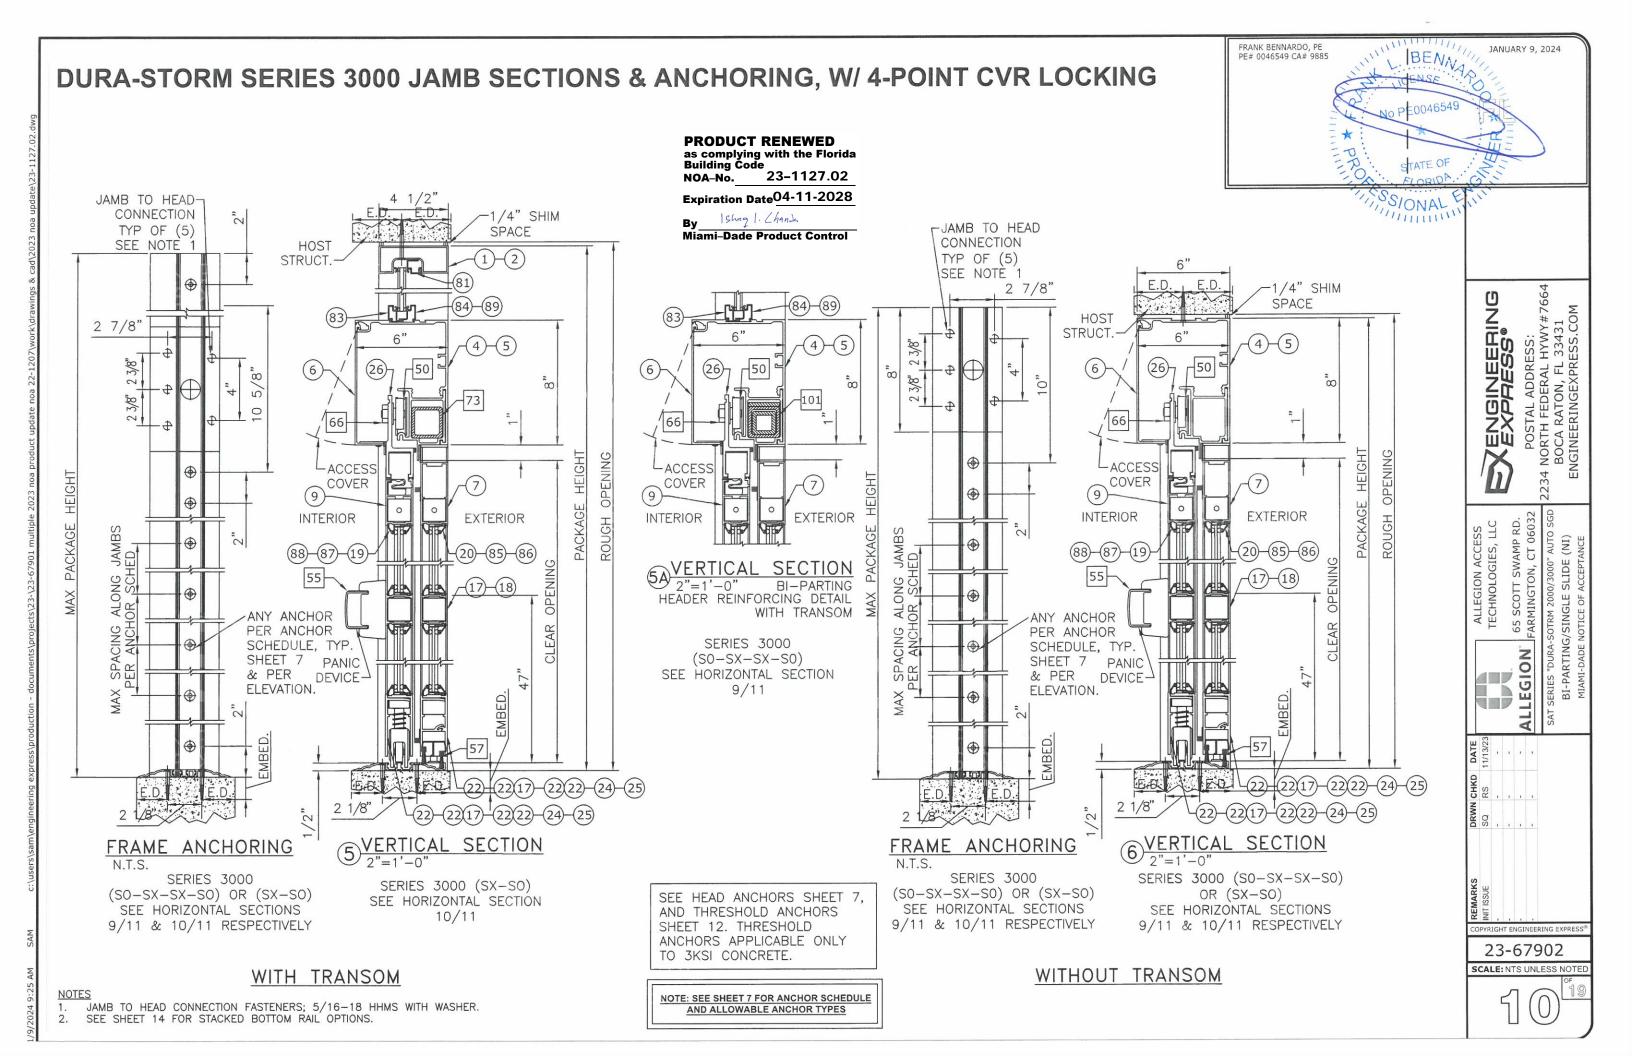

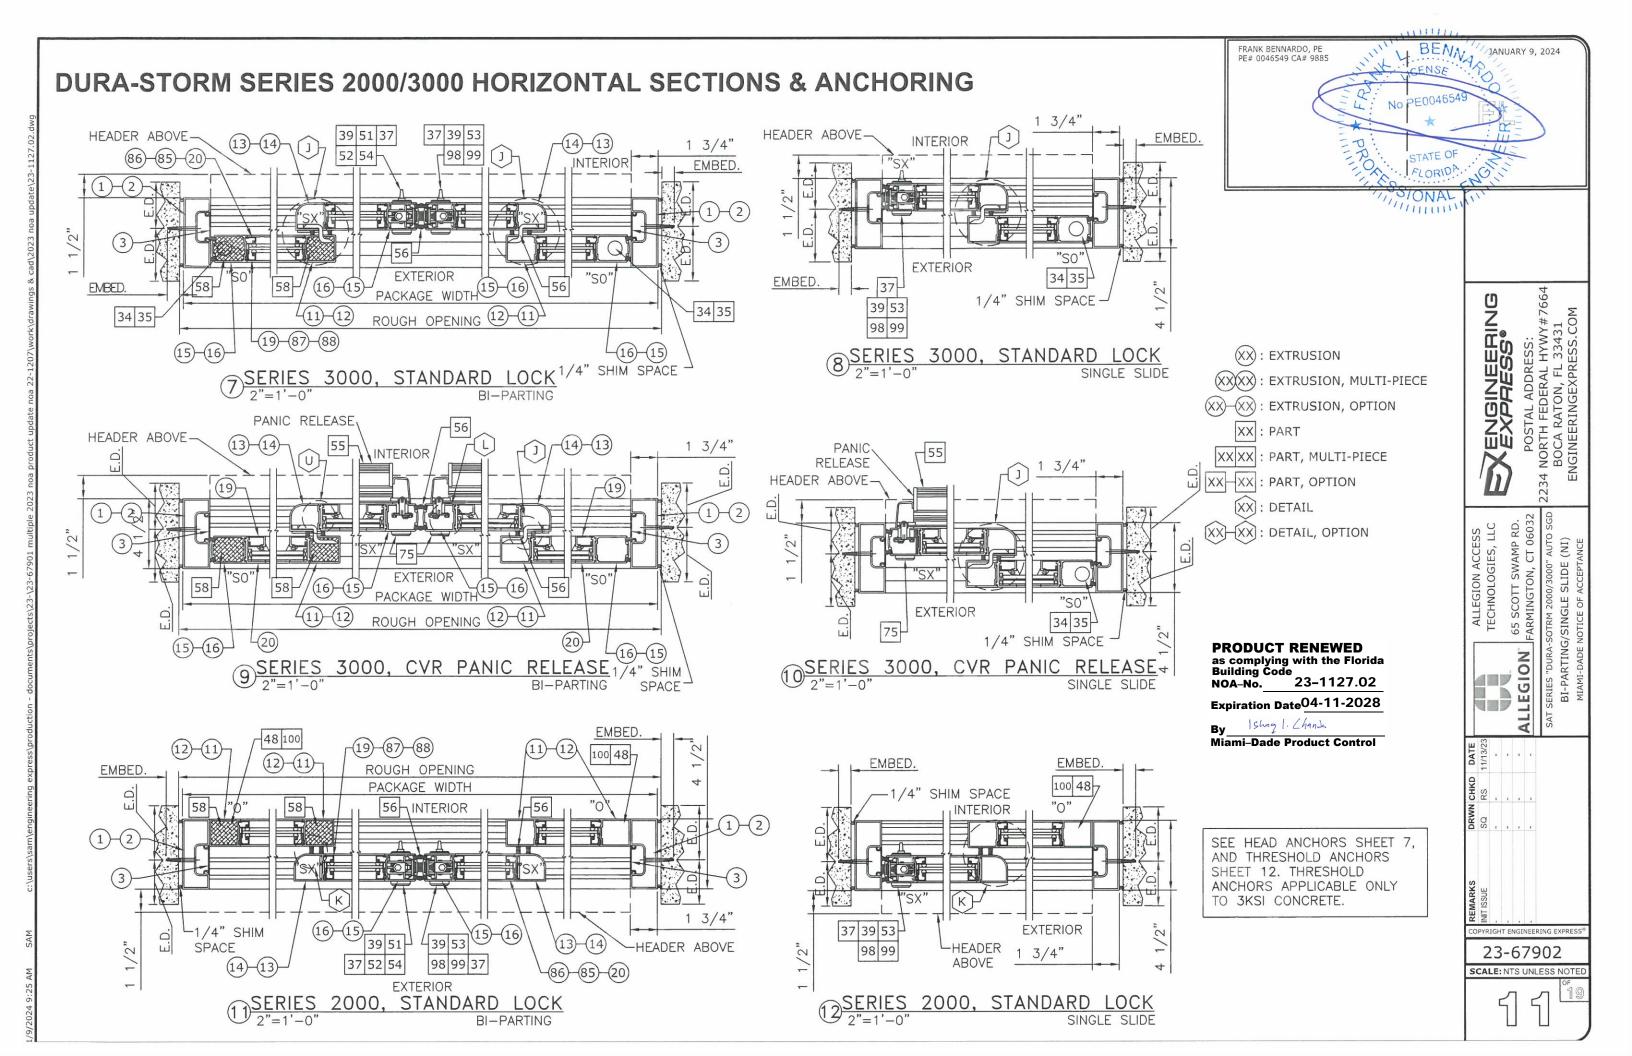


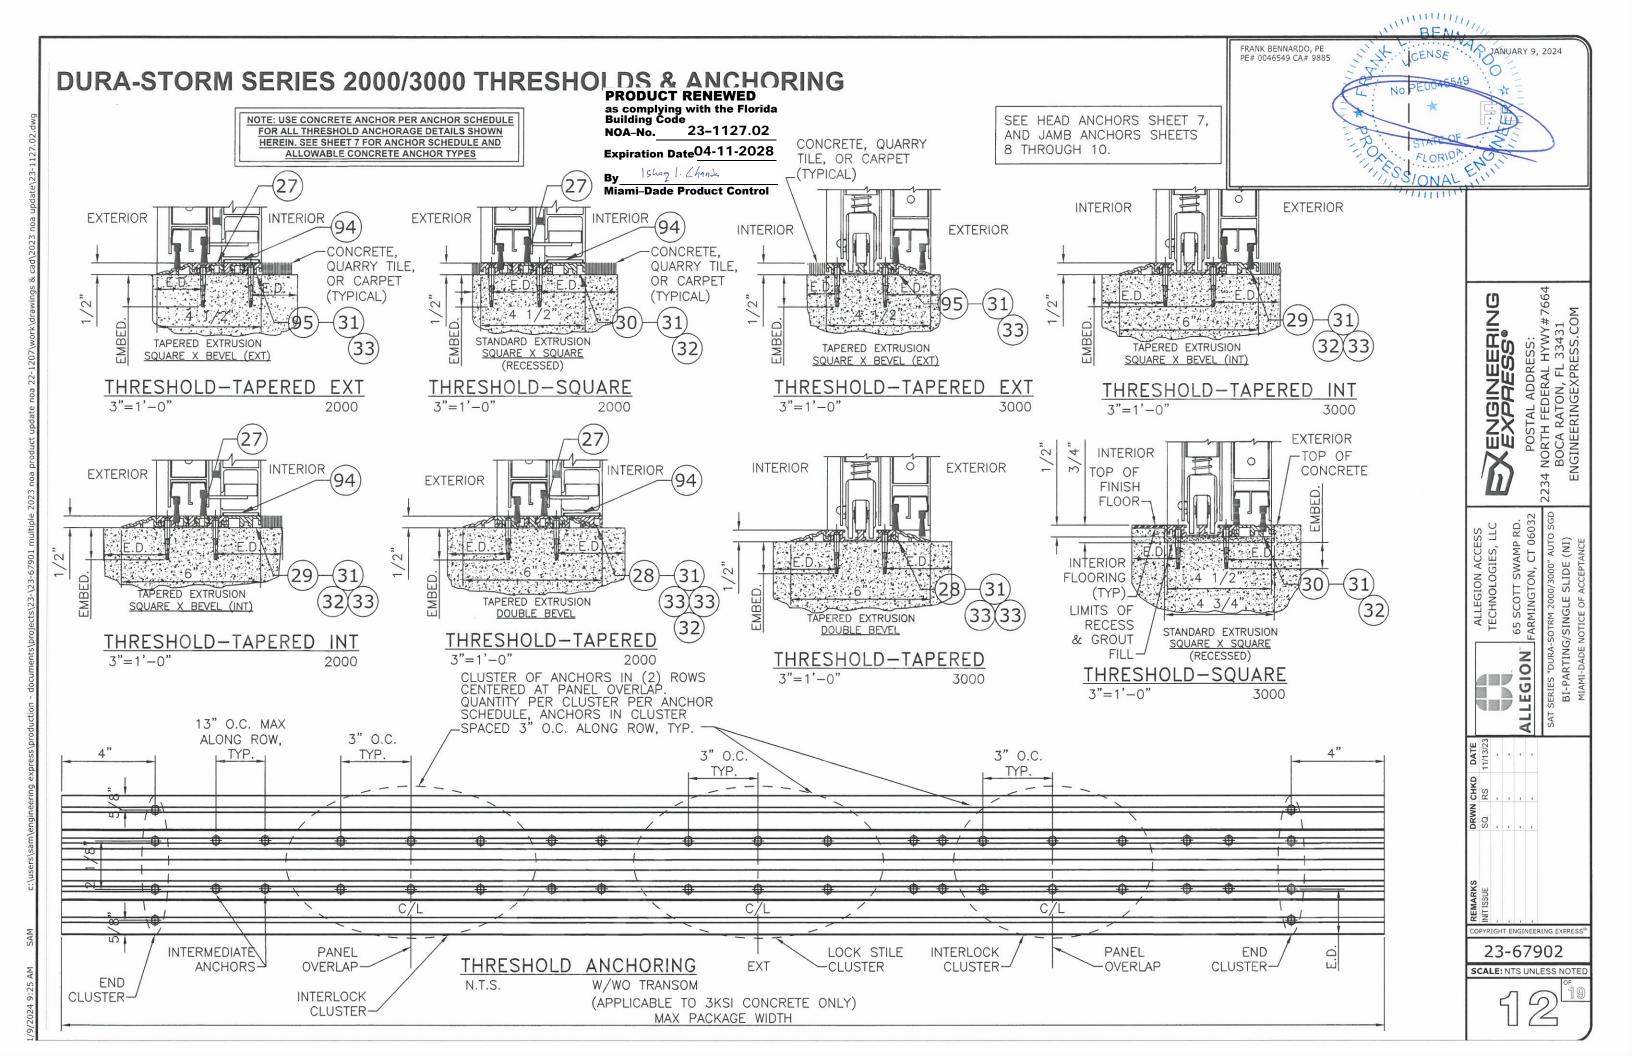

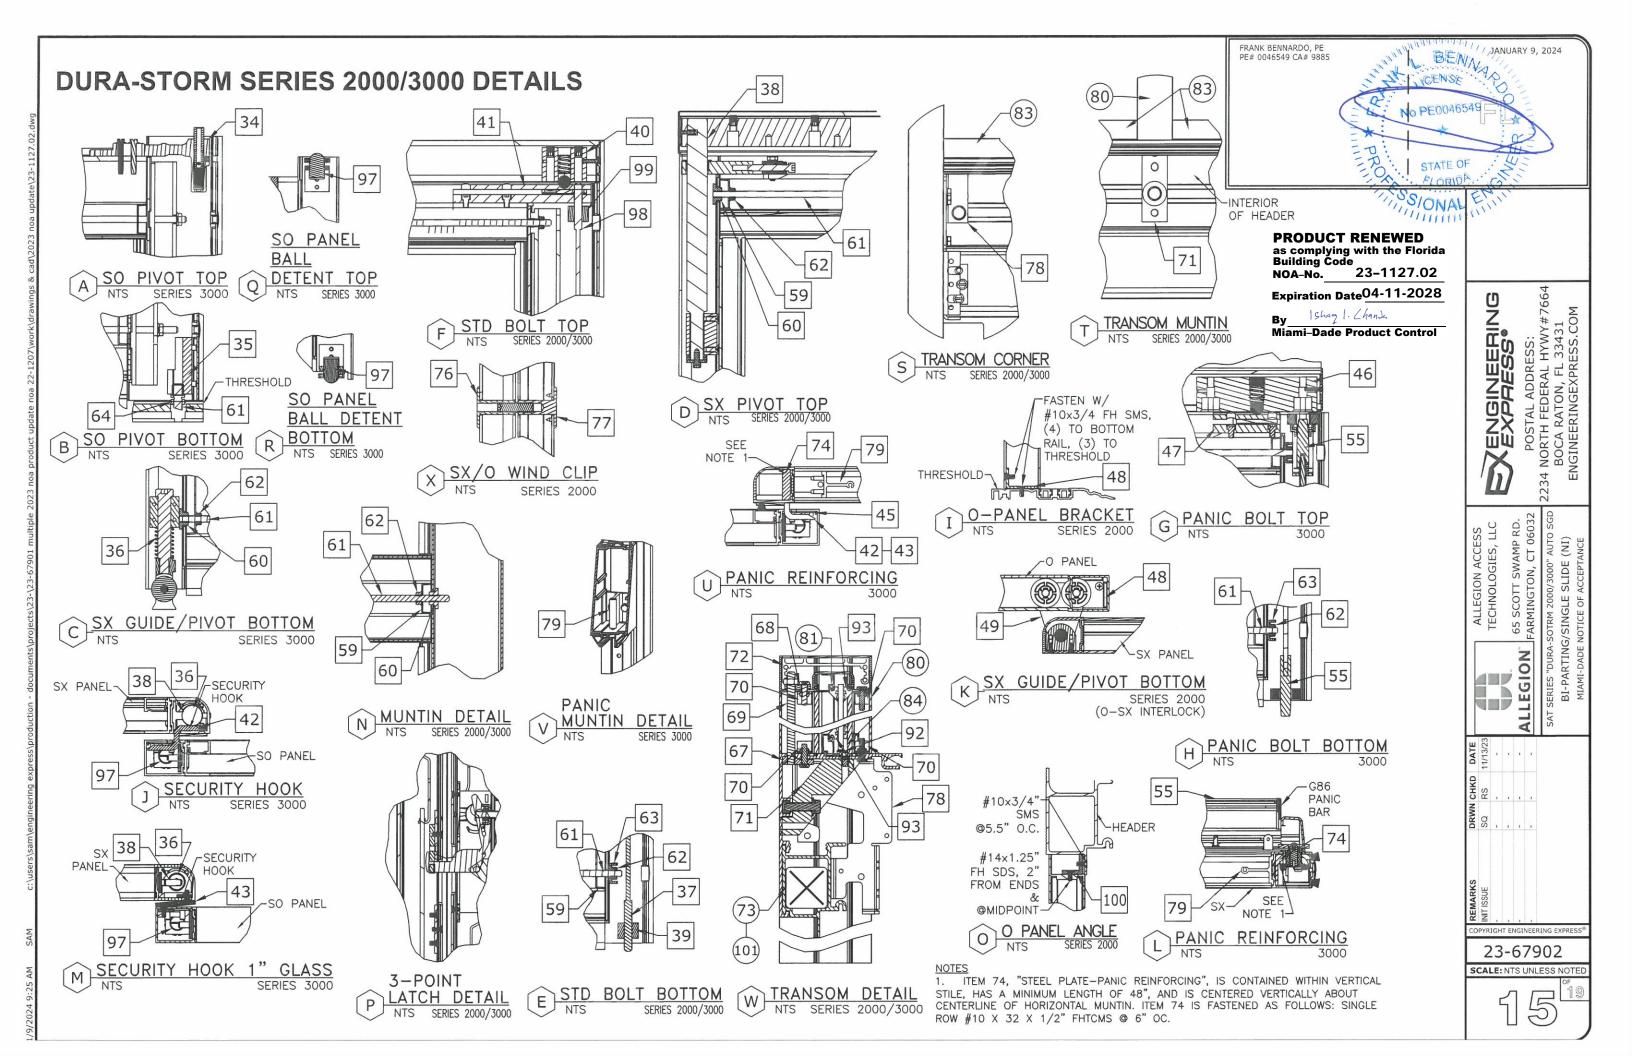


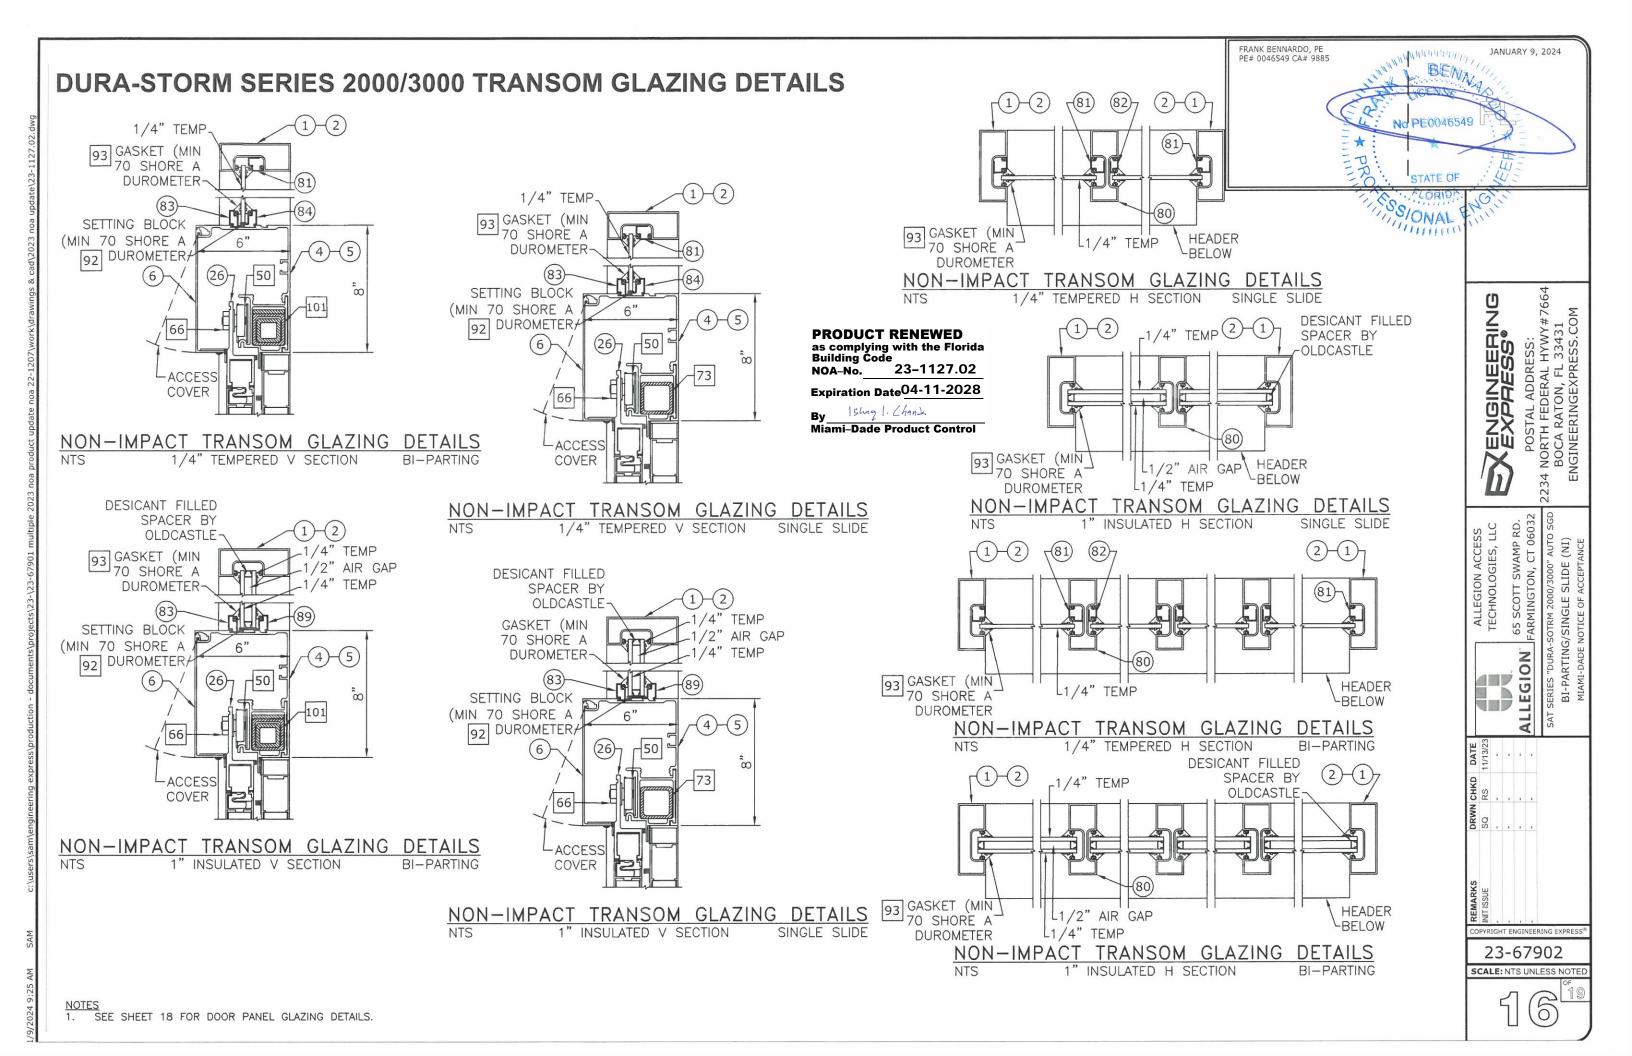



DURA-STORM SERIES 2000/3000 LOCKING ARRANGEMENTS

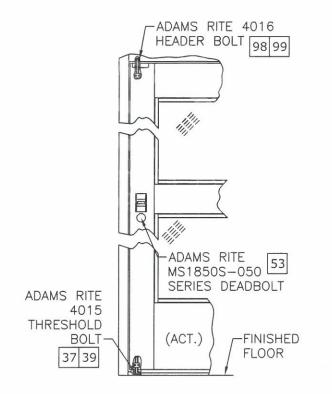

3-PT CONCEALED LOCKING SYSTEM SERIES 2000/3000 SINGLE SLIDE

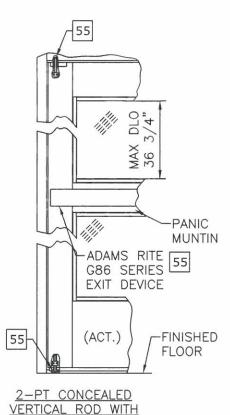

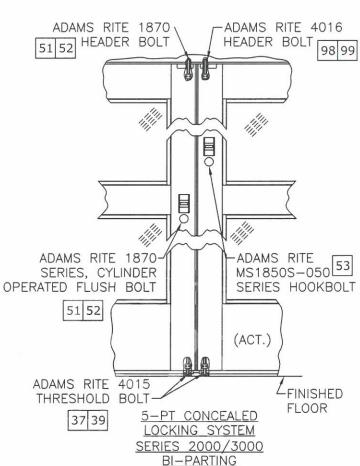

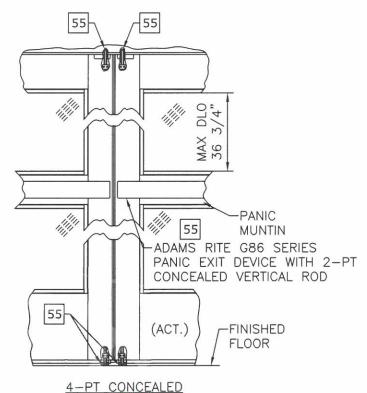



VERTICAL ROD WITH

PANIC RELEASE

LOCKING SYSTEM

SERIES 3000 BI-PARTING

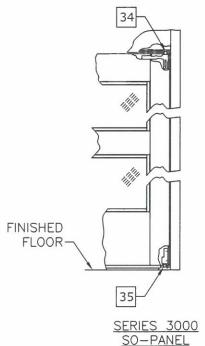

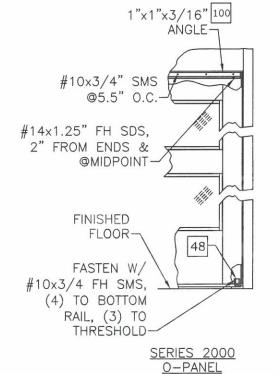

FRANK BENNARDO, PE PE# 0046549 CA# 9885

PRODUCT RENEWED as complying with the Florida Building Code 23-1127.02 NOA-No.

Expiration Date 04-11-2028

Ishag 1. Chands Miami-Dade Product Control


EXPRESS. 65 SCOTT SWAMP RD. ARMINGTON, CT 06032 ALLEGION ACCESS
TECHNOLOGIES, LLC ALLEGION CHKD RS - - - -OPYRIGHT ENGINEERING EXPRESS 23-67902 SCALE: NTS UNLESS NOTED

ANUARY 9, 2024

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LOCKING SYSTEM SERIES 3000 SINGLE SLIDE

PANIC RELEASE

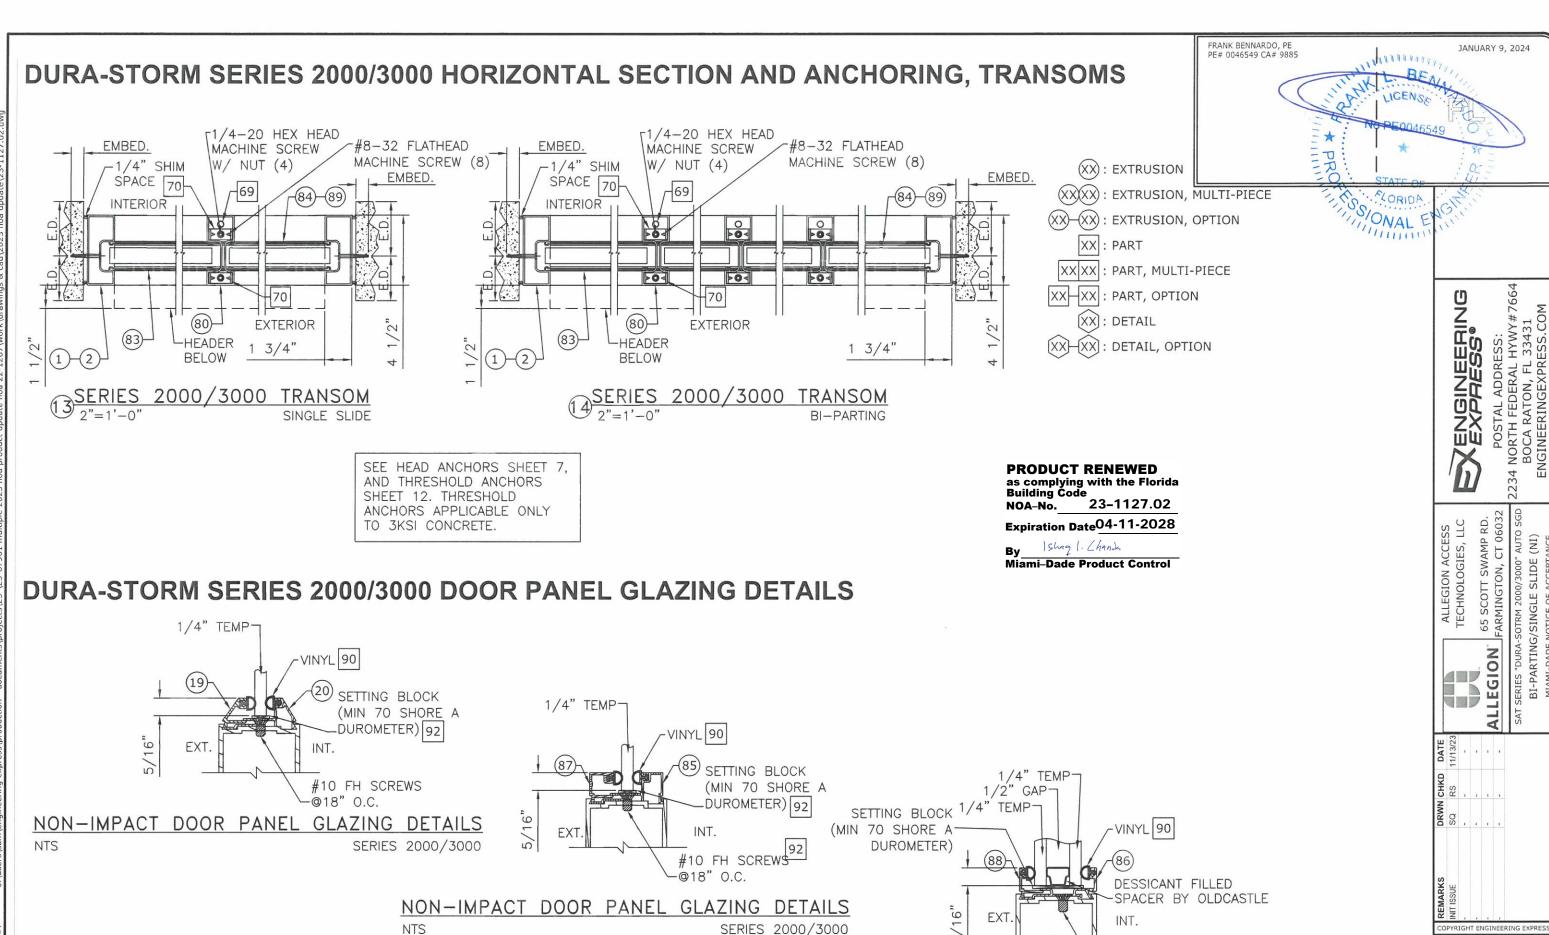

SEE SHEET 16 FOR TRANSOM GLAZING DETAILS.

NON-IMPACT DOOR PANEL GLAZING DETAILS NTS SERIES 2000/3000

#10 FH SCREWS

-@18" O.C.

23-67902

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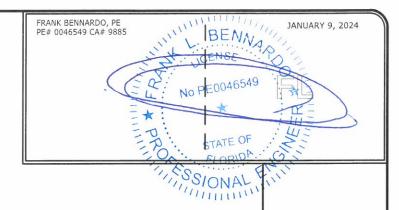
6

DURA-STORM SERIES 2000/3000 BILL OF MATERIALS

DEFEDENCE	DECCRIPTION
REFERENCE	DESCRIPTION
1	Extrusion - Jamb - 4 1/2"
2	Extrusion - Jamb - 6"
3	Extrusion - Jamb - Insert
4	Extrusion - Header - 1 PC
5	Extrusion - Header - 2 PC
<u>6</u> 7	Extrusion - Header Cover -
8	Extrusion - Top Rail - O, SO Extrusion - Top Rail - O, SO
9	Extrusion - Top Rail - SX
10	Extrusion - Top Rail - SX
11	Extrusion - Stile - Fixed
12	Extrusion - Stile - Lead
13	Extrusion - Stile - Pivot
14	Extrusion - Stile - Pivot
15	Extrusion - Stile - Lead
16	Extrusion - Stile - Lock
17	Extrusion - Muntin Bar/Stacked Bottom Rail Part - 2"
18	Extrusion - Muntin Bar - 4 1/4"
19	Extrusion - Panel Glass Stop - 1/4" - Horizontal
20	Extrusion - Panel Glass Gutter - 1/4" - Horizontal
21	Extrusion - Bottom Rail O - 4"
22	Extrusion - Bottom Rail SO/SX4"
23	Extrusion - Bottom Rail O - 10" - 2 PC
24	Extrusion - Bottom Rail SX/SO - 1 PC - 10"
25	Extrusion - Bottom Rail SX/SO - 2 PC - 10"
26	Extrusion - Hanger -
27	Extrusion - Threshold - Filler
28	Extrusion - Threshold - Dbl bevel - 6"
29	Extrusion - Threshold - Sq/BvI - 6"
30	Extrusion - Threshold - Recessed - 4.5"
31 32	Extrusion - Threshold - Core Extrusion - Threshold - Square
33	Extrusion - Threshold - Bevel
34	Component - Top Pivot - SO - 3000
35	Component - Bottom Pivot - SO - 3000
36	Component - Bottom Guide - SX- 2000/3000
37	Component - Throw Bolt - Std - Adams Rite 4015
38	Component - Top pivot - SX
39	Component - Guide - Throw Bolt - Adams Rite 4015
40	Component - Ball Detent - Std
	·
41	Component - Detent Block - Std
42	Component - Security Hook - Std
43	Component - Security Hook - 1" Glass
45	Component - Backing Plate - Security Hook
46	Component - Ball Detent
47	Component - Detent Block
48	Component - Bracket - O Panel
49	Component - Bottom Guide - SX - 2000
50	Component - Load Wheel - Steel/Aluminum/Plastic
51	Component - Lock - Cylinder - Adams Rite 1870 (2-P Lock) or Adams Rite MS1850S-050 (3-PT Lock)
52	Component - Lock - Thumb Turn - Adams Rite 1870 (2-PT Lock) or Adams Rite MS1850S-050 (3-PT Lock)

NON-CALL	OUT	PART	#	44	IS	NOT	PART	OF	BOM
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REFERENCE	DESCRIPTION				
	Component - 8 Ply Multipoint Lock - Single Action -				
53	Adams Rite MS1850S-050 (Deadbolt), Used w/ Adams				
	Rite 4015 and 4016 Bolts				
54	Component - Exit Indicator -				
55	Component - 2-Pt Panic Device - Adams Rite G86 with concealed vertical rod (top/bottom) and latch assemble				
56	Component - Pile - Adhesive/non Adhesive backed				
57	Component - Brush - Sweep				
58	Component - Foam Block -				
59	Hardware - Tie Rod - Plate				
60	Hardware - Tie Rod - Nut - 5/16-18 - Steel				
61	Hardware - Threaded Rod - 5/16-18 - Steel				
62	Hardware - 5/16 - 18 - Nut - Steel				
63	Hardware - Tie Rod / Rail - Plate - Steel				
64	Hardware - 7/16-20 Jamb Nut - Steel				
65	Hardware - 7/16 SO Pivot Pin - Steel				
66	Hardware - 5/8-11 Nut - Steel				
67	Hardware - Tie Rod - Nut Plate				
68	Hardware - Tie Rod - Top Clip				
69	Hardware - Tie Rod - 3/8-16 Hardware - Transom Clip - Steel				
70 71	Hardware - Stiffener - Steel - A500				
72	Hardware - Stineller - Steel - A500				
	Tube - Transom Stiffener - Single Slide - Steel (w/				
73	Optional Transom)				
74	Component - Steel Plate - Panic Reinforcing (48" Min.)				
75	Component - Key Operator - Adams Rite				
76	Component - Lock Flange (Int) - "Wind Clip"				
77	Component - Lock Flange (Ext) - "Wind Clip"				
78	Component - Header End Plate				
79	Component - Muntin Clip (with Panic)				
80	Extrusion - Transom - Vertical Muntin				
81	Extrusion - Transom - Frame Stop - 1/4"				
82	Extrusion - Transom - Vertical Muntin Stop - 1/4"				
83	Extrusion - Transom - Header Stop				
84	Extrusion - Transom - Header Gutter - 1/4"				
85	Extrusion - Panel Glass Gutter - 1/4" - Vertical				
86	Extrusion - Panel Glass Gutter - 1"				
87	Extrusion - Panel Glass Stop - 1/4" - Vertical				
88	Extrusion - Panel Glass Stop - 1"				
89	Extrusion - Transom - Header Gutter - 1"				
	Glazing - Vinyl Bulb - 0.200"				
90					
91	Glazing - Vinyl Bulb - 0.262"				
92	Glazing - Setting Block -				
93	Glazing - Gasket - Transom				
94	Extrusion - Key Strip				
95	Extrusion - Threshold - Sq/Bvl - 4.5"				
96	Extrusion - Bottom Rail O - 10"				
97	Component - Ball Detent - SO				
98	Component - Throw Bolt - Std - Adams Rite 4016				
99	Component - Guide - Throw Bolt - Adams Rite 4016				
100	Extrusion - 1"x1"x3/16" Angle				
	Nested Tube - Transom Stiffener - Bi-Parting - Steel (v				



PRODUCT RENEWED as complying with the Florida Building Code NOA-No. 23-1127.02

Expiration Date 04-11-2028

By | Sheq | . Chank
Miami-Dade Product Control

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