

DEPARTMENT OF REGULATORY AND ECONOMIC RESOURCES (RER) BOARD AND CODE ADMINISTRATION DIVISION

NOTICE OF ACCEPTANCE (NOA)

Gensteel Doors Inc. 4950 Hickmore Street

Ville St. Laurent, Quebec, Canada H4T1K6

Scope:

This NOA is being issued under the applicable rules and regulations governing the use of construction materials. The documentation submitted has been reviewed and accepted by Miami-Dade County RER -Product Control Section to be used in Miami Dade County and other areas where allowed by the Authority Having Jurisdiction (AHJ).

This NOA shall not be valid after the expiration date stated below. The Miami-Dade County Product Control Section (In Miami Dade County) and/or the AHJ (in areas other than Miami Dade County) reserve the right to have this product or material tested for quality assurance purposes. If this product or material fails to perform in the accepted manner, the manufacturer will incur the expense of such testing and the AHJ may immediately revoke, modify, or suspend the use of such product or material within their jurisdiction. RER reserves the right to revoke this acceptance, if it is determined by Miami-Dade County Product Control Section that this product or material fails to meet the requirements of the applicable building code.

This product is approved as described herein and has been designed to comply with the Florida Building Code, including the High Velocity Hurricane Zone.

DESCRIPTION: Series "GenStorm" Inswing Opaque Steel Doors

APPROVAL DOCUMENT: Drawing No. **AD11-04**, titled "Genstorm Opaque Inswing Door - LMI", sheet 1 through 8 of 8, prepared by manufacture, signed and sealed by Gordon D. Thomas, P.E. on 03/23/2022 and last revised on 02/28/2024, bearing the Miami-Dade County Product Control Revision stamp with the Notice of Acceptance number and expiration date by the Miami-Dade County Product Control Section.

MISSILE IMPACT RATING: Large Missile Impact Resistant

Limitations:

- 1. See Design Pressures & corresponding Hardware in sheets 1 & 6. Max. Exterior (positive) DP= +33 (double), +65 (Single) w/ PEMKO-177 AT threshold, where water infiltration requirement is needed.
- 2. Options #1, 2 & #3 require total two (2) flush bolts (top/bottom) on in-active panel.

LABELING: Each unit shall bear one of the following permanent labels:

Gensteel Doors Inc.	Gensteel Doors Inc.	Gensteel Doors, USA
4950 Hickmore Street	2335 Industrial Park Drive	1551 Fairground Road
Ville St. Laurent, Quebec, Canada H4T1K6	Cornwall, Ontario, Canada K6H7M4	Madison, Georgia, USA 30650

Along w/ series or model number and the statement: "Miami-Dade County Product Control Approved".

RENEWAL of this NOA shall be considered after a renewal application has been filed and there has been no change in the applicable building code negatively affecting the performance of this product.

TERMINATION of this NOA will occur after the expiration date or if there has been a revision or change in the materials, use, and/or manufacture of the product or process. Misuse of this NOA as an endorsement of any product, for sales, advertising or any other purposes shall automatically terminate this NOA. Failure to comply with any section of this NOA shall be cause for termination and removal of NOA.

ADVERTISEMENT: The NOA number preceded by the words Miami-Dade County, Florida, and followed by the expiration date may be displayed in advertising literature. If any portion of the NOA is displayed, then it shall be done in its entirety.

INSPECTION: A copy of this entire NOA shall be provided to the user by the manufacturer or its distributors and shall be available for inspection at the job site at the request of the Building Official.

This NOA **revises NOA #22-0330.01** and consists of this page 1 and evidence pages E-1, E-2, E-3 & E-4, as well as approval document mentioned above.

The submitted documentation was reviewed by Ishaq I. Chanda, P.E.



NOA No. 23-1207.13 Expiration Date: February 23, 2027 Approval Date: March 14, 2024 Page 1

NOTICE OF ACCEPTANCE: EVIDENCE SUBMITTED

1. Evidence submitted under previous approvals

A. DRAWINGS

- 1. Manufacturer's die drawings and sections (submitted under file listed below)
- 2. Drawing No. **AD11-04**, titled "Genstorm Opaque Inswing Door LMI", sheet 1 through 8 of 8, dated 02-02-12 and last revised on December 24, 2020, prepared by MCY Engineering, Inc, signed and sealed by Yiping Wang, P.E.

B. TESTS (submitted under file #11-0907.01)

- 1. Test reports on 1) Air Infiltration Test, per FBC, TAS 202-94
 - 2) Uniform Static Air Pressure Test, Loading per FBC, TAS 202-94
 - 3) Water Resistance Test, per FBC, TAS 202-94 (w/ PEMO 177 AT)
 - 4) Large Missile Impact Test per FBC, TAS 201-94
 - 5) Cyclic Wind Pressure Loading per FBC, TAS 203-94
 - 6) Forced Entry Test, per FBC 2411 3.2.1 and TAS 202-94
 - 7) Tensile Test, per ASTM A370-05

Along with marked-up drawings and installation diagram of Genstorm Opaque Double & Single Swinging Doors, prepared by Fenestration Testing Laboratory, Inc., Test Reports No(s). **6491**, dated 05/31/11, signed and sealed by Martin D. Brinson, P.E.

Note: This test report has addendum letter dated Nov 11, 2011 issued by Fenestration Testing lab, signed and sealed by Martin D. Brinson, P.E.

C. CALCULATIONS

Anchor verification calculations and structural analysis, complying with FBC-2014 (5th Edition), prepared by MCY Engineering, Inc., dated 12/20/16, signed and sealed by Yiping Wang, P.E.

D. QUALITY ASSURANCE

1. Miami Dade Department of Regulatory and Economic Resources (RER).

E. MATERIAL CERTIFICATIONS (submitted under file #11-0907.01)

- 1. Tensile Test, per ASTM A370-05 item B (1) (7)
- 2. Tensile test report N0. FTL 6745 per ASTM A370-05 dated 12/01/11, issued by Fenestration Testing Lab, signed and sealed by Martin D. Brinson, P.E.

F. STATEMENTS

- 1. Statement letter of conformance to FBC 2014 (5th Edition) and "No financial interest", dated 12/15/16, prepared by MCY Engineering, Inc, signed and sealed by Yiping Wang, P.E.
- 2. Statement letter of Lab. Compliance, as a part of above test reports.

G. OTHER

- 1. This NOA revises & renews NOA #11-0907.01, expiring on 02/23/22.
- 2. Test proposals # **10-0769R** dated 11/27/11 and e-mail 11/01/10 approved by PERA.
- 3. Distribution agreement between GenSteel Door, Canada & North American Door Corp, N.Y. dated 10/22/10, signed by Bruno Gervasi and Antonio Gervasi, respectively.

Shag 1. Chanda

NOTICE OF ACCEPTANCE: EVIDENCE SUBMITTED

2. Evidence submitted under NOA #18-0116.20

A. DRAWINGS

1. Drawing No. **AD11-04**, titled "Genstorm Opaque Inswing Door - LMI", sheet 1 through 8 of 8, dated 02-02-12 and last revised on JAN 02, 2018, prepared by MCY Engineering, Inc, signed and sealed by Yiping Wang, P.E.

B. Test

1. None.

C. CALCULATIONS

1. None.

D. QUALITY ASSURANCE

1. Miami Dade Department of Regulatory and Economic Resources (RER).

E. MATERIAL CERTIFICATIONS

1. None.

F. STATEMENTS

- 1. Statement letter of conformance to FBC 2017 (6th Edition), dated 01/02/18, prepared by MCY Engineering, Inc., signed and sealed by Yiping Wang, P.E.
- 2. E-mail statement letter dated 02/27/18 clarifying DWG changes, issued by MCY Engineering, Inc., signed by Yanet Pablos.

G. OTHER

1. This NOA revises NOA# 17-0130.02, expiring 02/23/22.

3. Evidence submitted under NOA #20-1230.07

A. DRAWINGS

1. Drawing No. **AD11-04**, titled "Genstorm Opaque Inswing Door - LMI", sheet 1 through 8 of 8, dated 02-02-12 and last revised on December 24, 2020, prepared by MCY Engineering, Inc, signed and sealed by Yiping Wang, P.E.

B. Test

1. None.

C. CALCULATIONS

1. None.

D. QUALITY ASSURANCE

1. Miami Dade Department of Regulatory and Economic Resources (RER).

E. MATERIAL CERTIFICATIONS

1. None.

F. STATEMENTS

1. Statement letter of conformance to FBC 2020 (7th Edition), dated 12/24/20, prepared by MCY Engineering, Inc., signed and sealed by Yiping Wang, P.E.

G. OTHER

1. This NOA revises NOA #18-0116.20, expiring 02/23/22.

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NOTICE OF ACCEPTANCE: EVIDENCE SUBMITTED

4. Evidence submitted under NOA#22-0330.01

A. DRAWINGS

1. Drawing No. **AD11-04**, titled "Genstorm Opaque Inswing Door - LMI", sheet 1 through 8 of 8, prepared by manufacture, signed and sealed by Gordon D. Thomas, P.E. on 03/23/2022.

B. Test

1. None.

C. CALCULATIONS

1. None.

D. QUALITY ASSURANCE

1. Miami Dade Department of Regulatory and Economic Resources (RER).

E. MATERIAL CERTIFICATIONS

1. None.

F. STATEMENTS

- 1. Statement letter of conformance to FBC 2020 (7th Edition) and no financial interest, dated 05/02/2022, signed and sealed by Gordon D. Thomas, P.E.
- 2. Successor Engineer Statement letter of adopting another Engineer's work dated 12/14/23 per FLA Administrative rule 61G15.27.001 and taking full responsibility, prepared, signed and sealed by Gordon D. Thomas, P.E. (submitted under file #23-1207.11)

G. OTHER

1. This NOA renews NOA #20-1230.07, expiring 02/23/22.

Ishag 1. Chanda

Ishaq I. Chanda, P.E. Product Control Unit Supervisor NOA No. 23-1207.13 Expiration Date: February 23, 2027 Approval Date: March 14, 2024

Gensteel Doors Inc.

NOTICE OF ACCEPTANCE: EVIDENCE SUBMITTED

4. New Evidence submitted

A. DRAWINGS

1. Drawing No. **AD11-04**, titled "Genstorm Opaque Inswing Door - LMI", sheet 1 through 8 of 8, dated 02/28/2024, prepared by manufacture, signed and sealed by Gordon D. Thomas, P.E. Note: This revision is FBC 2023 notes update only.

B. Test

1. None.

C. CALCULATIONS

1. None.

D. QUALITY ASSURANCE

1. Miami Dade Department of Regulatory and Economic Resources (RER).

E. MATERIAL CERTIFICATIONS

1. None.


- **F. STATEMENTS** (item # 5 was submitted under previous submittal)
 - 1. Statement letter of conformance to FBC 2023(8th Edition) dated 1/28/24, prepared, signed and sealed by Gordon D. Thomas, P.E.
 - 2. Successor Engineer Statement letter of adopting another Engineer's work dated 12/14/23 per FLA Administrative rule 61G15.27.001 and taking full responsibility, prepared, signed and sealed by Gordon D. Thomas, P.E.
 - 3. Statement letter of "No financial interest to the testing Lab" dated 12/14/23, prepared, signed and sealed by Gordon D. Thomas, P.E
 - 4. Statement letter, no changes other than title block, prepared, signed and sealed by Gordon D. Thomas, P.E.
 - 5. Distribution agreement dated JAN 26, 2021 between Gensteel Doors, Inc., Canada & North American Door Corp, N.Y. (dba Gensteel Doors, LLC, USA), signed by Bruno Gervasi, VP manufacturing and Antonio Gervasi, President, respectively on behalf of their companies.


G. OTHER

1. This NOA revises NOA #22-0330.01, updates to FBC 2023, expiring 02/23/27.

Isheg 1. Chande

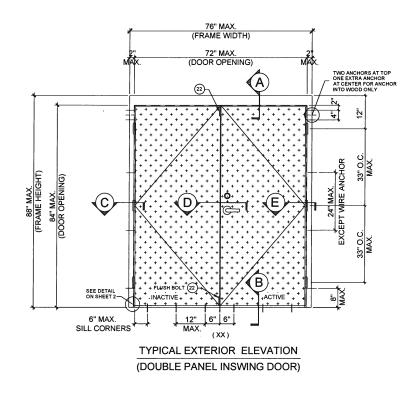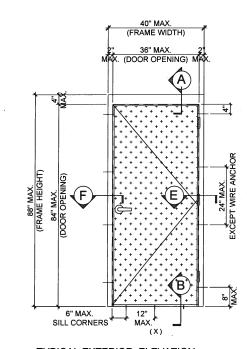Ishaq I. Chanda, P.E. Product Control Unit Supervisor NOA No. 23-1207.13 Expiration Date: February 23, 2027 Approval Date: March 14, 2024





TYPICAL EXTERIOR ELEVATION (SINGLE PANEL INSWING DOOR)

PRODUCT REVISED as complying with the Florida Building Code NOA-No. 23-1207.13 Expiration Date 02/23/2027

By

SERIES GENSTORM OPAQUE OUTSWING STEEL DOOR (LMI)

- THIS PRODUCT HAS BEEN DESIGNED AND TESTED TO COMPLY WITH THE REQUIREMENTS OF THE 8TH EDITION FLORIDA BUILDING CODE (2023) INCLUDING HIGH VELOCITY HURRICANE ZONE (HVHZ).

- DOORS RATED FOR LARGE MISSILE IMPACT AND DO NOT REQUIRE SHUTTERS.
- SEE DOOR DESIGN LOAD CHART FOR APPLICABLE WATER RATING WITH SILL PEMKO 177-AT OR PEMKO 2005 AT
- ANCHORS SHALL BE AS LISTED, SPACED AS SHOWN ON DETAILS. ANCHORS EMBEDMENT TO BASE MATERIAL SHALL BE BEYOND WALL DRESSING OR STUCCO.
- ANCHORING OR LOADING CONDITIONS NOT SHOWN IN THESE DETAILS ARE NOT PART OF THIS APPROVAL.
- MATERIALS INCLUDING BUT NOT LIMITED TO STEEL/METAL SCREWS THAT COME INTO CONTACT WITH OTHER DISSIMILAR MATERIALS SHALL MEET THE REQUIREMENTS OF THE 8TH EDITION FLORIDA BUILDING CODE (2023) SECTION AS APPLICABLE.
- METAL STRUCTURES NOT BY GENSTEEL DOOR CO. MUST SUPPORT LOADS IMPOSED BY DOOR SYSTEM AND TRANSFER THEM TO THE BUILDING STRUCTURE.

WOOD BUCKS BY OTHERS MUST BE ANCHORED PROPERLY TO TRANSFER LOADS TO THE STRUCTURE.

A LOAD DURATION FACTOR IN ALLOWABLE STRESS IS USED IN DESIGN OF ANCHORS INTO WOOD ONLY.

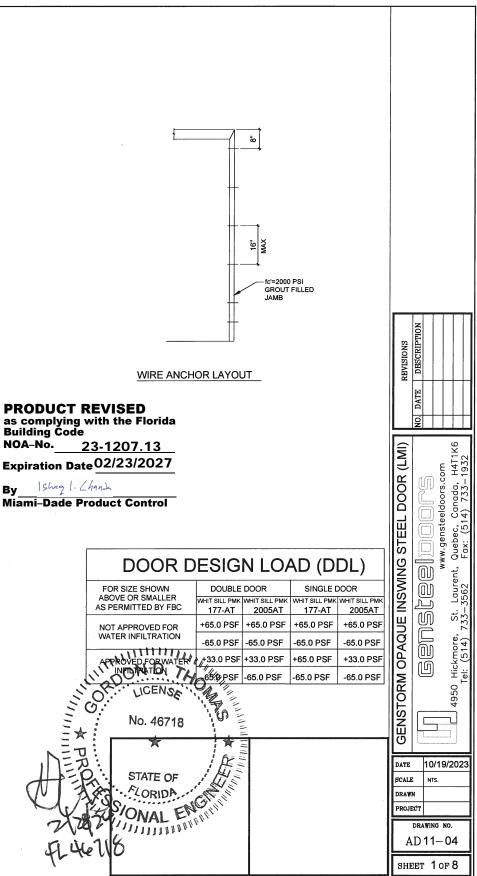
DOOR PANEL: MIN. 20 GA. STEEL MIN. Fy = 47.3 KSI MIN., DOOR FRAME: MIN. 18 GA. STEEL MIN. Fy = 47.3 KSI MIN.

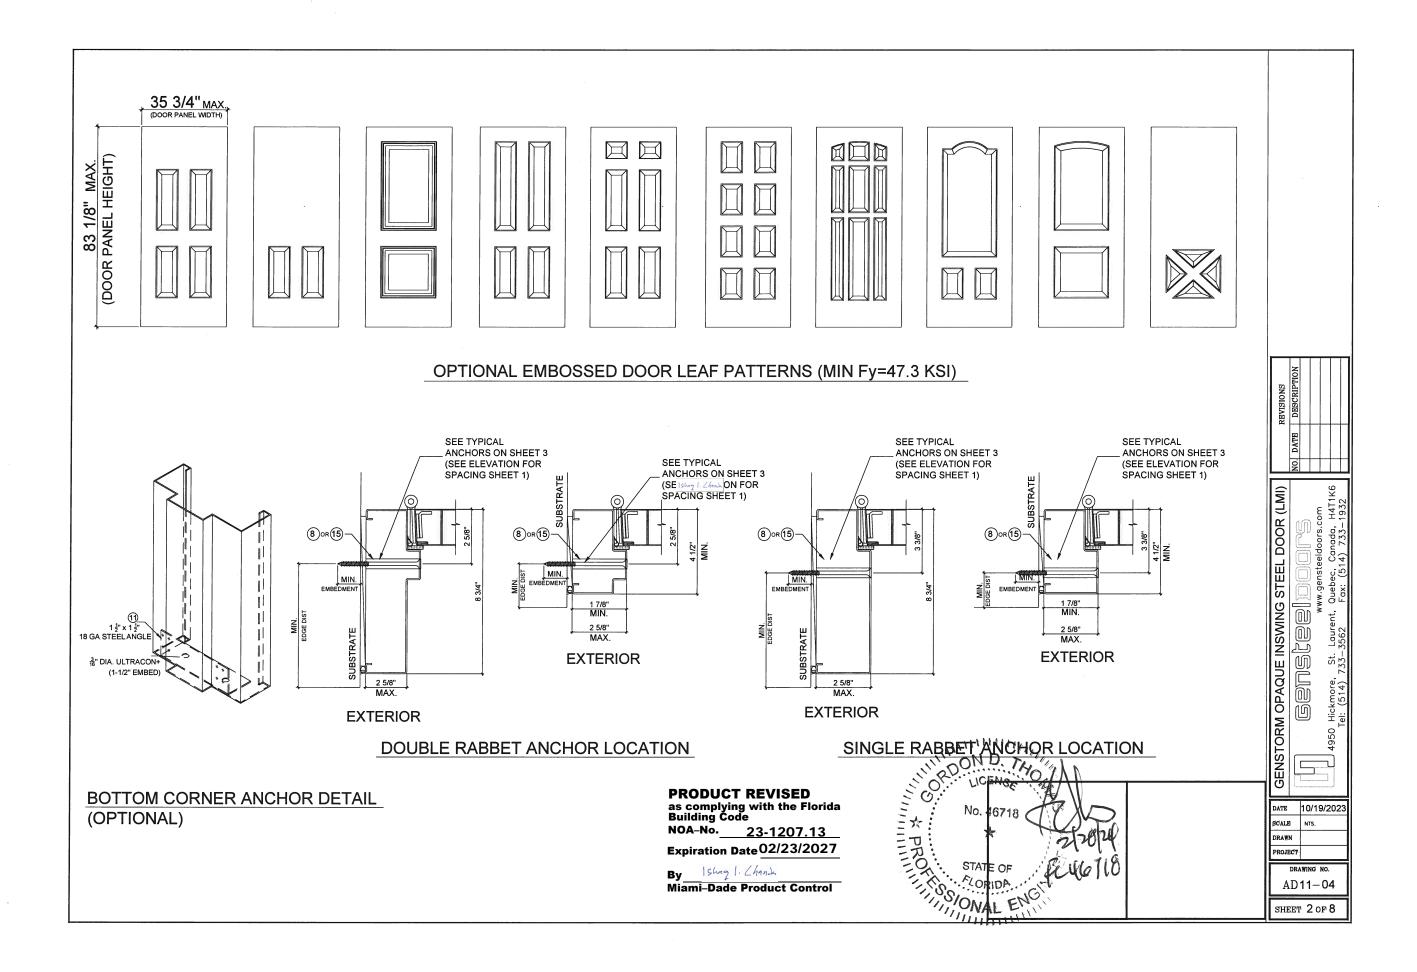
DOOR PANEL STAINLESS OPTION: 20 GA. STAINLESS STEEL DOOR PANEL MEETING MIN. Fy = 47.3 KSI, . OR BETTER MAY QUALIFY HAVING "MIL-CERTIFICATE" AS A VERIFICATION OF THE AVAILABLE MIN. YIELD STRENGTH.

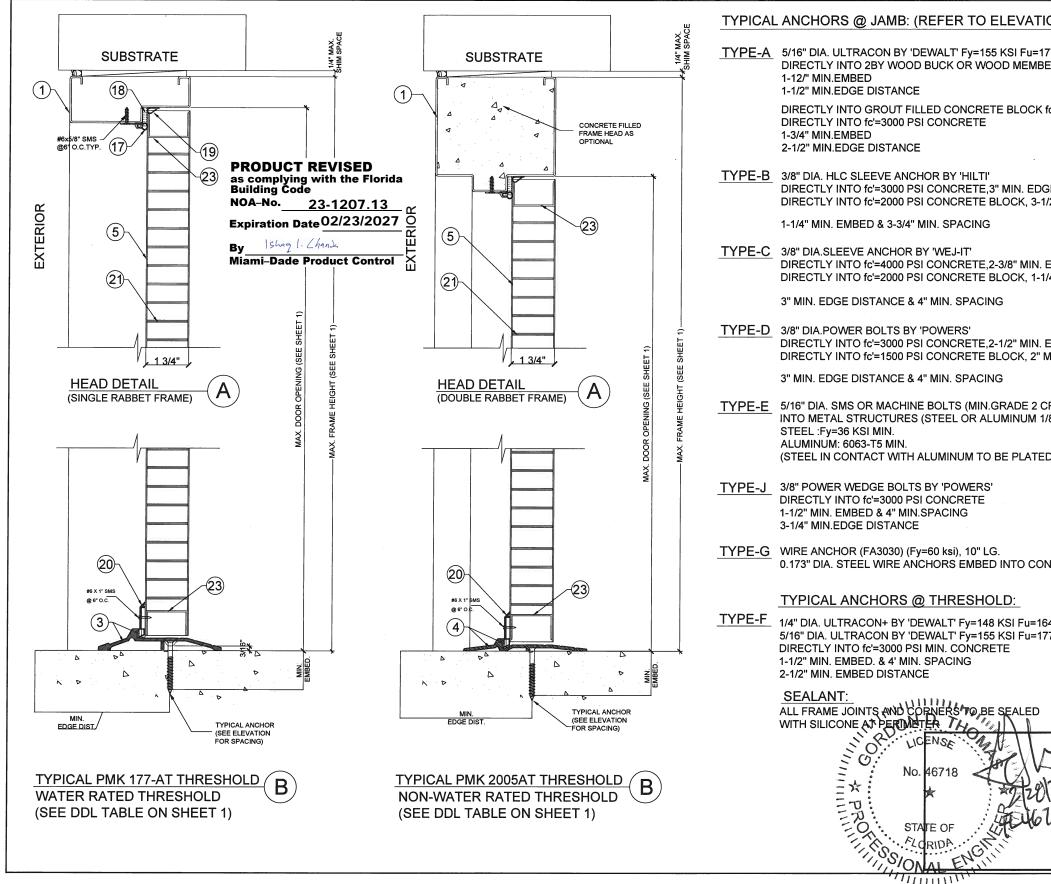
DOOR PANEL STAINLESS OPTION: 18 GA STAINLESS STEEL DOOR PANEL MEETING MIN Fy = 47.3KSI OR BETTER MAY QUALIFY HAVING "MIL-CERTIFICATE" AS A VERIFICATION OF THE AVAILABLE MIN. YIELD STRENGTH.

NOTES:

EGRESS REQUIREMENTS TO BE REVIEWED BY BUILDING OFFICIAL.









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ON FOR SPACING)	
77 KSI ERS SG=0.55	
fc'=2000 PSI	
GE DISTANCE /2" MIN. EDGE DISTANCE	
EMBED /4" MIN. EMBED	
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CRS) OR ST/ST /8" MIN. THICK)	
D OR PAINTED)	DR (LMI)
NCRETE BLOCK 54 KSI OR 77 KSI	GENSTORM OPAQUE INSWING STEEL DOOR (LMI) GENSTORM OPAQUE INSWING STEEL DOOR (LMI) Beneficial and the state of the state
\neg	DATE 10/19/2023 SCALE NTS.
(24 1.15	DRAWN PROJECT
1.10	drawing no. AD 11-04
	SHEET 3 OF 8



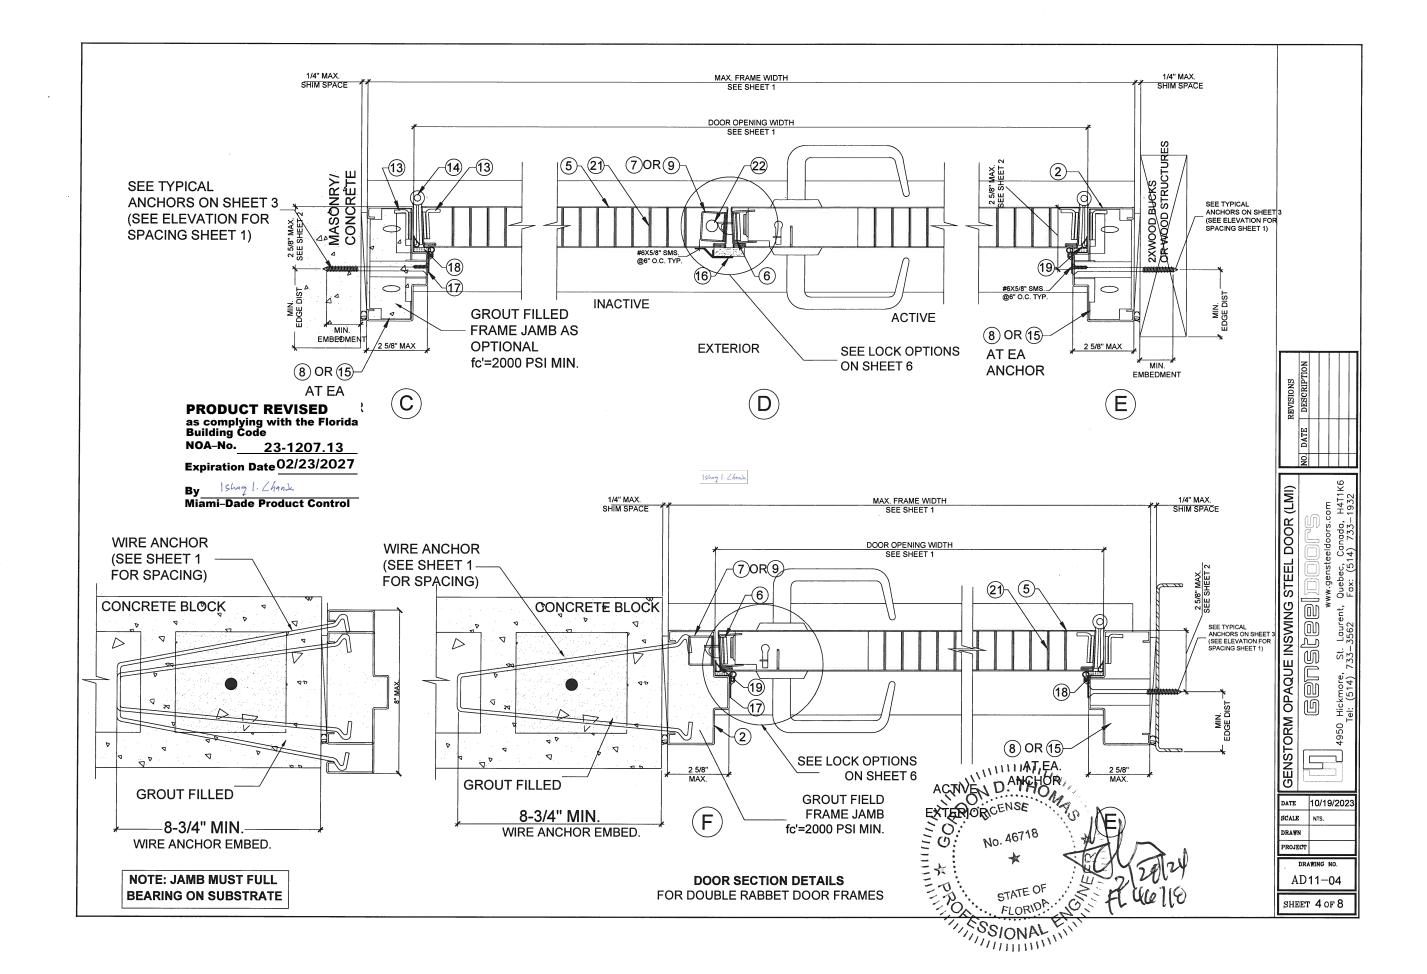

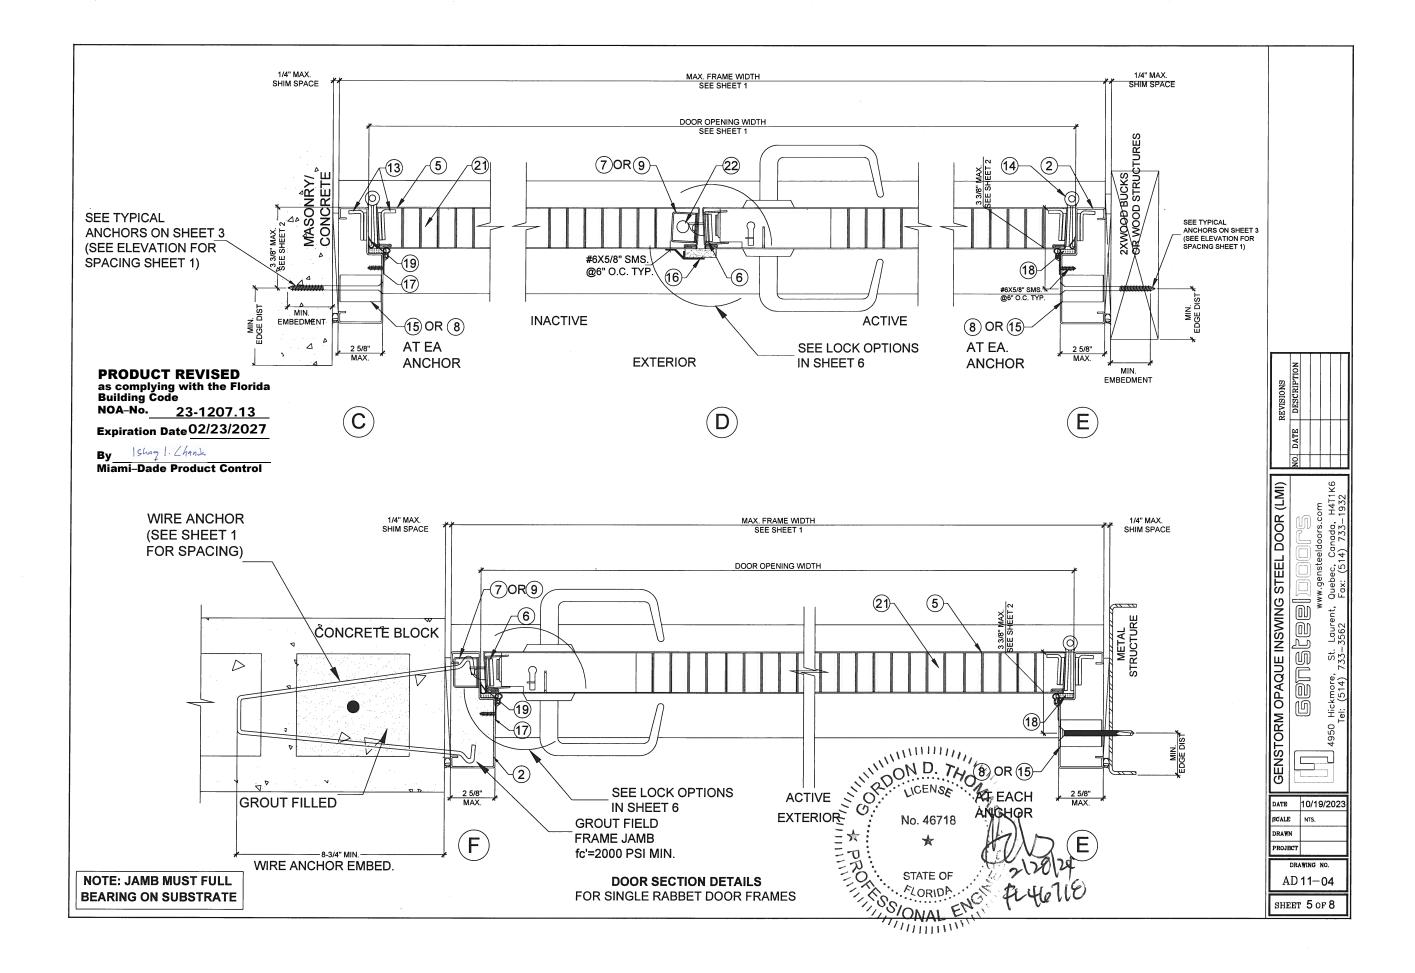LOCK OPTIONS LOCK OPTIONS FOR DOUBLE DOORS ACTIVE PANEL CAN APPLY TO SINGLE DOORS. (EXTERIOR ELEVATIONS - INSWING DOORS) **OPTION 1 OPTION 4** ACTIVE LEAF: ACTIVE LEAF: DOREX 12 SERIES LOCK SET 40 5/16" FROM BOTTOM

INACTIVE LEAF: STRIKE FOR LOCKSET. IVES FB 458 MANUAL FLUSH BOLT (TOP& BOTTOM)

OPTION 2

ACTIVE LEAF: SCHLAGE AL SERIES LOCK SET. 40 5/16" FROM BOTTOM. **&SCHLAGE B SERIES DEADLOCK.** 46 5/16" FROM BOTTOM.

INACTIVE LEAF: STRIKE FOR LOCKSET. STRIKE FOR DEADLOCK. IVES FB 458 MANUAL FLUSH BOLT TOP& BOTTOM

OPTION 3

ACTIVE LEAF:

DOREX FH SERIES LOCKSET, 40 5/16" FROM BOTTOM. DOREX TLA SERIES DEADLOCK, 46 5/16" FROM BOTTOM.

INACTIVE LEAF:

STRIKE FOR LOCKSET. STRIKE FOR DEADLOCK. **IVES FB 458 MANUAL FLUSH BOLT** TOP& BOTTOM

HINGES: STEEL BUTT HINGES 3 PER LEAF LOCATED AT 12" MAX. FROM TOP OF THE DOOR TO CENTER LINE OF 1ST HINGE AND TO BE SPACED OUT NOT TO EXCEED 33" FROM CL TO CL OF HINGE. TO BE FASTENED BY (4)#12-24 X 1/2" FLATHEAD MACHINE SCREWS.

HARDWARE LOCATIONS: ALL THESE DOORS WERE MANUFACTURED WITH THE CYLINDRICAL, LEVER, OR KNOBS AT 40-5/16" C.L. FROM THE BOTTOM OF THE FRAME. ALL THE DEADLOCKS WERE POSITIONED 46-5/16" FROM THE BOTTOM OF THE FRAME.

PRODUCT REVISED as complying with the Florida Building Code

By Ishag I. Chanda



OPTION 6

OPTION 5

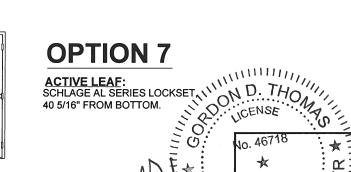
40 5/16" FROM BOTTOM.

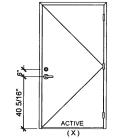
DOREX FHA SERIES LOCKSET,

ACTIVE LEAF:


ACTIVE LEAF:

DOREX FH SERIES LOCKSET. 40 5/16" FROM BOTTOM. DOREX TLA SERIES DEADLOCK, 46 5/16" FROM BOTTOM.





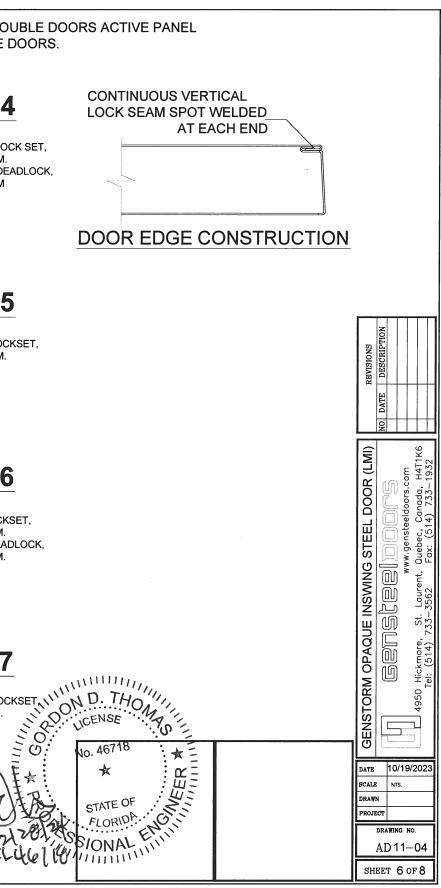SCHLAGE AL SERIES LOCK SET, 40 5/16" FROM BOTTOM. **&SCHLAGE B SERIES DEADLOCK**, 46 5/16" FROM BOTTOM




ACTIVE INACTIVE FLUSH BOLT (XX)

`___ (XX)

FLUSH BOLT

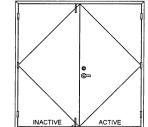ACTIVE



FLUSH BOLT ____(XX)

NOA-No. 23-1207.13 Expiration Date02/23/2027

ACTIVE

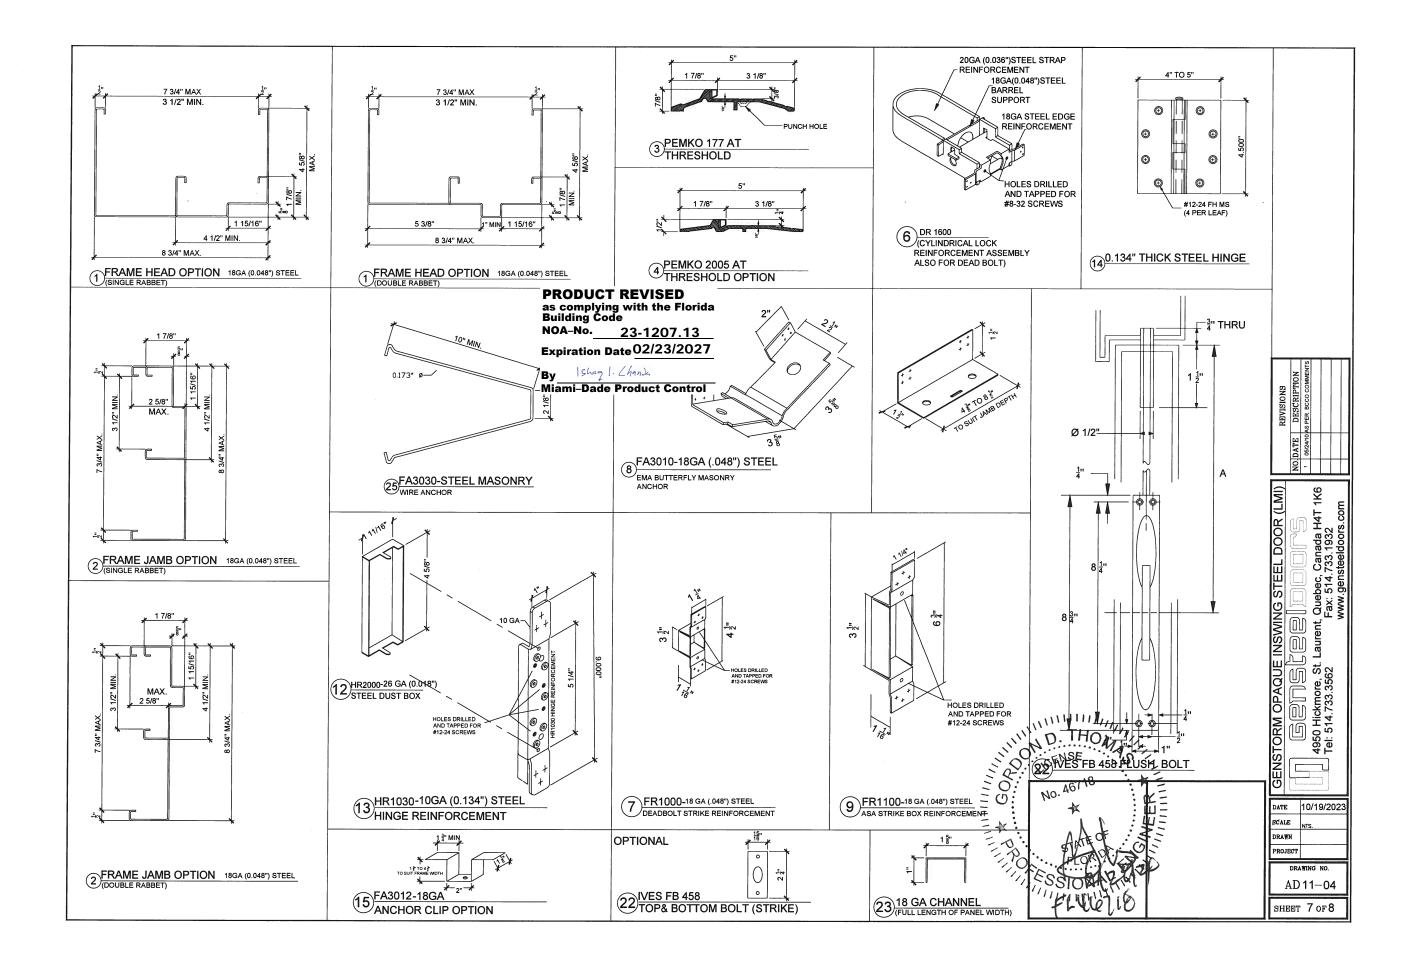
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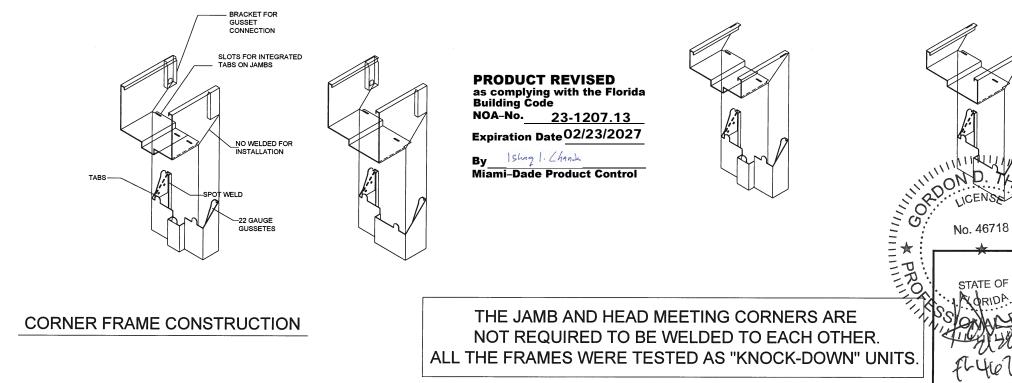
ACTIVE

(X)

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				BILL OF MATERIALS	
ITEM	PART NO.	MATERIAL	QTY.	DESCRIPTION	MANUFACTURER/SUPPLI
1		STEEL OR ST/ST	AS REQD.	FRAME HEAD	18GA (0.048MIN) Fy=47.3 KS
2		STEEL OR ST/ST	AS REQD.	FRAME HEAD	18GA (0.048MIN) Fy=47.3 KS
3	PMK177-AT	ALUM	1	THRESHOLD WITH THERMO SEAL INSERT	PEMKO 177AT
4	PMK 2005AT	ALUMINUM	1	OPTIONAL THRESHOLD WITH THERMO SEAL INSERT	PEMKO 2005AT
5		STEEL OR ST/ST	AS REQD.	DOOR PANEL 1 3/4" THK.	20GA. (0.036 MIN) Fy=47.3 KS
6	DR1600	STEEL	AS REQD.	CYLINDRICAL LOCK REINFORCEMENT	GENSTEEL PROGRESSION WELD
7	FR1000	STEEL	AS REQD.	DEAD BOLT STRIKE REINFORCEMENT	GENSTEEL PROGRESSION WELD
8	FA3010	STEEL	AS REQD.	BUTTERFLY MASONRY ANCHOR	GENSTEEL
9	FR1100	STEEL	AS REQD.	ASA STRIKE BOX	GENSTEEL PROGRESSION WELDED TO THE
10	FA3030	STEEL	AS REQD.	MASONRY WIRE ANCHOR 0.173 DIA.	GESNSTEEL Fy=60 KSI Fv=
11	FA1040	STEEL	2	FLOOR ANCHOR 18 GA (1-1/2" X 1-1/2") (OPTION)	GENSTEEL
12	HR2000	STEEL	3 PER LEAF	HINGE DUST BOX	GENSTEEL
13	HR1030	STEEL	3 PER LEAF	HINGE REINFORCEMENT WELDED TO FRAME AND DOOR	GENSTEEL PROGRESSION WELDED TO THE
14	HINGE	STEEL	3 PER LEAF	4 1/2" LONG HINGE	HAGER USA OR EQU
15	FA3012	STEEL	AS REQD.	ANCHOR CLIP (OPTION)	HGENSTEEL PROGRESSION WEL
16	PEMKO P375R		AS REQD.	PEMKO 375R ASTRAGAL WITH SPONGENEOPRENE	PEMKO (WITH #6X5/8" ST/ST S
17	PEMKO 303_S	STEEL	AS REQD.	PERIMETER GASKETING WEATHERSTRIP ADAPTER	PEMKO (WITH #6X5/8" ST/ST S
18	PEMKO 387		AS REQD.	ADHESIVE CLOSED CELL SPONGE WEATHERSTRIP	РЕМКО
19	PEMKO 88	SILICONSEAL TM	AS REQD.	ADHESIVE GASKETING WEATHERSTRIP	РЕМКО
20	PEMKO 315_N		1 PER LEAF	DOOR SWEEP WEATHERSTRIP AT BOTTOM OF PANEL	PEMKO (WITH #6X1" ST/ST SM
21	HONEYCOMB CORE		AS REQD.	INSIDE OF DOOR PANEL	GENSTEEL
22	IVES FB 458	STEEL	AS REQD.	IVES TOP & BOTTOM FLUSH BOLTS	IVES
23	CH3601	STEEL	AS REQD.	1" X 1-5/8" X 1" X 18GA DOOR END CHANNEL	GENSTEEL



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