

DEPARTMENT OF REGULATORY AND ECONOMIC RESOURCES (RER) BOARD AND CODE ADMINISTRATION DIVISION

### **NOTICE OF ACCEPTANCE (NOA)**

PRODUCT CONTROL SECTION 11805 SW 26 Street, Room 208 T (786) 315-2590 F (786) 315-2599

www.miamidade.gov/economy

**MIAMI-DADE COUNTY** 

Shanghai Superhouse Building Material Co., Ltd Level 5, Unit 10, No. 8666 Hunan highway Road, PuDong New Area, Shanghai, China, 201314

### SCOPE:

This NOA is being issued under the applicable rules and regulations governing the use of construction materials. The documentation submitted has been reviewed and accepted by Miami-Dade County RER -Product Control Section to be used in Miami Dade County and other areas where allowed by the Authority Having Jurisdiction (AHJ).

This NOA shall not be valid after the expiration date stated below. The Miami-Dade County Product Control Section (In Miami Dade County) and/or the AHJ (in areas other than Miami Dade County) reserve the right to have this product or material tested for quality assurance purposes. If this product or material fails to perform in the accepted manner, the manufacturer will incur the expense of such testing and the AHJ may immediately revoke, modify, or suspend the use of such product or material within their jurisdiction. RER reserves the right to revoke this acceptance, if it is determined by Miami-Dade County Product Control Section that this product or material fails to meet the requirements of the applicable building code.

This product is approved as described herein and has been designed to comply with the Florida Building Code, including the High Velocity Hurricane Zone.

DESCRIPTION: Series "SPA 100 & SPA 150" Aluminum Sliding Glass Door - L.M.I.

**APPROVAL DOCUMENT:** Drawing No. **AD 22-33**, titled "SPA 100 & SPA 150 Aluminum Sliding Glass Door (L.M.I.)", sheets 1 through 17 of 17, dated 01/19/2023 with revision "R2" dated 12/22/2023, prepared by MCY Engineering, Inc., signed and sealed by Yipping Wang, P.E., bearing the Miami-Dade County Product Control **Revision** stamp with the Notice of Acceptance number and expiration date by the Miami-Dade County Product Control Section.

## MISSILE IMPACT RATING: Large and Small Missile Impact Resistant

- 1. See sheet **2**, **3** and **4** for Design Pressure (DP) based on glazing options, frame sizes, threshold adapters and Hardware options.
- 2. Max. DP= +90 PSF requires use of threshold adapter (part #9A) limited to tested frame size.

**LABELING:** Each unit shall bear a permanent label with the manufacturer's name or logo, **Shanghai, China**, series, and the following statement: "Miami-Dade County Product Control Approved", unless otherwise noted herein.

**RENEWAL** of this NOA shall be considered after a renewal application has been filed and there has been no change in the applicable building code negatively affecting the performance of this product.

**TERMINATION** of this NOA will occur after the expiration date or if there has been a revision or change in the materials, use, and/or manufacture of the product or process. Misuse of this NOA as an endorsement of any product, for sales, advertising or any other purposes shall automatically terminate this NOA. Failure to comply with any section of this NOA shall be cause for termination and removal of NOA.

**ADVERTISEMENT:** The NOA number preceded by the words Miami-Dade County, Florida, and followed by the expiration date may be displayed in advertising literature. If any portion of the NOA is displayed, then it shall be done in its entirety.

**INSPECTION:** A copy of this entire NOA shall be provided to the user by the manufacturer or its distributors and shall be available for inspection at the job site at the request of the Building Official.

This NOA revises NOA#23-0119.02 and consists of this page 1 and evidence pages E-1 & E-2, as well as approval document mentioned above.

The submitted documentation was reviewed by Sifang Zhao, P.E.



*5,2*. 02/29/2024

NOA No. 23-1222.13 Expiration Date: March 09, 2028 Approval Date: February 29, 2024

Page 1

### NOTICE OF ACCEPTANCE: EVIDENCE SUBMITTED

### A. DRAWINGS

- 1. Manufacturer's die drawings and sections. (Submitted under NOA #23-0119.02)
- 2. Drawing No. **AD 22-33**, titled "SPA 100 & SPA 150 Aluminum Sliding Glass Door (L.M.I.)", sheets 1 through 17 of 17, dated 01/19/2023 with revision "R2" dated 12/22/2023, prepared by MCY Engineering, Inc., signed and sealed by Yipping Wang, P.E.

### B. TESTS

- 1. Test reports on: 1) Air Infiltration Test, per FBC, TAS 202-94
  - 2) Uniform Static Air Pressure Test, Loading per FBC, TAS 202-94
  - 3) Water Resistance Test, per FBC, TAS 202-94
  - 4) Forced Entry Test, per FBC, and TAS 202-94
  - 5) Large Missile Impact Test per FBC, TAS 201-94
  - 6) Cyclic Wind Pressure Loading per FBC, TAS 203-94

along with marked-up drawings and installation diagram of an aluminum sliding glass door, prepared by Intertek Testing, Shanghai, China., Test Report No(s) #190904008SHF-001 dated 11/27/2019 and #21071600SHF-001, dated 03/28/2022, signed and sealed by Vinu Abraham, P.E. (Submitted under NOA #23-0119.02)

### C. CALCULATIONS

- 1. Anchor verification calculations and structural analysis, complying with FBC-7<sup>th</sup> Edition dated 01/03/23, prepared by MCY Engineering, Inc., signed and sealed by Yipping wang, P.E. (*Submitted under NOA #23-0119.02*)
- 2. Glazing complies with ASTM E1300-04, -09 & -16.

### D. QUALITY ASSURANCE

1. Miami-Dade Department of Regulatory and Economic Resources (RER).

### E. MATERIAL CERTIFICATIONS

- 1. NOA No. 23-0717.30 issued to Kuraray America, Inc. for their "SentryGlas (Clear and White) Interlayer", dated 08/31/23, expiring on 07/04/28.
- 2. Notice of Acceptance No. **21-0216.01** issued to Eastman Chemical Company (MA) (Former Solutia, Inc.) for the "**Saflex Clear and Color Glass Interlayers**", expiring on 05/21/26.

0

Sifang Zhao, P.E. Product Control Examiner NOA No. 23-1222.13 Expiration Date: March 09, 2028 Approval Date: February 29, 2024

### Shanghai Superhouse Building Material Co., Ltd

### NOTICE OF ACCEPTANCE: EVIDENCE SUBMITTED

### F. STATEMENTS

- 1. Statement letter of conformance to **FBC** 8<sup>th</sup> **Edition** (2023) and of no financial interest, issued by MCY Engineering, Inc., dated 12/22/2023, signed and sealed by Yiping Wang, P. E.
- 2. Distributor Agreement, between manufacturer Shanghai Superhouse Bldg. Material Co., China and CasaNoah Design Group, LLC, USA (Distributor), signed by Lilian Li, director and Bin Lin, director on behalf of their respective companies.

  (Submitted under NOA #23-0119.02)


### G. OTHER

1. This NOA revises NOA #23-0119.02, expiring on 03/09/2028, for FBC 8<sup>th</sup> Edition (2023) update.

00

Sifang Zhao, P.E. Product Control Examiner NOA No. 23-1222.13 Expiration Date: March 09, 2028 Approval Date: February 29, 2024

# SHANGHAI SUPERHOUSE BUILDING MATERIAL CO., LTD. SERIES SPA I OO AND SPA I 50 SLIDING GLASS DOOR - L.M.I.

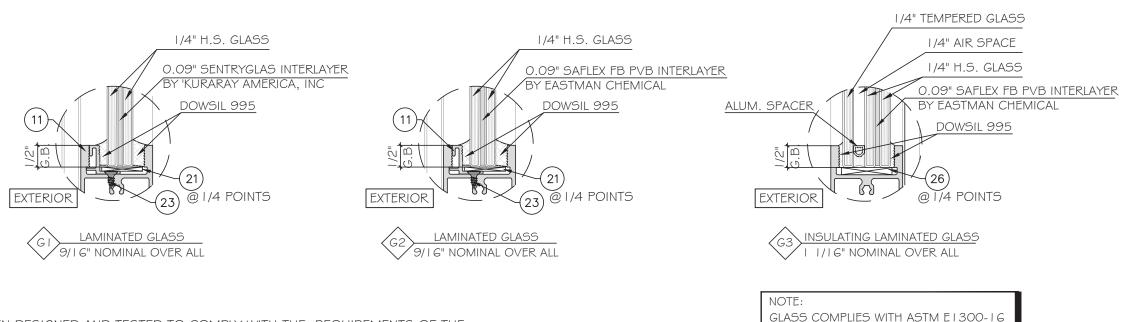

### GENERAL NOTES:

- THIS PRODUCT HAS BEEN DESIGNED AND TESTED TO COMPLY WITH THE REQUIREMENTS OF THE 8TH EDITION FLORIDA BUILDING CODE (2023) INCLUDING HIGH VELOCITY HURRICANE ZONE (HVHZ).
- DOORS RATED FOR LARGE MISSILE IMPACT. LMI SYSTEM TO BE USED FOR INSTALLATIONS UP TO 30 FT AND CAN BE USED ABOVE 30 FT OF GRADE. IMPACT SHUTTERS ARE NOT REQUIRED.
- THESE DOORS ARE APPROVED FOR AIR AND WATER INFILTRATION.
- ANCHORS SHALL BE AS LISTED, SPACED AS SHOWN ON DETAILS. ANCHORS EMBEDMENT TO BASE MATERIAL SHALL BE BEYOND WALL DRESSING OR STUCCO.
- ANCHORING OR LOADING CONDITIONS NOT SHOWN IN THESE DETAILS ARE NOT PART OF THIS APPROVAL.
- MATERIALS INCLUDING BUT NOT LIMITED TO STEEL/ METAL SCREWS THAT COME INTO CONTACT WITH OTHER DISSIMILAR MATERIALS SHALL MEET THE REQUIREMENTS OF THE 8TH EDITION FLORIDA BUILDING CODE (2023) SECTION AS APPLICABLE
- METAL STRUCTURES BY OTHERS TO BE DESIGNED TO SUPPORT THE LOADS IMPOSED BY THIS GLAZING SYSTEM AND TO TRANSFER SUCH LOADS TO THE BUILDING MAIN STRUCTURE.
- ULTIMATE LOAD OBTAINED FROM ASCE 7-22 APPLICABLE LOAD COMBINATION EQUATIONS. MULTIPLY BY 0.6 SHALL BE LESS THAN OR EQUAL TO MAX. DESIGN LOAD IN THIS DOCUMENT. THE DESIGN LOADS SHOWN IN THIS DOCUMENT ARE ALLOWABLE DESIGN LOADS.
- MANUFACTURER'S LABEL SHALL BE LOCATED ON A READILY VISIBLE LOCATION IN ACCORDANCE WITH SECTION 1709.9.3 OF FLORIDA BUILDING CODE LABELING TO COMPLY WITH SECTION 1709.9.2.

### -SEALANTS:

ALL FRAME CORNERS, JOINTS, MULLION SEAMS AND PERIMETER GLAZING BEAD TO FRAME INSTALLATION FASTENERS SEALED WITH SILICON SEALANT.

USE CHARTS AS FOLLOWS.

DETERMINE DESIGN WIND LOAD REQUIREMENTS BASED ON WIND STEP 1: VELOCITY, BLDG. HEIGHT, WIND ZONE USING APPLICABLE ASCE 7-22 STANDARD OR WIND TUNNEL REPORTS

SEE SHEET E | \$ E2 \$ E3 FOR TYPICAL SLIDING DOOR ELEVATION. STEP 2:

STEP 3: SEE SHEET A | \$ A2 FOR ANCHOR OPTIONS. SEE SHEET E | \$ E2 \$ E3 FOR ANCHOR LAYOUT.

(3 SEC. GUSTS).

STEP4: THE LOWEST VALUE RESULTING FROM STEPS 2 \$ 3 THAT EXCEED THE DESIGN WIND PRESSURES DETERMINED THOUGH STEP | SHALL APPLY TO

ENTIRE SYSTEM

- ON CENTER

O.C.

ABBREVIATIONS AND SYMBOLS D.L.O. - DAYLITE OPENING SECTION NUMBER F.H. - FRAME HEIGHT F.W. - FRAME WIDTH - WITH SHEET NUMBER W/O - WITHOUT

**PRODUCT REVISED** Expiration Date 03/09/2028

MIAMI-DADE COUNTY


Miami-Dade Product Control

ENGINEERING, MCY

SHANGHAI SUPERHOUSE BUILDING MATERIAL CO., LTD LEVEL 5, BUILDING 10, NO.8666 HUNAN RD, PUDONG NEW AREA

AD22-33

**COVER** 

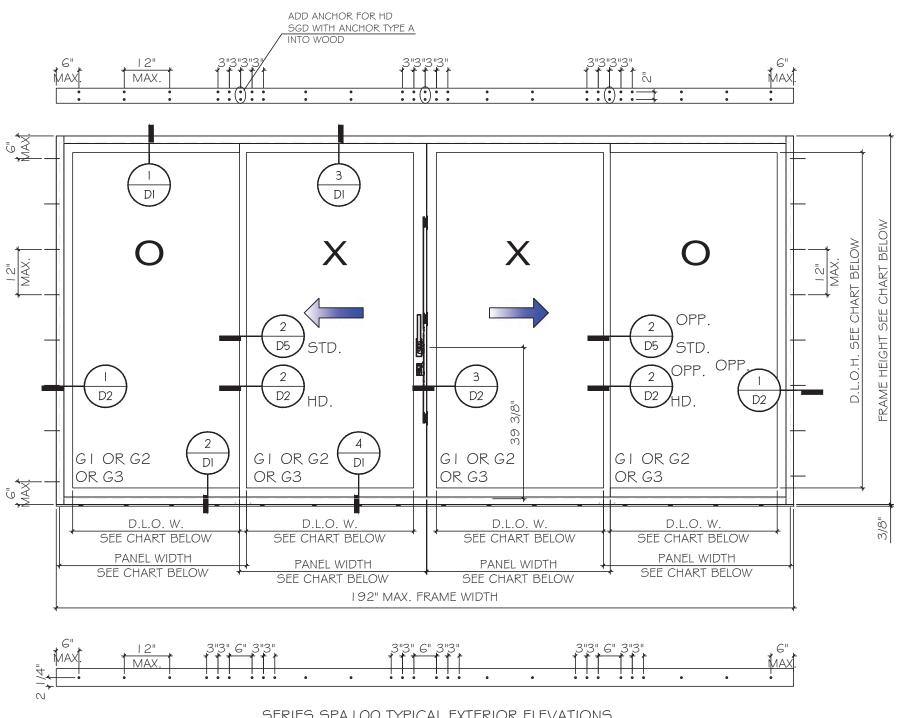

## SERIES SPA I OO TYPICAL EXTERIOR ELEVATIONS

### TWO TRACK OXXO


	DIME	ENSIONS	DIMEN	SIONS		DESIGN LOADS (PSF)		HARDWARE OPTION	
GLASS TYPE	PANEL WIDTH MAX.	FRAME HEIGHT MAX.	D.L.O.W. MAX.	D.L.O.H. MAX.	INTERLOCK OPTION			(SEE SHEET 12 FOR COMPOSITION)	
	IN.	IN.	IN.	IN.		EXT. (+)	INT. (-)	COMI OSITION)	
GI	48 5/8"	96"	43 1/2"	87 3/8"	HD	90	110	#  \$ #2	
G1,G2,G3	48 5/8"	96"	43 1/2"	87 3/8"	STD	65	65	#3	
G3	48 5/8"	108"	43 1/2"	99 3/8"	HD	65	65	#	

NOTE: FOR SIZE SHOWN ABOVE OR SMALLER AS PERMITTED BY FBC

HARDWARE OPTION #1:MULTI-POINT LOCK BY SIEGA.


HARDWARE OPTION #2:DUAL POINT MORTISE LOCK BY DNW.

HARDWARE OPTION #3:DUAL MORTISE LOCK BY MUTU.

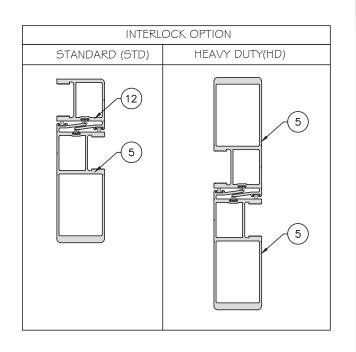

THRESHOLD OPTION			
OPTION I	OPTION 2		
9	(9A)		
DESIGN LOAD +65 PSF	DESIGN LOAD +90 PSF		



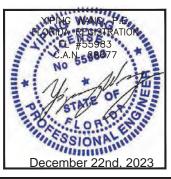

			UPDATE FB	Descriptio
			James	Drawn By
			12.22.2023	Date
			R2	Rev. No.
Drawn Date 12.22.2023			SCA AS SI	HOWN

MCY ENGINEERING, INC. GLAZING CONSULTANTS

SERIES SPA100 AND SPA150 SLIDING GLASS DOOR - L.M.I


SHANGHAI SUPERHOUSE BUILDING MATERIAL CO., LTD LEVEL 5, BUILDING 10, NO.8666 HUNAN RD, PUDONG NEW AREA

12781 MIRAMAR PKWY.

AD22-33

E1

Sheet No. 2 OF 17

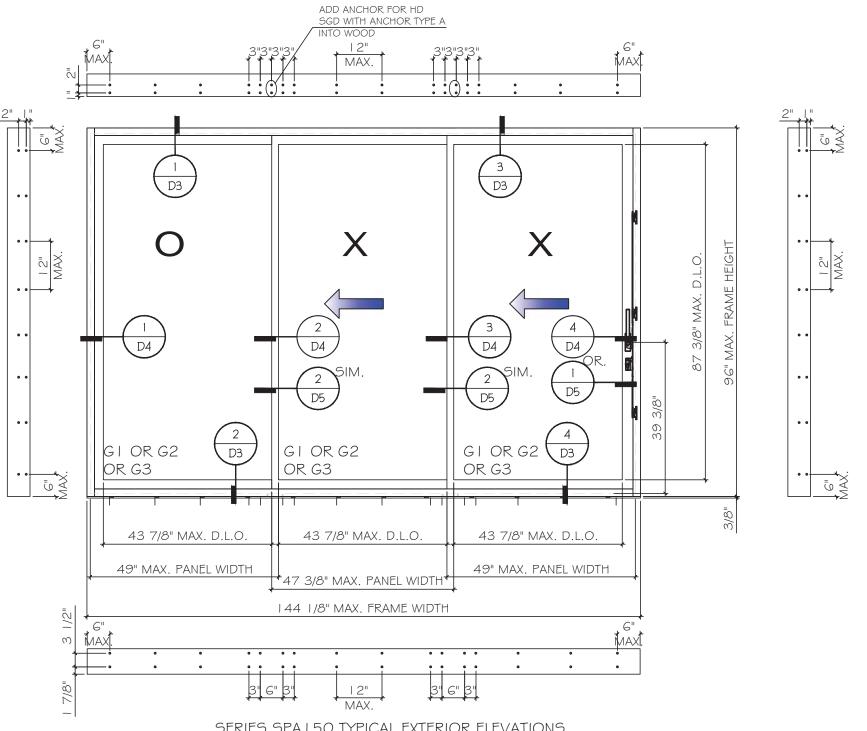


## SERIES SPA I 50 TYPICAL EXTERIOR ELEVATIONS

### THREE TRACK OXX/XXO


	DIME	DIMENSIONS		DIMENSIONS				HARDWARE OPTION
GLASS TYPE	PANEL WIDTH MAX.	FRAME HEIGHT MAX.	D.L.O.W. MAX.	D.L.O.H. MAX.	INTERLOCK OPTION	DESIGN LOADS (PSF)		(SEE SHEET 12 FOR COMPOSITION)
	IN.	IN.	IN.	IN.		EXT. (+)	INT. (-)	
GI	49"	96"	43 7/8"	87 3/8"	HD	90	110	#  \$ #2
G1,G2,G3	49"	96"	43 7/8"	87 3/8"	STD	65	65	#3

NOTE: FOR SIZE SHOWN ABOVE OR SMALLER AS PERMITTED BY FBC HARDWARE OPTION # I :MULTI-POINT LOCK BY SIEGA. HARDWARE OPTION #2:DUAL POINT MORTISE LOCK BY DNW. HARDWARE OPTION #3:DUAL MORTISE LOCK BY MUTU.

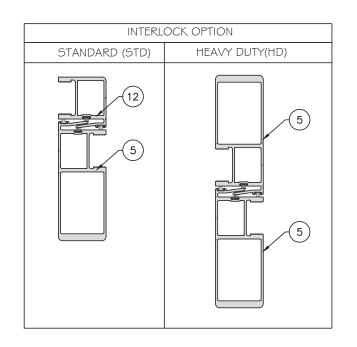

THRESHOLD OPTION				
OPTION I	OPTION 2			
9	9A			
DESIGN LOAD +65 PSF	DESIGN LOAD +90 PSF			

MIAMI-DADE COUNTY **PRODUCT REVISED** as complying with the Florida Building Code 23-1222.13 NOA-No. Expiration Date 03/09/2028By Miami-Dade Product Control

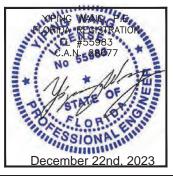


12.22.2023 AD22-33

SERIES SPA100 AND SPA150 SLIDING GLASS DOOR - L.M.I

SHANGHAI SUPERHOUSE BUILDING MATERIAL CO., LTD LEVEL 5, BUILDING 10, NO.8666 HUNAN RD, PUDONG NEW AREA

MCY ENGINEERING, INC. GLAZING CONSULTANTS 12781 MIRAMAR PKWY. STE. 301

E2 Sheet No. 3 OF 17

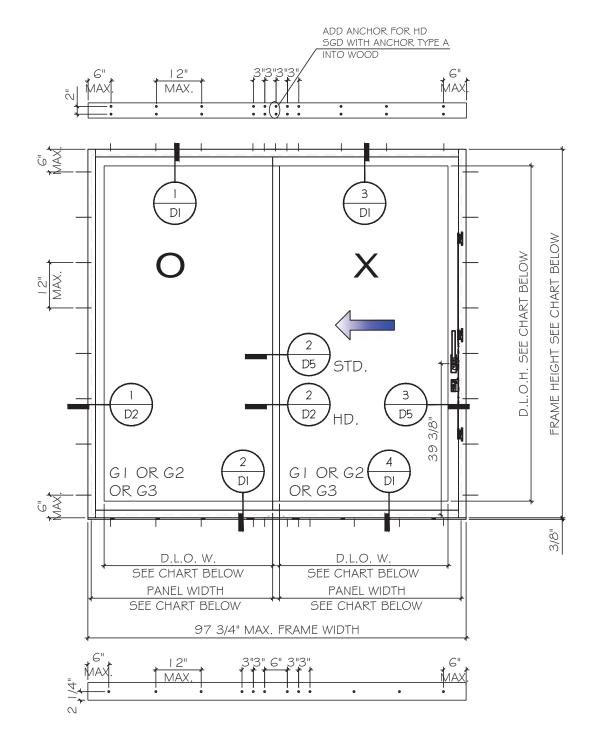

## SERIES SPAIOO TYPICAL EXTERIOR ELEVATIONS


### TWO TRACK OX/XO

	DIME	DIMENSIONS		DIMENSIONS				HARDWARE OPTION
GLASS TYPE	PANEL WIDTH MAX.	FRAME HEIGHT MAX.	D.L.O.W. MAX.	D.L.O.H. MAX.	INTERLOCK OPTION	DESIGN LOADS (PSF)		(SEE SHEET 12 FOR COMPOSITION)
	IN.	IN.	IN.	IN.		EXT. (+)	INT. (-)	COMI OSITION)
GI	48 5/8"	96"	43 1/2"	87 3/8"	HD	90	110	#  \$ #2
G1,G2,G3	48 5/8"	96"	43 1/2"	87 3/8"	STD	65	65	#3
G3	48 5/8"	108"	43 1/2"	99 3/8"	HD	65	65	#

NOTE: FOR SIZE SHOWN ABOVE OR SMALLER AS PERMITTED BY FBC HARDWARE OPTION # I : MULTI-POINT LOCK BY SIEGA.

HARDWARE OPTION #2:DUAL POINT MORTISE LOCK BY DNW.

HARDWARE OPTION #3:DUAL MORTISE LOCK BY MUTU.

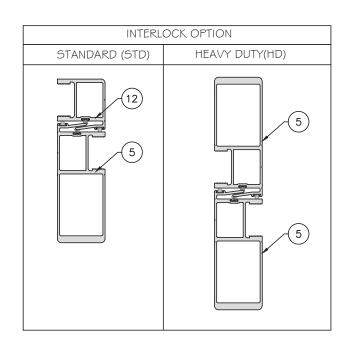


THRESHOLD OPTION			
OPTION I	OPTION 2		
9	(9A)		
DESIGN LOAD +65 PSF	DESIGN LOAD +90 PSF		

MIAMI-DADE COUNTY

PRODUCT REVISED
as complying with the Florida
Building Code
NOA-No. 23-1222.13

Expiration Date 03/09/2028

Miami-Dade Product Control

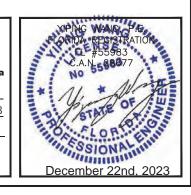

| SERIES SPA100 AND SPA150 SLIDING GLASS DOOR - L.M.I
| SHANGHAI SUPERHOUSE BUILDING MATERIAL CO., LTD
| SHANGHAI SUPERHOUSE BUILDING MATERIAL CO., LTD
| LEVEL 5, BUILDING 10, NO.8666 HUNAN RD, PUDONG NEW AREA | Shanghai, China

12.22.2023


AD22-33


E3


Sheet No. 4 OF 17


MCY ENGINEERING, INC. GLAZING CONSULTANTS

12781 MIRAMAR PKWY.

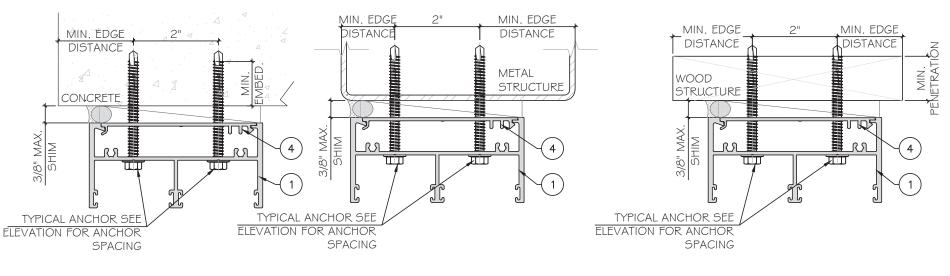

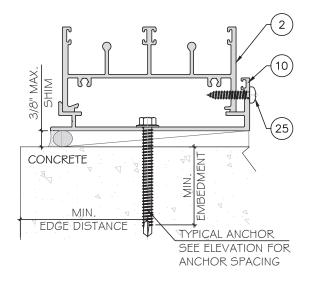

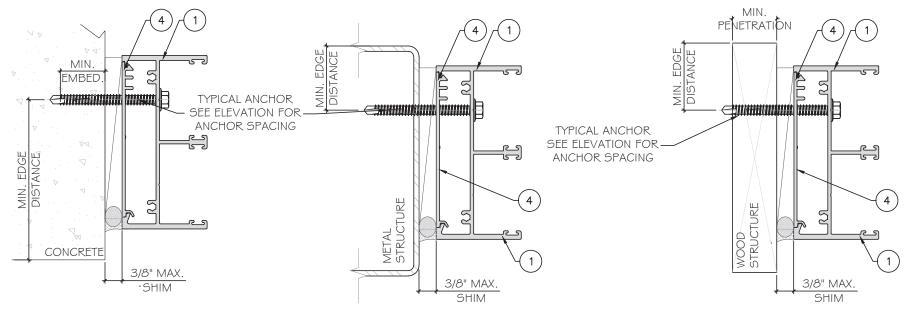

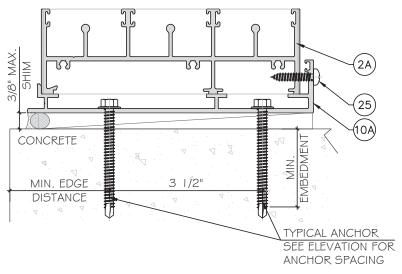

### TYPICAL ANCHOR TYPES: SEE ELEVATIONS FOR SPACING

TYPE "A": I/4" DIA. ULTRACON+ BY 'DEWALT' (Fu= 164 KSI, Fy= 148 KSI) THRU 1BY OR 2BY WOOD BUCKS INTO CONCRETE WITH I 1/2" MIN. PENETRATION INTO WOOD

OR THRU WOOD INTO MONSORY

TYPE "B": 1/4" DIA. ULTRACON+ BY 'DEWALT' (Fu=164 KSI, Fy=148 KSI)

DIRECTLY INTO CONCRETE (f'c=3000 PSI MIN.)

WITH I 3/4" MIN. EMBED

DIRECTLY INTO HOLLOW BLOCK

WITH I I/4" MIN. EMBED.

(JAMB ONLY)

DIRECTLY INTO GROUT FILLED BLOCKS (JAMB ONLY)

WITH I 3/4" MIN. EMBED

TYPE "C": 1/4" TEKS SELF DRILLING SCREW(GRADE 5) (Fu= 1 20 KSI, Fy=90 KSI)

INTO APPROVED MULLIONS INTO METAL STRUCTURE

STEEL: 12 GA. MIN. (Fy=36 KSI MIN.) ALUMINUM: 1/8" THK. MIN. (6063-T6 MIN.)

(STEEL IN CONTACT WITH ALUMINUM TO BE PLATED OR PANTED)

TYPICAL ANCHOR EDGE DISTANCE:

INTO CONCRETE AND MASONRY = 2 1/2" MIN.

INTO WOOD STRUCTURE = I " MIN.

INTO METAL STRUCTURE = 3/4" MIN

WOOD SG = 0.55 MIN.

(HEAD & JAMB)

(JAMB ONLY)

CONCRETE f'c = 3000 ps MIN.(HEAD \$ SILL \$ JAMB)

C-90 HOLLOW/FILLED BLOCK f'm = 2000 psi MIN.

NORMAL STRENGTH CMU

GLAZING BEAD AT FRAME SILL SEALED TO GLASS WITH DOW CORNING 983. FRAME CORNERS SEALED WITH DOW CORNING 999 OR EQUAL COMPATIBLE

MIAMI-DADE	COUNTY

PRODUCT REVISED
as complying with the Florida
Building Code 23-1222.13 NOA-No.

Expiration Date 03/09/2028

By Miami-Dade Product Control

December 22nd, 2023

12.22.2023

MCY ENGINEERING, INC. GLAZING CONSULTANTS


SERIES SPA100 AND SPA150 SLIDING GLASS DOOR - L.M.I

SHANGHAI SUPERHOUSE BUILDING MATERIAL CO., LTD LEVEL 5, BUILDING 10, NO.8666 HUNAN RD, PUDONG NEW AREA

12781 MIRAMAR PKWY.

AD22-33

Α1

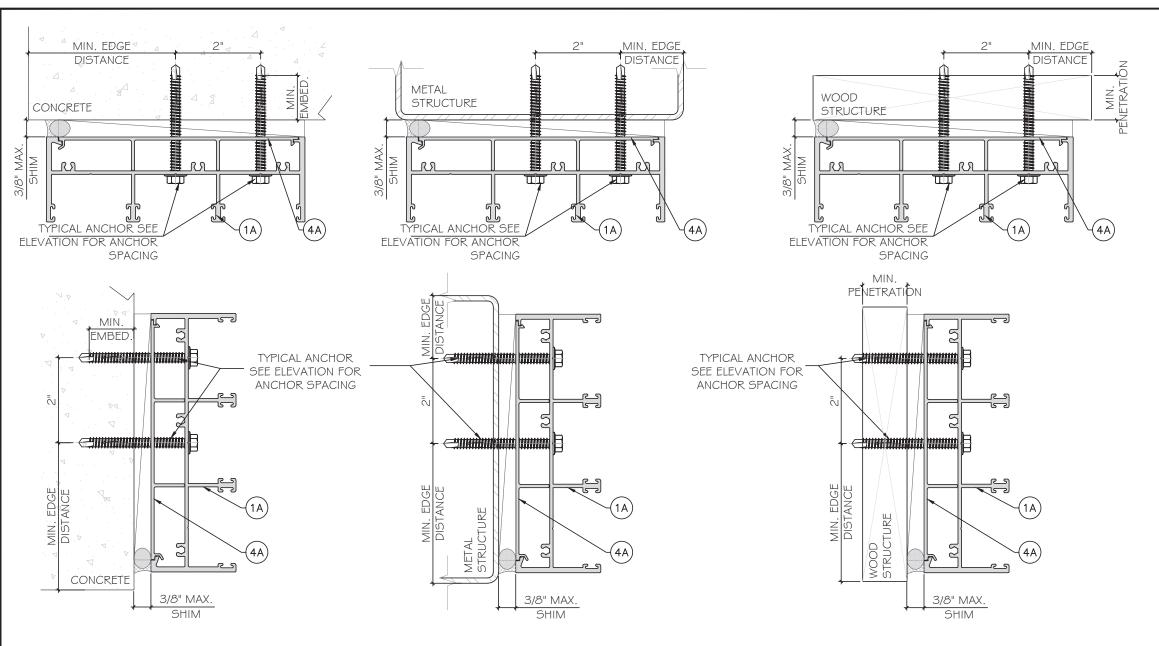

### TYPICAL ANCHOR TYPES: SEE ELEVATIONS FOR SPACING

TYPE "A": 1/4" DIA. ULTRACON+ BY 'DEWALT' (Fu=164 KSI, Fy=148 KSI) THRU I BY OR 2BY WOOD BUCKS INTO CONCRETE WITH I 1/2" MIN. PENETRATION INTO WOOD

OR THRU WOOD INTO MONSORY

TYPE "B": 1/4" DIA. ULTRACON+ BY 'DEWALT' (Fu= 164 KSI, Fy= 148 KSI)

DIRECTLY INTO CONCRETE (fc=3000 PSI MIN.)

WITH I 3/4" MIN. EMBED

DIRECTLY INTO HOLLOW BLOCK

(JAMB ONLY)

WITH I 1/4" MIN. EMBED.

DIRECTLY INTO GROUT FILLED BLOCKS (JAMB ONLY)

WITH I 3/4" MIN. EMBED

TYPE "C": 1/4" TEKS SELF DRILLING SCREW(GRADE 5) (Fu= 120 KSI, Fy=90 KSI)

INTO APPROVED MULLIONS INTO METAL STRUCTURE

STEEL: 12 GA. MIN. (Fy=36 KSI MIN.) ALUMINUM: 1/8" THK. MIN. (6063-T6 MIN.)

(STEEL IN CONTACT WITH ALUMINUM TO BE PLATED OR PANTED)

TYPICAL ANCHOR EDGE DISTANCE: INTO CONCRETE AND MASONRY = 2 1/2" MIN. INTO WOOD STRUCTURE = I " MIN. INTO METAL STRUCTURE = 3/4" MIN.

(HEAD & JAMB) WOOD SG = 0.55 MIN.CONCRETE fc = 3000 psi MIN.(HEAD & SILL & JAMB) C-90 HOLLOW/FILLED BLOCK f'm = 2000 psi MIN. (JAMB ONLY) NORMAL STRENGTH CMU


GLAZING BEAD AT FRAME SILL SEALED TO GLASS WITH DOW CORNING 983. FRAME CORNERS SEALED WITH DOW CORNING 999 OR EQUAL COMPATIBLE

MIAMI-DADE COUNTY

**PRODUCT REVISED** 

23-1222.13 NOA-No. Expiration Date 03/09/2028

Miami-Dade Product Control

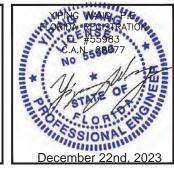

				UPDATE FBC 2023	Description
				James	Drawn By
				12.22.2023 James	Date
				R2	Rev. No.
Drawn Date SCALE 12.22.2023 AS SHOWN					
DRAWING NO.					
AD22-33					


MCY ENGINEERING, INC. GLAZING CONSULTANTS


SERIES SPA100 AND SPA150 SLIDING GLASS DOOR - L.M.I


SHANGHAI SUPERHOUSE BUILDING MATERIAL CO., LTD LEVEL 5, BUILDING 10, NO.8666 HUNAN RD, PUDONG NEW AREA


12781 MIRAMAR PKWY.


A2 Sheet No.

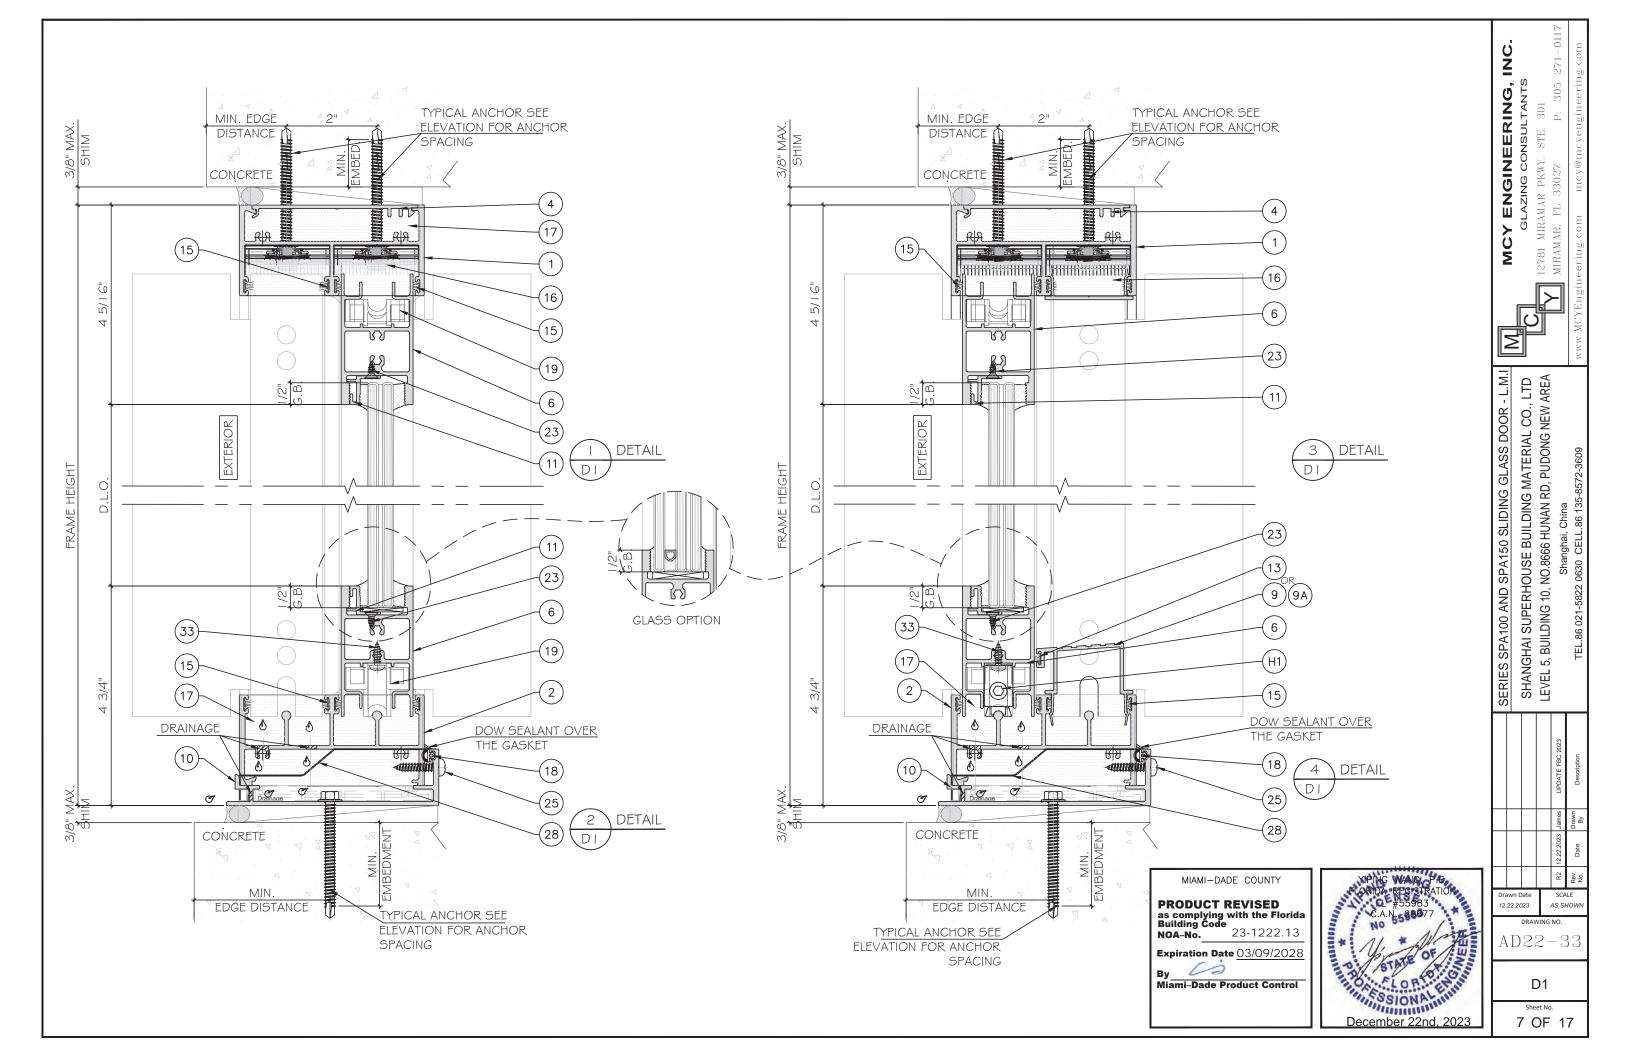


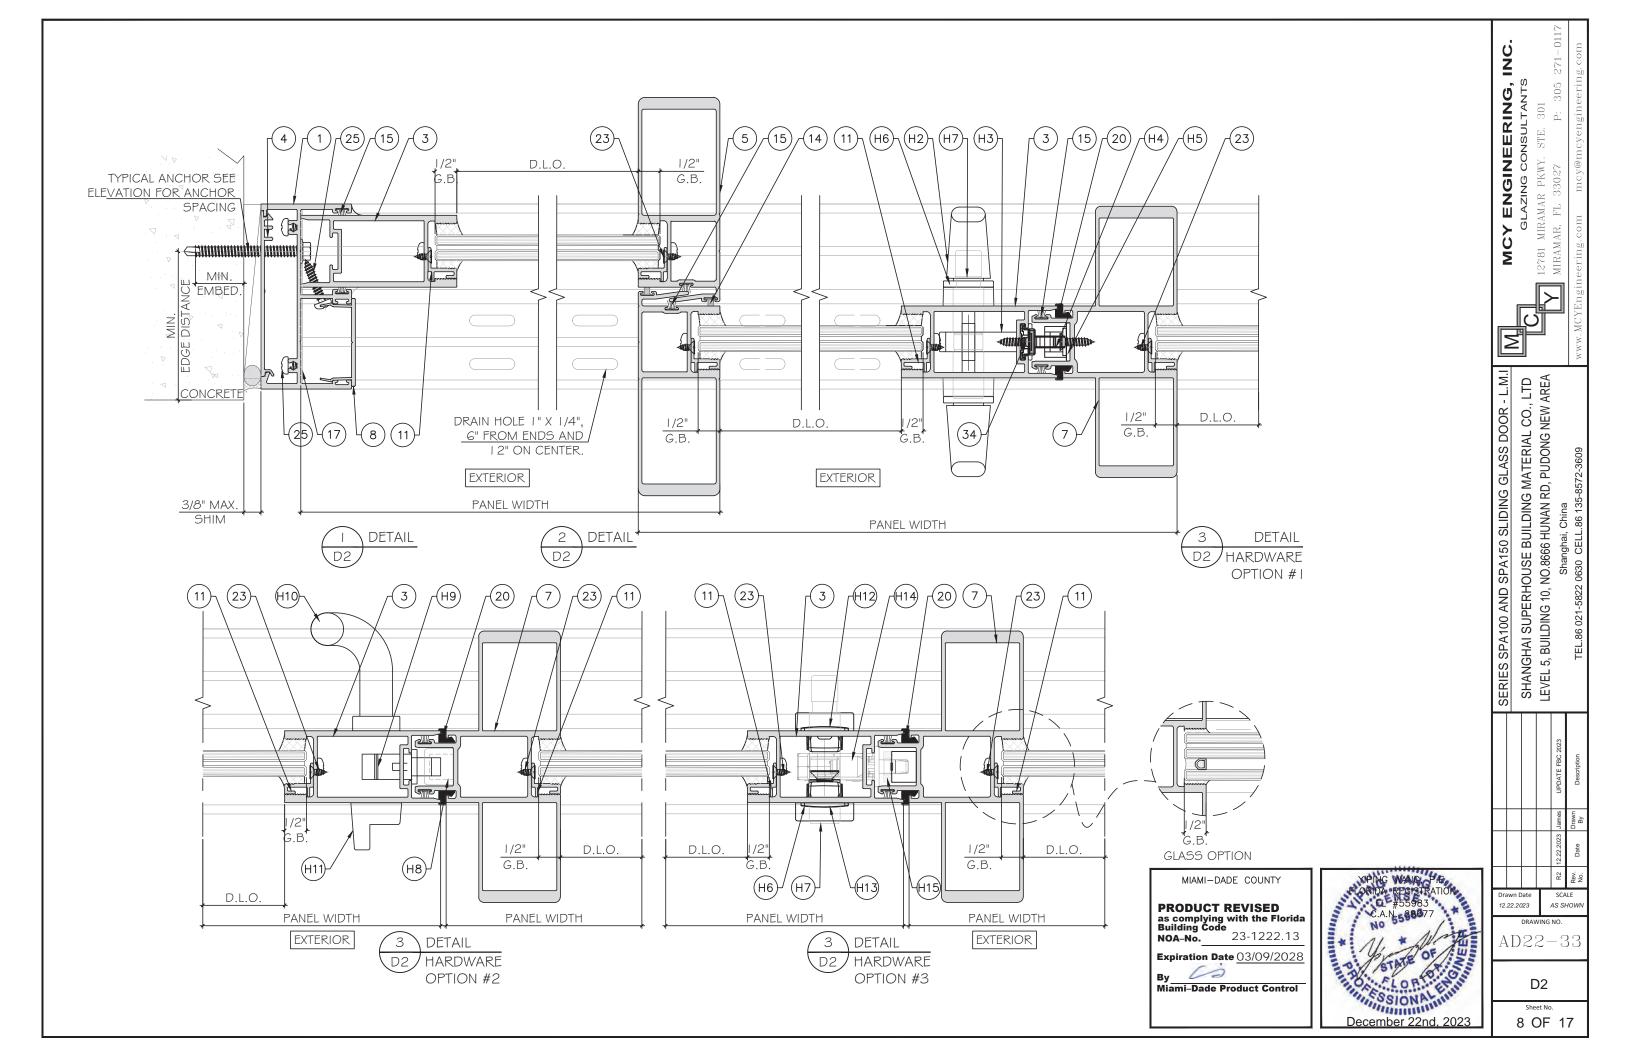

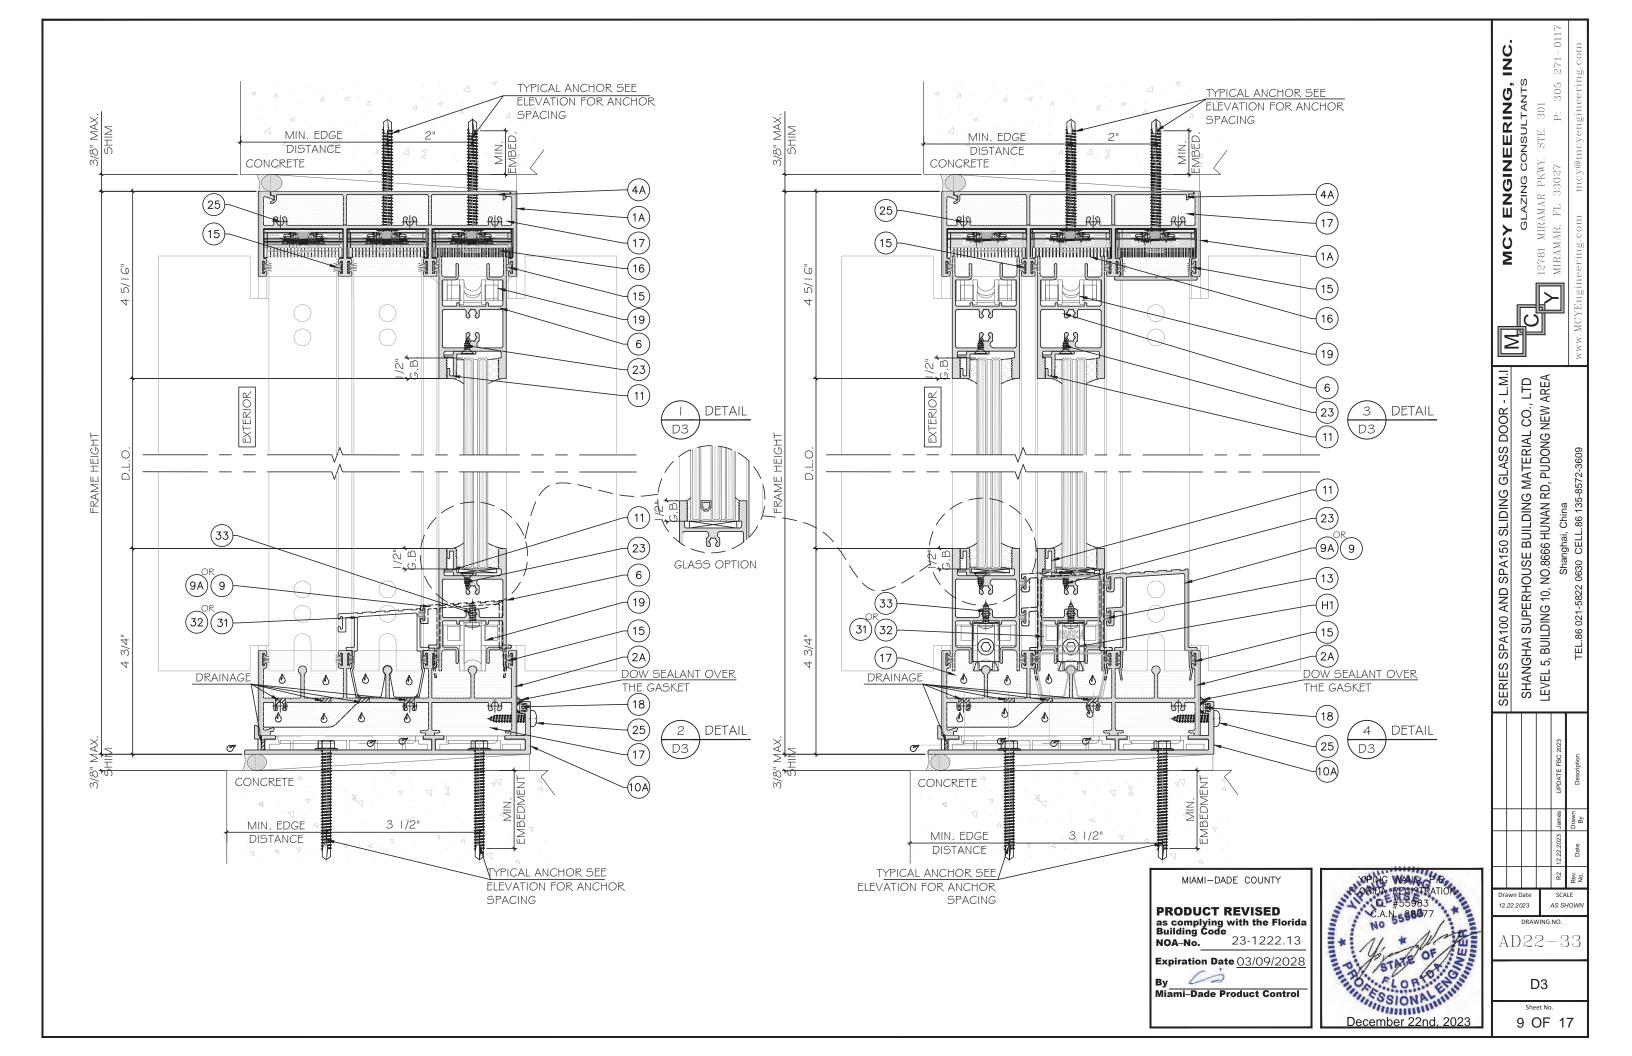


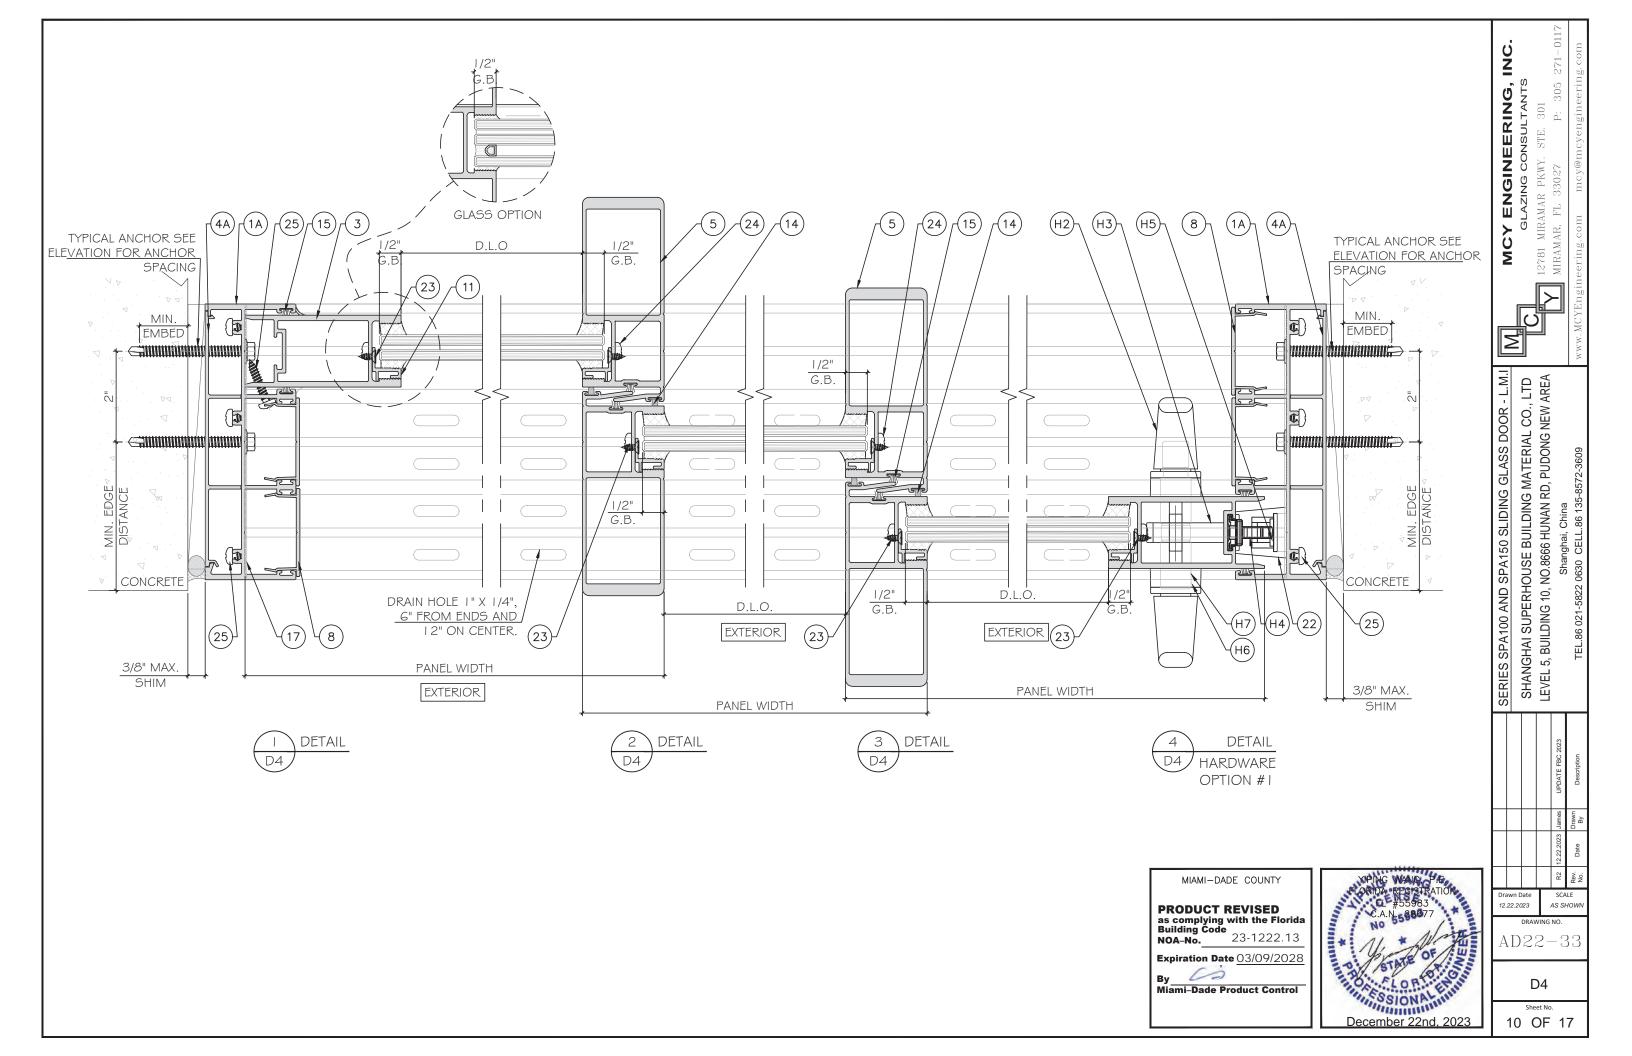


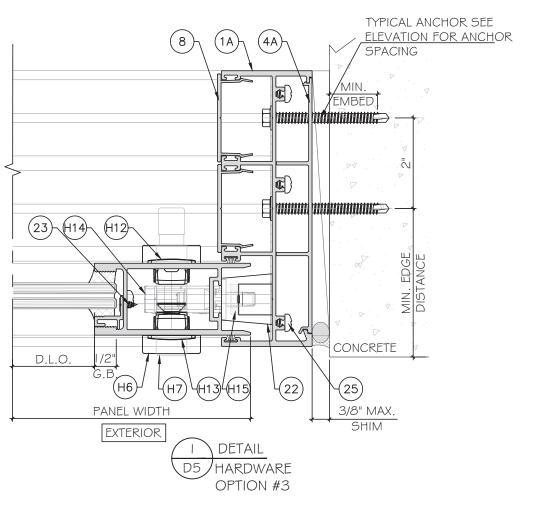

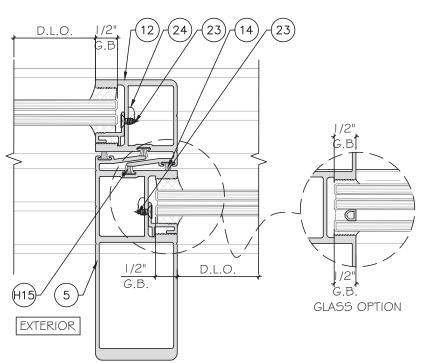



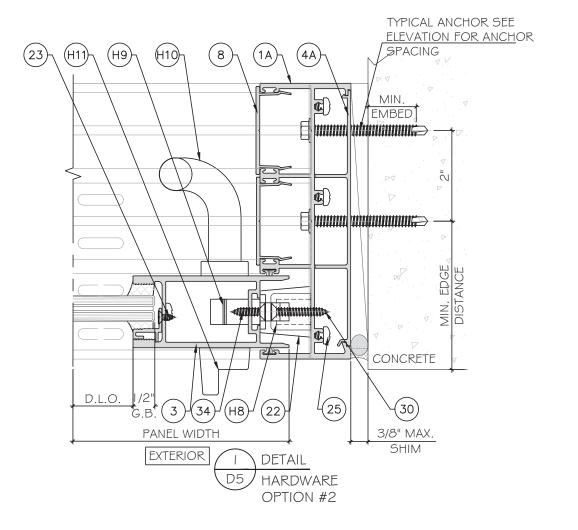

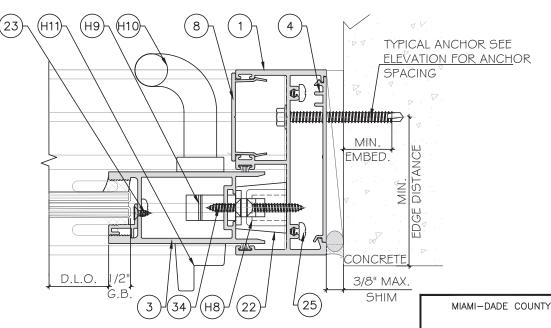

EXTERIOR

3 DETAIL
D5 HARDWARE
OPTION #2

PRODUCT REVISED
as complying with the Florida
Building Code
NOA-No. 23-1222.13

**Expiration Date** <u>03/09/2028</u>

Miami-Dade Product Control



SERIES SPA100 AND SPA150 SLIDING GLASS DOOR - L.M.I
SHANGHAI SUPERHOUSE BUILDING MATERIAL CO., LTD
LEVEL 5, BUILDING 10, NO.8666 HUNAN RD, PUDONG NEW AREA


MCY ENGINEERING, INC.
GLAZING CONSULTANTS
12781 MIRAMAR PKWY. STE. 301
MIRAMAR, FL 33027 P: 305 271-0


Drawn Date 12.22.2023 AS SHOW.

DRAWING NO.

AD 22 — 33


Sheet No.
11 OF 17

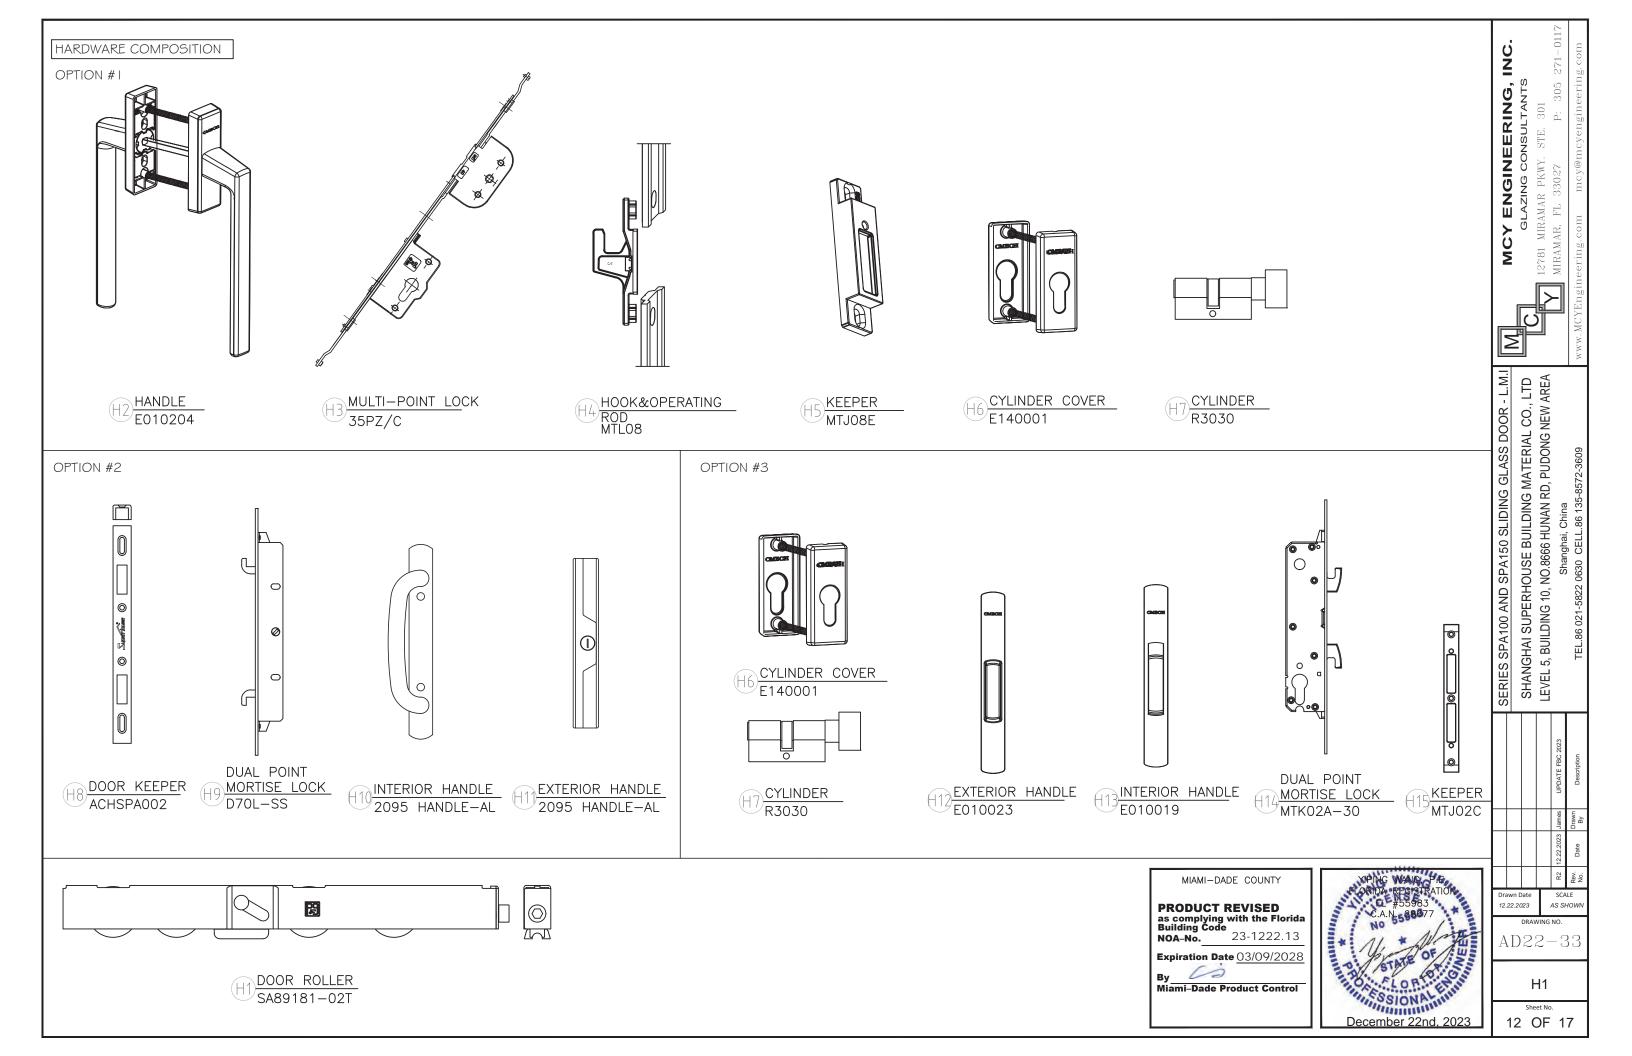

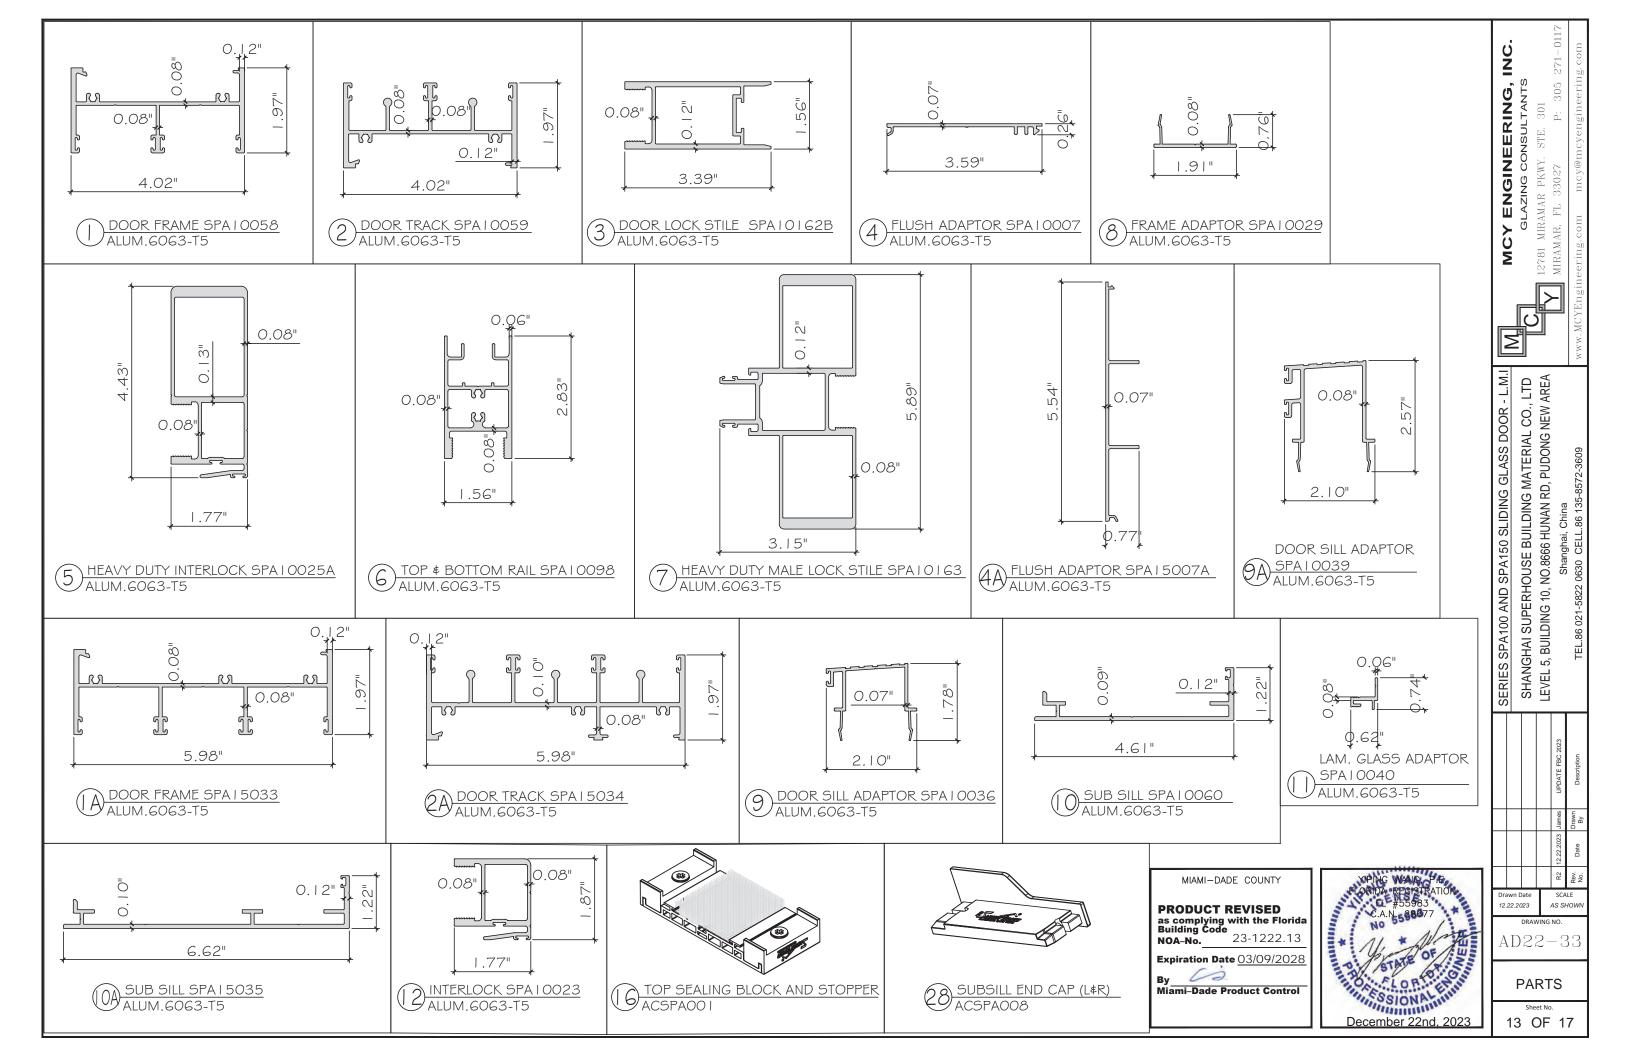


CROSS SLOTTED HEAD SCREW

SS304 Fy≥205MPA. Fu=594-620MPA.
(SCREW COMPLY WITH US ASTM.)

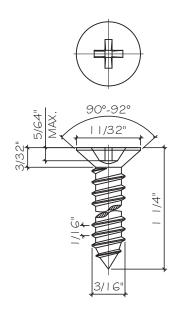

CROSS SLOTTED HEAD SCREW
SS304 Fy≥205MPA. Fu=594-620MPA.
(SCREW COMPLY WITH US ASTM.)



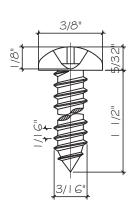


CROSS PAN HEAD SCREW

5S304 Fy≥205MPA. Fu=594-620MPA.


(SCREW COMPLY WITH US ASTM.)



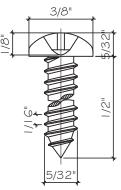

CROSS PAN HEAD SCREW
55304 Fy \ge 205MPA. Fu = 594-620MPA.
(SCREW COMPLY WITH US ASTM.)




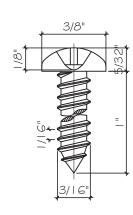

CROSS PAN HEAD SCREW

SS304 Fy≥205MPA. Fu=594-620MPA.

(SCREW COMPLY WITH US ASTM.)

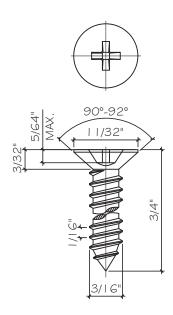


CROSS SLOTTED HEAD SCREW
SS304 Fy≥205MPA. Fu=594-620MPA.
(SCREW COMPLY WITH US ASTM.)

PRODUCT REVISED
as complying with the Florida
Building Code
NOA-No. 23-1222.13

Expiration Date 03/09/2028

Miami-Dade Product Control

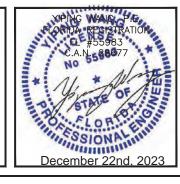

MCY ENGINEERING, INC.	GLAZING CONSULTANTS	12781 MIRAMAR PKWY. STE. 301	▼   MIRAMAR, FL 33027 P: 305 271-01
Σ	]  -	_	
G GLASS DOOR - L.M.I	MATERIAL CO., LTD	RD. PUDONG NEW AREA	

DRAWING NO.
AD22-33

PARTS

	BILL OF MATERIALS					
ITEM	PART	DESCRIPTION	MATERIAL	MANUFACTURE		
1	SPA   0058	FRAME HEAD AND JAMB	ALUM. 6063-T5	GUANGYA ALU. COMPANY		
IA	SPA   5033	DOOR FRAME	ALUM. 6063-T5	GUANGYA ALU. COMPANY		
2	SPA   0059	FRAME SILL	ALUM. 6063-T5	GUANGYA ALU. COMPANY		
2A	SPA   5034	DOOR TRACK	ALUM. 6063-T5	GUANGYA ALU. COMPANY		
3	SPA10162B	DOOR LOCK STILE	ALUM. 6063-T5	GUANGYA ALU. COMPANY		
4	SPA   0007	FLUSH ADAPTOR	ALUM. 6063-T5	GUANGYA ALU. COMPANY		
4A	SPA   5007A	FLUSH ADAPTOR	ALUM. 6063-T5	GUANGYA ALU. COMPANY		
5	SPA   0025A	HEAVY DUTY INTERLOCK	ALUM. 6063-T5	GUANGYA ALU. COMPANY		
6	SPA   0098	TOP \$ BOTTOM RAIL	ALUM. 6063-T5	GUANGYA ALU. COMPANY		
7	SPA10163	HEAVY DUTY MALE LOCK STILE	ALUM. 6063-T5	GUANGYA ALU. COMPANY		
8	SPA   0029	FRAME ADAPTOR	ALUM. 6063-T5	GUANGYA ALU. COMPANY		
9	SPA   0036	LOW THRESHOLD	ALUM. 6063-T5	GUANGYA ALU. COMPANY		
9A	SPA I 0039	HIGH THRESHOLD	ALUM. 6063-T5	GUANGYA ALU. COMPANY		
10	SPA   0060	SUB SILL	ALUM. 6063-T5	GUANGYA ALU. COMPANY		
IOA	SPA   5035	SUB SILL	ALUM. 6063-T5	GUANGYA ALU. COMPANY		
11	SPA   0040	LAM. GLASS ADAPTOR	ALUM. 6063-T5	GUANGYA ALU. COMPANY		
12	SPA   0023	INTERLOCK	ALUM. 6063-T5	GUANGYA ALU. COMPANY		
13	K5211	THRESHOLD GASKET, ADUROMETER 9±2 SHORE A	FOAM	-		
14	K5201	INTERLOCK GASKET, ADUROMETER 9±2 SHORE A	FOAM	-		
15	7-3.5-4	PILE WSTRIPPING WITH FIN	-	-		
16	ACSPA001	TOP SEALING BLOCK AND STOPPER	PA66	SUPERHOUSE COMPANY		
17	SPA I OOO I W	FRAME JOINT GASKET	-	3M COMPANY		
18	SBWG-006	SUBSILL GASKET, ADUROMETER 70±5 SHORE A	EPDM	-		
19	ACSPA020	SUPPORT BLOCK FOR FIX PANEL BOTTOM	PA66	SUPERHOUSE COMPANY		
20	KS521	MALE LOCK STILE GASKET, ADUROMETER 9±2 SHORE A	FOAM	-		
21	-	EPDM SETTING BLOCK 3/32" X 7/8", ADUROMETER 75±5 SHORE A	EPDM	-		
22	-	EPDM STOPPER, ADUROMETER 65±2 SHORE A	EPDM	-		
23	-	CROSS SLOTTED HEAD SCREW DIA.5/32" X 3/8", Fy≥205MPA, Fu=594-620MPA. @   2" O.C. (SCREW COMPLY WITH US ASTM.)	55304	CHUANGGU COMPANY		
24	-	CROSS PAN HEAD SCREW DIA.3/16" X 1 1/2", Fy≥205MPA, Fu=594-620MPA. (SCREW COMPLY WITH US ASTM.)	55304	CHUANGGU COMPANY		
25	-	CROSS PAN HEAD SCREW DIA.3/16" X 1",Fy≥205MPA, Fu=594-620MPA. @12" O.C. (SCREW COMPLY WITH US ASTM.)	55304	CHUANGGU COMPANY		
26	-	EPDM SETTING BLOCK 5/32" X 1-3/32", ADUROMETER 75±5 SHORE A	EPDM	-		
27	-	STRUCTURE SILICONE DOWSIL 995	SILICONE	DOWSIL		
28	ACSPA008	SUBSILL END CAP (L¢R)	PA66	SUPERHOUSE COMPANY		
29	NOT USED					
30	-	CROSS SLOTTED HEAD SCREW, DIA.3/16" X 1 1/4", Fy≥205MPA. Fu=594-G20MPA. (SCREW COMPLY WITH US ASTM.)	55304	CHUANGGU COMPANY		
31	ACSPA-018	LOW THRESHOLD END CAP	TPR	SUPERHOUSE COMPANY		
32	ACSPA-05 I	HIGH THRESHOLD END CAP	TPR	SUPERHOUSE COMPANY		
33		CROSS PAN HEAD SCREW DIA.5/32" X 1/2", Fy≥205MPA. Fu=594-620MPA. (SCREW COMPLY WITH US ASTM.)	55304	CHUANGGU COMPANY		
34		CROSS SLOTTED HEAD SCREW, DIA.3/16" X 3/4", Fy≥205MPA. Fu=594-G20MPA. (SCREW COMPLY WITH US ASTM.)	55304	CHUANGGU COMPANY		

MCY ENGINEERING, INC.

GLAZING CONSULTANTS

GLAZING CONSULTANTS

12781 MIRAMAR PKWY. STE. 301

MIRAMAR, FL 33027 P: 305 271-01 SERIES SPA100 AND SPA150 SLIDING GLASS DOOR - L.M.I.
SHANGHAI SUPERHOUSE BUILDING MATERIAL CO., LTD
LEVEL 5, BUILDING 10, NO.8666 HUNAN RD, PUDONG NEW AREA
Shanghai, China
TEL.86 021-5822 0630 CELL.86 135-8572-3609 SCALE AS SHOWN Drawn Date 12.22.2023


AD22-33

BOM Sheet No. 15 OF 17

MIAMI-DADE COUNTY PRODUCT REVISED
as complying with the Florida
Building Code
NOA-No. 23-1222.13

**Expiration Date** <u>03/09/2028</u>

00 By Miami-Dade Product Control

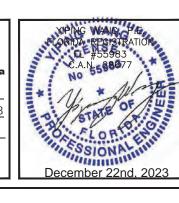


	BILL OF MATERIALS					
ITEM	PART	DESCRIPTION	MATERIAL	MANUFACTURE		
НІ	SA89181-02T	DOOR ROLLER	PAG6	PAG		
H2	E010204	HANDLE	ZINC ALLOY	CMECH		
НЗ	35PZ/C	MULTI-POINT LOCK	ZINC ALLOY	SIEGENIA		
H4	MTL08	HOOK	STAINLESS STEEL	MUTU		
H5	MTJ08E	KEEPER	STAINLESS STEEL	MUTU		
H6	E140001	CYLINDER COVER	ZINC ALLOY	CMECH		
H7	FT130105	CYLINDER, R3030	BRASS	CMECH		
H8	ACHSPA002	DOOR KEEPER	STAINLESS STEEL	SUPERHOUSE COMPANY		
Н9	D70L-55	DUAL POINT MORTISE LOCK	STAINLESS STEEL	DNW COMPANY		
НІО	2095 HANDLE - AL	INTERIOR HANDLE	STAINLESS STEEL	DNW COMPANY		
HII	2095 HANDLE - AL	EXTERIOR HANDLE	STAINLESS STEEL	DNW COMPANY		
HI2	E010023	EXTERIOR HANDLE	ZINC ALLOY	CMECH		
H13	E010019	INTERIOR HANDLE	ZINC ALLOY	CMECH		
H14	MTKO2A-30	DUAL POINT MORTISE LOCK	STAINLESS STEEL	MUTU		
H15	MTJ02C	KEEPER	STAINLESS STEEL	MUTU		

MIAMI-DADE COUNTY

PRODUCT REVISED
as complying with the Florida
Building Code
NOA-No. 23-1222.13

Expiration Date 03/09/2028

By
Miami-Dade Product Control

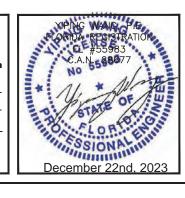

MCY ENGINEERING, INC.
GLAZING CONSULTANTS
12781 MIRAMAR PKWY. STE. 301
MIRAMAR, FL 33027 P: 305 271-01

SERIES SPA100 AND SPA150 SLIDING GLASS DOOR - L.M.I SHANGHAI SUPERHOUSE BUILDING MATERIAL CO., LTD LEVEL 5, BUILDING 10, NO.8666 HUNAN RD, PUDONG NEW AREA Shanghai, China TEL.86 021-5822 0630 CELL.86 135-8572-3609

SCALE AS SHOWN Drawn Date 12.22.2023

AD22-33

BOM

Sheet No. 16 OF 17

