## MIAMI-DADE COUNTY DEPARTMENT OF TRANSPORTATION AND PUBLIC WORKS (DTPW)

#### ADDENDUM No. 12 May 23, 2025

PROJECT: Biscayne Shores Pump Station Retrofit Nos. 109 and 110 and MIC Stormwater Pump

Station Trash Rack Repair Project No. 20230197-R

BID DUE DATE: June 4, 2025; 02:00 P.M.

FROM:

Miami-Dade County DTPW Capital Improvements Division 111 NW First Street, 14<sup>th</sup> Floor

Miami, FL 33128 305.375.2930

TO: Prospective Bidders and Interested Parties

This Addendum forms part of the project solicitation documents and will be incorporated into the Contract Documents, as applicable. Insofar as the Original Contract Documents, Drawings and Specifications are inconsistent, this Addendum shall govern. Please acknowledge receipt of this Addendum, at the time of bid submittal to Miami-Dade County, in the space provided on the "Acknowledgement of Addenda Form" provided with the project solicitation documents. Failure to acknowledge receipt of all addenda may be cause for disqualification.

#### CHANGES TO SOLICITATION DOCUMENTS:

A. Replace the Disadvantaged Business Enterprise (DBE) Package Information, Form 275-030-11 dated 09/19, in its entirety with the attached DBE Bid Package Information, Form 275-030-11 dated 07/24.

#### CHANGES TO SPECIAL PROVISIONS:

- A. In Appendix "C" Standard Terms and Conditions Grant Agreement, replace Exhibit H in its entirety with the attached Exhibit H, Revised 4/8/2024.
- B. Add to Appendix "E" of the Special Provisions the attached Class I and Class II Permits.

#### CHANGES TO ENGINEERING DRAWINGS:

A. Replace the original Set of Plans PS 109 & 110 including the Electrical Plans, in their entirety with the attached Revised Civil Set of Plans by Addendum No. 12 and Revised Electrical Plans by Addendum No. 12.

#### **END OF ADDENDUM NO. 12**

## MIAMI-DADE COUNTY DEPARTMENT OF TRANSPORTATION AND PUBLIC WORKS (DTPW)

ADDENDUM No. 12 May 23, 2025

Tiondra Wright

Chief, Capital Improvements Division

Department of Transportation and Public Works (DTPW)

#### TW:er

c: Elva Reyes, DTPW

Katherine Fernandez, DTPW

Liza Herrera, P.E., DTPW

Daryl Hildoer, P.E., DTPW

Caesar Suarez, SBD

Clerk of the Board

Project File

#### 275-030-11 EQUAL OPPORTUNITY OFFICE 07/24

#### DBE BID PACKAGE INFORMATION

#### **DBE Utilization**

The Department began its DBE race neutral program January 1, 2000. **Contract specific goals are not placed on Federal/State contracts**; however, the Department has an overall 10.54% DBE goal it must achieve. In order to assist contractors in determining their DBE commitment level, the Department has reviewed the estimates for this letting.

As you prepare your bid, please monitor potential or anticipated DBE utilization for contracts. When the low bidder executes the contract with the Department, information will be requested of the contractor's DBE participation for the project. While the utilization is not mandatory in order to be awarded the project, continuing utilization of DBE firms on contracts supports the success of Florida's DBE Program, and supports contractors' Equal Employment Opportunity and DBE Affirmative Action Programs.

Any project listed as 0% DBE availability does not mean that a DBE may not be used on that project. A 0% DBE availability may have been established due to any of the following reasons: limited identified subcontracting opportunities, minimal contract days, and/or small contract dollar amount. Contractors are encouraged to identify any opportunities to subcontract to DBE's.

Please contact the Equal Opportunity Office at (850) 414-4747 if you have any questions regarding this information.

#### **DBE Reporting**

If you are the prime contractor on a project, enter your DBE participation in the Equal Opportunity Compliance system prior to the pre-construction or pre-work conference for all federal and state funded projects. This **will not** become a mandatory part of the contract. It will assist the Department in tracking and reporting planned or estimated DBE utilization. <u>During</u> the <u>contract</u>, the prime contractor is required to report actual payments to DBE and MBE subcontractors through the web-based Equal Opportunity Compliance (EOC) system.

All DBE payments must be reported whether or not you initially planned to utilize the company. In order for our race neutral DBE Program to be successful, your cooperation is imperative. If you have any questions, please contact EOOHelp@dot.state.fl.us.

#### **Bid Opportunity List**

The Federal DBE Program requires States to maintain a database of all firms that are participating or attempting to participate on FDOT-assisted contracts. The list must include all firms that bid on prime contracts or bid or quote subcontracts on FDOT-assisted projects, including both **DBE's and non-DBEs.** 

Please complete the Bidders Opportunity List through the Equal Opportunity Compliance system within 3 business days of submission of the bid or proposal for ALL subcontractors or sub-consultants who quoted to you for specific project for this letting. The web address to the Equal Opportunity Compliance system is: <a href="https://www.fdot.gov/equalopportunity/eoc.shtm">https://www.fdot.gov/equalopportunity/eoc.shtm</a>.

#### STATE OF FLORIDA DEPARTMENT OF TRANSPORTATION

DBE BID PACKAGE INFORMATION

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#### **DBE/AA Plans**

Contractors bidding on FDOT contracts are to have an approved DBE Affirmative Action Plan (FDOT Form 275-030-11B) on file with the FDOT Equal Opportunity Office before execution of a contract. DBE/AA Plans must be received with the contractors bid or received by the Equal Opportunity Office <u>prior to the award</u> of the contract.

Plans are approved by the Equal Opportunity Office in accordance with Ch. 14-78, Florida Administrative Code. Plans that do not meet these mandatory requirements may not be approved. Approvals are for a (3) three year period and should be updated at anytime there is a change in the company's DBE Liaison Officer and/or President. Contractors may evidence adoption of the DBE/AA Policy and Plan and/or a change in the designated DBE Liaison officer as follows:

- Print the first page of the document on company stationery ("letterhead") that indicates the company's name, mailing address, phone number, etc.
- Print the company's name in the "\_\_\_\_" space; next to "Date" print the month/day/year the policy is being signed; record the signature of the company's Chief Executive Officer, President or Chairperson in the space next to "by" and print the full first and last name and position title of the official signing the policy.
- Print the DBE Liaison's full name, email address, business mailing address and phone number the bottom of email.

E-mail the completed and signed DBE AA Plan to: eeoforms@dot.state.fl.us.

The Department will review the policy, update department records and issue a notification of approval or disapproval; a copy of the submitted plan will not be returned to the contractor.

#### STATE OF FLORIDA DEPARTMENT OF ENVIRONMENTAL PROTECTION RESILIENT FLORIDA GRANT PROGRAM CONTRACTUAL SERVICES CERTIFICATION

Exhibit H
Required for all grant agreements that include Contractual Services as an expenditure category.
DEP Agreement Number:
Project Title:
Grantee:
Subcontractor:
Prior to making a request for payment of contractual services, the Grantee must provide the following to the Department Grant Manager then responsible for the Grantee's Resilient Florida Grant Program grant agreement:
1. Documentation of the Grantee's procurement process, as consistent with Attachment 1, Paragraph 9(c) and Attachment 2, Paragraph 11;
2. A list of all subcontractor quote and/or bid amounts (as applicable), including the company name and address for each subcontractor;
3. An explanation of how and why the Grantee made their determination(s) for the subcontractor(s) selected to perform certain task(s) under the Grantee's relevant grant agreement;
<ul><li>4. A copy of the Grantee's executed subcontract agreement, as required by Attachment 2, Paragraph 11; and</li></ul>
<ul><li>5. This Exhibit H, signed and dated by the Grantee's own (non-Departmental) grant manager.</li></ul>
By signing below, I certify that, on behalf of the Grantee, I have provided all the information required by items 1. through 4. of this exhibit, as stated above, to the Department Grant Manager currently responsible for the Grantee's Resilient Florida Grant Program grant agreement. I also certify that the procurement process the Grantee utilized follows all of said Grantee's non-Departmental policies and procedures for subcontractors.
Grantee's Grant Manager Signature
Print Name

Date



#### **Department of Regulatory and Economic Resources**

See Specific Condition #1.

Coastal Resources Section 701 NW 1st Court, Suite 400 Miami, FL 33136-3912 305-372-6575

#### **Class I Construction Permit**

Permit Number:CLI-2024-0221Issue Date:5/13/2025 MCDERM Project Manager:Nicole AlvaradoWork Expiration5/13/2027 RA

Date:

<u>Permittee</u> <u>Contractor</u>

Miami-Dade County Department of Transportation and Public Works c/o Josiel Ferrer-Diaz, Chief Development Officer 7100 Northwest 36 Street

Miami, Florida 33166 Phone No. (305) 679-0090

<u>Bond</u> <u>Engineer</u>

Performance Bond: N/A Nelson H. Ortiz, P.E. #57556

Mitigation Bond: \$3,127.50

**BBEETF Contribution:** N/A

THE ABOVE NAMED PERMITTEE IS HEREBY AUTHORIZED TO PERFORM THE WORK SHOWN ON THE APPLICATION AND APPROVED DRAWINGS, PLANS, AND OTHER DOCUMENTS ATTACHED HERETO OR ON FILE WITH THE DEPARTMENT AND MADE PART HEREOF, SUBJECT TO THE ATTACHED GENERAL AND SPECIFIC CONDITIONS.

Plans Entitled: PROJECT: BISCYANE SHORES PUMP

STATTION NO.'S 109 & 110 RETROFIT

Date Signed and Sealed: 11/27/2024

**Project Location:** Northeast 109<sup>th</sup> Street and Northeast 110<sup>th</sup> and North Bayshore Avenue

**Project Description:** • Removal of the existing concrete seawall, seawall cap and riprap.

#### Northeast 109th Street

Installation of 17.50 linear feet of new concrete seawall located between 0 and 17.50 linear feet from the north property line as per the DERM final approved plans. The wetface of the new seawall will extend no more than 12 inches waterward of the Mean High Water Line.

THIS PERMIT AND PLANS SHALL BE KEPT ON SITE DURING ALL PHASES OF CONSTRUCTION

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- Installation of 17.25 linear feet of new concrete seawall 32.83 and 50.08 linear feet from the north property line as per the DERM final approved plans. The wetface of the new seawall will extend no more than 12 inches waterward of the Mean High Water Line.
- Installation of 11 concrete batter piles, 7 concrete king piles, and 34.75 linear feet of concrete seawall cap located between 0 17.50 and 32.83 50.08 linear feet from the north property line as per the DERM final approved plans. The seawall cap will measure 2.8 feet wide by 2.0 feet high, and extend 1.7 feet waterward of the wetface of the new seawall.
- Installation of two 10 foot long concrete return walls one located at each end of the property.
- Installation of a 0.7 foot wide by 21.3 foot long portion of the energy dissipater in-water located approximately between 17.50 and 32.83 linear feet from the north property line as shown in DERM final approved plans.
- Installation of 50.08 linear feet of coral rock riprap boulders along the new seawall located between 0 and 50.08 linear feet from the north property line. The riprap will consist of 1 to 3 foot diameter boulders and will be placed at a 2 horizontal :1 vertical slope extending a maximum of 10 feet waterward from the base of the new seawall.

#### Northeast 110th Street

- Installation of 18.58 linear feet of new concrete seawall located between 0 and 18.58 linear feet from the north property line as per the DERM final approved plans. The wetface of the new seawall will extend no more than 12 inches waterward of the Mean High Water Line.
- Installation of 16.67 linear feet of new concrete seawall located between 33.91 and 49.24 linear feet from the north property line as per the DERM final approved plans. The wetface of the new seawall will extend no more than 12 inches waterward of the Mean High Water Line.
- Installation of 11 concrete batter piles, 7 concrete king piles, and 33.91 linear feet of concrete seawall cap located between 0 18.58 and 33.91 49.24 linear feet from the north property line as per the DERM final approved plans. The seawall cap will measure 2.8 feet wide by 2.0 feet high, and extend 1.7 feet waterward of the wetface of the new seawall.
- Installation of two 10 foot long concrete return walls one located at each end of the property.
- Installation of a 0.7 foot wide by 21.3 foot long portion of the energy dissipater in-water located approximately between 18.58 and 33.91 linear feet from the north property line as shown in DERM final approved plans.
- Installation of 49.24 linear feet of coral rock riprap boulders along the new seawall located between 0 and 50.1 linear feet from the north property line. The riprap will consist of 1 to 3 foot diameter boulders and will be placed at a 2 horizontal :1 vertical slope extending a maximum of 10 feet waterward from the base of the new seawall.

Attachment A: Mooring Prohibited Area (MPA)

## THIS PERMIT AND PLANS SHALL BE KEPT ON SITE DURING ALL PHASES OF CONSTRUCTION

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#### Specific Conditions

- 1. The name, address, telephone number, and license number of the contractor who will be performing the work shall be submitted a minimum of 30 days prior to the commencement of work. Work authorized by this permit shall not commence until written acceptance of the contractor by DERM has been issued and all pre-construction conditions have been completed to DERM's satisfaction.
- 2. After the new seawall has been installed and prior to backfilling or forming/pouring the seawall cap, the site shall be inspected by DERM staff. The contractor shall provide a minimum of 2 business days and a maximum of 5 business days notice to the Coastal Resources Section at (305) 372-6575 prior to the desired inspection date. The above-referenced work shall not commence until DERM has inspected the site and authorized construction to begin.
- 3. A turbidity curtain shall completely enclose the work area and shall not be removed until turbidity levels within the enclosed area return to background levels outside the curtain.
- 4. Turbidity curtains must be clearly marked in 10 foot intervals along the length with the name of the contractor on-site. In the event that a turbidity curtain becomes detached from the project area and is identified by DERM, the contractor will be notified to immediately remove the turbidity curtain from tidal waters and properly dispose, or return to the project area and resecure it. Failure to mark turbidity curtains as specified above and remove derelict turbidity curtains from tidal waters may result in enforcement action without further notice.
- 5. Turbidity controls shall be employed and maintained in the most effective manner possible to prevent turbidity from extending beyond the turbidity control mechanism in place. Failure to deploy and maintain the turbidity curtain or other turbidity control mechanism in the most effective manner possible may result in the issuance of a Uniform Civil Violation Notice (UCVN). In no event may turbidity exceed 0 Nephelometric Turbidity Units (NTU) above background beyond 50 feet of the operation. If turbidity levels exceed 0NTU above background beyond 50 feet of the operation, all construction shall be halted and additional turbidity controls implemented. The incident shall be immediately reported to the Coastal Resources Section Compliance and Enforcement Group at (305) 372-6575 and the work shall not resume until the contractor has received authorization from DERM.
- 6. Environmental controls and best management practices must be implemented to prevent any materials related to construction from entering the surrounding water. Any material removed as well as material applied to accomplish repairs must be contained so as to prevent fugitive particulates and/or discharge to surface waters. Any materials which fall into the water shall be removed immediately. The contractor shall ensure that no material is placed in the water either temporarily or permanently.
- 7. The wetface of the new seawall shall extend a maximum of 12 inches waterward of the wetface of the Mean High Water Line.
- 8. The final grade of the uplands immediately adjacent to the seawall cap shall be maintained a minimum of 6 inches below the seawall cap in order to prevent positive drainage of stormwater into the waterway and adjacent areas. All uplands immediately adjacent to the seawall cap shall be graded away from the said structures.
- 9. Pursuant to Section 24-48.3(4) of the Code of Miami-Dade County, Florida, the contractor shall ensure that the backfill is from upland sources and it consists of suitable material and must meet the definition of clean fill as defined in Section 24-5 of the Code of Miami-Dade County.
- 10. All backfilling shall be done after completion of the seawall. This permit does not authorize any filling except for backfill landward of the bulkhead. This permit does not authorize the filling of tidal waters or wetlands for additional development.
- 11. The contractor shall provide trucking receipts for all fill from upland sites that is utilized for backfilling behind the new seawall. This condition shall be satisfied within 30 days of the completion of the seawall.

THIS PERMIT AND PLANS SHALL BE KEPT ON SITE DURING ALL PHASES OF CONSTRUCTION

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- 12. Due to shallow water depths, vessels shall be restricted from mooring in areas designated as a "Mooring Prohibited Area" (Attachment A). Failure to comply with this specific condition may be subject to enforcement by DERM.
- 13. The installation of fenders, davits, mooring whips, cleats, or any hardware to facilitate the mooring of vessels within the MPA is prohibited. Failure to comply with this specific condition may be subject to enforcement by DERM.
- 14. In order to mitigate for the water quality impacts associated with the seawall installation, and in order to extend the life of the seawall and provide habitat for a variety of invertebrates and protective cover for small fish, 34.75 cubic yards of riprap (approximately 47 tons) shall be placed on-site at the base of the seawall at a two to one (2H:1V) slope. The riprap shall consist of natural limerock riprap boulders ranging in size from 1 to 3 feet in diameter and may not extend greater than 10 feet waterward of the base of the new seawall. Riprap shall be installed in a manner which prevents it from shifting or relocating. This condition shall be satisfied within 30 days of the completion of the seawall.
- 15. Please be advised that the federal government may have designated all or part of the subject property as critical habitat for one or more endangered species. You are not authorized to commence any work or activities pursuant to this permit until you obtain any and all approvals or permits, if necessary, from the federal government pursuant to the Endangered Species Act and from the State of Florida pursuant to Florida law on endangered species. Please be advised that, even after work commences, if Miami-Dade County is advised by the federal government, the State of Florida, or a court that an activity on the subject property is in violation of the Endangered Species Act, in violation of Florida law on endangered species, or in violation of a permit or approval granted by the federal government pursuant to the Endangered Species Act, such violation may result in an immediate stop work order. You are strongly advised to consult with the United States Fish and Wildlife Service and any other necessary federal or state agencies before conducting any work or activities on the property. The Vero Beach office of the United States Fish and Wildlife Service may be reached at (772) 562-3909. Please be aware that the federal government may require certain actions or protections on the property, and this may result in the need to modify the plans for the property. Therefore, it is recommended that you consult with the United States Fish and Wildlife Service at an early stage in the process. In the event that the United States Fish and Wildlife Service advises that your plans for the subject property may result in a "take" of endangered or threatened species, you are strongly recommended to inform Miami-Dade County in writing at the earliest stage possible.

See General Permit Conditions.

#### **General Permit Conditions**

- 1. This permit does not eliminate the necessity to obtain any required federal, state, and local authorizations prior to the start of any activity approved by this permit. This permit is a regulatory approval and does not convey to the permittee or create in the permittee any property right or privilege, or any interest in real property, nor does it authorize any entrance upon or activities on property which is not owned or controlled by the permittee. In the event that any structure authorized hereunder is determined by a final adjudication issued by a court of competent jurisdiction to encroach on or interfere with adjacent riparian rights, the permittee agrees to either obtain written consent for the offending structure from the affected riparian owner or to remove the interference.
- 2. This permit must be kept on-site during all phases of construction.
- 3. All work shall be performed in accordance with the above referenced plans and in accordance with the attached specific and general permit conditions. If a General Condition(s) conflicts with a Specific Condition(s) in this permit document, the Specific Condition shall be the controlling condition for work authorized by this permit.
- 4. This permit only authorizes the work described under the Project Description. Any additional work in, on, over or upon tidal waters or coastal wetlands at the property shall require additional Class I approval.
- 5. Any deviation from the approved plans for this project shall be submitted in writing to, and approved by DERM prior to the commencement of this project. The contractor and the permittee shall take whatever remedial action

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is necessary to bring the project into compliance with the permit and approved plans upon determination by DERM that the structure is not in compliance with such.

- 6. DERM shall be notified no later than 48 hours and no earlier than 5 days prior to the commencement of the work authorized by this permit, unless otherwise noted herein. The permittee and/or contractor may notify DERM by calling (305) 372-6575 or by submitting the attached Notice of Commencement of Construction via hand delivery, U.S. Mail, or facsimile at (305) 372-6479.
- 7. Prior to performing any work, the contractor shall verify the location of all underground and overhead utility lines and verify that no utilities will be damaged by the work. Contact Sunshine State One-Call of Florida at 1-800-432-4770 or on the web at http://www.callsunshine.com/corp/before/submitting.html for locating underground utility lines.
- 8. The permittee and the contractor are hereby advised that under Florida law, no person shall commence any excavation, filling, construction, or other activity involving the use of sovereign or other lands of the State, title to which is vested in the Board of Trustees of the Internal Improvement Trust Fund or the Florida Department of Environmental Protection (FDEP), until such person has received the required authorization for the proposed use from the Board of Trustees or FDEP. If such work is done without consent, or if a person otherwise damages state land or products of state land, the Board of Trustees may levy administrative fines of up to \$10,000 per offense pursuant to the Florida Administrative Code.
- 9. The permittee and contractor shall obtain all required approvals from all local, state and federal agencies prior to performing the work authorized by this permit.
- 10. Trimming or alteration of mangroves or work in wetlands other than what is authorized by this permit is prohibited. Work not authorized by this permit or that is not explicitly exempt from permit requirements pursuant to the Mangrove Trimming and Preservation Act (403.9321-9334 F.S.) shall require additional Class I approval.
- 11. For any work involving mangrove trimming or alteration, if the subject Class I permit is revoked by DERM, or the state statute providing the exemption is modified or eliminated, the permittee shall be required to obtain a new permit from DERM prior to mangrove trimming or alteration.
- 12. All work authorized by this permit shall be performed by the contractor and/or subcontractor holding an applicable certificate of competency and shall be licensed in Miami-Dade County to perform such work. Any work which is subcontracted shall require that the permittee or contractor (i.e. the permittee or contractor who is listed on this permit) notify the project manager at DERM at (305) 372-6575 or by facsimile at (305) 372-6479 a minimum of 72 hours prior to the subcontractor performing any work. Notification shall include the name of the subcontractor performing the work, the subcontractor's Miami-Dade County license number or state general contractor license number, and scope of work. Failure to comply with this condition is a violation of the Class I permit and may result in enforcement action DERM.
- 13. The contractor shall not store or place, even on a temporary basis, construction materials or demolition debris in tidal waters and shall take all necessary precautions to prevent construction material or demolition debris from falling into the water or adjacent wetlands. Any debris that falls into the water and/or adjacent wetlands shall be removed immediately. Construction material and demolition debris shall be disposed of in accordance with all federal, state and local regulations.
- 14. Turbidity controls (such as, but not limited to, turbidity curtains) shall be implemented whenever visible plumes are present to ensure compliance with the water quality standards stipulated in Section 24-42(3) of the Code of Miami-Dade County. Turbidity controls shall be employed and maintained in the most effective manner possible to prevent turbidity from extending beyond the control mechanism in place.
- 15. Turbidity may not exceed 0 Nephelometric Turbidity Units (NTU) within the Aquatic Preserve or 29 NTU outside of the Aquatic Preserve, above background beyond the turbidity control device or 50 feet from any point of discharge. Turbidity levels shall be monitored. If the turbidity levels exceed the above standards, all construction shall stop and additional turbidity controls shall be implemented. Work shall not resume until the contractor has implemented adequate turbidity control methods and has received authorization from DERM to recommence

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- work. At DERM's discretion, turbidity samples may be required to be collected in accordance with Section 24-44.2(3) of the Code of Miami-Dade County.
- 16. Environmental controls and best management practices must be implemented to prevent any materials related to construction from entering the surrounding water. Any material removed as well as material applied to accomplish repairs must be contained so as to prevent fugitive particulates and/or discharge to surface waters. Any materials which fall into the water shall be removed immediately. The contractor shall ensure that no material is placed in the water either temporarily or permanently.
- 17. If any work or activity associated with this project is to take place in navigable waters, the contractor shall instruct all personnel associated with the project of the potential presence of manatees and the need to avoid collision with manatees. All vessels associated with the project must operate at "Idle Speed/No Wake" at all times while in water where the draft of the vessel provides less than a 4 foot clearance from the bottom. Additionally, all vessels will follow routes of deep water whenever possible. All in-water construction activities shall cease upon the sighting of a manatee(s) within 50 feet of the project area and will not resume until the manatee(s) has departed the project area. Any collision with and/or injury to a manatee shall be reported immediately to the "Manatee Hotline" (1-888-404-FWCC), the U.S. Fish and Wildlife Service, Jacksonville Field Office (904) 791-2580, and DERM (305) 372-6864.
- 18. The contractor shall ensure that all vessels associated with the construction shall operate within waters of sufficient depth so as to preclude bottom scouring or prop dredging and shall maintain a minimum of 1 foot of water between the vessel bottom and submerged aquatic resources.
- 19. The contractor shall ensure that there are no impacts to seagrass, hard corals, or soft corals as a result of construction operations, such as, but not limited to, propeller scouring; and vessel or barge anchoring, grounding or spudding. The marine contractor and permittee shall be held jointly liable for any of these unauthorized impacts. For any impacts caused by the construction operation, DERM shall require, at a minimum, restoration and mitigation.
- 20. For the purposes of this permit, "vessel" is herein defined as any craft designed to float or navigate on water, including but not limited to: sailboats, powerboats, rowboats, boats, ships, skiffs, houseboats, personal watercraft and inflatable boats.
- 21. Pursuant to Section 24-48.10 of the Code of Miami-Dade County the work or structures authorized under this permit shall be privately maintained by the permittee, his successors and assigns. Whenever, in the opinion of the Director of the DERM, said work or structures are not maintained in such a manner so as to prevent deterioration to the extent that they become a hazard to the public or to navigation, or create an obstruction of flow, or prevent access for drainage maintenance purposes, or may damage adjacent property, then the owner is required to perform any necessary remedial work.
- 22. Unless otherwise authorized in this permit and pursuant to Sections 24-48.23 and 24-48.24 of the Code of Miami-Dade County, the installation or construction of non-water-dependent floating or fixed structures (e.g. covered structures, canopies, helicopter pads, commercial signs, etc.) is prohibited in, on, over or upon any of the tidal waters of Miami-Dade County and constitutes a violation of this permit. Failure to comply with this condition may subject the permittee to enforcement action without further warning.
- 23. A DERM Class II permit is required for the construction, installation, and/or alteration of any outfall or overflow system in, on, under or upon any water body of Miami-Dade County. In addition, a DERM Class V permit is required for any dewatering of groundwater, surface waters or water, which has entered into an excavation. The contractor shall contact the Water Control Section of DERM at (305) 372-6681 in order to obtain a Class II or Class V permit prior to the construction of any outfall or overflow system and prior to any dewatering activity.
- 24. The time allotted to complete the work for which this permit has been issued shall be limited to the period stipulated on the permit unless an extension of time is granted pursuant to Section 24-48.9(2) of the Code of Miami-Dade County. Applications for extensions of time shall be submitted to DERM at least 30 days prior to the date of permit expiration; incomplete or untimely applications for extensions of time will be returned to the permittee.

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- 25. An application for Transfer of a Class I permit may be filed with DERM at any time prior to the transfer of property ownership up to 120 days after the date of transfer of fee simple ownership of the property that is the subject of the permit. The Application for Transfer must be signed by both the transferee and transferor. Applications for Transfer shall be filed in the form prescribed by DERM and shall not be processed if the filed Application for Transfer is not fully complete in all respects pursuant to Section 24-48.18, of the Code of Miami-Dade County within 120 days of the date of transfer of property ownership.
- 26. If the project involves construction, replacement, or repair of a seawall, the new seawall cap shall be a minimum of 6 inches above the final grade of the uplands immediately adjacent, and in order to prevent positive drainage of stormwater into the waterway, all uplands immediately adjacent to the new seawall shall be graded away from the waterway.
- 27. To further reduce the possibility of injuring or killing a manatee during construction, work within portions of the Biscayne Canal, Little River, and the Coral Gables Waterway shall be performed only between May 1 and November 15.
- 28. A minimum of 1 foot of clearance shall be maintained at all times between the submerged bottom, and any existing benthic resources, and any vessels moored at the property.
- 29. Adequate clearance shall be maintained at all times between the submerged bottom, and any existing benthic resources, and any vessels moored at the property, such that there are no impacts to State or County water quality standards, even on a temporary basis, or to benthic resources or the submerged bottom, including but not limited to bottom scouring or prop dredging.
- 30. If railing is required to be installed pursuant to this permit, it shall be installed within 30 days of completion of the permitted work, and prior to the use of the structure(s) authorized by this permit, including the mooring of vessels.
- 31. A performance and/or mitigation bond may be held to ensure compliance with the aforementioned conditions and the completion of any required mitigation. Failure to comply with any of these conditions may result in the revocation by Miami-Dade County of all or a portion of the bond without further notice.
- 32. Pursuant to Section 24-48.3.(9), the use or installation of unencapsulated polystyrene as defined in Section 24-5 shall be prohibited in connection with any work requiring a Class I permit. Pursuant to Section 24-48.26, for all facilities which are subject to a County marine facilities operating permit pursuant to this chapter, such permit shall require the removal, replacement or repair of any unencapsulated polystyrene where such polystyrene shows evidence of degradation, disintegration, shredding, or other damage, as determined in the discretion of the Director.
- 33. Please be advised that chapter 18C of the Miami-Dade County Code has designated Fertilizer-Free Zones on properties throughout the County that contain or lie adjacent to any open body of water, including Biscayne Bay, wetlands, other surface waters, or that contain or lie adjacent to stormwater drains and seawalls. The Fertilizer-Free Zone is defined as that area, as measured from the top of bank, within twenty (20) feet of any open body of water, including Biscayne Bay, wetlands, other surface waters, or within twenty (20) feet of any stormwater drain or seawall. The application of any fertilizer within a Fertilizer-Free Zone is strictly prohibited at all times. Violations of this requirement may be punished by fines in accordance with chapter 8CC of the Code and may require restoration of animal, plant, and aquatic life in accordance with the provisions in chapter 24 of the Code. For further information, please visit <a href="https://www.miamidade.gov/fertilizer">www.miamidade.gov/fertilizer</a>.

<u>CLI-2024-0221</u> Page: 7 of 10



## DEPARTMENT OF REGULATORY AND ECONOMIC RESOURCES COASTAL RESOURCES SECTION

701 NW 1<sup>st</sup> Court, Ste 600, Miami, FL 33136 Phone 305-372-6575 Email dermcr@miamidade.gov


#### NOTICE OF COMMENCEMENT OF CONSTRUCTION


PERMIT NO.:
PERMITTEE'S NAME:
PROJECT LOCATION:
PERMIT ISSUANCE DATE:
CONTRACTOR NAME:
PROPOSED DATE OF COMMENCEMENT:
ANTICIPATED DATE OF COMPLETION:
COMMENTS:

THIS PERMIT AND PLANS SHALL BE KEPT ON SITE DURING ALL PHASES OF CONSTRUCTION

<u>CLI-2024-0221</u> Page: 8 of 10

#### Northeast 110th Street

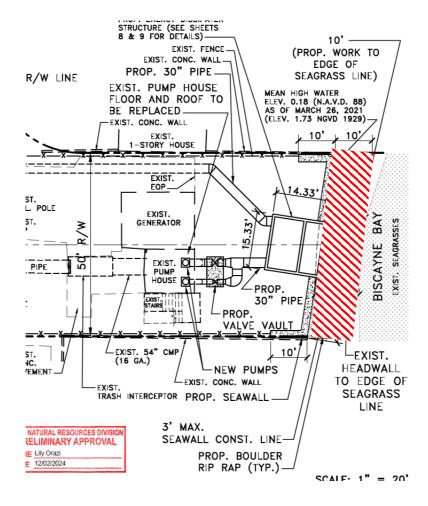

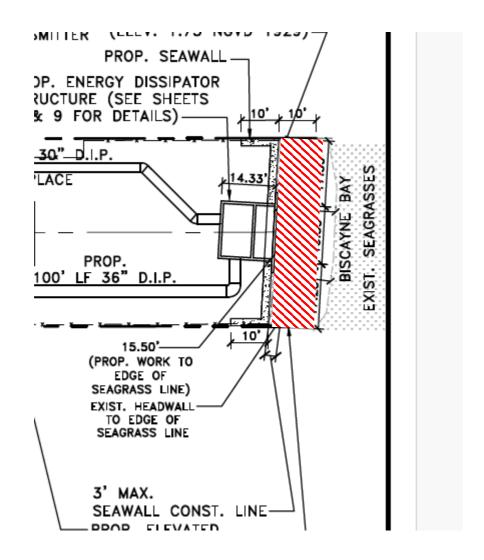

<u>CLI-2024-0221</u> Page: 10 of 10



#### **Regulatory and Economic Resources**

Environmental Resources Management 701 NW 1st Court, 6th Floor Miami, Florida 33136-3912 T 305-372-6567 F 305-372-6407

May 13, 2025

RE: Miami-Dade County Class II Permit No. 20240028: located at N BAYSHORE DR BETWEEN NE 109 ST & 110 ST UNIC, FL 00000-

Dear JOSIEL FERRER-DIAZ:

Enclosed is a copy of Class II Permit No. 20240028, pursuant to the provisions of Section 24-48 of the Miami-Dade County code. Please call or notify this office no later than forty eight(48) hours and no earlier than five(5) days prior to the commencement of work authorized by this permit, by submitting the attached Notice of Commencement of Construction via U.S. Mail, or by email dermwatercontrol@miamidade.gov.

Sincerely,

Marsel Fakhrutdinov, P.E.

Senior Professional Engineer, Water Control Section

Division of Environmental Resources Management

Enclosure





#### **Regulatory and Economic Resources**

Environmental Resources Management 701 NW 1st Court, 6th Floor Miami, Florida 33136-3912 T 305-372-6567 F 305-372-6407

#### NOTICE OF COMMENCEMENT OF CONSTRUCTION

Permit Number: CLII - 20240028

Issue Date: May 13, 2025

Expiration Date: May 13, 2027

Project Name: BISCAYNE SHORES 109 & 110 PUMP STATION RETROFIT

Location: N BAYSHORE DR BETWEEN NE 109 ST & 110 ST UNIC, FL 00000-

Permittee: JOSIEL FERRER-DIAZ

MDC DEPARTMENT OF TRANSPORTATION AND PUBLIC WORKS

Professional Engineer: Mr. NELSON H ORTIZ

GRAEF NELSON H. ORTIZ, PE

MUST BE FILLED IN BY PERMITTEE OR CONTRACTOR:

S'I'AR'.	I. DA	чл. Е. :				_	
DATE	OF	COMP	LETION	:			



#### OFFICIAL DOCUMENT

#### **Regulatory and Economic Resources**

Environmental Resources Management 701 NW 1st Court, 6th Floor Miami, Florida 33136-3912 T 305-372-6567 F 305-372-6407



Permit Number: CLII-20240028 Issue Date: 05/13/2025
Project Manager: MAYRA A DE TORRES Expiration Date: 05/13/2027

#### Permittee:

MDC DEPARTMENT OF TRANSPORTATION AND PUBLIC WORKS JOSIEL FERRER-DIAZ 7100 NW 36TH STREET MIAMI, FL 33166-

Class II Drainage Construction Permit

#### Professional Engineer:

GRAEF NELSON H. ORTIZ, PE Mr. NELSON H ORTIZ 9200 S. DADELAND BLVD., SUITE 601 MIAMI, FL 33156-

Application Name: BISCAYNE SHORES 109 & 110 PUMP STATION RETROFIT

Project Location:

N BAYSHORE DR BETWEEN NE 109 ST & 110 ST UNIC, FL 00000-

#### Project Description:

The proposed project is for the drainage improvement of storm drainage Pump Station 109 and 110 serving the Miami-Dade County Department of Transportation and Public Works. This project proposes to improve two existing pump station (PS 109 and 110) to making them more efficient and more capable of handling more significant storm events, as wells as, storm surges.

The retrofit project includes upgrades to both pump stations such as a new roof and floor for the 110 pump house: new pumps, emergency back-up generators for both stations, dissipater structures. The water quality for the site remains in place by the existing twelve (12) storm drainage wells permitted under the Florida Department of Environmental Protection (FDEP) Permit No. UC 13-293899 and the South Florida Water Management District (SFWMD) Environmental Resources Permit (ERP) No. 13- 00820-S. All construction activities must be conducted according to the signed and sealed plans by Nelson H. Ortiz, P.E., Graef, on January 30, 2025 (19 Pages).

Based on the information provided, the Department has determined that the project is consistent with Chapter 24-48 of the Code of Miami Dade County.

#### Specific Conditions:

THE ABOVE NAMED PERMITTEE IS HEREBY AUTHORIZED TO PERFORM THE WORK SHOWN ON THE APPLICATION AND APPROVED DRAWINGS, PLANS, AND OTHER DOCUMENTS ATTACHED HERETO OR ON FILE WITH THE DEPARTMENT AND MADE PART HEREOF, SUBJECT TO THE ATTACHED GENERAL AND SPECIAL CONDITIONS.

THIS PERMIT AND PLANS SHALL BE KEPT ON SITE DURING ALL PHASES OF CONSTRUCTION

Page 1 of 6



- 1. Contractor's information must be provided to this office prior to the commencement of this project.
- 2. The contractor shall comply with the terms and conditions of the approved Miami-Dade County RER DERM Class I Permit CLI-2024-0221.
- 3. The contractor shall take all the necessary measurement to prevent any adverse environmental impact over adjacent properties and/or bodies of water.
- 4. All works authorized by this permit shall be maintained and operated in accordance with the requirements of Chapter 24 of the Code of Miami-Dade County for the life of the system. Should the permittee and/or DERM become aware that discharges from the system do not meet water quality standards pursuant to Section 24-42 of the Code of Miami-Dade County, the permittee shall make such changes to the system as deemed necessary by DERM in order to meet water quality standards.
- 5. The permittee shall ensure that once construction is completed and prior to the start of operation, the proposed drainage system is thoroughly cleaned in order to prevent adverse environmental impacts as referenced above.
- 6. The contractor shall ensure that all turbidity control devices are in place to avoid bottom scouring or dredging and maintain a minimum of 1 foot of clearance between the bottom of the device and any submerged aquatic resources.
- 7. Installation of temporary pollution prevention measures such as floating turbidity barriers and silt fences are required to minimize adverse impacts to natural resources.
- 8. The applicant is advised that a permit from the South Florida Water Management District may be required for the proposed project. It is the applicant's responsibility to contact this agency for more information regarding permit and procedures.
- 9. If solid waste or debris other than clean fill is encountered, the contractor shall provide a plan for the removal and proper disposal of all unsuitable material, within the limits of the work, for review and approval by DERM. Any fill material to be used shall be in accordance with the clean fill requirements of Chapter 24 of the Miami-Dade County Code.
- 10. The contractor shall take all the necessary measures to keep pollutants of any kind, including oil, grease, and debris from entering any body of water and adjacent properties.
- 11. The Permittee shall employ turbidity controls methods and best management practices to prevent adverse impact to the existing storm sewer system along the street areas and adjacent properties.
- 12. Please note, any construction activities that require dewatering will require a Class V permit, pursuant to Section 24-48.1(1)(e) of the Miami-Dade County Code. Class V permits are required for any dewatering of groundwater, surface water, or water which has entered into an underground facility, excavation, or trench.

#### General Conditions:

- 13. DERM shall be notified no later than forty-eight (48) hours and no earlier than five (5) days prior to the commencement of the work authorized by this permit, unless otherwise noted herein. The permittee and/or contractor may notify DERM by calling (305) 372-6681 or by submitting the attached Notice of Commencement of Construction via hand delivery, U.S. Mail, or facsimile at (305) 372-6489.
- 14. This permit or a copy thereof, complete with all conditions, attachments, exhibits and modifications shall be kept at the work site of the permitted activity. The complete permit shall be available for review at the work site upon request by DERM staff. The permittee shall require the contractor to review the complete permit prior to the commencement of the activity authorized by this permit.

MIAMI-DADE

COUNTY

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#### **Regulatory and Economic Resources**

Environmental Resources Management 701 NW 1st Court, 6th Floor Miami, Florida 33136-3912 T 305-372-6567 F 305-372-6407

miamidade.gov

- 15. All of the plans and documents referenced on page 1 of this permit are part of the conditions of this permit. In the case of a conflict between any of the approved plans and any condition of this permit, a determination as to which plan or condition to be followed will be made by DERM.
- 16. This permit only authorizes the grading and drainage work summarized in page 1 of this permit. Any additional work not shown in this permit or on the approved plans shall require additional Class II permit approval.
- 17. This Class II Permit does not authorize any dewatering activities on the subject property. A separate Class V Permit from the Department, (305) 372-6681, is required for this activity.
- 18. The time allotted to complete the work for which this permit has been issued shall be limited to the period stipulated on the permit unless the permittee requests an extension of time from DERM. The time extension request form must be submitted at least thirty (30) calendar days prior to the time of expiration of the time period set forth in the permit or in a prior extension of time. Applications for extensions of time that are not timely filed pursuant to Section 24-48.9(2)(b) of the Code of Miami-Dade County will be returned to the applicant.
- 19. The permittee must allow DERM representatives to inspect the authorized activity during normal business hours to ensure that the work authorized through this permit is being, or has been accomplished in accordance with the terms and conditions of this permit.
- 20. Compliance with Chapter 24 of the Code of Miami-Dade County as well as all General and Specific Conditions contained in this permit, is required. If DERM determines that the permittee and/or contractor is not performing the construction in accordance with the conditions of the permit, the Code, or the approved plans upon which the permit was issued, DERM may order suspension of the permit or the stopping of work until such time as the permittee and/or the contractor has complied with the permit, plans or standards. In such case, the permittee or the contractor or both shall take all necessary precautions to leave the work area in a safe and secure condition.
- 21. If any contamination is encountered on site during construction, the contractor shall immediately cease all subsurface disturbances and notify the Department by calling (305) 372-6955, (305) 372-6700, or (305) 372-6681.
- 22. The permittee shall be responsible for establishing adequate measures and engineering controls during construction to ensure compliance with the water quality standards stipulated in Section 24-42(3) of the Code of Miami-Dade County.
- 23. The permittee shall apply sediment and erosion control measures along the perimeter of the construction site to protect the adjacent properties from sediment and turbidity discharge and erosion damage.
- 24. Turbidity may not exceed twenty-nine (29) Nephelometric Turbidity Units (NTU's) above background within surrounding surface waters, and within Outstanding Florida Waters, the standards is no degredation above background levels. If the turbidity levels exceed the above standard, all construction activity shall stop and additional turbidity controls shall be implemented. The construction activity shall not resume until the contractor has received authorization from DERM. At DERM's discretion, turbidity samples may be required and shall be collected in accordance with Section

THIS PERMIT AND PLANS SHALL BE KEPT ON SITE DURING ALL PHASES OF CONSTRUCTION

Page 3 of 6



24-44.2(3) of the Code of Miami-Dade County, or as specified by DERM, and the results sent directly to the review engineer.

- 25. The permittee shall hold and save Miami-Dade County harmless from any and all damages, claims, or liabilities which may arise by reason of the construction, alteration, operations, maintenance, removal, abandonment or use of any system authorized by this permit.
- 26. The permittee shall take all necessary precautions to prevent construction or demolition debris from falling into adjacent water bodies or wetlands. Any debris that falls into the adjacent water bodies or wetlands shall be removed immediately via a methodology approved by DERM. Construction and demolition debris shall be disposed of in accordance with all Federal, State and Local regulations.
- 27. Any water body affected by the construction activity should be restored to its pre-existing condition prior to the commencement of the work covered by this permit. The permittee shall also be responsible for ensuring complete removal of accumulated sediments, turbidity curtains, and other devices in a water body that would reduce its conveyance or storage capacity. The permittee is responsible in securing any permits required for this restoration work.
- 28. The permittee shall comply with the provisions of Chapter 16A of the Code of Miami-Dade County related to Historic Preservation to preserve known and potential archeological resources in the area that are subject to this permit.
- 29. A NPDES (National Pollutant Discharge Elimination System) Stormwater Permit may be required as per Rule 62-621.300(4), F.A.C. for the proposed construction activity. Please contact the Florida Department of Environmental Protection NPDES Stormwater Section at (850) 245-7522 or www.dep.state.fl.us/water/stormwater/NPDES.
- 30. If any work or activity associated with this project is to take place in-water:
  - a. All personnel associated with the project shall be instructed about the presence of manatees and manatee speed zones, and the need to avoid collisions with and injury to manatees. The permittee shall advise all construction personnel that there are civil and criminal penalties for harming, harassing, or killing manatees which are protected under the Marine Mammal Protection Act, the Endangered Species Act, and the Florida Manatee Sanctuary Act.
  - b. All vessels associated with the construction project shall operate at "Idle Speed/No Wake" at all times while in the immediate area and while in water where the draft of the vessel provides less than a four-foot clearance from the bottom. All vessels will follow routes of deep water whenever possible.
  - c. Siltation or turbidity barriers shall be made of material in which manatees cannot become entangled, shall be properly secured, and shall be regularly monitored to avoid manatee entanglement or entrapment. Barriers must not impede manatee movement.
  - d. All on-site project personnel are responsible for observing water-related activities for the presence of manatee(s). All in-water operations, including vessels, must be shutdown if a manatee(s) comes within 50 feet of the operation. Activities will not resume until the manatee(s) has moved beyond the 50-foot radius of the project operation, or until 30 minutes elapses if the manatee(s) has not reappeared within 50 feet of the operation. Animals must not be herded away or harassed into leaving.
  - e. Any collision with or injury to a manatee shall be reported immediately to the FWC Hotline at 1-888-404-3922 and RER at 305.372.6452. Collision and/or injury should also be reported to the U.S. Fish and Wildlife Service (1-772-562-3909) for south Florida, and to FWC at ImperiledSpecies@myFWC.com
  - f. Temporary signs concerning manatees shall be posted prior to and during all in-water project activities. All signs are to be removed by the permittee upon completion of the project. Temporary signs that have already been approved for this

THIS PERMIT AND PLANS SHALL BE KEPT ON SITE DURING ALL PHASES OF CONSTRUCTION

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#### **Regulatory and Economic Resources**

Environmental Resources Management 701 NW 1st Court, 6th Floor Miami, Florida 33136-3912 T 305-372-6567 F 305-372-6407



use by the Florida Fish and Wildlife Conservation Commission (FWC) must be used (see MyFWC.com/manatee). One sign which reads Caution: Boaters must be posted. A second sign measuring at least 81/2" by 11" explaining the requirements for "Idle Speed/No Wake" and the shut down of in-water operations must be posted in a location prominently visible to all personnel engaged in water-related activities. Questions concerning these signs can be sent to the email address listed above.

- 31. All work authorized by this permit shall be performed by the contractor and/or subcontractor holding an applicable certificate of competency and shall be licensed in Miami-Dade County to perform such work. Any work that is subcontracted shall require that the permittee and contractor (i.e. the contractor listed on this permit) notify the review engineer at (305) 372-6681 or by facsimile at (305) 372-6489 a minimum of seventy-two hours prior to the subcontractor performing any work. Notification shall include the name of the subcontractor performing the work, the subcontractor's Miami-Dade County license number or state general contractor license number and scope of work.
- 32. It is a violation of the Code to perform any work authorized pursuant to this permit if the permittee(s) sell or otherwise transfer ownership of the property unless DERM has approved an Application for Transfer. An Application for Transfer may be filed with DERM at any time prior to the transfer of property ownership and, for a limited time, after the transfer of property ownership and must be signed by both the proposed transferee and transferor. Applications for Transfer shall be filed in the form prescribed by DERM and shall not be processed if the filed Application for Transfer is not fully complete in all respects pursuant to Section 24-48.18 of the Code within 120 days of the date of transfer of property ownership. The project must be in compliance with all the restrictions, limitations, and conditions of this permit at the time of submittal of the Application for Transfer and continuously throughout the time period during which the application is being processed.
- 33. A performance and/or mitigation bond may be held to ensure compliance with the aforementioned conditions and the completion of any required mitigation. Failure to comply with any of these conditions may result in the revocation by Miami-Dade County of all or a portion of the bond without further notice. The bond shall remain in force for up to six (6) months after the approved completion date if the work covered by the bond.
- 34. If the engineer who provided certification pursuant to Section 24-48.2(I)(B)(2) of the code or pursuant to Section 24-48.2(II)(A)(4) of the code is discharged by the property owner or his agent, or if said engineer ceases to work on the proposed or approved work, all work allowed by this permit shall immediately cease and shall not be resumed until a new engineer is obtained. The property owner shall also be required to obtain a new engineer who shall meet all the requirements of this permit.
- 35. Issuance of a this permit does not relieve the applicant from obtaining all required federal, State and local permits.
- 36. Within thirty (30) days after completion of the work, the permittee or contractor shall file record drawings or as-builts certified by the engineer of record with DERM.
- 37. FOR CONSTRUCTION ACTIVITIES THAT DISTURB ONE (1) ACRE OR GREATER, A NPDES GENERIC

THIS PERMIT AND PLANS SHALL BE KEPT ON SITE DURING ALL PHASES OF CONSTRUCTION

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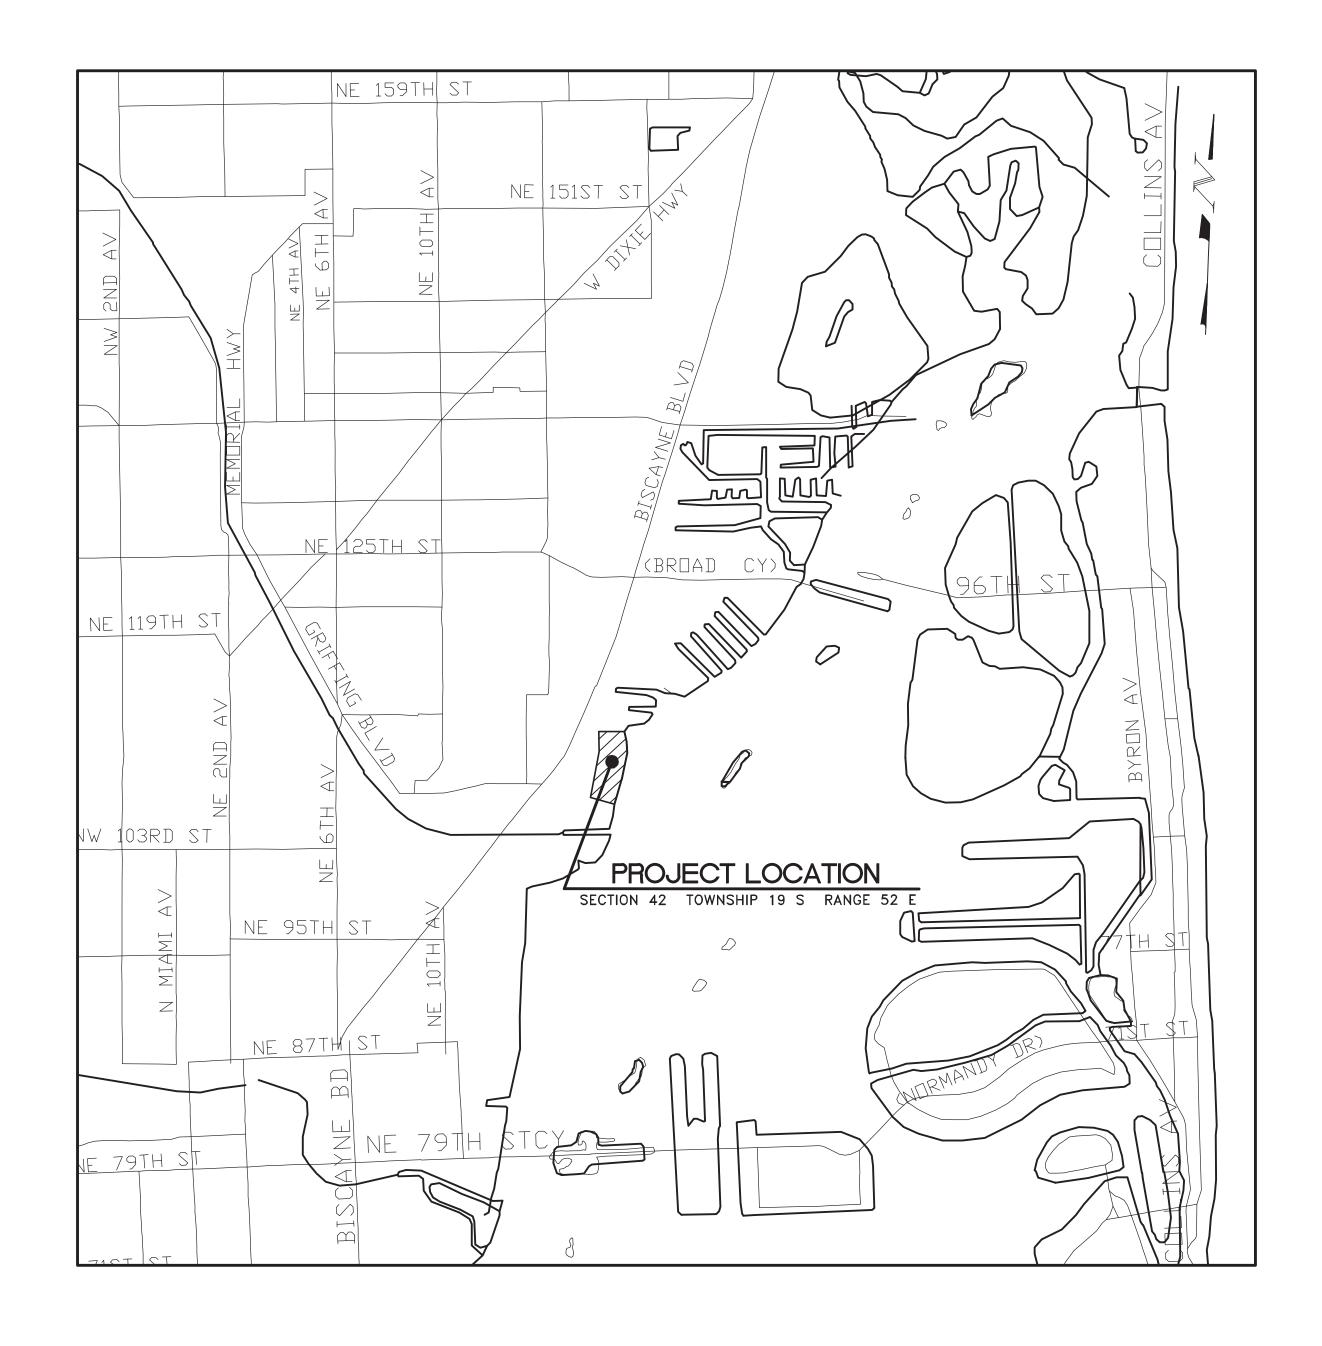
PERMIT IS REQUIRED. To apply for this permit call FDEP Stormwater Program: (850) 245-7522 or visit Florida DEP NPDES website at: http://www.floridadep.gov/water/stormwater/content/construction-activity-cgp

38. The permittee shall retain a copy of the stormwater pollution prevention plan (SWPP) and all reports, records and documentation required by this permit at the construction site, or an appropriate alternative location as specified in the Notice of Intent (NOI), from the date of project initiation to the date of final stabilization. Please refer to DEP Document No. 62-621.3000 (4) (a): http://www.dep.state.fl.us/water/stormwater/npdes/docs/cgp.pdf

THIS PERMIT AND PLANS SHALL BE KEPT ON SITE DURING ALL PHASES OF CONSTRUCTION


# BISCAYNE SHORES PUMP STATION RETROFIT No. 109 AND 110

# DTPW PROJECT NO. 20180139




LOCATION MAP SCALE: APPROX. 1" = 2,000'

COVER SHEET

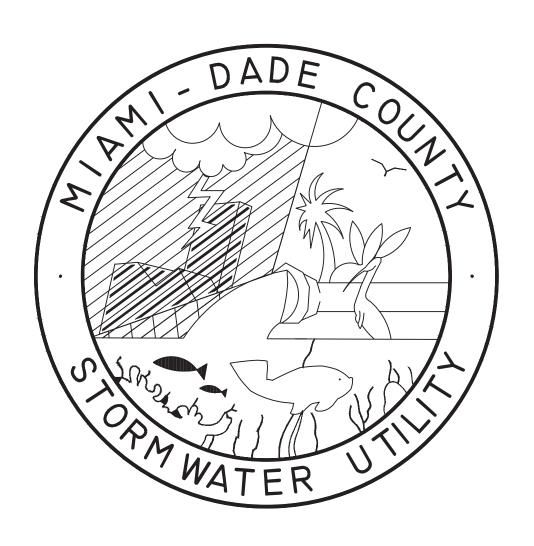


## INDEX OF DRAWINGS

SHT. No.	DESCRIPTION
C-1	COVER SHEET
C-2	QUANTITIES, PAY ITEMS, AND NOTES
C-3	PS 109 EXISTING CONDITIONS/DEMOLITION PLAN
C-4	PS 109 PROPOSED SITE PLAN
C-5	PS 109 PROPOSED PUMP STATION PLAN AND ELEVATION
C-6	PS 109 ELEVATED GENERATOR STRUCTURE
C-7	PS 109 SEAWALL PLAN AND DETAILS
C-8	PS 110 EXISTING CONDITIONS/DEMOLITION PLAN
C-9	PS 110 PROPOSED SITE PLAN
C-10	PS 110 PROPOSED PUMP STATION PLAN AND ELEVATION,
	(SLUICE GATE DETAILS)
C-11	PS 110 PUMP HOUSE RETROFIT DETAILS
C-12	PS 110 SEAWALL PLAN AND DETAILS
C-13	ENERGY DISSIPATOR DETAILS
C-14	SEAWALL DETAILS AND SECTIONS
C-15	TRASH INTERCEPTOR DETAILS
C-16	MISCELLANEOUS DETAILS & NOTES
C-17	STORMWATER POLLUTION PREVENTION PLAN DETAILS AND NOTES
C-18	PS 109 STORMWATER POLLUTION PREVENTION PLAN
C-19	PS 110 STORMWATER POLLUTION PREVENTION PLAN
E-0	SITE LOCATION, LEGEND AND NOTES
E-1	PS 110 EXISTING SITE CONDITIONS/DEMOLITION PLAN
E-2	PUMP STATION 110 ELECTRICAL DEMOLITION PLAN
E-3	PUMP STATION 110 ELECTRICAL NEW WORK PLAN
E-4	PUMP STATION 109 EXISTING CONDITIONS/DEMOLITION PLAN
E-5	PUMP STATION 109 ELECTRICAL NEW WORK PLAN
E-6	POWER RISER DIAGRAM
E-7	PANEL SCHEDULES AND GENERATOR SPECIFICATIONS
E-8	GENERATOR TANK DRAWING

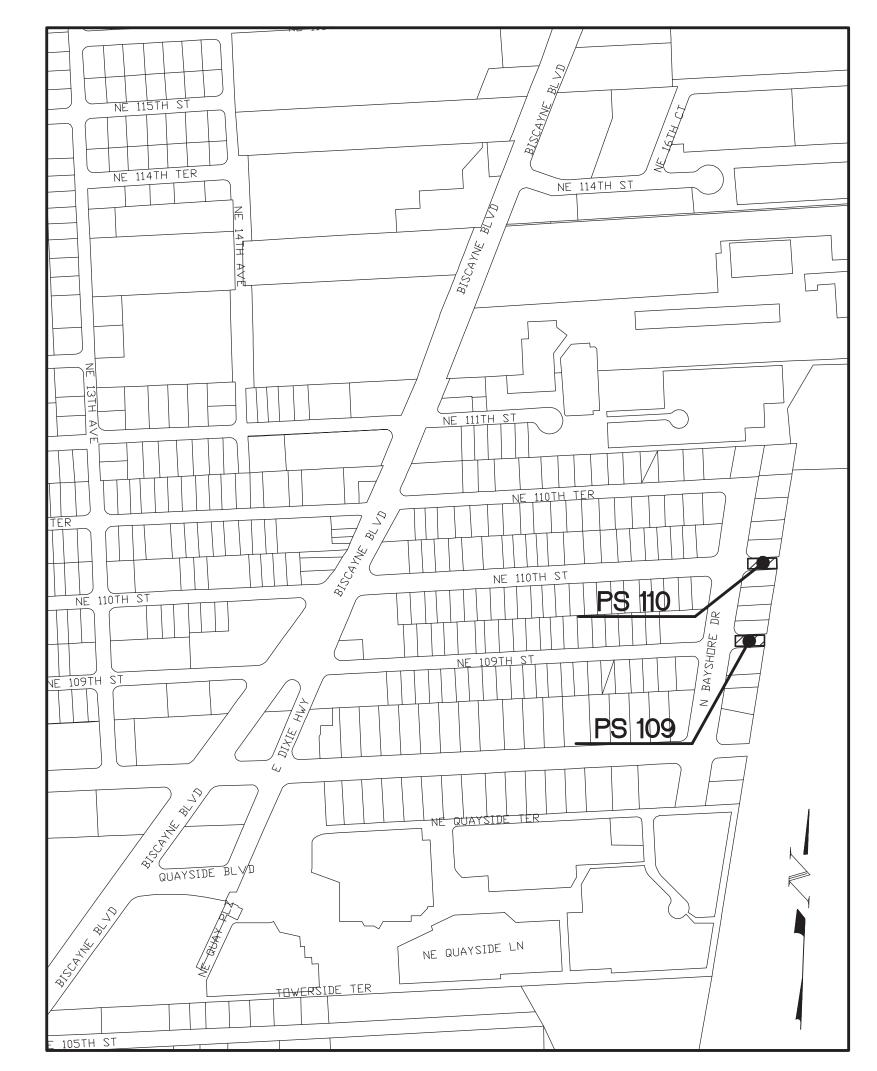

KEY PLAN

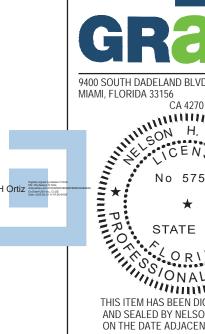

09/13/2024 ADDRESS M-D C COMMENTS

THIS ITEM HAS BEEN DIGITALLY SIGNED AND SEALED BY NELSON H. ORTIZ, P.E. ON THE DATE ADJACENT TO THE SEAL. PRINTED COPIES OF THIS DOCUMENT ARE NOT CONSIDERED SIGNED AND SEALED AND THE SIGNATURE MUST BE VERIFIED FOR THE FIRM:
PROJECT NO.: 2017-7053.01
NELSON H. ORTI


BISCAYNE SHORES PUMP STATIONS

No. 109 AND 110 RETROFIT

MIAMI-DADE

DEPARTMENT OF TRANSPORTATION AND PUBLIC WORKS STEPHEN P. CLARK CENTER 111 NW 1ST STREET, 16TH FLOOR

PROJECT NO. 17053.01	SHEET NO. 1	
DRAWING NO. C-1	OF 28 SH	EETS

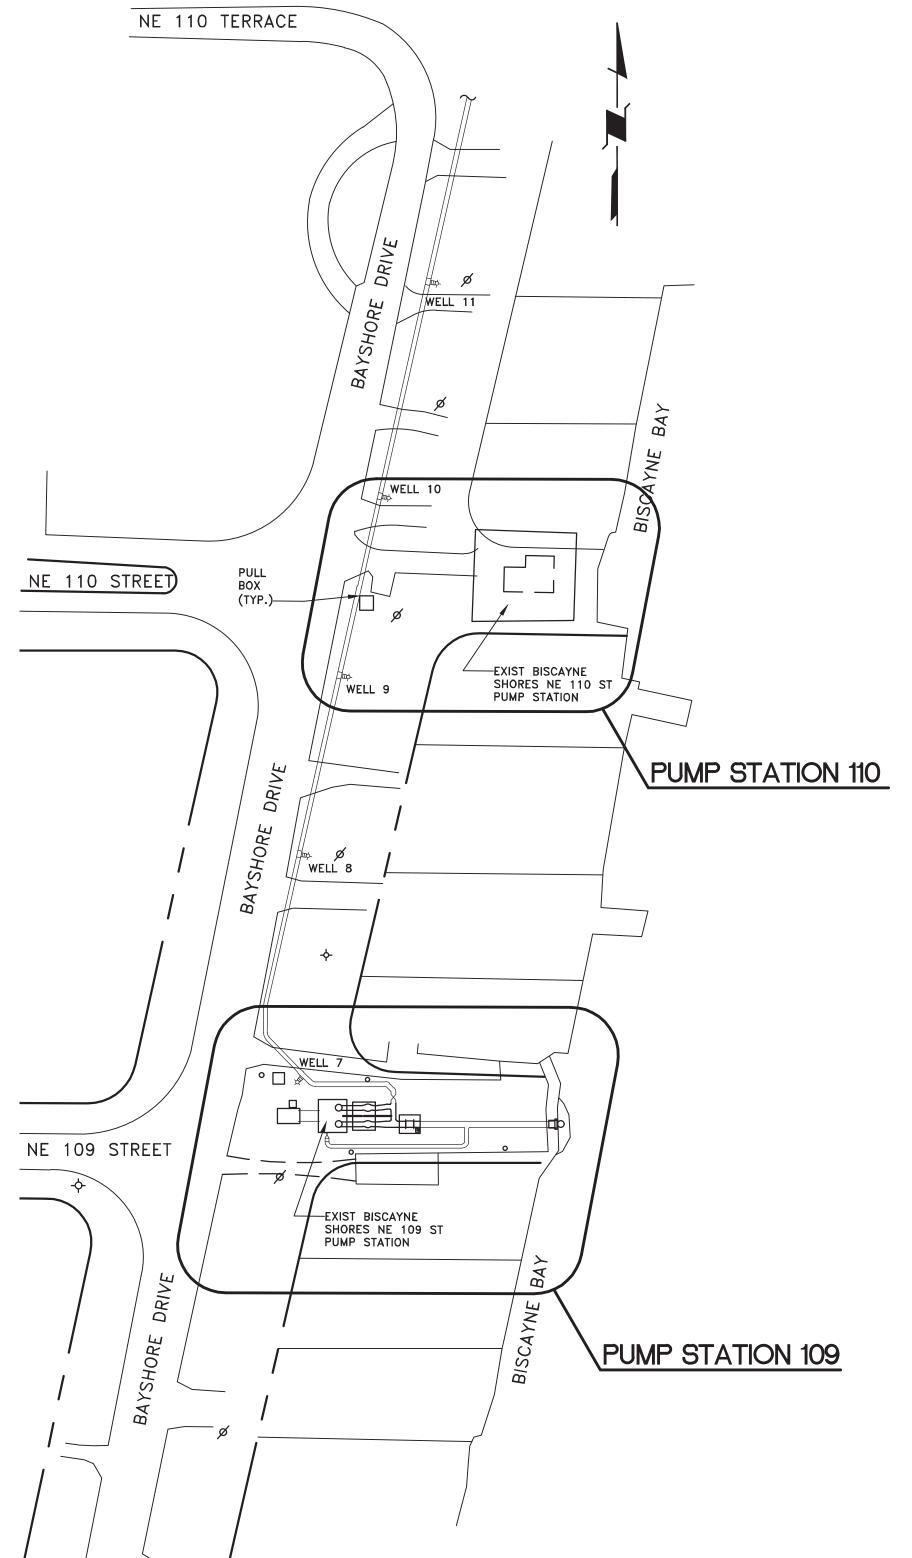

Item No.	Description	Unit	Quantity
102-74-1	Barricades (Temporary - Types I, II, VP and Drum)	E.A./DAY	7,200
104-10-3	Sediment Barrier	L.F.	675
104-11	Floating silt barrier	L.F.	200
104-18	Inlet Protection System	E.A.	2
110-1-1B	Clearing and grubbing	L.S.	1
110-3D	Building Demolition	LS	1
120-6	Embankment	C.Y.	79
334-2-13-1A	Driveway Pavement - Asphalt	S.Y.	159
400-1-15	Class I Concrete [(Miscellaneous) (Trench build-up, collars, pipe plugs, structure plugs etc.) (This item is contingent upon field conditions and may increased decreased or eliminated by the Engineer)]	C.Y.	5
400-11-4	Seawall (Includes reinforcement)	S.F.	840
425-99E	ENERGY DISSIPATING OUTFALL (E.A.)	E.A.	2
430-19-30	Ductile Iron Pipe and Fittings, 30" Diameter	LF	145
430-19-36	Ductile Iron Pipe and Fittings, 36" Diameter	LF	120
430-94-1-1	Desilting Pipe, 0 - 48"	L.F.	190
430-95-2	Desilting Drainage Structure	E.A.	3
430-880-2533	CHECK VALVE (Pipe diameter 18" to 36 or equivalent)	EA	4
446-30-45	30" D.I.P 45 DEGREE BEND	E.A	4
446-30-90	30" D.I.P 90 DEGREE BEND	E.A	1
446-36-90	36" D.I.P 90 DEGREE BEND	E.A	3
446-38-16	30" X 16" D.I.P.CONCENTRIC REDUCER	E.A	1
446-38-30	30" X 24" D.I.P.CONCENTRIC REDUCER	E.A	1
446-38-36	36" X 30" D.I.P.CONCENTRIC REDUCER	E.A	2
447-30-30	30" x 30" Tee	E.A.	1
447-36-36	36" x 36" Tee	E.A.	1
508-72A	Emergency Generator with ATS and Fuel Tank	ASSM.	2
527-2	Detectable Warning on Walking Surface	S.F.	40
550-10-998	FENCE (Type B) (5.1'-6.0' Height)	L.F.	573
200 10 370	Three (1) pe b) (e.1 e.e Height)	13.1	273
550-60-233	Fence Gate - Type B, Sliding/Cantilever, 12' -18- Opening	E.A.	1
550-60-235	Fence Gate, Type B, Sliding/Cantilever, 20.1 – 24' Opening	E.A.	1
550-75-1	REMOVAL AND DISPOSAL OF EXISTING CHAIN LINK FENCE.	L.F.	300
575-2A	Sodding-ST. Augustine, or match existing, includes watering and maintenance. Contingent item based on field conditions, may be increased, or decreased by the engineer.	S.Y.	1,020
580-4-32	Clusia Rosea Shrub	L.F.	160
580-327-3C	Removal and Relocate Existing Coconut Palm Trees	Е.А.	3
600-4	Pump Station Improvements	L.S.	1
639-1-021	Electrical Power Service (FPL)	LS	1
685-118B	Telemetry System	LS	1

## NOTES:

- 1) The Pump Station Improvements item covers, but is not limited to, all work to be completed at the BS 109 and BS 110 Pump
- Stations in the (structure/building footprint). Work is to include the replacement of roof and floor at BS 110, a new generator platform at BS 109, all electrical work, including the parts, associated in the cost of separating both pump station electrical systems; new ultra sonic transmitters and other miscellaneous items. Item price incudes all labor, parts, and permits.
- 2) The Electrical Power Service item includes all work and materials to establish new power and/or reestablish power at the pump stations, which includes all cost to FPL.
- 3) The Telemetry System item includes all work, labor, and materials to establish a new telemetry system and/or re-establish the system at the pump stations.
- 4) The Energy Dissipating Structure items includes the cost of the adjacent approved bank stabilization method and related costs.
  5) The Emergency generator fuel tank shall be full upon delivery.


- GENERAL NOTES
- 1. ELEVATIONS SHOWN REFER TO THE NATIONAL GEODETIC VERTICAL DATUM 1929 (N.G.V.D. 29). SUBTRACT 1.55 FEET FROM ELEVATION SHOWN TO N.A.V.D.
- 2. ALL CONSTRUCTION LAYOUT SHALL BE THE RESPONSIBILITY OF THE CONTRACTOR.
- 3. IT IS THE INTENT OF THESE DRAWINGS TO BE IN ACCORDANCE WITH APPLICABLE CODES AND AUTHORITIES HAVING JURISDICTION. ANY DISCREPANCIES BETWEEN THESE DRAWINGS AND APPLICABLE CODES SHALL BE IMMEDIATELY BROUGHT TO THE ATTENTION OF THE ENGINEER.
- 4. EXISTING UTILITIES SHOWN ARE BASED ON INFORMATION SUPPLIED BY OTHERS. IT SHALL BE THE CONTRACTORS RESPONSIBILITY TO VERIFY ALL UNDERGROUND FACILITIES PRIOR TO THE START OF CONSTRUCTION AND COORDINATE WITH THE VARIOUS UTILITY COMPANIES TO RELOCATE, BY PASS OR OTHERWISE ENSURE THAT UTILITY SERVICES WILL NOT BE INTERRUPTED DURING CONSTRUCTION.
- 5. EXISTING GRADES WERE TAKEN FROM THE BEST AVAILABLE DATA AND MAY NOT ACCURATELY REFLECT PRESENT CONDITIONS. CONTRACTOR SHALL BE RESPONSIBLE FOR FAMILIARIZING HIMSELF WITH CURRENT SITE CONDITIONS, AND SHALL REPORT ANY DISCREPANCIES TO THE ENGINEER PRIOR TO STARTING WORK.
- 6. ALL CONSTRUCTION AND MATERIALS SHALL CONFORM TO APPLICABLE STANDARDS AND SPECIFICATIONS OF THE MIAMI-DADE COUNTY DEPARTMENT OF TRANSPORTATION AND PUBLIC WORKS, MIAMI-DADE COUNTY DRER AND ALL OTHER LOCAL, STATE AND NATIONAL CODES, WHERE APPLICABLE.
- 7. ALL SECTIONS INDICATED HEREIN REFER TO THE MIAMI-DADE COUNTY PUBLIC WORKS MANUAL.
- 8. THE INFORMATION PROVIDED IN THESE DRAWINGS IS SOLELY TO ASSIST THE CONTRACTOR IN ASSESSING THE NATURE AND EXTENT OF CONDITIONS WHICH WILL BE ENCOUNTERED DURING THE COURSE OF WORK. THE CONTRACTORS ARE DIRECTED, PRIOR TO BIDDING, TO CONDUCT WHATEVER INVESTIGATIONS THEY DEEM NECESSARY TO ARRIVE AT THEIR OWN CONCLUSIONS REGARDING THE ACTUAL CONDITIONS THAT WILL BE ENCOUNTERED, AND UPON WHICH BIDS WILL BE BASED.
- 9. LOCATIONS, ELEVATIONS AND DIMENSIONS OF EXISTING FACILITIES AND OTHER FEATURES ARE SHOWN ACCORDING TO THE BEST INFORMATION AVAILABLE AT THE TIME OF THE PREPARATION OF THESE DRAWINGS. THE CONTRACTOR SHALL VERIFY THE LOCATIONS, ELEVATIONS, AND OTHER FEATURES AFFECTING HIS WORK PRIOR TO CONSTRUCTION, AND NOTIFY THE ENGINEER IMMEDIATELY WHEN CONFLICT BETWEEN DRAWINGS AND ACTUAL CONDITIONS ARE DISCOVERED. CONTRACTOR SHALL WORK AS NEEDED TO AVOID CONFLICT WITH EXISTING UTILITIES (NO ADDITIONAL COST SHALL BE PAID FOR THIS WORK). EXISTING UTILITIES SHALL BE MAINTAINED IN SERVICE DURING CONSTRUCTION UNLESS OTHERWISE APPROVED BY THE UTILITY OWNER.
- 10. THE CONTRACTOR SHALL COORDINATE WITH UTILITIES TO ARRANGE RELOCATION AND TEMPORARY SUPPORT OF UTILITY FEATURES, ETC. AS NECESSARY TO COMPLETE THE WORK.
- 11. THE CONTRACTOR SHALL GIVE AT LEAST 48 HOURS NOTICE TO UTILITY COMPANIES TO PROVIDE FOR THE LOCATION OF EXISTING UNDERGROUND UTILITIES IN ADVANCE OF CONSTRUCTION. CONTACT UTILITIES NOTIFICATION CENTER AT 1-800-432-4770.
- 12. THE CONTRACTOR IS REQUIRED TO HAVE ALL APPLICABLE CONSTRUCTION PERMITS PRIOR TO START OF CONSTRUCTION.
- 13. THE CONTRACTOR SHALL NOTIFY THE MIAMI-DADE COUNTY DEPARTMENT OF TRANSPORTATION AND PUBLIC WORKS, MIAMI-DADE COUNTY DRER, WATER CONTROL, STORMWATER PLANNING AND DESIGN SECTION AND THE ENGINEER OF RECORD AT LEAST 48 HOURS PRIOR TO CONSTRUCTION.
- 14. PRIOR TO CONSTRUCTION AND INSTALLATION OF THE PROPOSED IMPROVEMENTS, FIVE SETS OF SHOP DRAWINGS SHALL BE SUBMITTED TO, AND APPROVED BY DRER-STORMWATER PLANNING AND DESIGN SECTION. IN ADDITION, IT IS THE CONTRACTOR'S RESPONSIBILITY TO OBTAIN ANY OTHER AGENCY SHOP DRAWING APPROVAL. IF REQUIRED.
- 15. THE CONTRACTOR SHALL CONTACT THE ENGINEER IMMEDIATELY ON ANY CONFLICT ARISING DURING CONSTRUCTION OF ANY IMPROVEMENTS SHOWN IN THESE DRAWINGS.
- 16. THE CONTRACTOR SHALL BE RESPONSIBLE FOR DAMAGE, REMOVAL OR MODIFICATION, ACCIDENTALLY OR PURPOSELY, CAUSED TO ANY IRRIGATION SYSTEMS, PRIVATE OR PUBLIC. THE CONTRACTOR SHALL REPLACE ANY DAMAGED, REMOVED OR MODIFIED IRRIGATION PIPES, SPRINKLER HEADS OR OTHER PERTINENT APPURTENANCES AT NO ADDITIONAL COST.
- 17. COMPLETE "AS-BUILT" INFORMATION RELATIVE TO LOCATION, SIZE AND DEPTH OF NEW PIPES, STRUCTURES, ETC., SHALL BE ACCURATELY RECORDED BY THE CONTRACTOR AND SUBMITTED (SIGNED AND SEALED BY A FLORIDA CERTIFIED P.L.S.) TO THE ENGINEER, PRIOR TO FINAL ACCEPTANCE OF THE WORK. ALL RECORD INFORMATION ON EXISTING UTILITIES CROSSINGS ENCOUNTERED DURING CONSTRUCTION, INCLUDING BUT NOT LIMITED TO PIPES, INLETS, MANHOLES, ETC., SHALL BE TAKEN BY A FLORIDA REGISTERED SURVEYOR AND SHOWN ON THE RECORD DRAWINGS. COST OF SIGNED AND SEALED AS-BUILTS SHALL BE COVERED IN OVERALL BID.
- 18. GRADING SHALL CONSIST OF ALL EXCAVATION, FILLING, SHAPING AND SLOPING NECESSARY FOR THE CONSTRUCTION, PREPARATION AND COMPLETION OF ALL SUBGRADES, SHOULDERS, SLOPES, INTERSECTIONS, PAVEMENTS AND OTHER AREAS, ALL IN ACCORDANCE WITH THE ALIGNMENT AND GRADES SHOWN IN THESE DRAWINGS.
- 19. CONTRACTOR SHALL BE RESPONSIBLE FOR RESETTING ALL DISTURBED EXISTING MANHOLE COVERS, VALVE BOXES, BLOW-OFF RISERS, ETC. TO NEW ELEVATIONS, AS REQUIRED, WHETHER SPECIFICALLY SHOWN ON DRAWINGS OR NOT.
- 20. THE CONTRACTOR SHALL NOT ENCROACH INTO PRIVATE PROPERTY WITH PERSONNEL, MATERIAL OR EQUIPMENT, UNLESS SPECIFICALLY APPROVED BY THE ENGINEER.
- 21. ALL DEMOLITION DEBRIS AND EXCESS MATERIAL TO BE DISPOSED OF BY CONTRACTOR IN AREAS PROVIDED BY HIM, UNLESS OTHERWISE NOTED. NO SEPARATE PAYMENT WILL BE MADE FOR THIS ITEM.
- 22. THE PROJECT SITE IS LOCATED IN FLOOD ZONE VE 11 (+11 FEET N.G.V.D. 29). ALL ELECTRICAL AND MECHANICAL EQUIPMENT, SUCH AS MOTORS, SWITCHES, RECEPTACLES, ETC. ARE REQUIRED TO BE AT LEAST A FOOT ABOVE FEMA'S FLOOD ELEVATION (+11 NGVD).

## SPECIAL NOTES

EXISTING PUMP CAPACITY (32,000 GPM) SHALL BE MAINTAINED DURING CONSTRUCTION BY MEANS OF TEMPORARY STAND-BY PUMPS. TEMPORARY STAND-BY PUMPS, WITH AUTOMATIC AND MANUAL START/STOP, TO BE OPERATED AND MAINTAINED BY CONTRACTOR AT ALL TIMES (24 HOURS PER DAY-7 DAYS A WEEK).

05/15/2024 UPDATE PAY ITEMS
12/05/2023 UPDATE PAY ITEMS
09/26/2022 UPDATE PAY ITEMS
12/17/2021 ADDRESS M-D C COMMENTS

04/15/2021 ADDRESS SFWMD COMMENTS

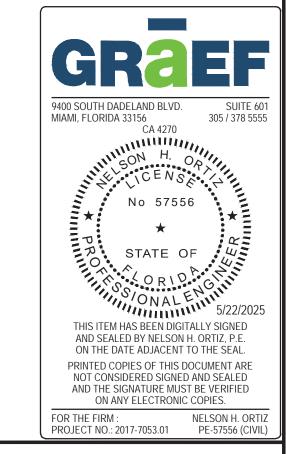


DESIGN BY:	J.R.G.	DATE:	04/10/2020
DRAWN BY:	P.F.	DATE:	
CHECKED BY:	N.H.O.	DATE:	

SITE LOCATION PLAN


QUANTITIES, PAY ITEMS, AND NOTES


BISCAYNE SHORES PUMP STATIONS No. 109 AND 110 RETROFIT

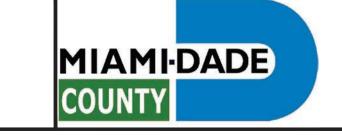


DEPARTMENT OF TRANSPORTATION
AND PUBLIC WORKS
STEPHEN P. CLARK CENTER
111 NW 1ST STREET, 16TH FLOOR
MIAMI. FLORIDA 33128

PROJECT NO. 17053.01	SHEET NO. 2	
DRAWING NO. C-2	OF 28	SHEETS

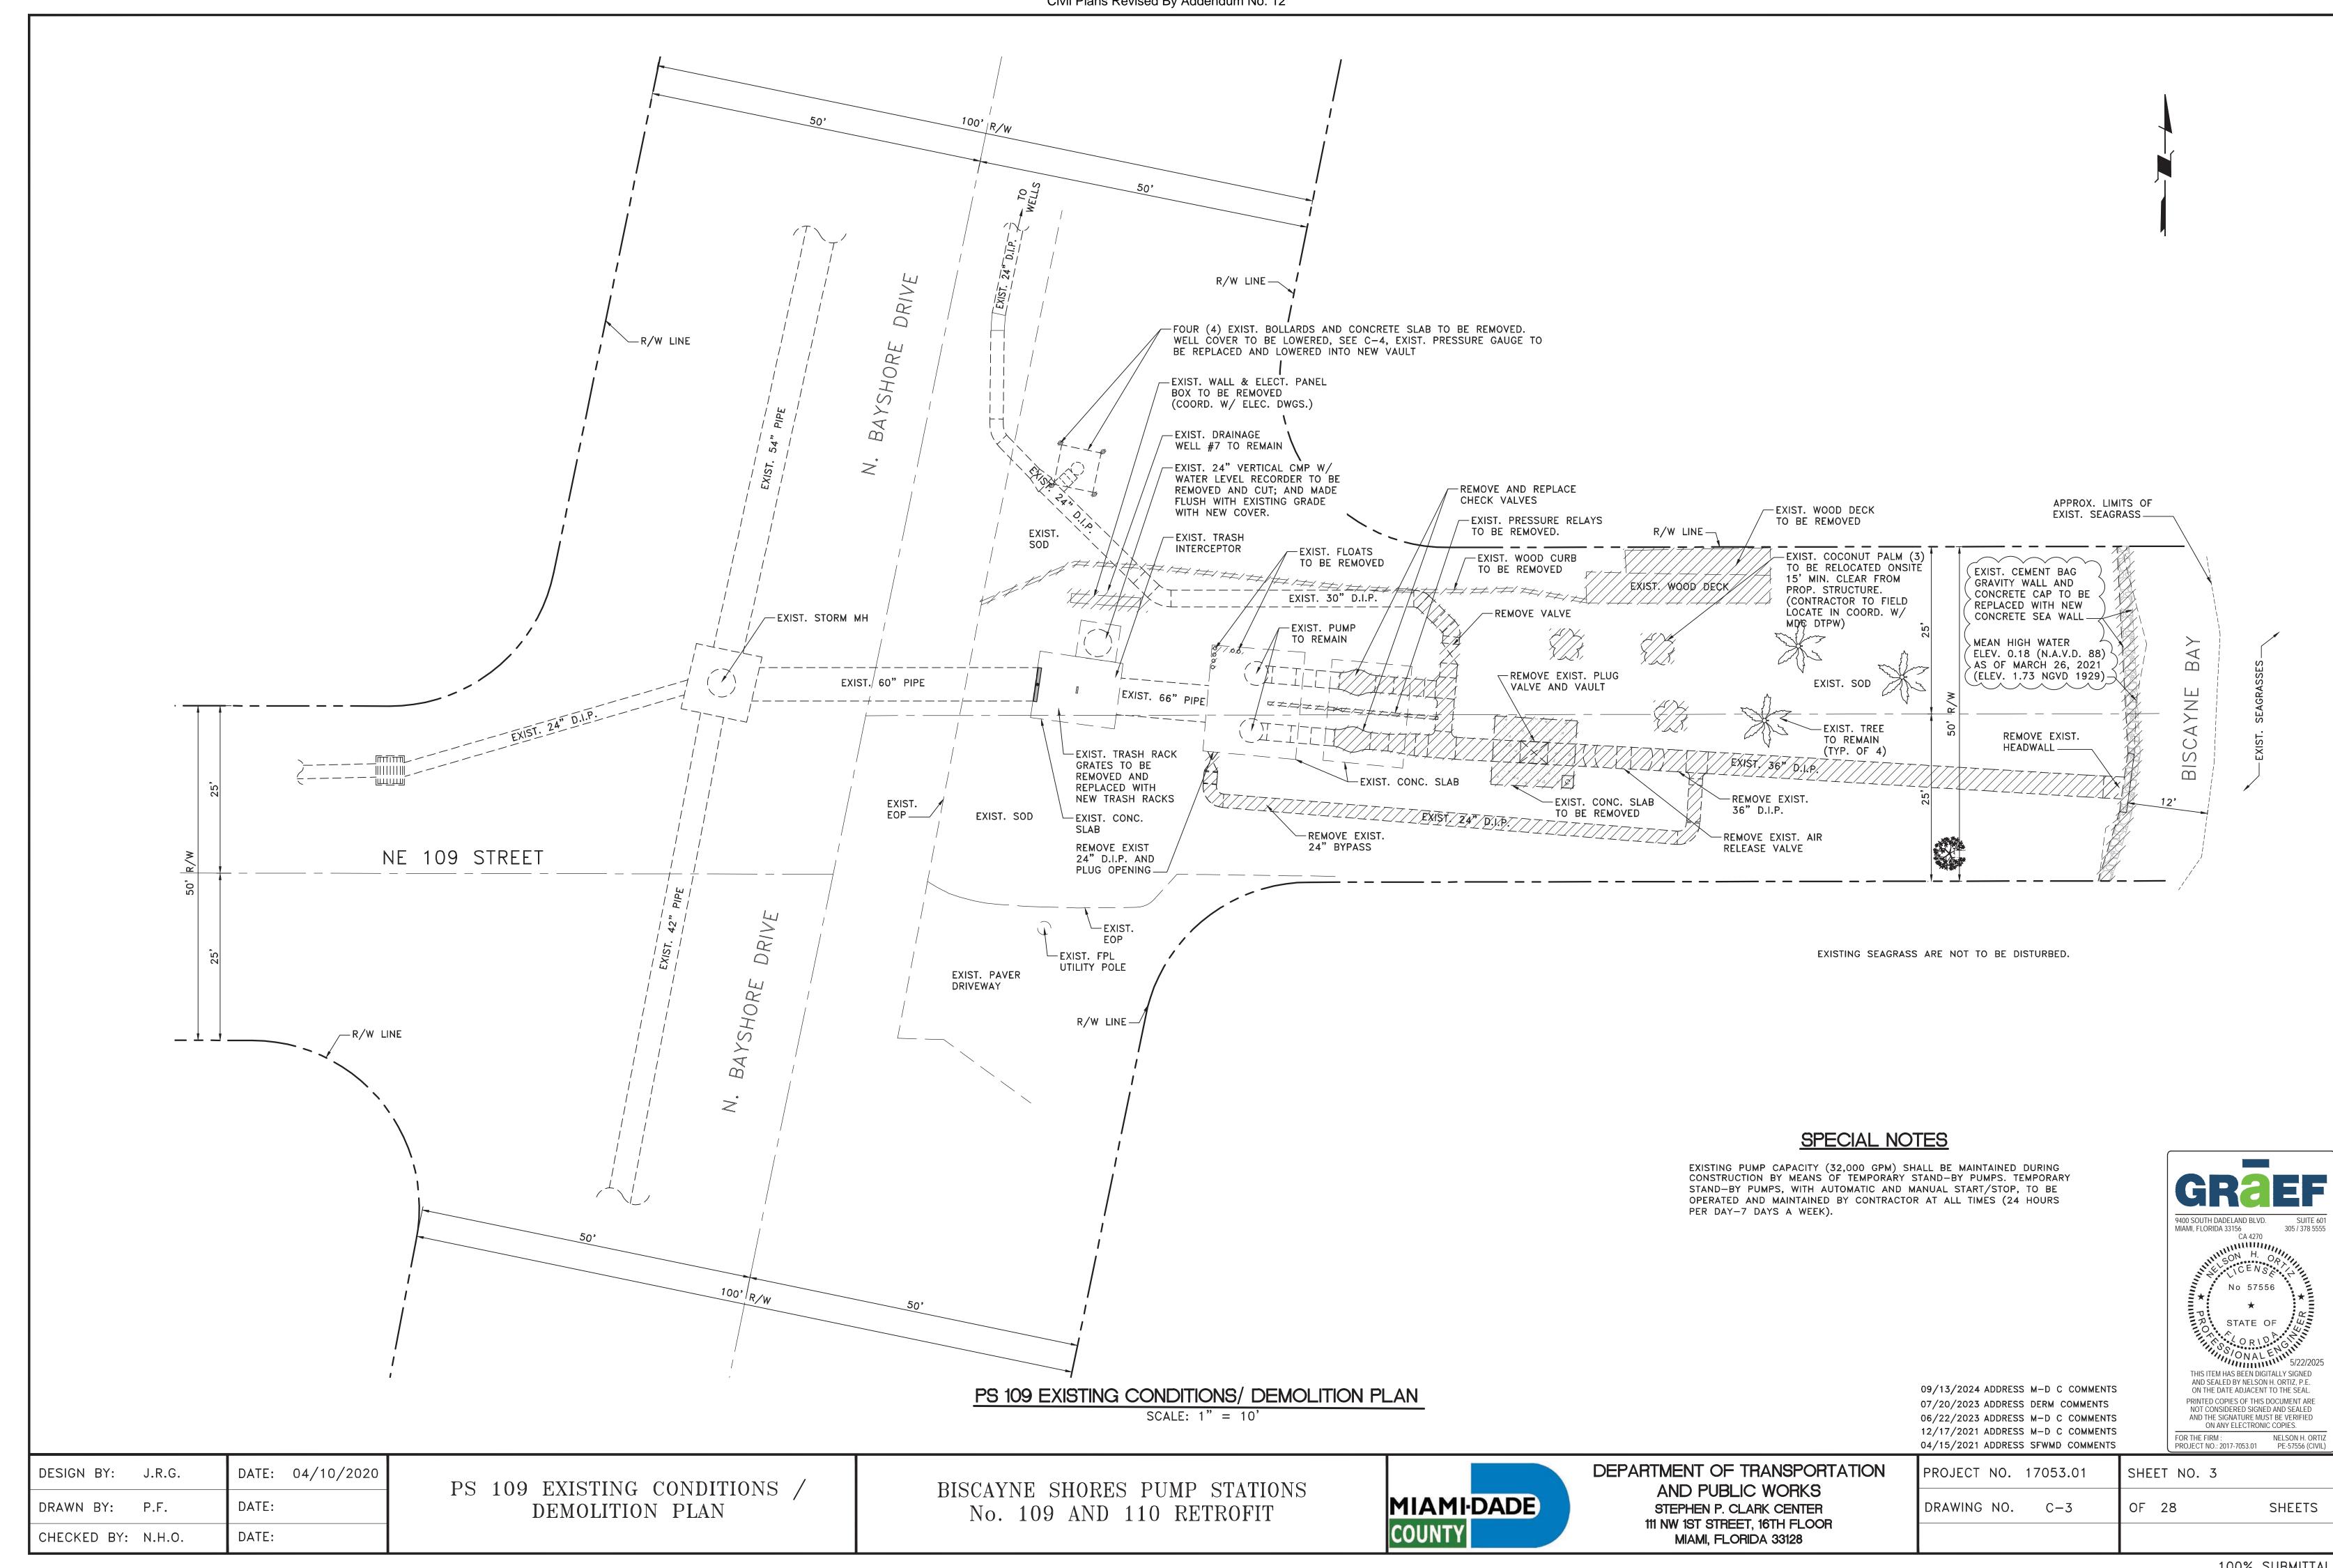

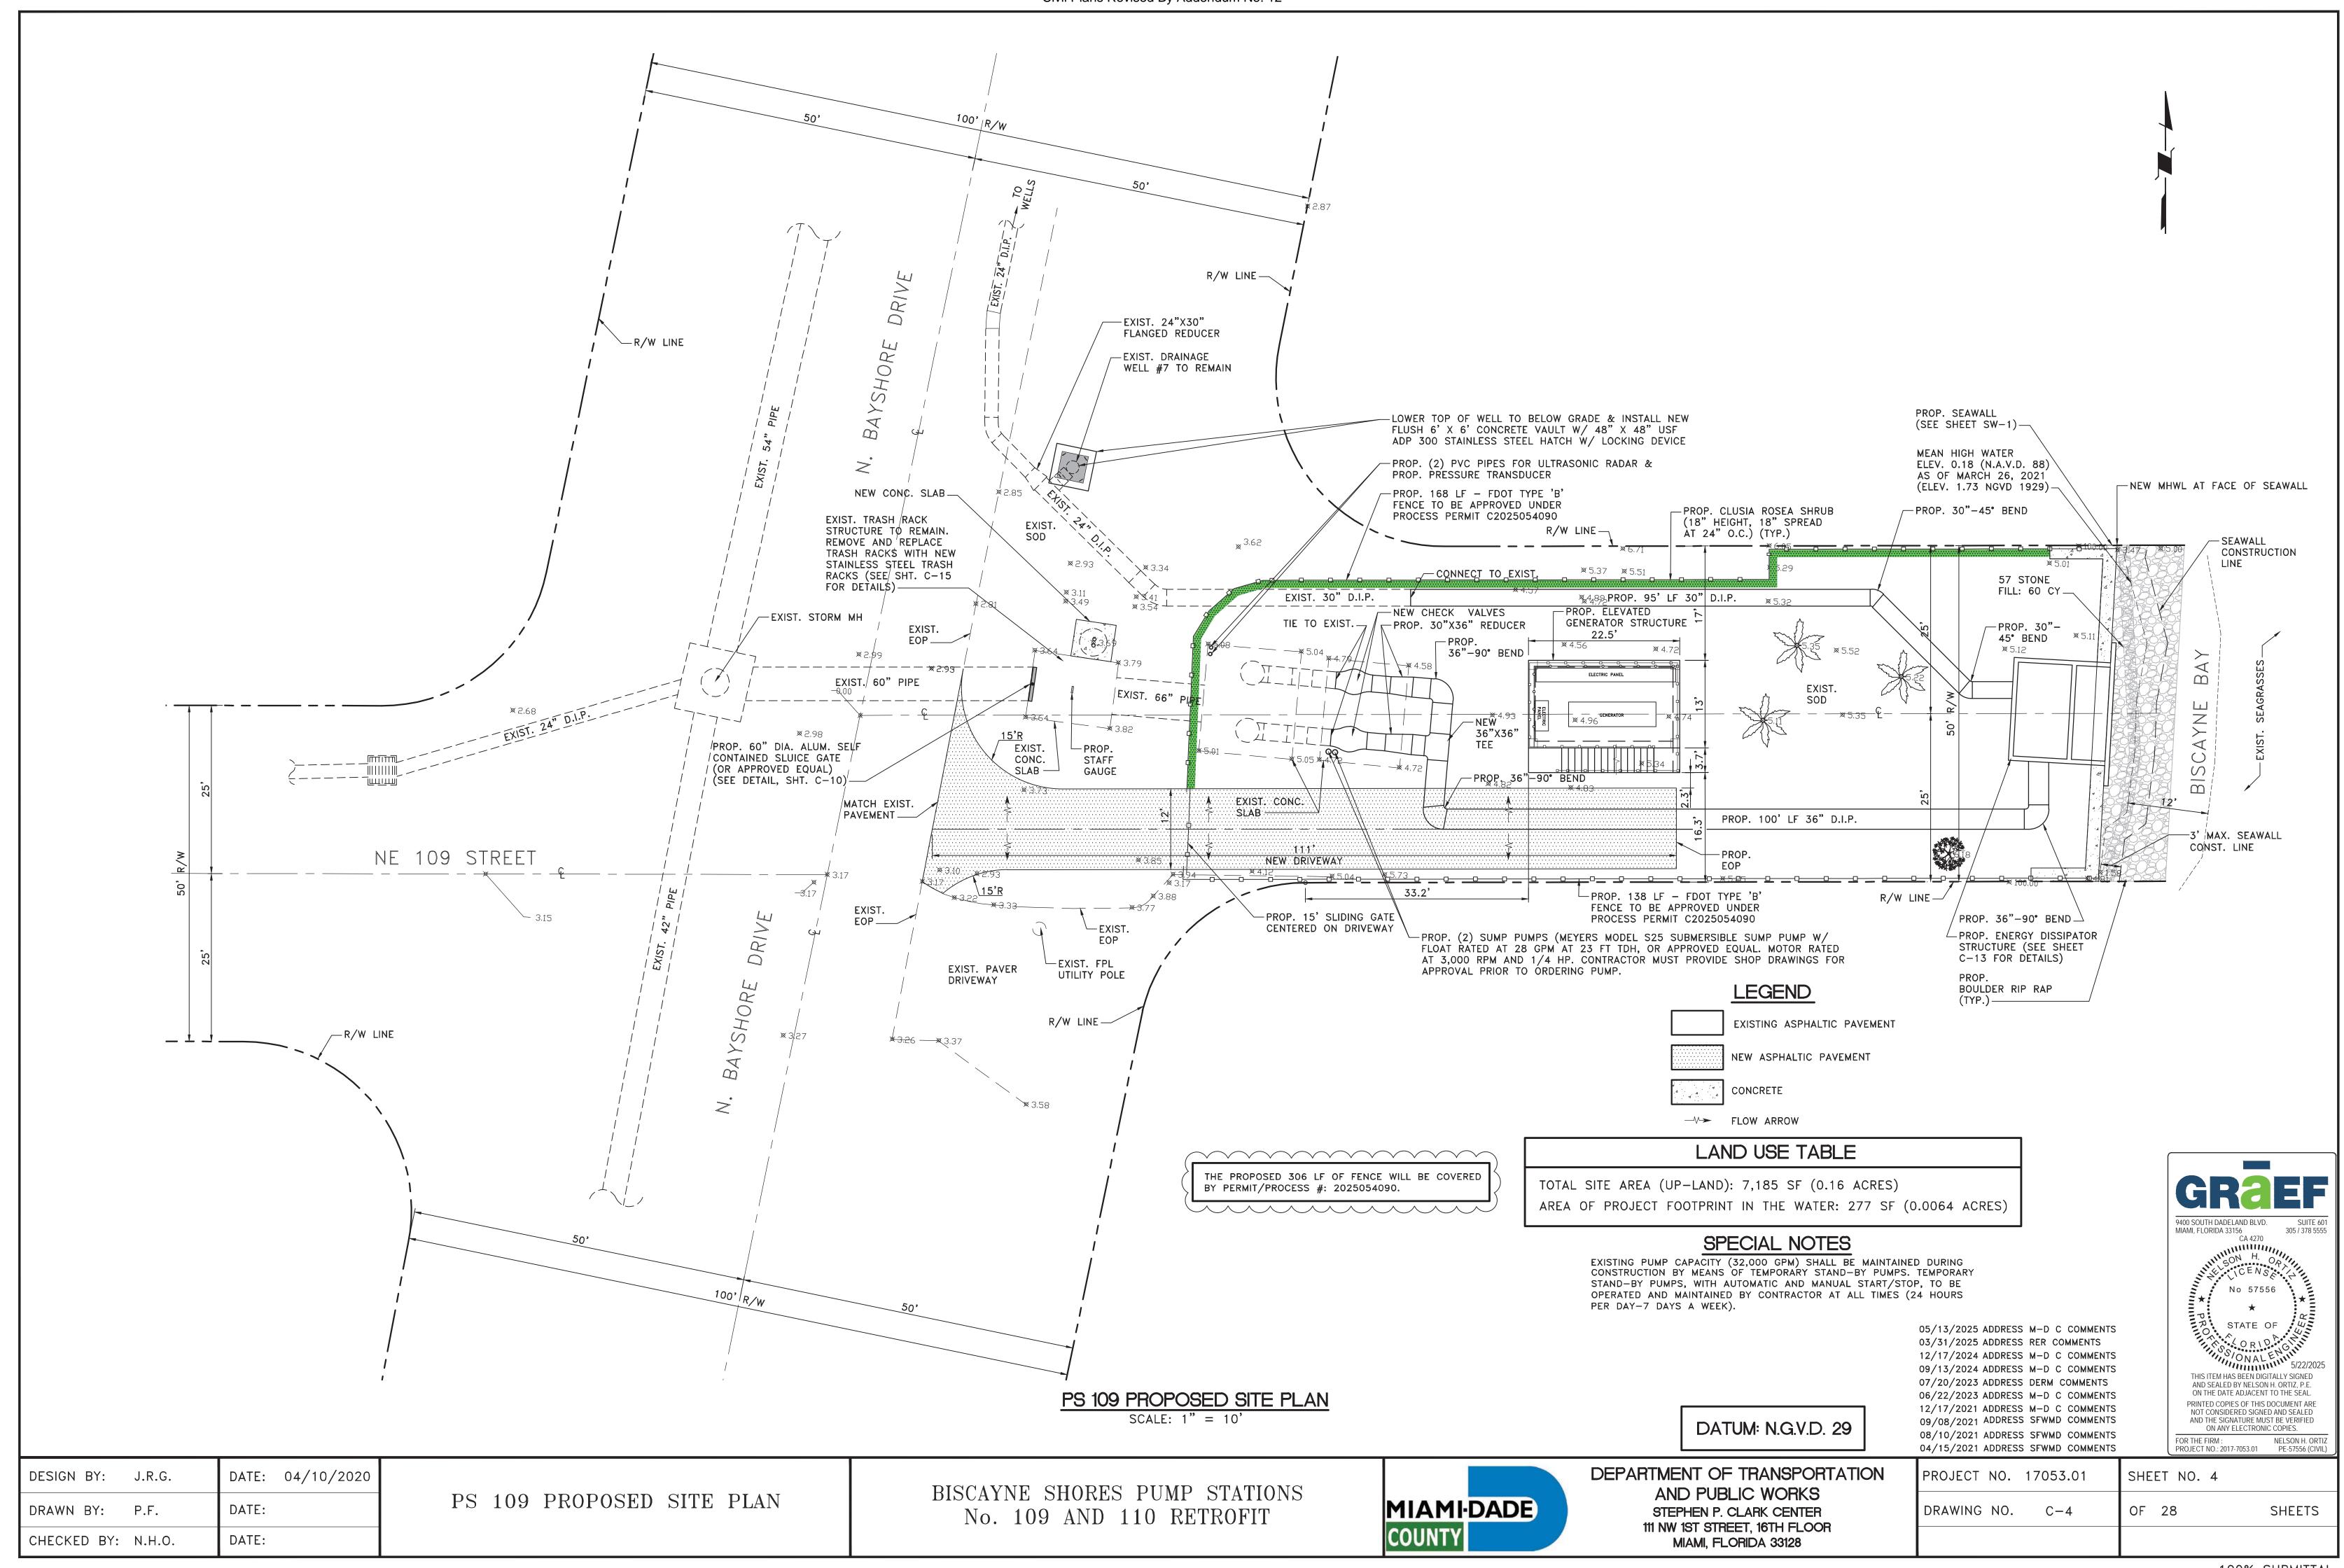

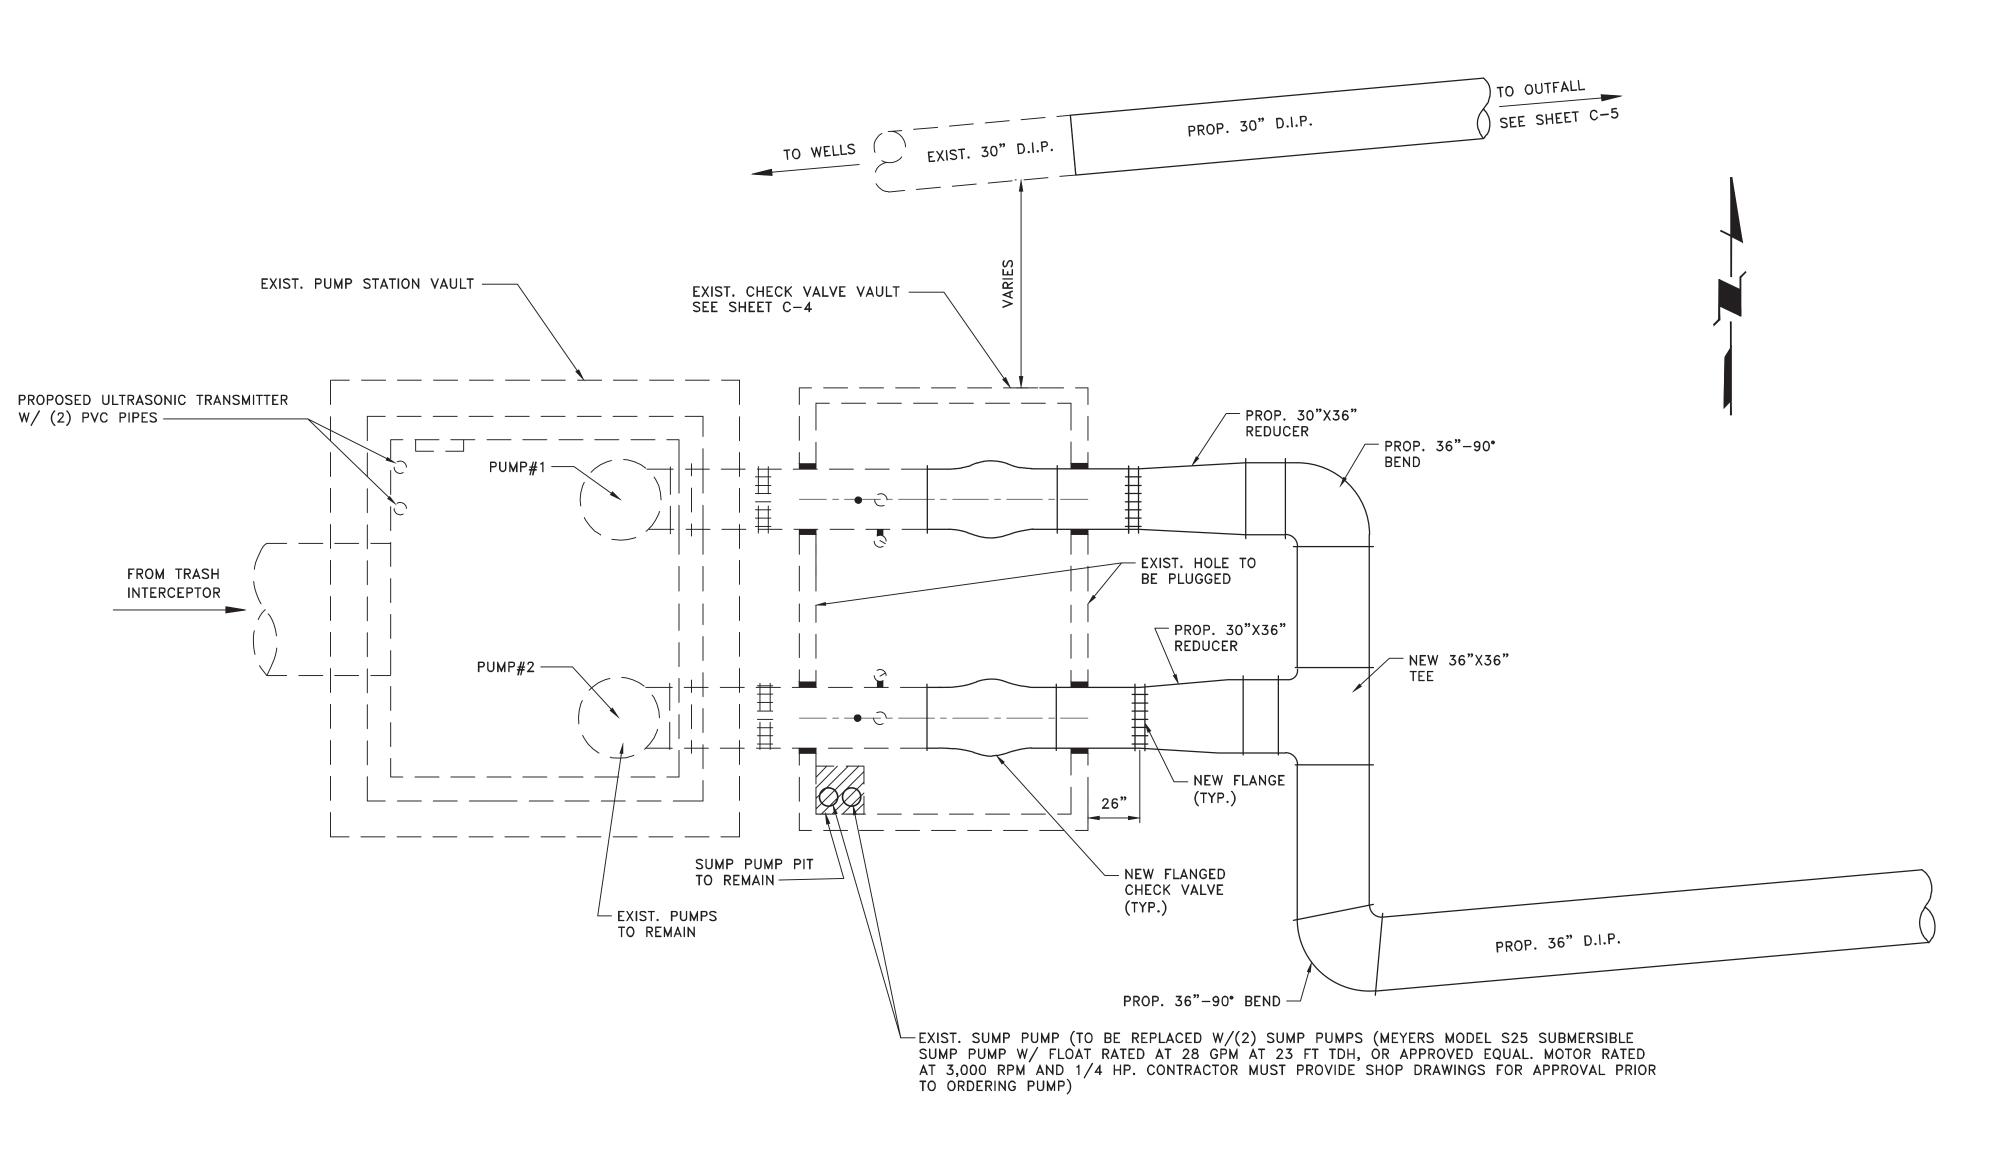

DATE: 04/10/2020

DATE:

DATE:


PS 109 PLAN AND ELEVATION

DESIGN BY: J.R.G.

DRAWN BY: P.F.

CHECKED BY: N.H.O.

# OVERALL PROPOSED PLAN

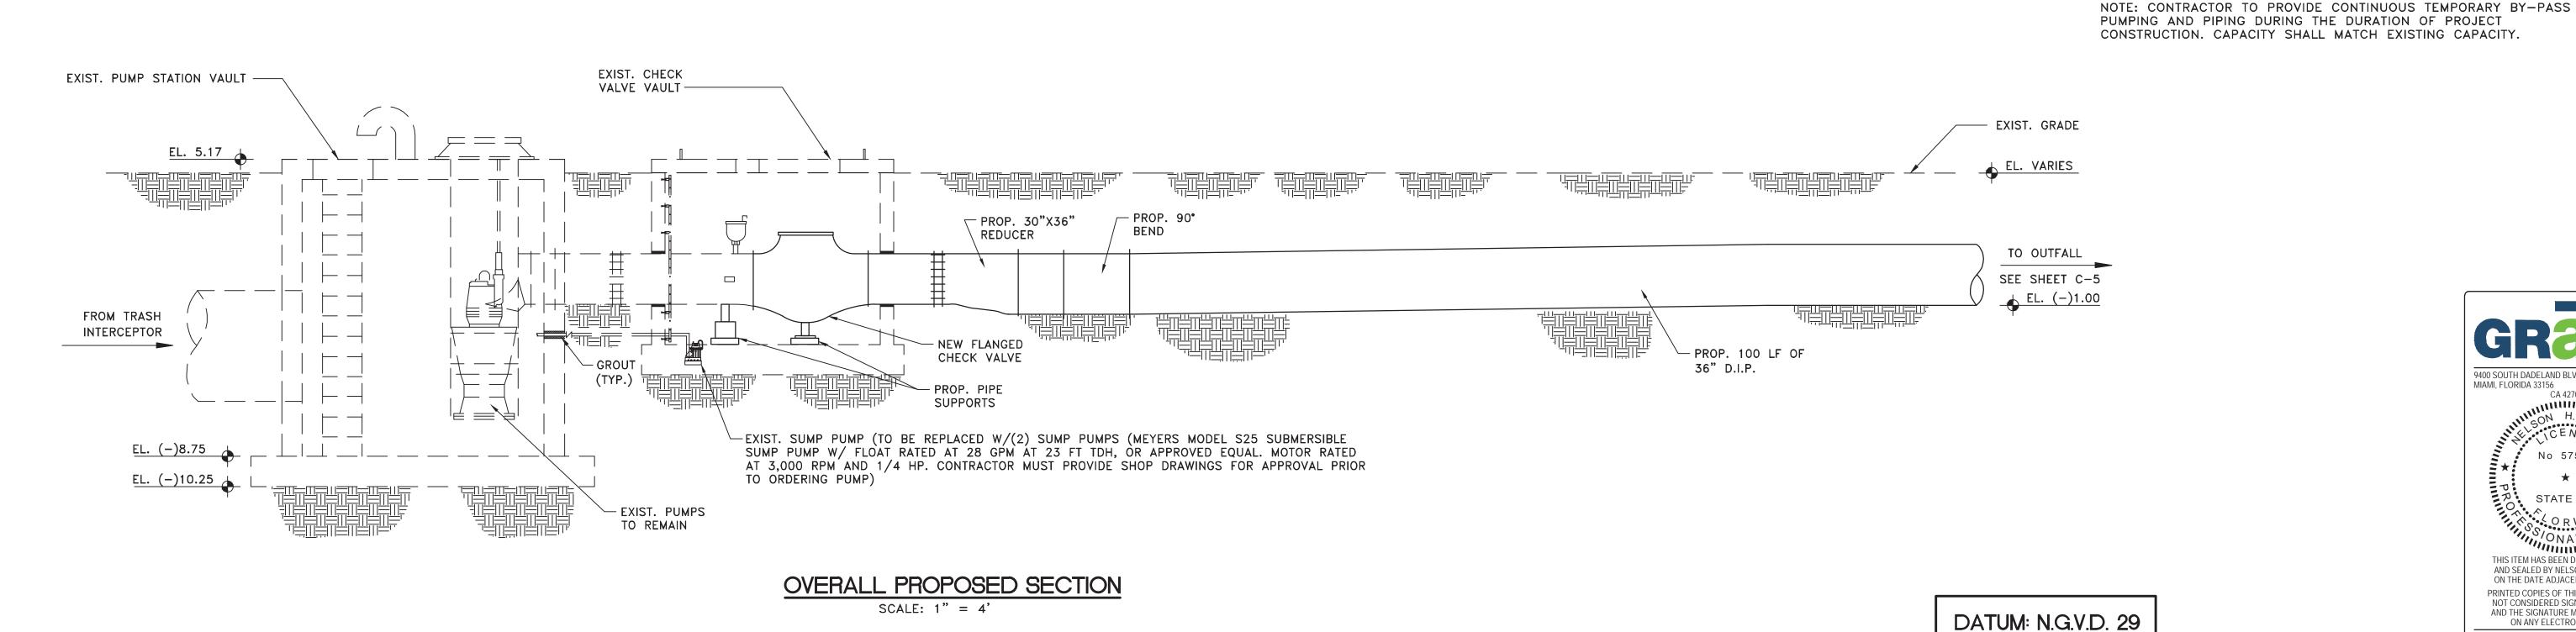

BISCAYNE SHORES PUMP STATIONS

No. 109 AND 110 RETROFIT

DEPARTMENT OF TRANSPORTATION AND PUBLIC WORKS MIAMI-DADE STEPHEN P. CLARK CENTER 111 NW 1ST STREET, 16TH FLOOR COUNTY MIAMI, FLORIDA 33128

DRAWING NO.

PROJECT NO. 17053.01 SHEET NO. 5 SHEETS OF 28 C-5

12/17/2021 ADDRESS M-D C COMMENTS

EXIST. PUMP STATION DATA TABLE

PUMP CAPACITY

NORMAL OPERATING RANGE

DISCHARGE PIPE DIAMETER

ALARM SIGNAL HIGH WATER

HIGH PRESSURE SHUT OFF SWITCH FEET OF HEAD HIGH PRESSURE ALARM LIGHT AND FEET OF HEAD

LAG PUMP LOW WATER SHUT OFF | ELEV. J LEAD PUMP LOW WATER SHUT OFF | ELEV. K

PUMP CYCLE TIME

PUMP EFFICIENCY

Q DISCHARGE PIPE

INFLUENT PIPE INVERT

PUMP MODEL

MOTOR SIZE FINISH GRADE

VALVE OPEN

SHUT OFF

LAG PUMP ON LEAD PUMP ON

WET WELL SLAB

ELECTRICAL SERVICE

CONTROL VALVE OPEN

LOW WATER ALARM/EMERGENCY

1. TURN OFF PUMPS #1 & #2.

WET WELL DIMENSIONS

12.0

FEET OF HEAD 6.0-18.0

SUBMERSIBLE PROPELLER

24" PROPELLER

MINUTES

**INCHES** H.P.

ELEV. A

ELEV. B

ELEV. C

ELEV. D

ELEV. F

ELEV. H

AMP. MIN.

ELEV. L

SEQUENCE OF CONSTRUCTION NOTES

6. ALL PIPES AND VALVES SHALL BE TESTED FOR LEAKS PRIOR TO BACKFILLING THE EXCAVATIONS, WHILE MIAMI-DADE COUNTY

DEPARTMENT OF TRANSPORTATION AND PUBLIC WORKS

2. REMOVE EXIST. PLUG VALVE VAULT IN ITS ENTIRETY.

3. REMOVE ALL PLUG VALVES AND PIPES, AS REQUIRED.

4. INSTALL ENERGY DISSIPATOR STRUCTURE.

5. INSTALL PIPES & APPURTENANCES.

PERSONNEL ARE PRESENT.

16.000

10 MIN.

12'X14' I.

80%

4.5

0.25

-5.25

3.5

-8.75

-2.5

-3.0


9400 SOUTH DADELAND BLVD. MIAMI, FLORIDA 33156

THIS ITEM HAS BEEN DIGITALLY SIGNED AND SEALED BY NELSON H. ORTIZ, P.E. ON THE DATE ADJACENT TO THE SEAL.


PRINTED COPIES OF THIS DOCUMENT ARE NOT CONSIDERED SIGNED AND SEALED

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ON ANY ELECTRONIC COPIES. FOR THE FIRM: NELSON H. ORTI PROJECT NO.: 2017-7053.01 PE-57556 (CIVIL

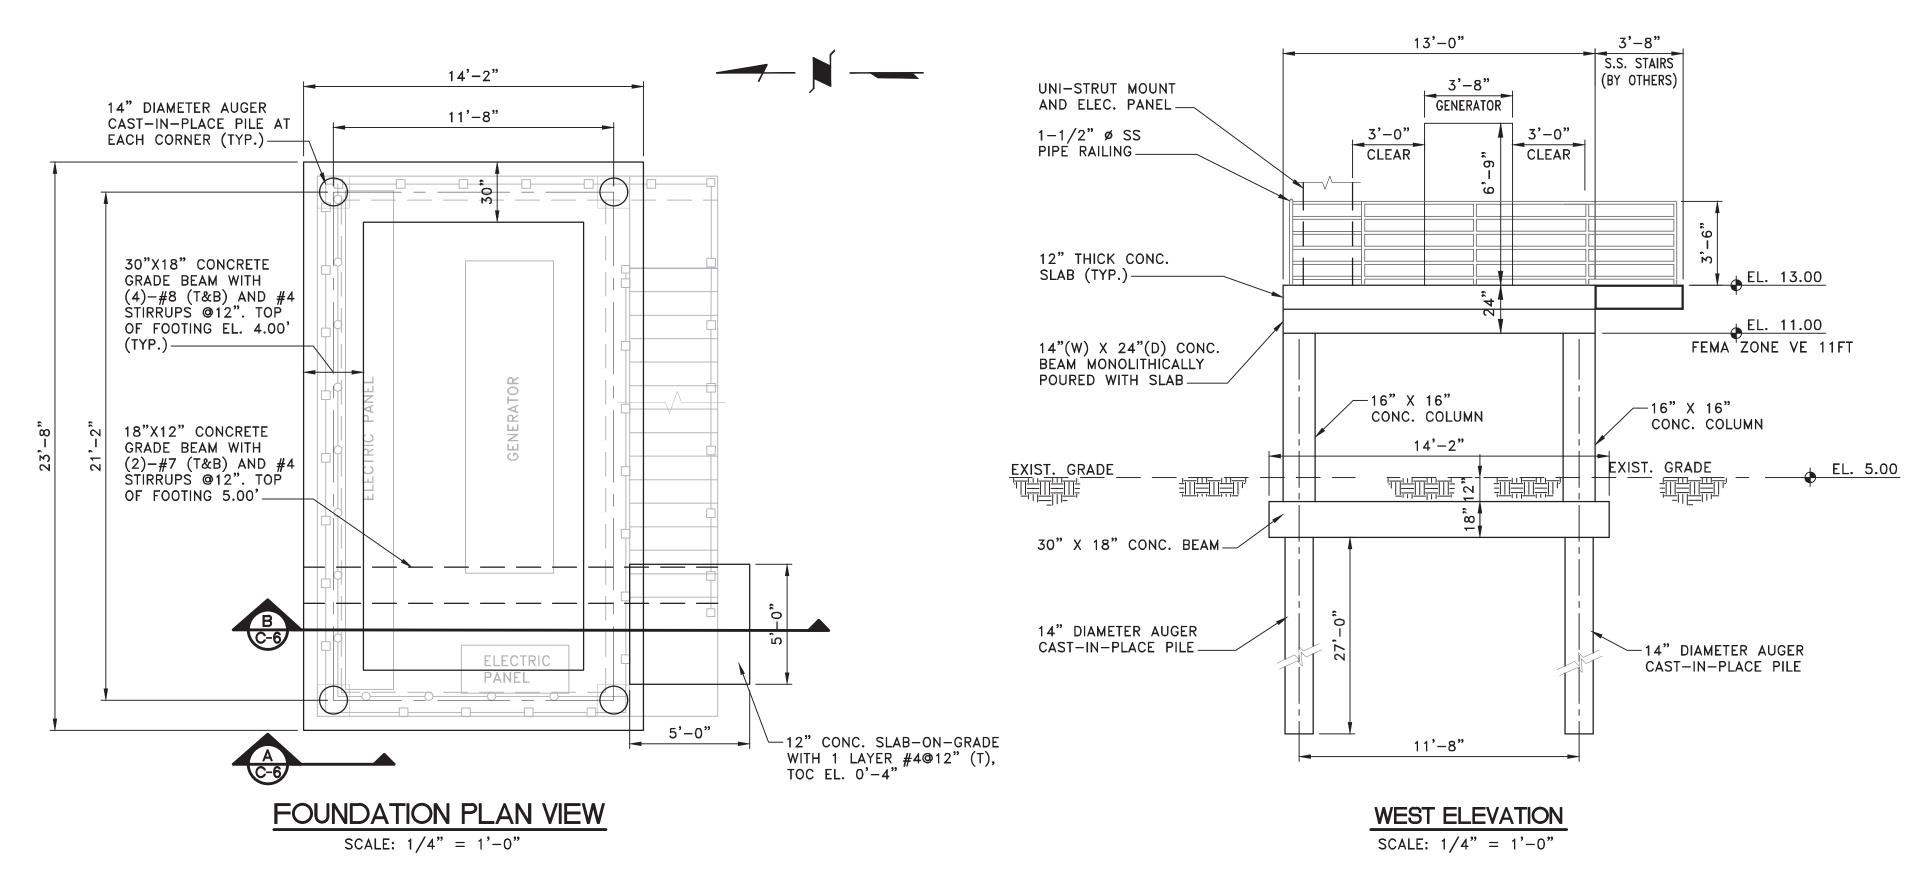

- 1. CONTRACTOR SHALL PROVIDE SHOP DRAWINGS FOR FABRICATION.
- 2. CONTRACTOR SHALL PROVIDE ACCESS LADDER SHOP DRAWINGS BEFORE BEGINNING FABRICATION TO E.O.R. FOR REVIEW & APPROVAL.
- 3. DIMENSIONS SHOWN ON THIS SHEET SHALL NOT SUPERCEDE DIMENSIONS SHOWN ON FABRICATION DRAWINGS.

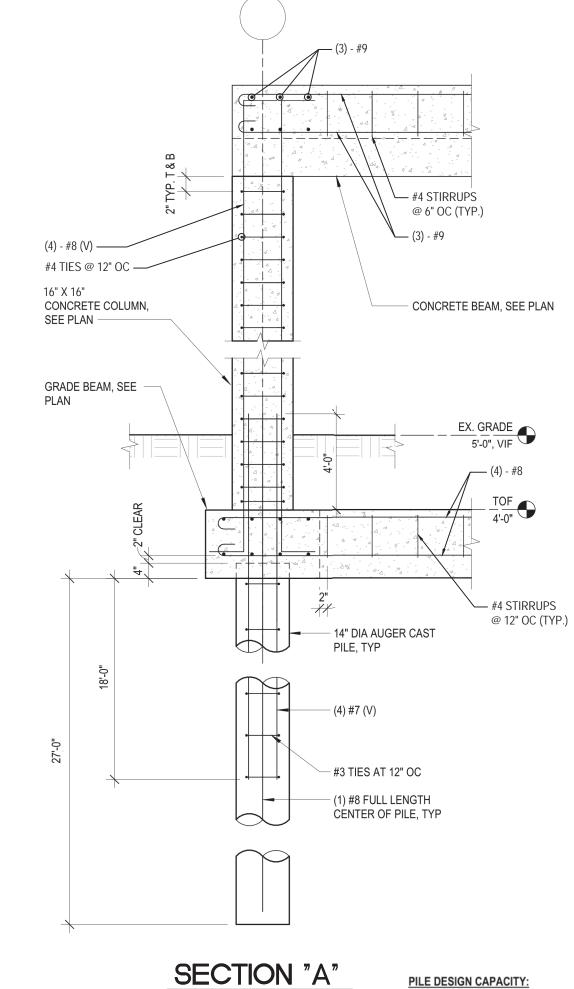

SECTION "A" SCALE: N.T.S.

ALLOWABLE AXIAL LOADS:

· 26 TONS DOWNWARD 6.5 TONS UPWARD 10 TONS LATERAL

## STRUCTURAL GENERAL NOTES


- 1. DESIGN IS IN ACCORDANCE WITH THE STATE OF FLORIDA BUILDING CODE, 2023 EDITION.
- 2. MINIMUM 28 DAY CONCRETE CYLINDER STRENGTH SHALL BE: AUGER CAST-IN-PLACE PILES: 5000 PSI
  - WATER/CEMENT RATIO SHALL NOT BE LARGER THAN 0.50.

OTHERS: 4000 PSI.

- 3. REINFORCING STEEL SHALL CONFORM TO ASTM A615 GRADE 60.
- 4. STAINLESS STEEL WIDE FLANGE BEAMS, CHANNELS, ANGLES SHALL CONFORM TO ASTM A276, ALLOY 316L.
- 5. STAINLESS STEEL PLATES SHALL CONFORM TO ASTM A240, ALLOY


STAINLESS STEEL BOLTS SHALL CONFORM TO ASTM F593D, ALLOY

- 7. STAINLESS STEEL NUTS AND WASHERS SHALL CONFORM TO ASTM F594 GROUP 2, ALLOY 316L.
- 8. ALL WELDING SHALL COMPLY WITH AWS D1.6 USING E316 ELECTRODES. ALL WELDERS TO BE CERTIFIED BY AWS.
- 9. ALL STAIR, HARDWARE, WIDE FLANGE BEAMS, CHANNELS, ANGLES, PLATES, RAILS, BRACKETS, BOLTS AND ANY FIXTURES OR SUPPORTS SHALL BE STAINLESS STEEL.
- 10. STATED AUGER CAST PILE COMPRESSIVE CAPACITY IS 26 TONS, TENSILE CAPACITY IS 6.5 TONES AND LATERAL CAPACITY IS 10, BASED ON SOIL REPORT PREPARED BY WINGERTER LABORATORIES INC., DATED NOVEMBER 15, 2019.
- 11. DESIGN LOADS: LIVE LOADS: PLATFORM: 40 PSF WIND LOAD (ASCE 7-22) BUILDING RISK CATEGORY III BASIC WIND SPEED V = 186 MPHEXPOSURE: D INTERNAL PRESSURE COEFFICIENT GCPI =0.0
- 12. RESISTANCE TO LATERAL LOADS ON STRUCTURE IS PROVIDED BY FLOOR DIAPHRAGMS AND CONCRETE MOMENT FRAMES. CONTRACTOR SHALL PROVIDE SUFFICIENT TEMPORARY BRACING UNTIL ALL LATERAL SUPPORT SYSTEMS ARE IN PLACE AND FUNCTIONAL
- 13. ALL STRUCTURAL FRAMING AND CONNECTIONS HAVE BEEN DESIGNED FOR THE FINAL COMPLETED CONDITION AND HAVE NOT BEEN INVESTIGATED FOR POTENTIAL LOADINGS ENCOUNTERED DURING ERECTION AND CONSTRUCTION. ANY INVESTIGATION OF THE STRUCTURAL FRAMING AND CONNECTIONS FOR ADEQUACY DURING THE ERECTION AND CONSTRUCTION PROCESS IS THE RESPONSIBILITY OF THE CONTRACTOR.
- 14. CONTRACTOR IS RESPONSIBLE FOR MEANS AND METHODS OF CONSTRUCTION AND JOB SITE SAFETY.
- 15. CONTRACTOR SHALL PROVIDE SHOP DRAWINGS FOR THE FOLLOWING ITEMS PRIOR TO FABRICATION: REBAR, CONCRETE MIX DESIGN, STRUCTURAL STEEL, STEEL STAIRS AND STEEL RAILING.

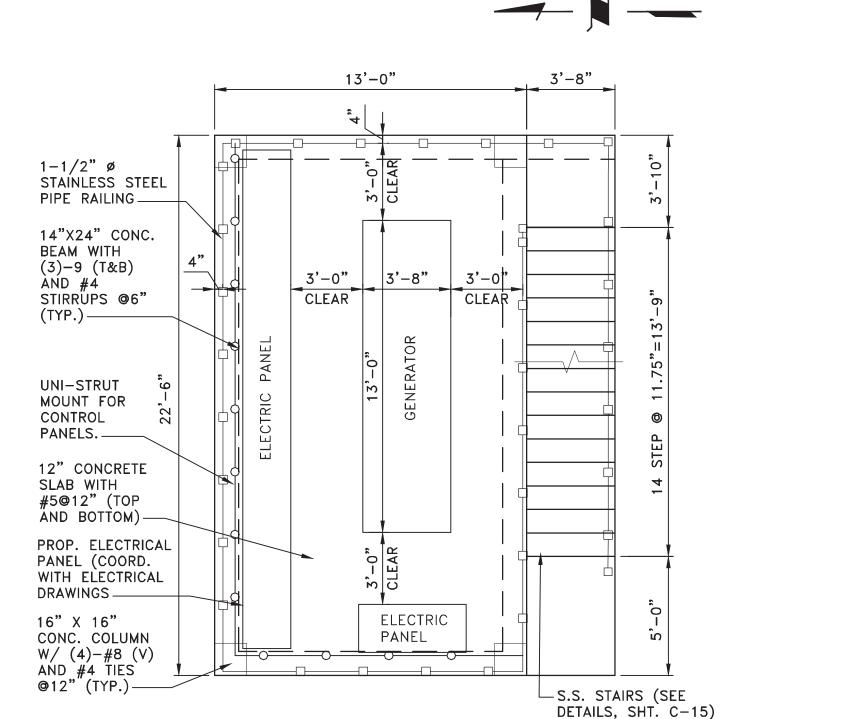

PLATFORM PLAN VIEW

SCALE: 1/4" = 1'-0"

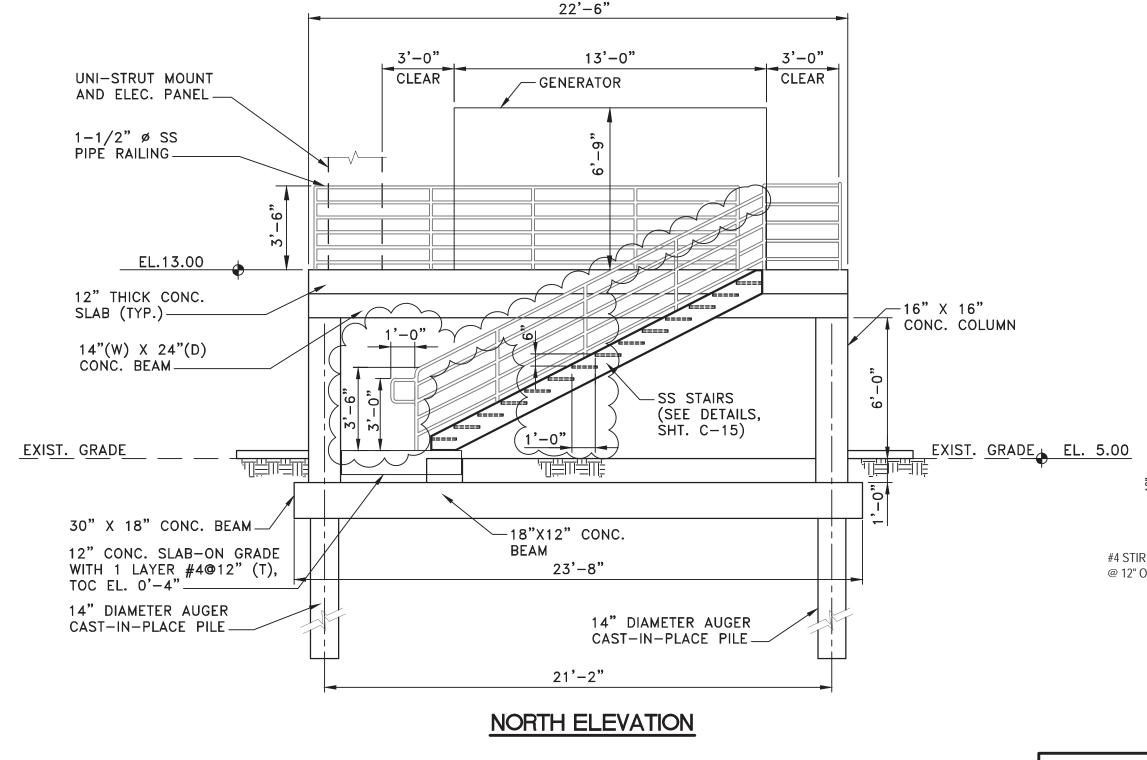

CL GRADE BEAM/PILE CL GRADE BEAM/PILE #4 STIRRUPS TOP BAR -@ 12" OC (TYP.) — 1 1 BOTTOM BAR -#4 STIRRUPS @ 12" OC (TYP.) — GRADE BEAM, SEE PLAN 2'-6" NOTE: SLAB ON GRADE NOT SHOWN FOR CLARITY.

PROPOSED ELEVATED GENERATOR STRUCTURE SCALE: 1/4" = 1'-0"

DATUM: N.G.V.D. 29

SECTION "B" SCALE: 1/2" = 1'-0"

12/17/2024 ADDRESS M-D C COMMENTS 09/13/2024 ADDRESS M-D C COMMENTS 12/17/2021 ADDRESS M-D C COMMENTS

9400 SOUTH DADELAND BLVD. MIAMI, FLORIDA 33156 THIS ITEM HAS BEEN DIGITALLY SIGNED AND SEALED BY NELSON H. ORTIZ, P.E. ON THE DATE ADJACENT TO THE SEAL PRINTED COPIES OF THIS DOCUMENT AR NOT CONSIDERED SIGNED AND SEALED AND THE SIGNATURE MUST BE VERIFIED FOR THE FIRM: NELSON H. ORTIZ PROJECT NO.: 2017-7053.01 PE-57556 (CIVIL

DESIGN BY:	J.R.G.	DATE:	04/10/2020
DRAWN BY:	P.F.	DATE:	
CHECKED BY:	N.H.O.	DATE:	

PS 109 ELEVATED GENERATOR STRUCTURE BISCAYNE SHORES PUMP STATIONS No. 109 AND 110 RETROFIT

MIAMI-DADE COUNTY

DEPARTMENT OF TRANSPORTATION AND PUBLIC WORKS STEPHEN P. CLARK CENTER 111 NW 1ST STREET, 16TH FLOOR MIAMI, FLORIDA 33128

PROJECT NO. 17053.01	SHEET NO. 6
DRAWING NO. C-6	OF 28

SHEETS

## STRUCTURAL NOTES

- 1. ALL DEBRIS ASSOCIATED WITH CLEARING SHALL BE REMOVED FROM THE SITE AND DISPOSED OF BY (THE CONTRACTOR.)
- 2. CONCRETE PILES SHALL BE DRIVEN TO THE FOLLOWING CRITERIA:

  KING PILES SHALL BE DRIVEN TO A MINIMUM BEARING CAPACITY OF 25 TONS AND TO A TIP ELEVATION OF ELEV.
  - BATTER PILES SHALL BE DRIVEN TO A MINIMUM BEARING CAPACITY OF 25 TONS AND A MINIMUM DEPTH OF EMBEDMENT OF FEET INTO FIRM MATERIAL.
- 3. CONCRETE PILES SHALL BE 12" SQUARE PRECAST PRESTRESSED PILES, AS DETAILED IN THESE DRAWINGS.
- 4. SHOP DRAWINGS FOR ALL REBAR SHALL SHOW THE ACTUAL MILL MARK ON THE REBARS MEETING ASTM A615.
- 5. SPLICES IN REINFORCING STEEL BARS SHALL BE A MINIMUM OF 36 BAR DIAMETERS EXCEPT WHERE DIMENSIONED OTHERWISE.
- 6. MINIMUM CONCRETE COVER FOR REINFORCING SHALL BE AS DETAILED IN THESE DRAWINGS. WHERE THIS COVER IS NOT DIMENSIONED, USE THE SAME AS DIMENSIONED FOR SIMILAR ITEMS. WHERE THERE ARE NO SIMILAR ITEMS THAT INDICATE THE AMOUNT OF COVER, 3 INCHES OF COVER SHALL BE PROVIDED.
- 7. THE CONTRACTOR SHALL PREPARE AND SUBMIT SHOP DRAWINGS FOR ALL PRECAST UNITS AND SHALL NOT PROCEED WITH THE MANUFACTURE OF THESE ITEMS PRIOR TO RECEIVING APPROVAL OF THE ENGINEER.
- 8. IT SHALL BE THE CONTRACTOR'S RESPONSIBILITY TO FIELD VERIFY ALL DIMENSIONS PRIOR TO CASTING ANY NON-TYPICAL CONCRETE PANELS. RE-CASTING OF ANY NON-TYPICAL CONCRETE PANEL DUE TO A DISCREPANCY IN DIMENSIONS SHALL AT THE CONTRACTOR'S EXPENSE.
- 9. ALL EXPOSED CONCRETE EDGES SHALL BE CHAMFERED 3/4", OR AS SHOWN.
- 10. ALL EXPOSED CONCRETE SURFACES SHALL HAVE A LIGHT BROOM FINISH.
- 11. EXPANSION JOINTS SHALL BE PREFORMED BITUMINOUS MATERIAL CONFORMING TO ASTM D1751 AND LOCATED AS SHOWN IN THESE DRAWINGS.
- 12. NO CONSTRUCTION JOINTS, OTHER THAN SHOWN, SHALL BE MADE WITHOUT PRIOR APPROVAL OF THE
- 13. ALL BACKFILL WHICH MAY BE REQUIRED FOR THE PROJECT WILL BE ACQUIRED FROM OFF-SITE SOURCES. CONTRACTOR SHALL BEAR ALL COSTS OF TRANSPORT OF THIS MATERIAL TO AND WITHIN THE PROJECT
- 14. TESTING OF CONCRETE: TESTING LABORATORY WILL BE RETAINED BY THE OWNER TO VERIFY SPECIFIED CONCRETE STRENGTHS. FAILURE OF ANY CONCRETE CYLINDER TO MEET SPECIFIED REQUIREMENTS SHALL BE DEEMED NON-COMPLYING. ALL COSTS OF ADDITIONAL TESTING TO DETERMINE ADEQUACY AND/OR REPLACEMENT OF DEFECTIVE WORK SHALL BE BORNE BY CONTRACTOR.
- 15. SILT BARRIERS: FLOATING SILT BARRIERS SHALL BE INSTALLED AROUND ALL GRADING OPERATIONS AND AROUND PILE OPERATIONS (PREDRILLING PILE HOLES AND PILE DRIVING), WHERE NECESSARY, SUCH THAT ALL REQUIRED TURBIDITY LIMITS AS DESIGNATED BY ENVIRONMENTAL REGULATORY AGENCIES ARE MAINTAINED.

## **GENERAL NOTES**

- 1. ELEVATIONS SHOWN REFER TO THE NORTH GEODETIC VERTICAL DATUM. (N.G.V.D.).
- HORIZONTAL AND VERTICAL CONTROL SHALL BE PROVIDED BY THE OWNER'S SURVEYOR. ALL CONSTRUCTION LAYOUT SHALL BE THE RESPONSIBILITY OF THE CONTRACTOR.
- 3. IT IS THE INTENT OF THESE PLANS TO BE IN ACCORDANCE WITH APPLICABLE CODES AND AUTHORITIES HAVING JURISDICTION. ANY DISCREPANCIES BETWEEN THESE PLANS AND APPLICABLE CODES SHALL BE IMMEDIATELY BROUGHT TO THE ATTENTION OF THE ENGINEER.
- 4. IT IS THE INTENT OF THESE PLANS AND THE RESPONSIBILITY OF THE CONTRACTOR TO COMPLY WITH LOCAL, STATE, AND FEDERAL ENVIRONMENTAL PERMITS ISSUED FOR THIS PROJECT. IT SHALL BE THE CONTRACTORS RESPONSIBILITY TO FAMILIARIZE HIMSELF WITH AND GOVERN HIMSELF BY ALL PROVISIONS OF THESE PERMITS.
- 5. IT SHALL BE THE CONTRACTOR'S RESPONSIBILITY TO VERIFY ALL UNDERGROUND FACILITIES PRIOR TO THE START OF CONSTRUCTION AND COORDINATE WITH THE VARIOUS UTILITY COMPANIES TO RELOCATE, BYPASS, OR OTHERWISE ENSURE THAT UTILITY SERVICES WILL NOT BE INTERRUPTED DURING CONSTRUCTION.
- 6. EXISTING GRADES AND SOUNDINGS WERE TAKEN FROM THE BEST AVAILABLE DATA AND MAY NOT ACCURATELY REFLECT PRESENT CONDITIONS. CONTRACTOR SHALL BE RESPONSIBLE FOR FAMILIARIZING HIMSELF WITH CURRENT SITE CONDITIONS, AND SHALL REPORT ANY DISCREPANCIES TO THE ENGINEER PRIOR TO STARTING WORK.
- 7. EXISTING CONDITIONS WERE TAKEN FROM THE SURVEY PREPARED BY MIAMI-DADE COUNTY DEPARTMENT OF TRANSPORTATION AND PUBLIC WORKS ROADWAY ENGINNERING AND RIGHT OF WAY DIVISION, MIAMI, FLORIDA, DATED JUNE 14, 2016.

## MATERIAL AND DESIGN DATA


#### A. MATERIALS:

- 1. CONCRETE: (Fc' = MIN. COMPRESSIVE STRENGTH AT 28 DAYS)

  A. CAST-IN-PLACE CONCRETE.......Fc' = 4,000 PSI

  B. PRECAST CONCRETE.......Fc' = 4,000 PSI

  C. PRECAST PRESTRESSED CONCRETE PILES.....Fc' = 5,500 PSI
- CONCRETE PILES SHALL BE 12" SQUARE PRECAST PRESTRESSED PILES WITH FOUR 1/2"ø 270K LO-LAX STRANDS WITH #5 GAGE WIRE SPIRAL TIFS.
- 3. REBAR, ANY SIZES, SHALL BE GALVANIZED STEEL AND SHALL CONFORM TO ASTM A615, GRADE 60.
- 4. ACCESSORIES SHALL BE ASTM A-36.
- 5. GEOTEXTILE FABRIC SHALL BE NON-WOVEN POLYPROPYLENE, MIRAFI 140N OR APPROVED EQUAL AT EACH PILE LOCATION (24" MIN. WIDTH).
- B. STRUCTURAL DESIGN IN ACCORDANCE WITH THE FOLLOWING CODES AND SPECIFICATIONS:
  - 1. THE FLORIDA BUILDING CODE (CURRENT EDITION).
- 2. ACI STANDARD BUILDING CODE REQUIREMENTS FOR REINFORCED CONCRETE (ACI 318).

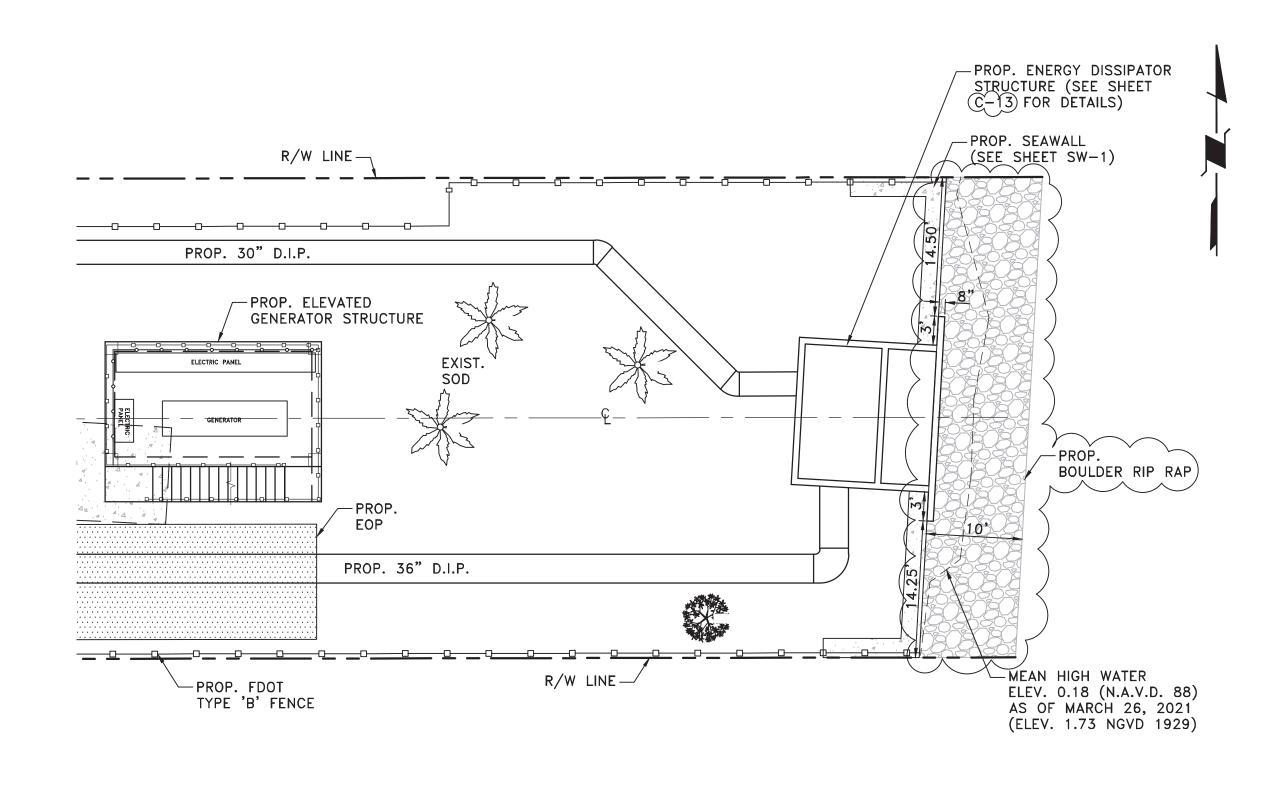

MEAN HIGH WATER ELEV. 0.18 (N.A.V.D. 88) AS OF MARCH 26, 2021 BISCAYNE BAY (ELEV. 1.73 NGVD 1929) 50'-0" --- PROPERTY LINE PROPERTY LINE <u>1'-3.8'</u> 12" SQ. VERTICAL – EXIST. CONC. SEWALL PILE (TYP. OF 11) (TO BE REMOVED) NON-TYPICAL PRECAST 12" SQ. BATTER CONC. PANEL (TYP.) -PILE (TYP. OF 7) 1'-3"+ NON-TYPICAL PRECAST - SEAL VOID WITH FILTER CONC. PANEL (TYP.) FABRIC AND EPOXY GROUT (TYP.)

PILE LAYOUT PLAN

SCALE: 1/4" = 1'-0"

09/13/2024 ADDRESS M-D C COMMENTS

PROJECT NO. 17053.01 SHEET NO. 7

DRAWING NO. C-7 OF 28

N.E. 109 STREET PUMP STATION SEAWALL

DESIGN BY: J.R.G. DATE: 04/10/2020

DRAWN BY: P.F. DATE:

CHECKED BY: N.H.O. DATE:

PS 109 SEAWALL PLAN AND DETAILS

BISCAYNE SHORES PUMP STATIONS No. 109 AND 110 RETROFIT

DEPARTMENT OF TRANSPORTATION

SHEETS


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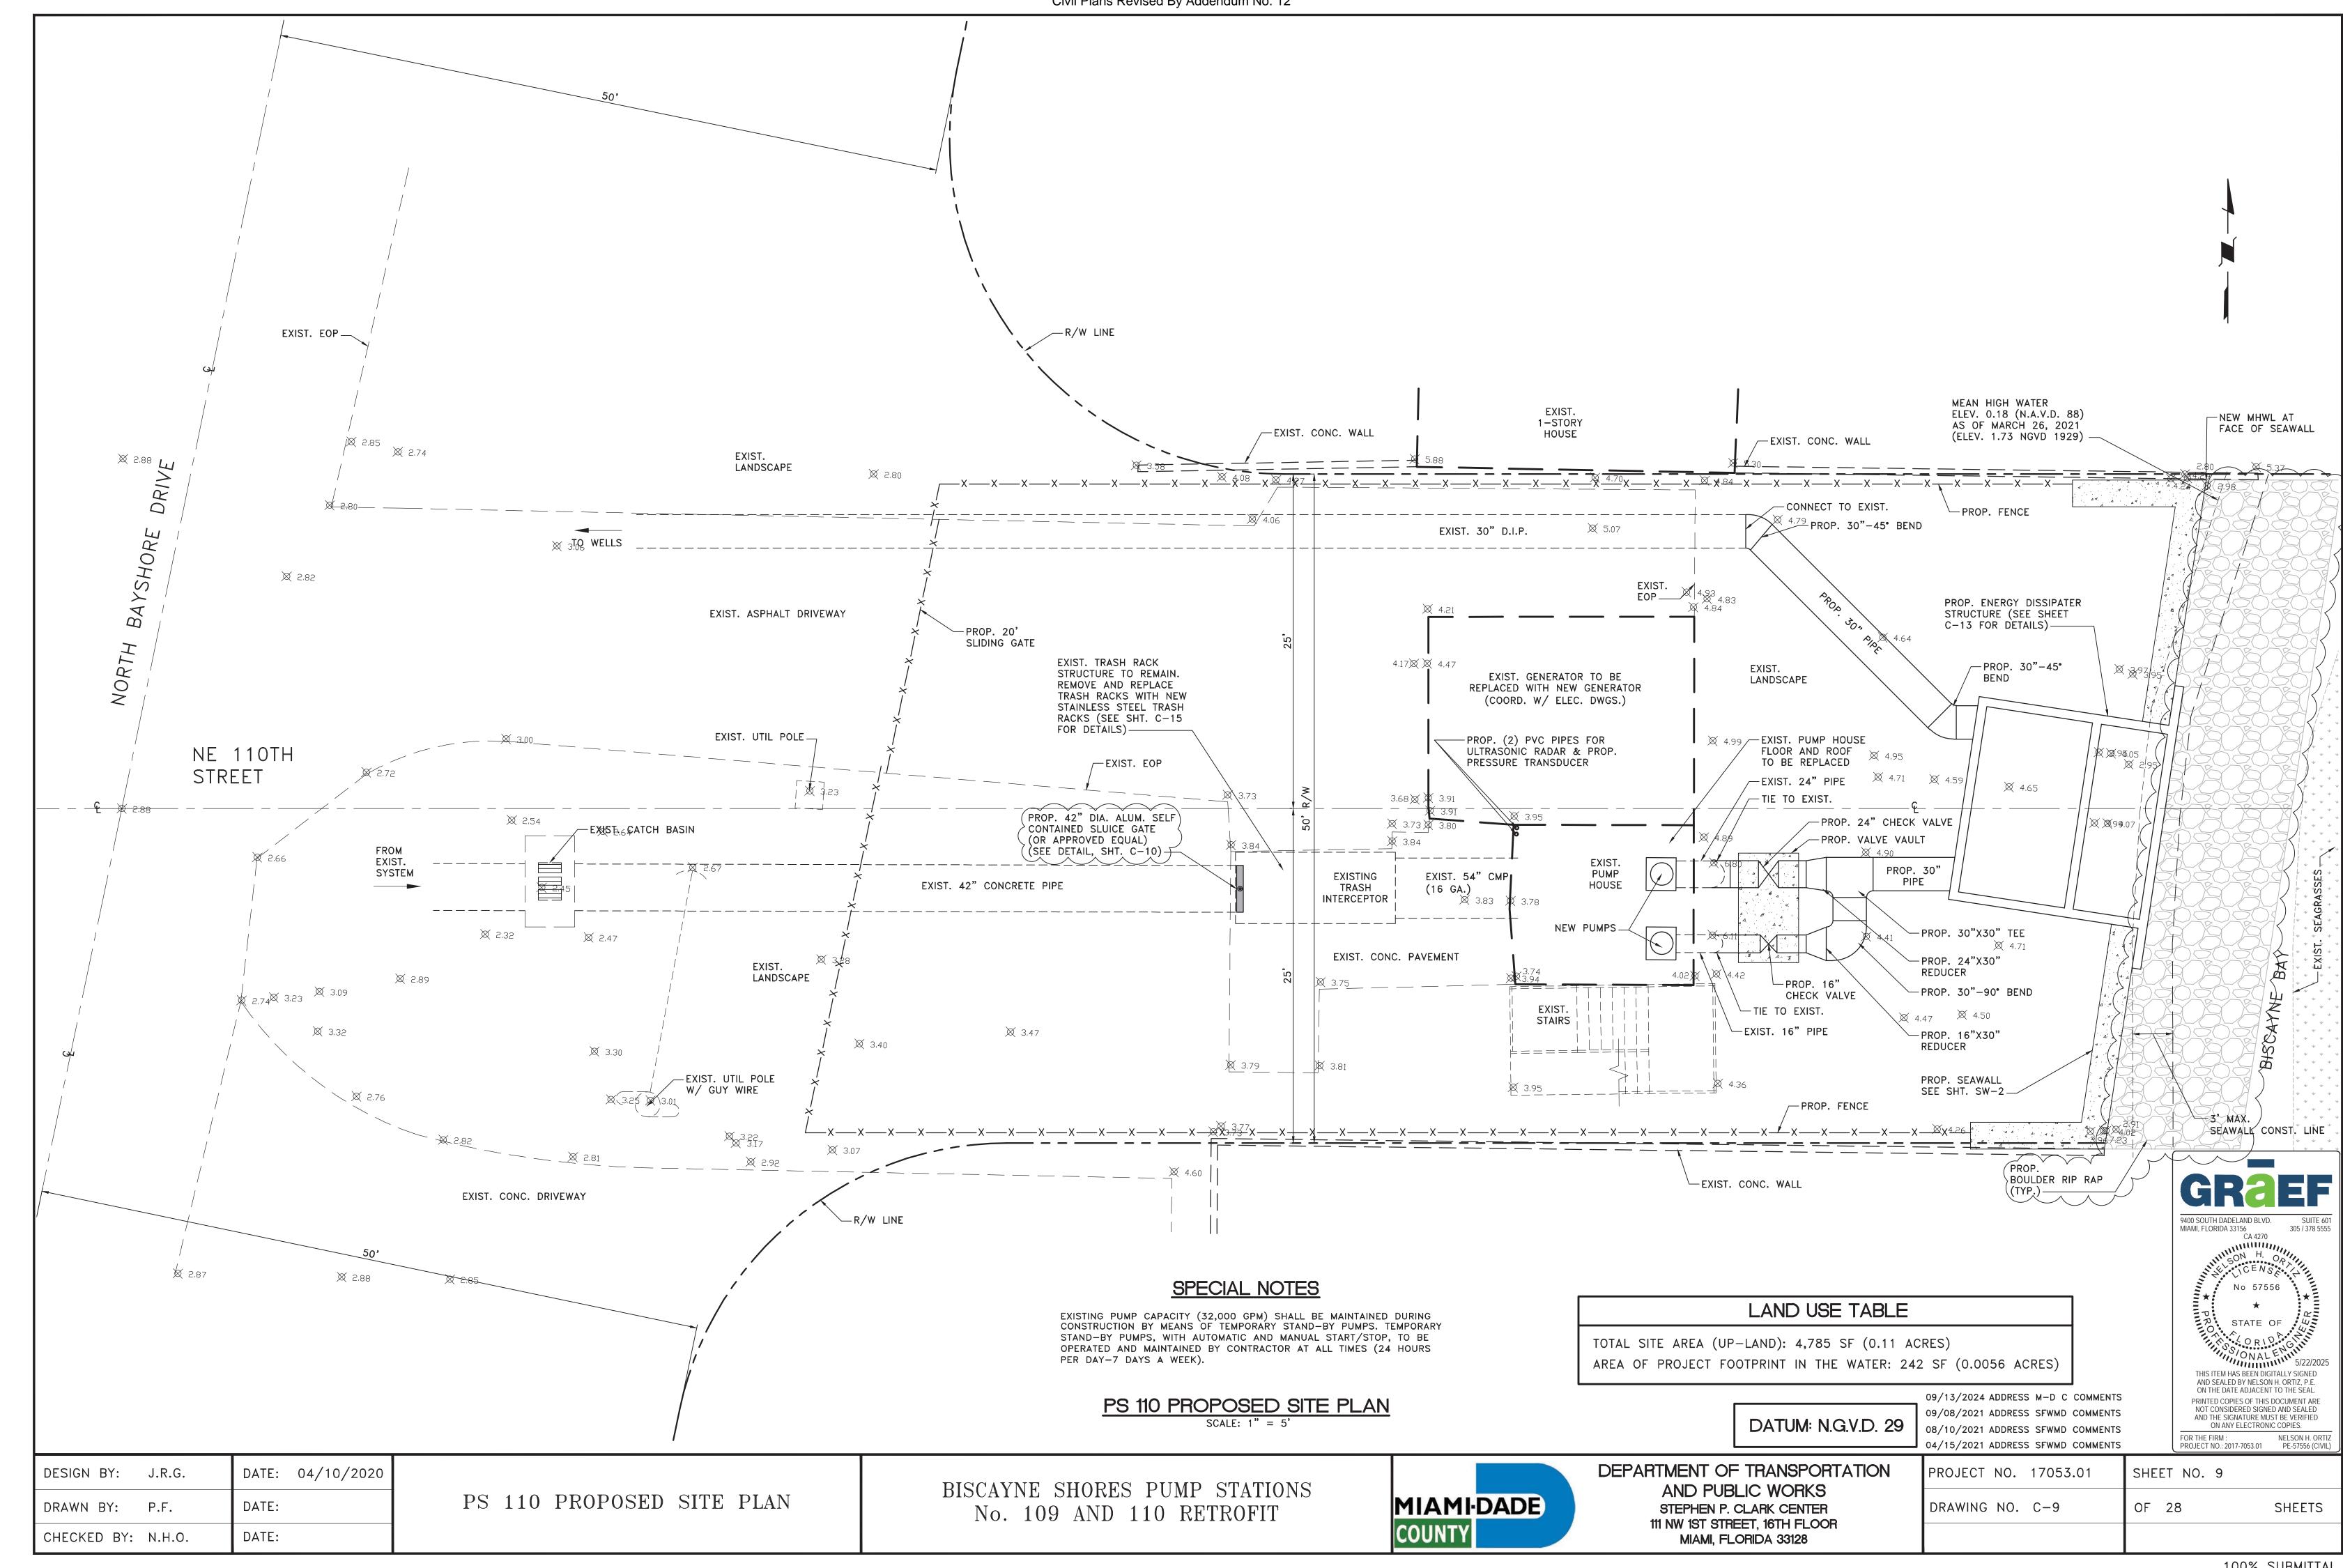
ON THE DATE ADJACENT TO THE SEAL


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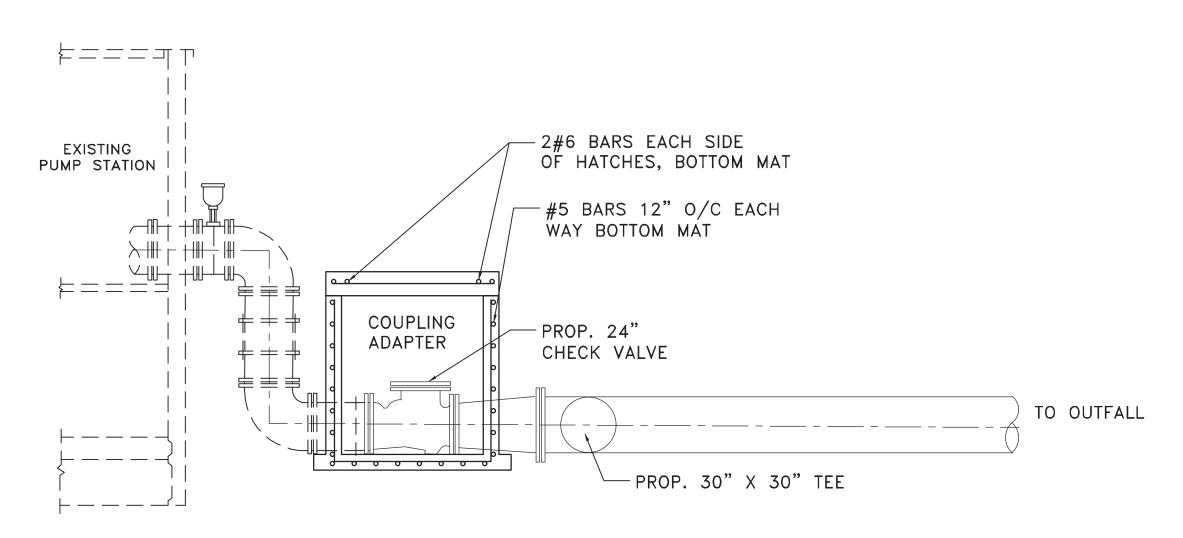
FOR THE FIRM:
PROJECT NO.: 2017-7053.01
PE-57556 (CIVI

MIAMI, FLORIDA 33156






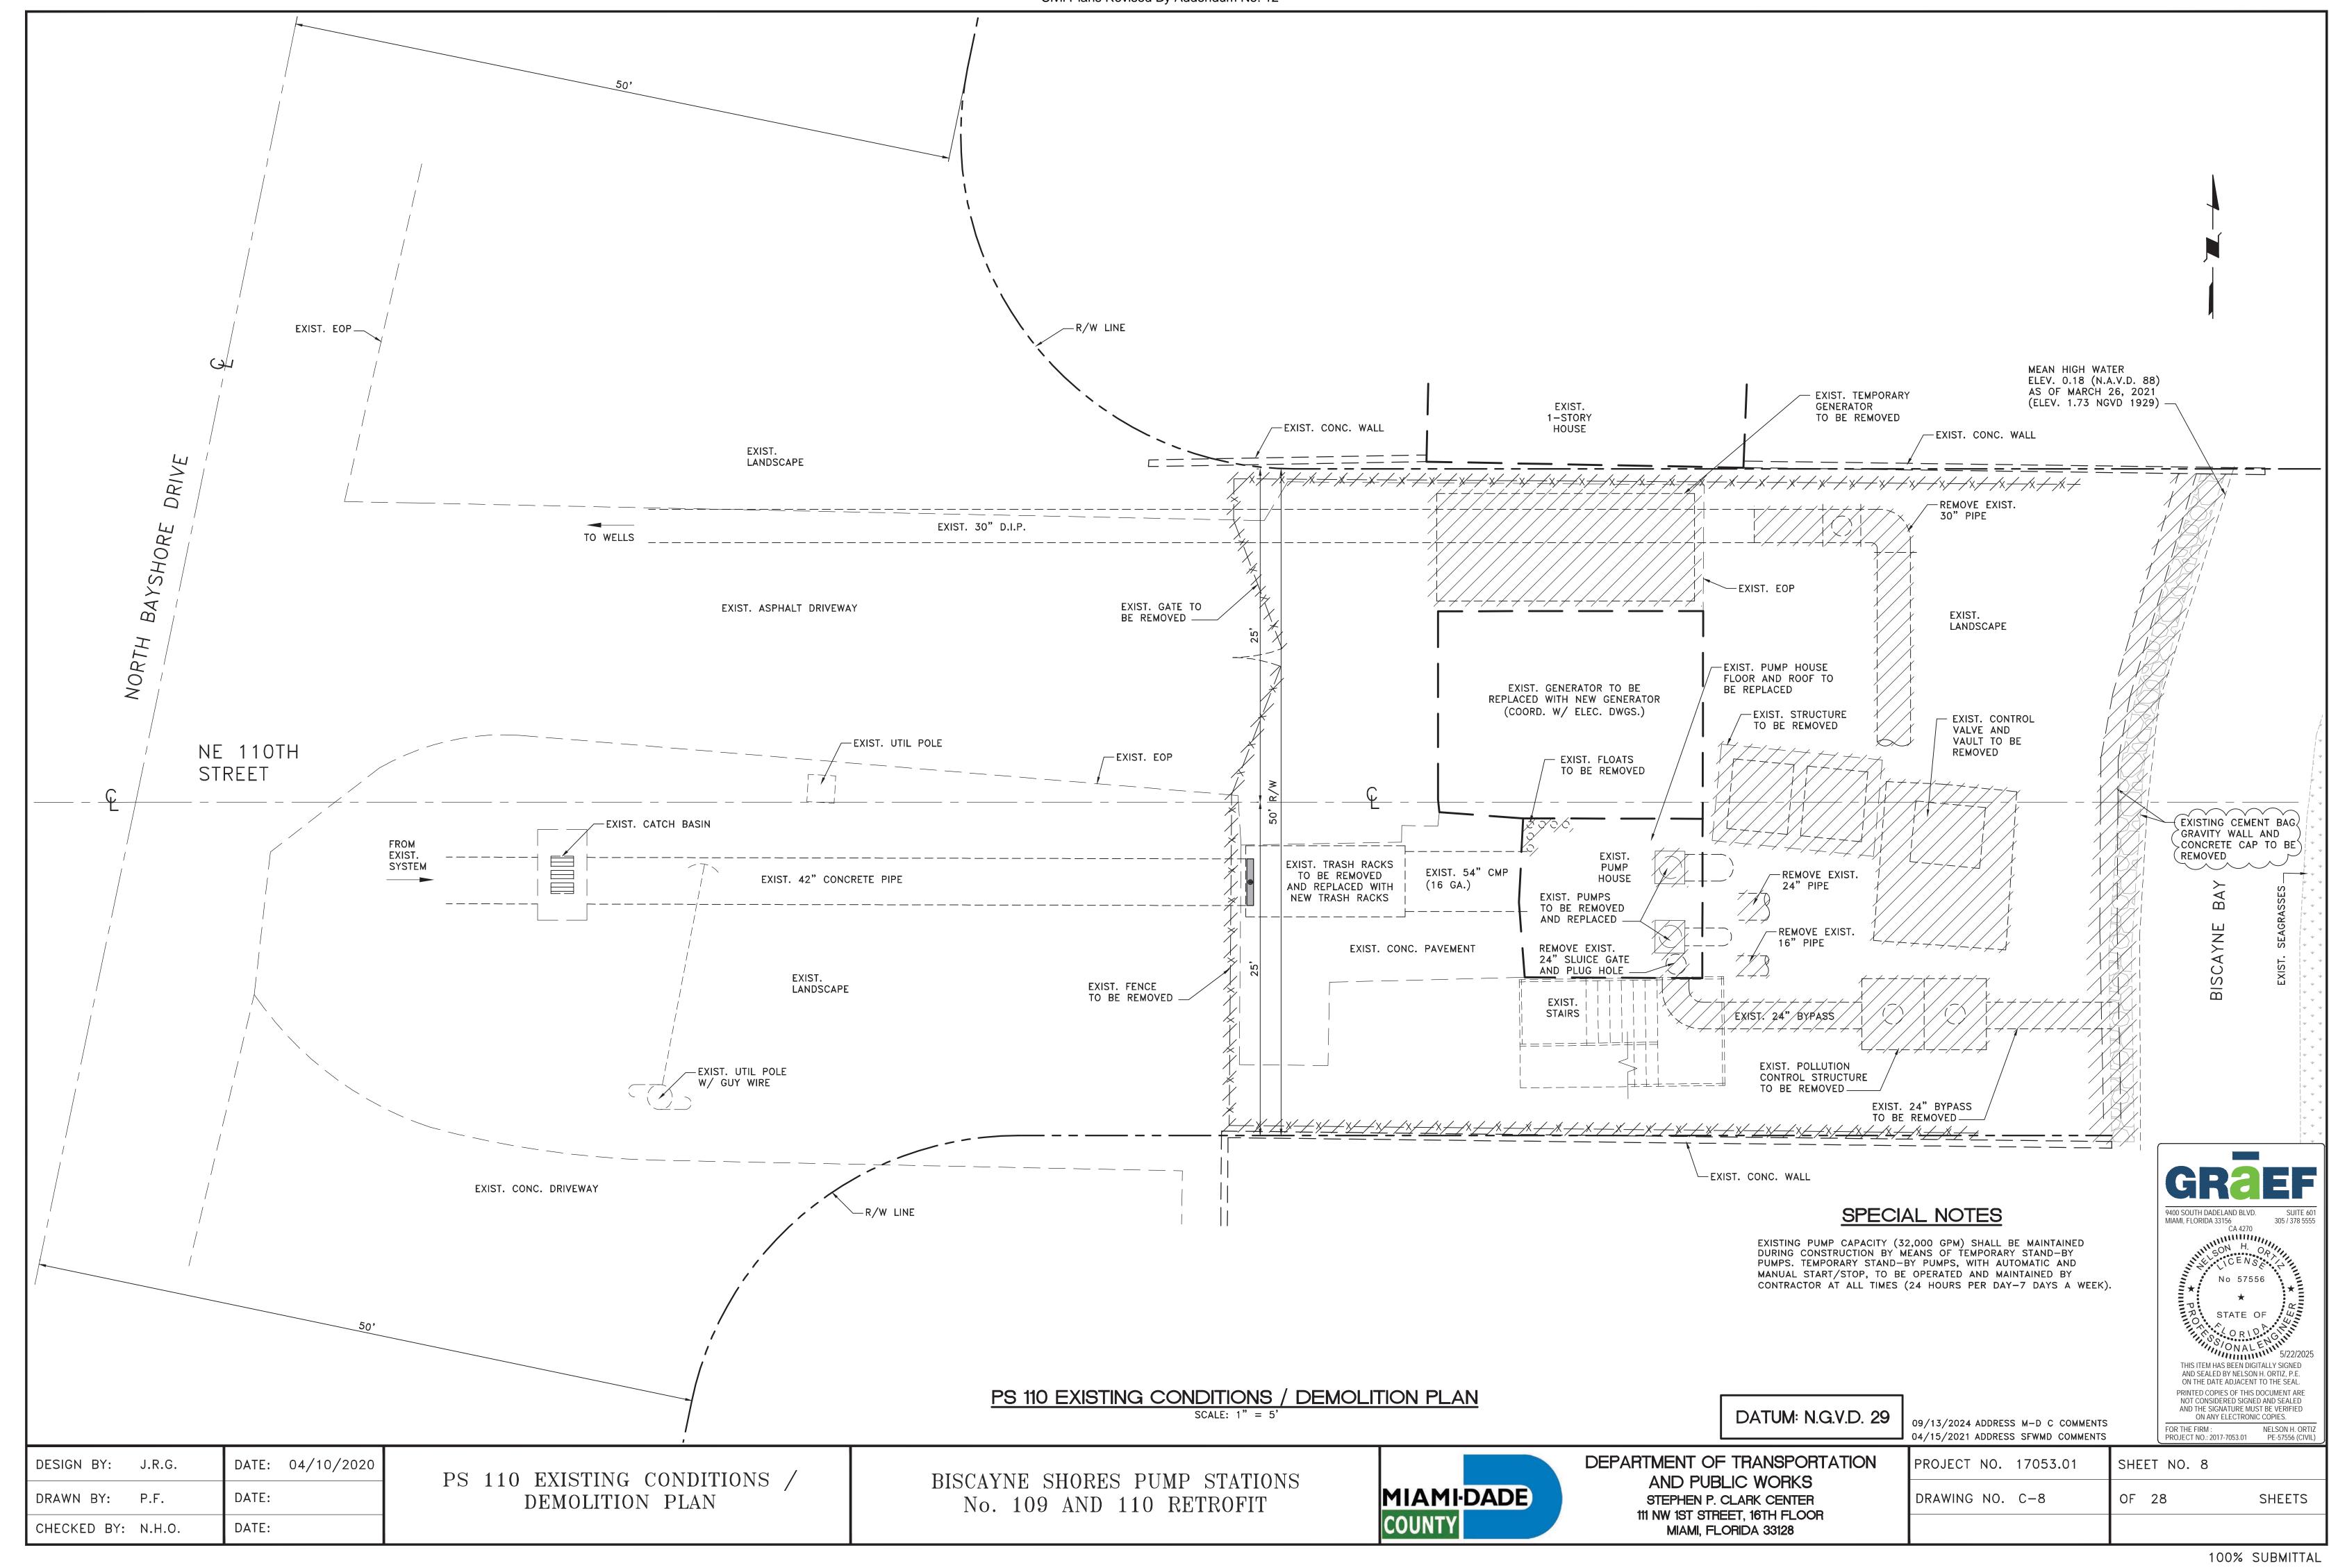

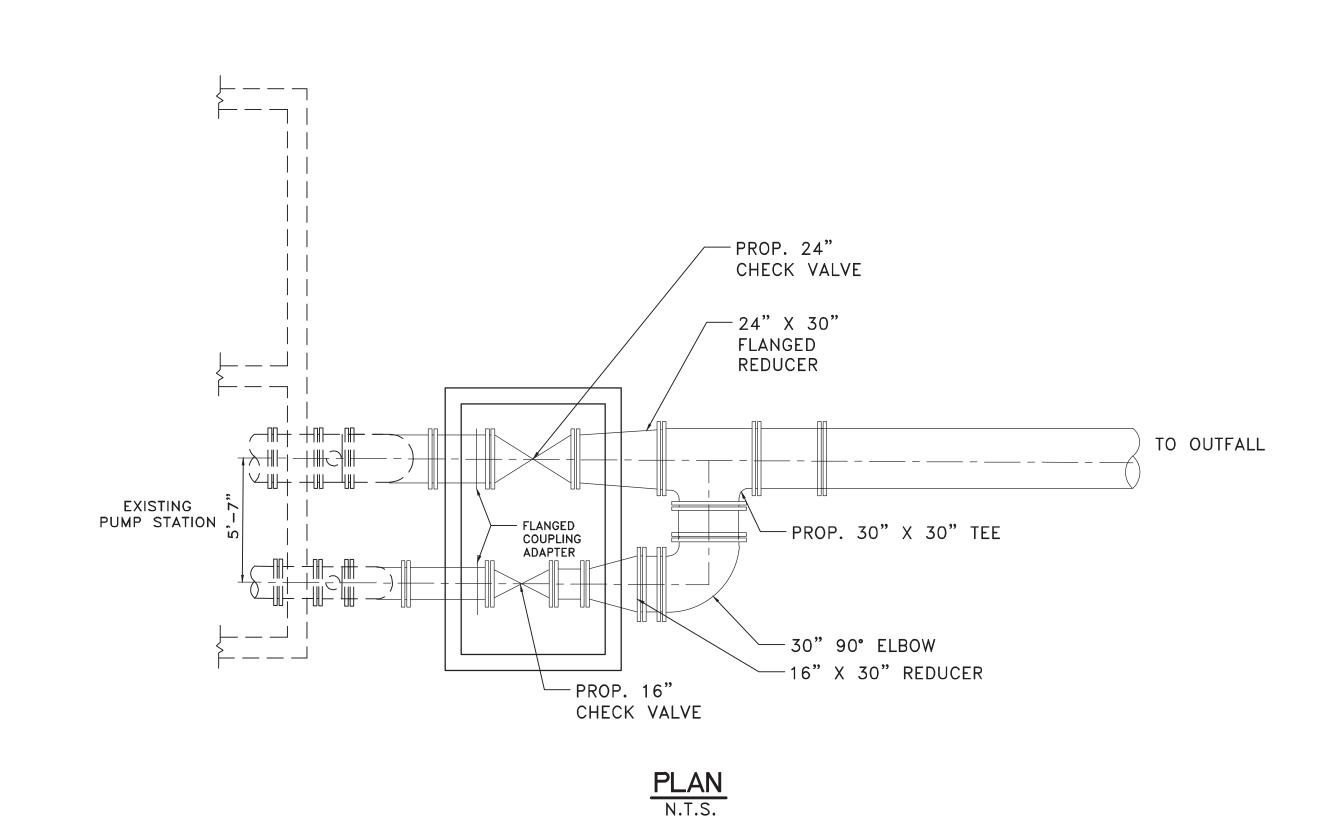


# **ELEVATION**

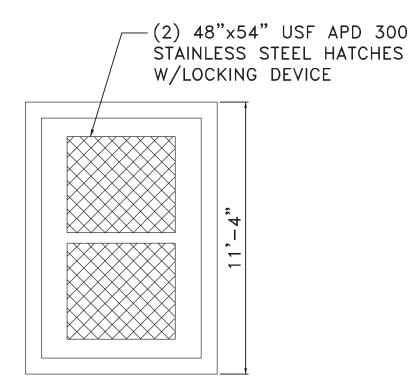

## NOTES:

- ALL JOINTS UP STREAM OF PLUG SHALL BE FLANGED OR RESTRAINED.
- 2. 16" & 24" CHECK VALVES SHALL BE APCO SERIES 100 RUBBER FLAPPER TYPE OR APPROVED EQUAL.
- 3. ADJUST PIPING TO FIT EXISTING CONDITIONS.

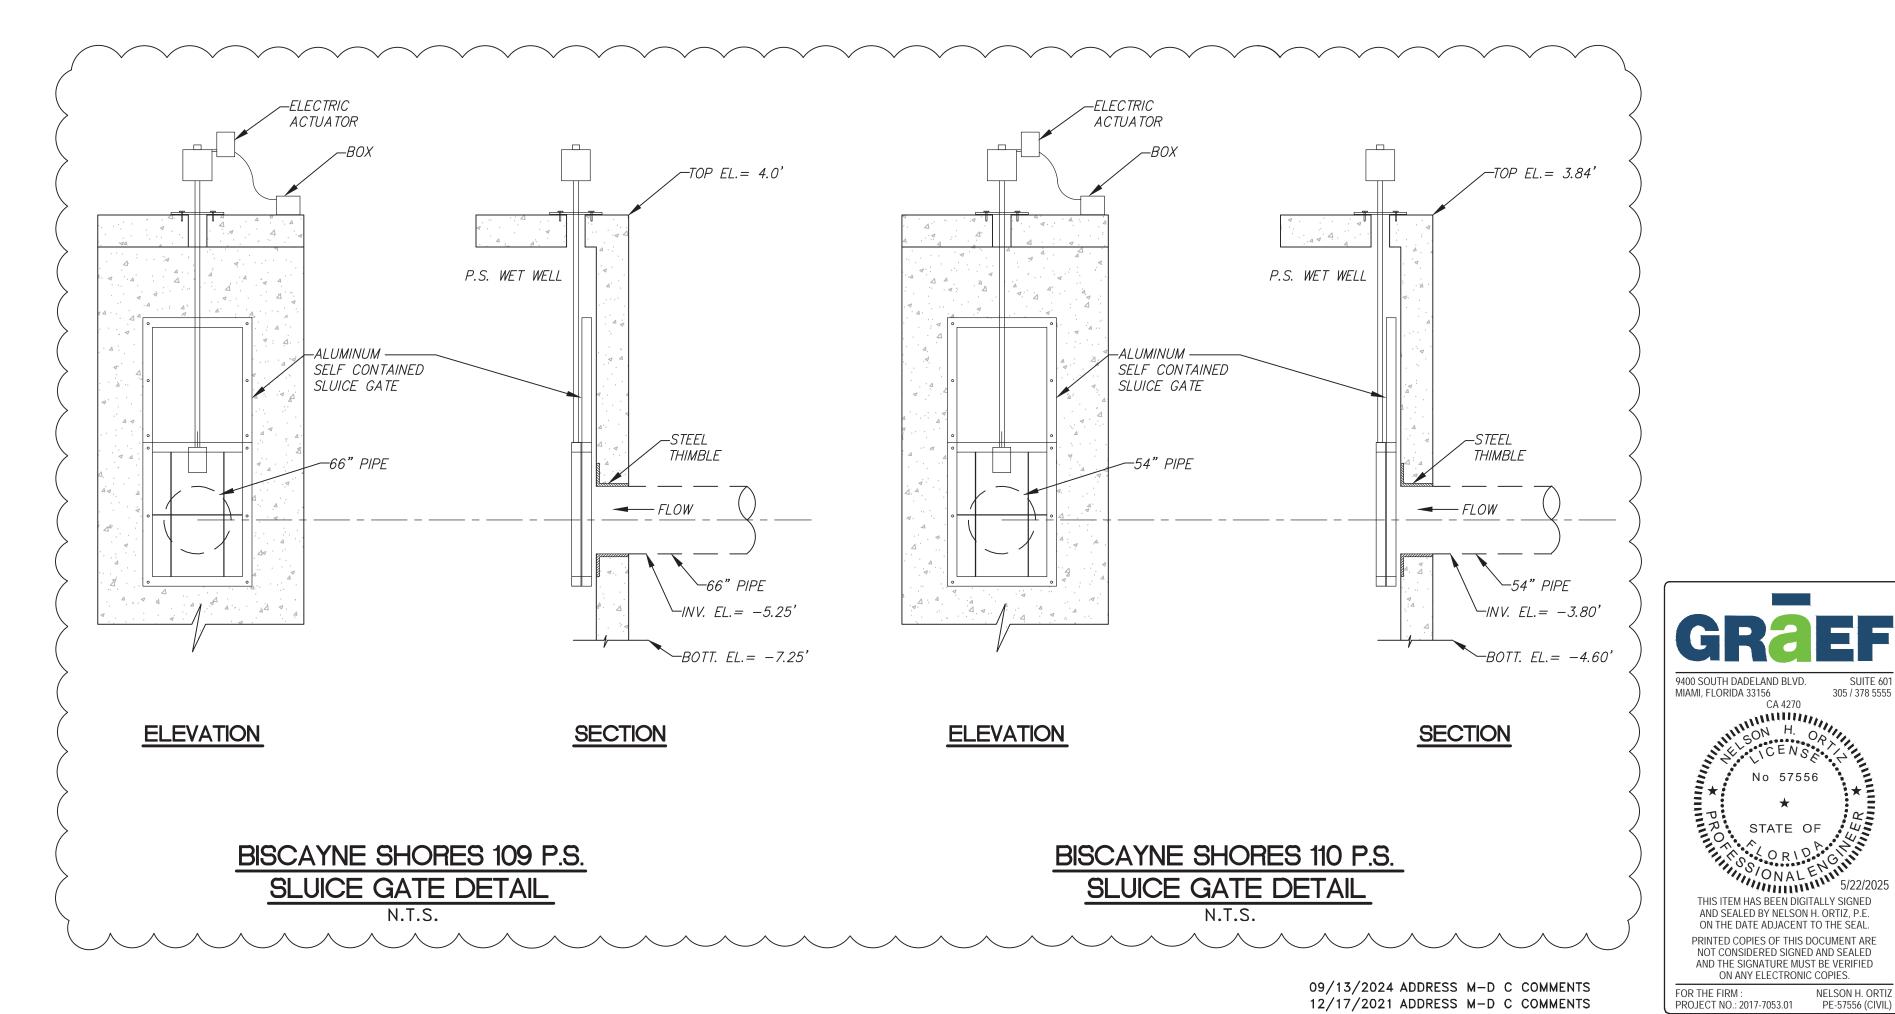


DESIGN BY: J.R.G. DATE: 04/10/2020

DRAWN BY: P.F. DATE:

CHECKED BY: N.H.O. DATE:

PS 110 PLAN AND ELEVATION SLUICE GATE DETAILS

BISCAYNE SHORES PUMP STATIONS No. 109 AND 110 RETROFIT

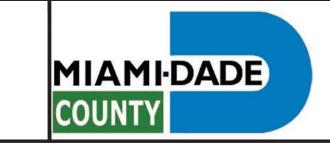

DEPARTMENT OF TRANSPORTATION
AND PUBLIC WORKS
STEPHEN P. CLARK CENTER

111 NW 1ST STREET, 16TH FLOOR

MIAMI, FLORIDA 33128

, ,		`
PROJECT NO. 17053.01	SHEET NO. 10	
DRAWING NO. C-10	OF 28	SHEETS

#### STRUCTURAL GENERAL NOTES 1. DESIGN IS IN ACCORDANCE WITH THE STATE OF FLORIDA BUILDING CODE, (2023) EDITION. 2. STAINLESS STEEL WIDE FLANGE BEAMS, CHANNELS SHALL CONFORM TO ASTM A276, ALLOY 316L. 3. STAINLESS STEEL PLATES SHALL CONFORM TO ASTM A240, ALLOY 316L. 4. STAINLESS STEEL BOLTS SHALL CONFORM TO ASTM F593D, ALLOY 316L. C6X8.2\_ 5. STAINLESS STEEL NUTS AND WASHERS SHALL CONFORM TO ASTM F594 GROUP 2, ALLOY 316L. -ROOF OVERHANG 1/4" REMOVABLE COVER-6. ALL WELDING SHALL COMPLY WITH AWS D1.6 USING E316 ELECTRODES. ALL WELDERS TO BE CERTIFIED BY AWS. -EXIST. CONC. WALL 7. CONTRACTOR MUST FIELD MEASURE EXACT VAULT DIMENSIONS PRIOR TO FABRICATION OF WORKING PLATFORM AND NEW ROOF. WORKING PLATFORM MUST BE INSTALLED PRIOR TO INSTALLATION OF DISCHARGE PIPES. (TO REMAIN) 13'-8" 8. ALL LADDERS, HARDWARE, WIDE FLANGE BEAMS, CHANNELS, ANGLES, PLATES, RAILS, BRACKETS, BOLTS AND ANY FIXTURES OR SUPPORTS SHALL BE STAINLESS STEEL. W8X10\_ 9. DESIGN LOADS: CLEVIS --PICK-UP POINT (JYP.) 4- W8X10 (4) 5"X5"X1/2"X12" LONG W/ (3)-3/4"ø S.S. HILTI KWIK BOLT, 5" EMBEDMENT LIVE LOADS: FLOOR: 40 PSF ROOF: 20 PSF 1/4" STAINLESS (TYP.) AT ENDS OF W8X10 STEEL PLATE \_\_ HINGE-WIND LOAD (ASCE 7-22) BUILDING RISK CATEGORY III BASIC WIND SPEED V = (186) MPH -EXIST. CONC. TURNBUCKLE (4) WALL (TO REMAIN) STAINLESS STEEL ASSEMBLIES (ÒNE AT EXPOSURE: D BEAMS/CROSS EA. CORNER) -INTERNAL PRESSURE COEFFICIENT GCPI =+/-0.18BEAMS (TYP.) -L1X1X3/16 ALL AROUND OPENING 5/8" TIE-ROD-10. CONTRACTOR SHALL PROVIDE SHOP DRAWINGS FOR THE FOLLOWING ITEMS PRIOR TO FABRICATION: STRUCTURAL STEEL, STEEL PLATES, AND STEEL LADDER. 4"X3"X3/8"X6" LONG W/ SECTION A-A HINGE-(2)-3/4"ø HILTI KWIK BOLT, 5" EMBEDMENT -36.5" 64" -C6X8.2 — C6X8.2 HING -1/4" STAINLESS STEEL PLATE -HINGE -L1X1X3/16 ALL AROUND OPENING 36.5" -HATCH WHEN -HINGE OPEN -3/4" DIAMETER C6X8.2 (TYP.) KNURLED RUNG -TOP OF -L1X1X3/16 |(MIN.)|STRUCTURE ALL AROUND OPENING 1/8", ——9/16" HOLE 4.5' X 4.5' PUMP HOUSE ROOF OPENING COMPRESSION <del>-</del>8-1/2" 42"X34" LADDER ENTRANCE ——— SEAL ROOF PLAN NOTE: CONTRACTOR SHALL PROVIDE SHOP DRAWINGS FOR FABRICATION. 13'-5" EXIST. CONC. WALL (TO REMAIN) -EXIST. CONC. WALL 11'-9" (TO REMAIN)-PROP. (2) PVC PIPES FOR ULTRASONIC RADAR & PROP. 2-3/8" 2-3/8" -1/4" DIAMOND PLATE WALKING PRESSURE TRANSDUCER -SURFACE 48"X48" 12" (TYP.) OPENING IN STAINLESS STEEL FOR RUNGS 12" 40.5" 40.5" 48" BEAMS/CROSS BEAMS (TYP.)— DIAMOND PLATE FLOORING -W8X18 (TYP.)— PROP. MWI 3/4" DIAMETER KNURLED RUNG PUMP C8X11.5-- 1/2"ø S.S. BOLTS (TYP.) 40.5" 48" 40.5" - L 8" X 4" X **DETAIL** 7/16" X 0'-3" EYE BOLT \_\_ 3/8" X 2-1/2" HINGE **DETAIL** STRINGER (TYP.) 48"X48" OPENING IN DIAMOND PLATE BAR 3/8" X 2-1/2" FLOORING\_ STRINGER (TYP.) — EXIST. 60" CONC. PIPE -3/8" BENT PLATE C8X11.5 48" (TYP.) — LADDER -LADDER

DESIGN BY:	J.R.G.	DATE:	04/10/2020
DRAWN BY:	P.F.	DATE:	
CHECKED BY:	N.H.O.	DATE:	

ENTRANCE -

1/4" DIAMOND

PLATE COVER\_

EXIST. LADDER

TO BE REMOVED -

PS 110 PUMP HOUSE RETROFIT DETAILS

INTERMEDIATE FLOOR PLAN


SCALE: 1/2" = 1'-0"

DIAMETER THREADED RODS @18", DRILL AND EPOXY, 5" EMBEDMENT, TYPICAL AT 4 SIDE PERIMETER

BISCAYNE SHORES PUMP STATIONS No. 109 AND 110 RETROFIT

SECTION C-C

SCALE: 1/2" = 1'-0"

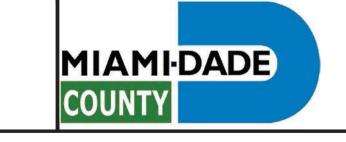

DEPARTMENT OF TRANSPORTATION

AND PUBLIC WORKS

STEPHEN P. CLARK CENTER

111 NW 1ST STREET, 16TH FLOOR

MIAMI, FLORIDA 33128

**SECTION** 

NOTE: ALL LADDER COMPONENTS SHALL BE STAINLESS STEEL.

LADDER DETAIL

PROJECT NO. 17053.01 SHEET NO. 11

DRAWING NO. C-11 OF 28 SHEETS

**ELEVATION** 

09/13/2024 ADDRESS M-D C COMMENTS

12/17/2021 ADDRESS M-D C COMMENTS

THIS ITEM HAS BEEN DIGITALLY SIGNED AND SEALED BY NELSON H. ORTIZ, P.E. ON THE DATE ADJACENT TO THE SEAL.

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AND THE SIGNATURE MUST BE VERIFIED

FOR THE FIRM: NELSON H. ORTI PROJECT NO.: 2017-7053.01 PE-57556 (CIVIL

## **GENERAL NOTES**

- 1. ELEVATIONS SHOWN REFER TO THE NORTH GEODETIC VERTICAL DATUM. (N.G.V.D.).
- 2. HORIZONTAL AND VERTICAL CONTROL SHALL BE PROVIDED BY THE OWNER'S SURVEYOR. ALL CONSTRUCTION LAYOUT SHALL BE THE RESPONSIBILITY OF THE CONTRACTOR.
- 3. IT IS THE INTENT OF THESE PLANS TO BE IN ACCORDANCE WITH APPLICABLE CODES AND AUTHORITIES HAVING JURISDICTION. ANY DISCREPANCIES BETWEEN THESE PLANS AND APPLICABLE CODES SHALL BE IMMEDIATELY BROUGHT TO THE ATTENTION OF THE ENGINEER.
- 4. IT IS THE INTENT OF THESE PLANS AND THE RESPONSIBILITY OF THE CONTRACTOR TO COMPLY WITH LOCAL, STATE, AND FEDERAL ENVIRONMENTAL PERMITS ISSUED FOR THIS PROJECT. IT SHALL BE THE CONTRACTORS RESPONSIBILITY TO FAMILIARIZE HIMSELF WITH AND GOVERN HIMSELF BY ALL PROVISIONS OF THESE PERMITS.
- 5. IT SHALL BE THE CONTRACTOR'S RESPONSIBILITY TO VERIFY ALL UNDERGROUND FACILITIES PRIOR TO THE START OF CONSTRUCTION AND COORDINATE WITH THE VARIOUS UTILITY COMPANIES TO RELOCATE, BYPASS, OR OTHERWISE ENSURE THAT UTILITY SERVICES WILL NOT BE INTERRUPTED DURING CONSTRUCTION.
- 6. EXISTING GRADES AND SOUNDINGS WERE TAKEN FROM THE BEST AVAILABLE DATA AND MAY NOT ACCURATELY REFLECT PRESENT CONDITIONS. CONTRACTOR SHALL BE RESPONSIBLE FOR FAMILIARIZING HIMSELF WITH CURRENT SITE CONDITIONS, AND SHALL REPORT ANY DISCREPANCIES TO THE ENGINEER PRIOR TO STARTING WORK.
- 7. EXISTING CONDITIONS WERE TAKEN FROM THE SURVEY PREPARED BY MIAMI-DADE COUNTY DEPARTMENT OF TRANSPORTATION AND PUBLIC WORKS ROADWAY ENGINNERING AND RIGHT OF WAY DIVISION, MIAMI, FLORIDA, DATED JUNE 14, 2016.

# —EXIST. CONC. WALL BOULDER RIP RAP-\_\_\_\_ EXIST. 30" D.I.P. \_\_\_\_\_\_\_\_\_\_\_ PROP. ENERGY DISSIPATER STRUCTURE (SEE SHEET C-13 FOR DETAILS)— EXIST. LANDSCAPE EXIST. GENERATOR TO BE REPLACED WITH NEW GENERATOR (COORD. W/ ELEC. DWGS.) PROP. 30" PUMP PIPE EXIST. STAIRS PROP. SEAWALL SEE SHT. SW-2 \_\±±±===== -PROP. FENCE MEAN HIGH WATER ELEV. 0.18 (N.A.V.D. 88) -EXIST. CONC. WALL AS OF MARCH 26, 2021 (ELEV. 1.73 NGVD 1929)

N.E. 110 STREET PUMP STATION SEAWALL


## STRUCTURAL NOTES

- 1. ALL DEBRIS ASSOCIATED WITH CLEARING SHALL BE REMOVED FROM THE SITE AND DISPOSED OF BY THE CONTRACTOR.
- 2. CONCRETE PILES SHALL BE DRIVEN TO THE FOLLOWING CRITERIA:
- A. KING PILES SHALL BE DRIVEN TO A MINIMUM BEARING CAPACITY OF 25 TONS AND TO A TIP ELEVATION OF ELEV.
- B. BATTER PILES SHALL BE DRIVEN TO A MINIMUM BEARING CAPACITY OF 25 TONS AND A MINIMUM DEPTH OF EMBEDMENT OF FEET INTO FIRM MATERIAL.
- 3. CONCRETE PILES SHALL BE 12" SQUARE PRECAST PRESTRESSED PILES, AS DETAILED IN THESE DRAWINGS.
- 4. SHOP DRAWINGS FOR ALL REBAR SHALL SHOW THE ACTUAL MILL MARK ON THE REBARS MEETING ASTM A615.
- 5. SPLICES IN REINFORCING STEEL BARS SHALL BE A MINIMUM OF 36 BAR DIAMETERS EXCEPT WHERE DIMENSIONED OTHERWISE.
- 6. MINIMUM CONCRETE COVER FOR REINFORCING SHALL BE AS DETAILED IN THESE DRAWINGS. WHERE THIS COVER IS NOT DIMENSIONED, USE THE SAME AS DIMENSIONED FOR SIMILAR ITEMS. WHERE THERE ARE NO SIMILAR ITEMS THAT INDICATE THE AMOUNT OF COVER, 3 INCHES OF COVER SHALL BE PROVIDED.
- 7. THE CONTRACTOR SHALL PREPARE AND SUBMIT SHOP DRAWINGS FOR ALL PRECAST UNITS AND SHALL NOT PROCEED WITH THE MANUFACTURE OF THESE ITEMS PRIOR TO RECEIVING APPROVAL OF THE ENGINEER.
- 8. IT SHALL BE THE CONTRACTOR'S RESPONSIBILITY TO FIELD VERIFY ALL DIMENSIONS PRIOR TO CASTING ANY NON-TYPICAL CONCRETE PANELS. RE-CASTING OF ANY NON-TYPICAL CONCRETE PANEL DUE TO A DISCREPANCY IN DIMENSIONS SHALL AT THE CONTRACTOR'S EXPENSE.
- 9. ALL EXPOSED CONCRETE EDGES SHALL BE CHAMFERED 3/4", OR AS SHOWN.
- 10. ALL EXPOSED CONCRETE SURFACES SHALL HAVE A LIGHT BROOM FINISH.
- 11. EXPANSION JOINTS SHALL BE PREFORMED BITUMINOUS MATERIAL CONFORMING TO ASTM D1751 AND LOCATED AS SHOWN IN THESE DRAWINGS.
- 12. NO CONSTRUCTION JOINTS, OTHER THAN SHOWN, SHALL BE MADE WITHOUT PRIOR APPROVAL OF THE ENGINEER.
- 13. ALL BACKFILL WHICH MAY BE REQUIRED FOR THE PROJECT WILL BE ACQUIRED FROM OFF-SITE SOURCES. CONTRACTOR SHALL BEAR ALL COSTS OF TRANSPORT OF THIS MATERIAL TO AND WITHIN THE PROJECT SITE.
- 14. TESTING OF CONCRETE: TESTING LABORATORY WILL BE RETAINED BY THE OWNER TO VERIFY SPECIFIED CONCRETE STRENGTHS. FAILURE OF ANY CONCRETE CYLINDER TO MEET SPECIFIED REQUIREMENTS SHALL BE DEEMED NON-COMPLYING. ALL COSTS OF ADDITIONAL TESTING TO DETERMINE ADEQUACY AND/OR REPLACEMENT OF DEFECTIVE WORK SHALL BE BORNE BY CONTRACTOR.
- 15. SILT BARRIERS: FLOATING SILT BARRIERS SHALL BE INSTALLED AROUND ALL GRADING OPERATIONS AND AROUND PILE OPERATIONS (PREDRILLING PILE HOLES AND PILE DRIVING), WHERE NECESSARY, SUCH THAT ALL REQUIRED TURBIDITY LIMITS AS DESIGNATED BY ENVIRONMENTAL REGULATORY AGENCIES ARE MAINTAINED.

## MATERIAL AND DESIGN DATA

#### A. MATERIALS:

- 2. CONCRETE PILES SHALL BE 12" SQUARE PRECAST PRESTRESSED PILES WITH FOUR 1/2"ø 270K LO-LAX STRANDS WITH #5 GAGE WIRE SPIRAL
- 3. REBAR, ANY SIZES, SHALL BE GALVANIZED STEEL AND SHALL CONFORM TO ASTM A615, GRADE 60.
- 4. ACCESSORIES SHALL BE ASTM A-36.
- 5. GEOTEXTILE FABRIC SHALL BE NON-WOVEN POLYPROPYLENE, MIRAFI 140N OR APPROVED EQUAL AT EACH PILE LOCATION (24" MIN. WIDTH).
- B. STRUCTURAL DESIGN IN ACCORDANCE WITH THE FOLLOWING CODES AND SPECIFICATIONS:
- 1. THE FLORIDA BUILDING CODE (CURRENT EDITION).
- 2. ACI STANDARD BUILDING CODE REQUIREMENTS FOR REINFORCED CONCRETE (ACI 318).

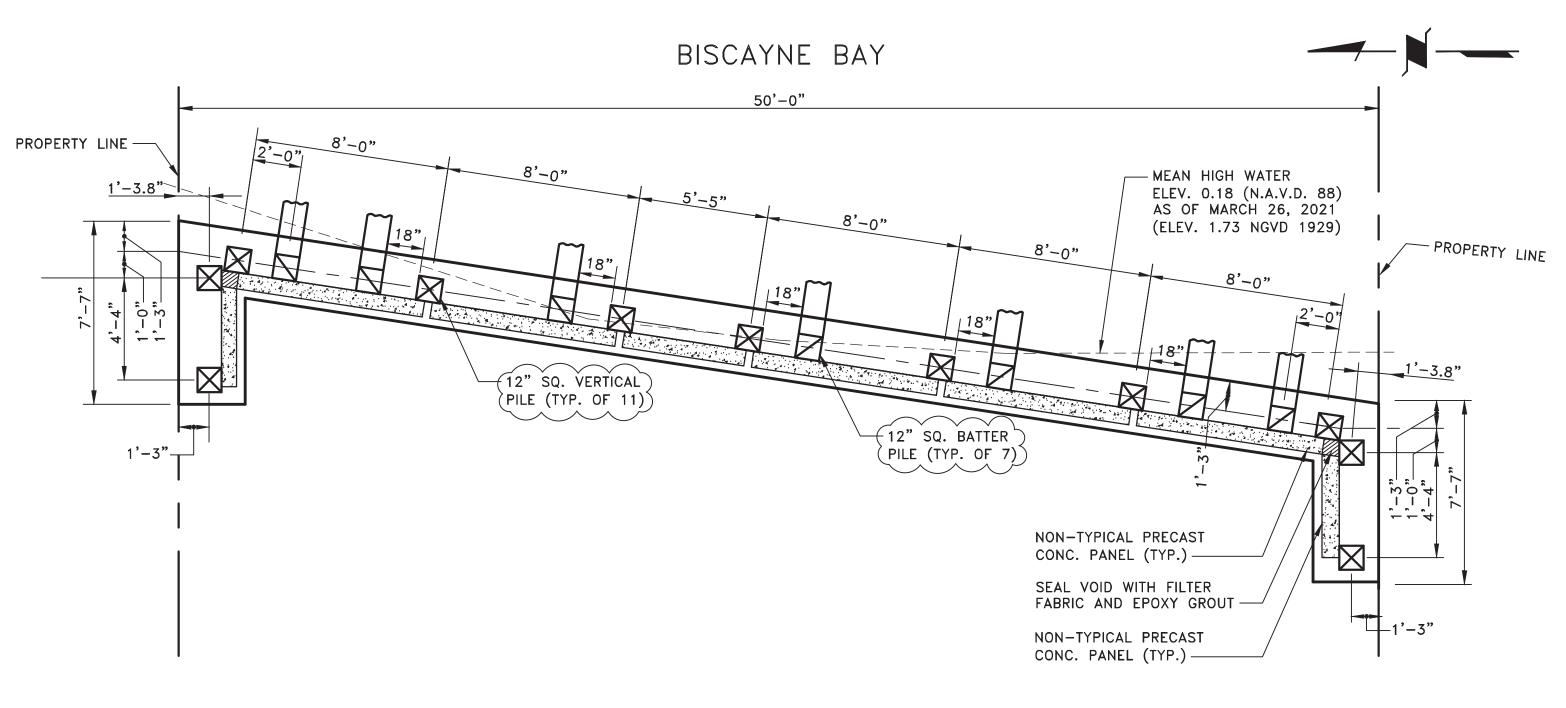

PILE LAYOUT PLAN

SCALE: 1/4" = 1'-0"

9400 SOUTH DADELAND BLVD.
MIAMI, FLORIDA 33156

CA 4270

SON H. OR

CE NS

NO 57556

\*\*

STATE OF

OR 1 D. G.

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AND SEALED BY NELSON H. ORTIZ, P.E.
ON THE DATE ADJACENT TO THE SEAL.

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FOR THE FIRM:
PROJECT NO.: 2017-7053.01
NELSON H. ORT
PE-57556 (CIVI

09/13/2024 ADDRESS M-D C COMMENTS

DESIGN BY: J.R.G. DATE: 04/10/2020

DRAWN BY: P.F. DATE:

CHECKED BY: N.H.O.

DATE:

PS 110 SEAWALL PLAN AND DETAILS

BISCAYNE SHORES PUMP STATIONS No. 109 AND 110 RETROFIT



DEPARTMENT OF TRANSPORTATION


AND PUBLIC WORKS


STEPHEN P. CLARK CENTER


111 NW 1ST STREET, 16TH FLOOR

MIAMI, FLORIDA 33128


PROJECT NO. 17053.01	SHEET NO. 12	
DRAWING NO. C-12	OF 28	SHEETS

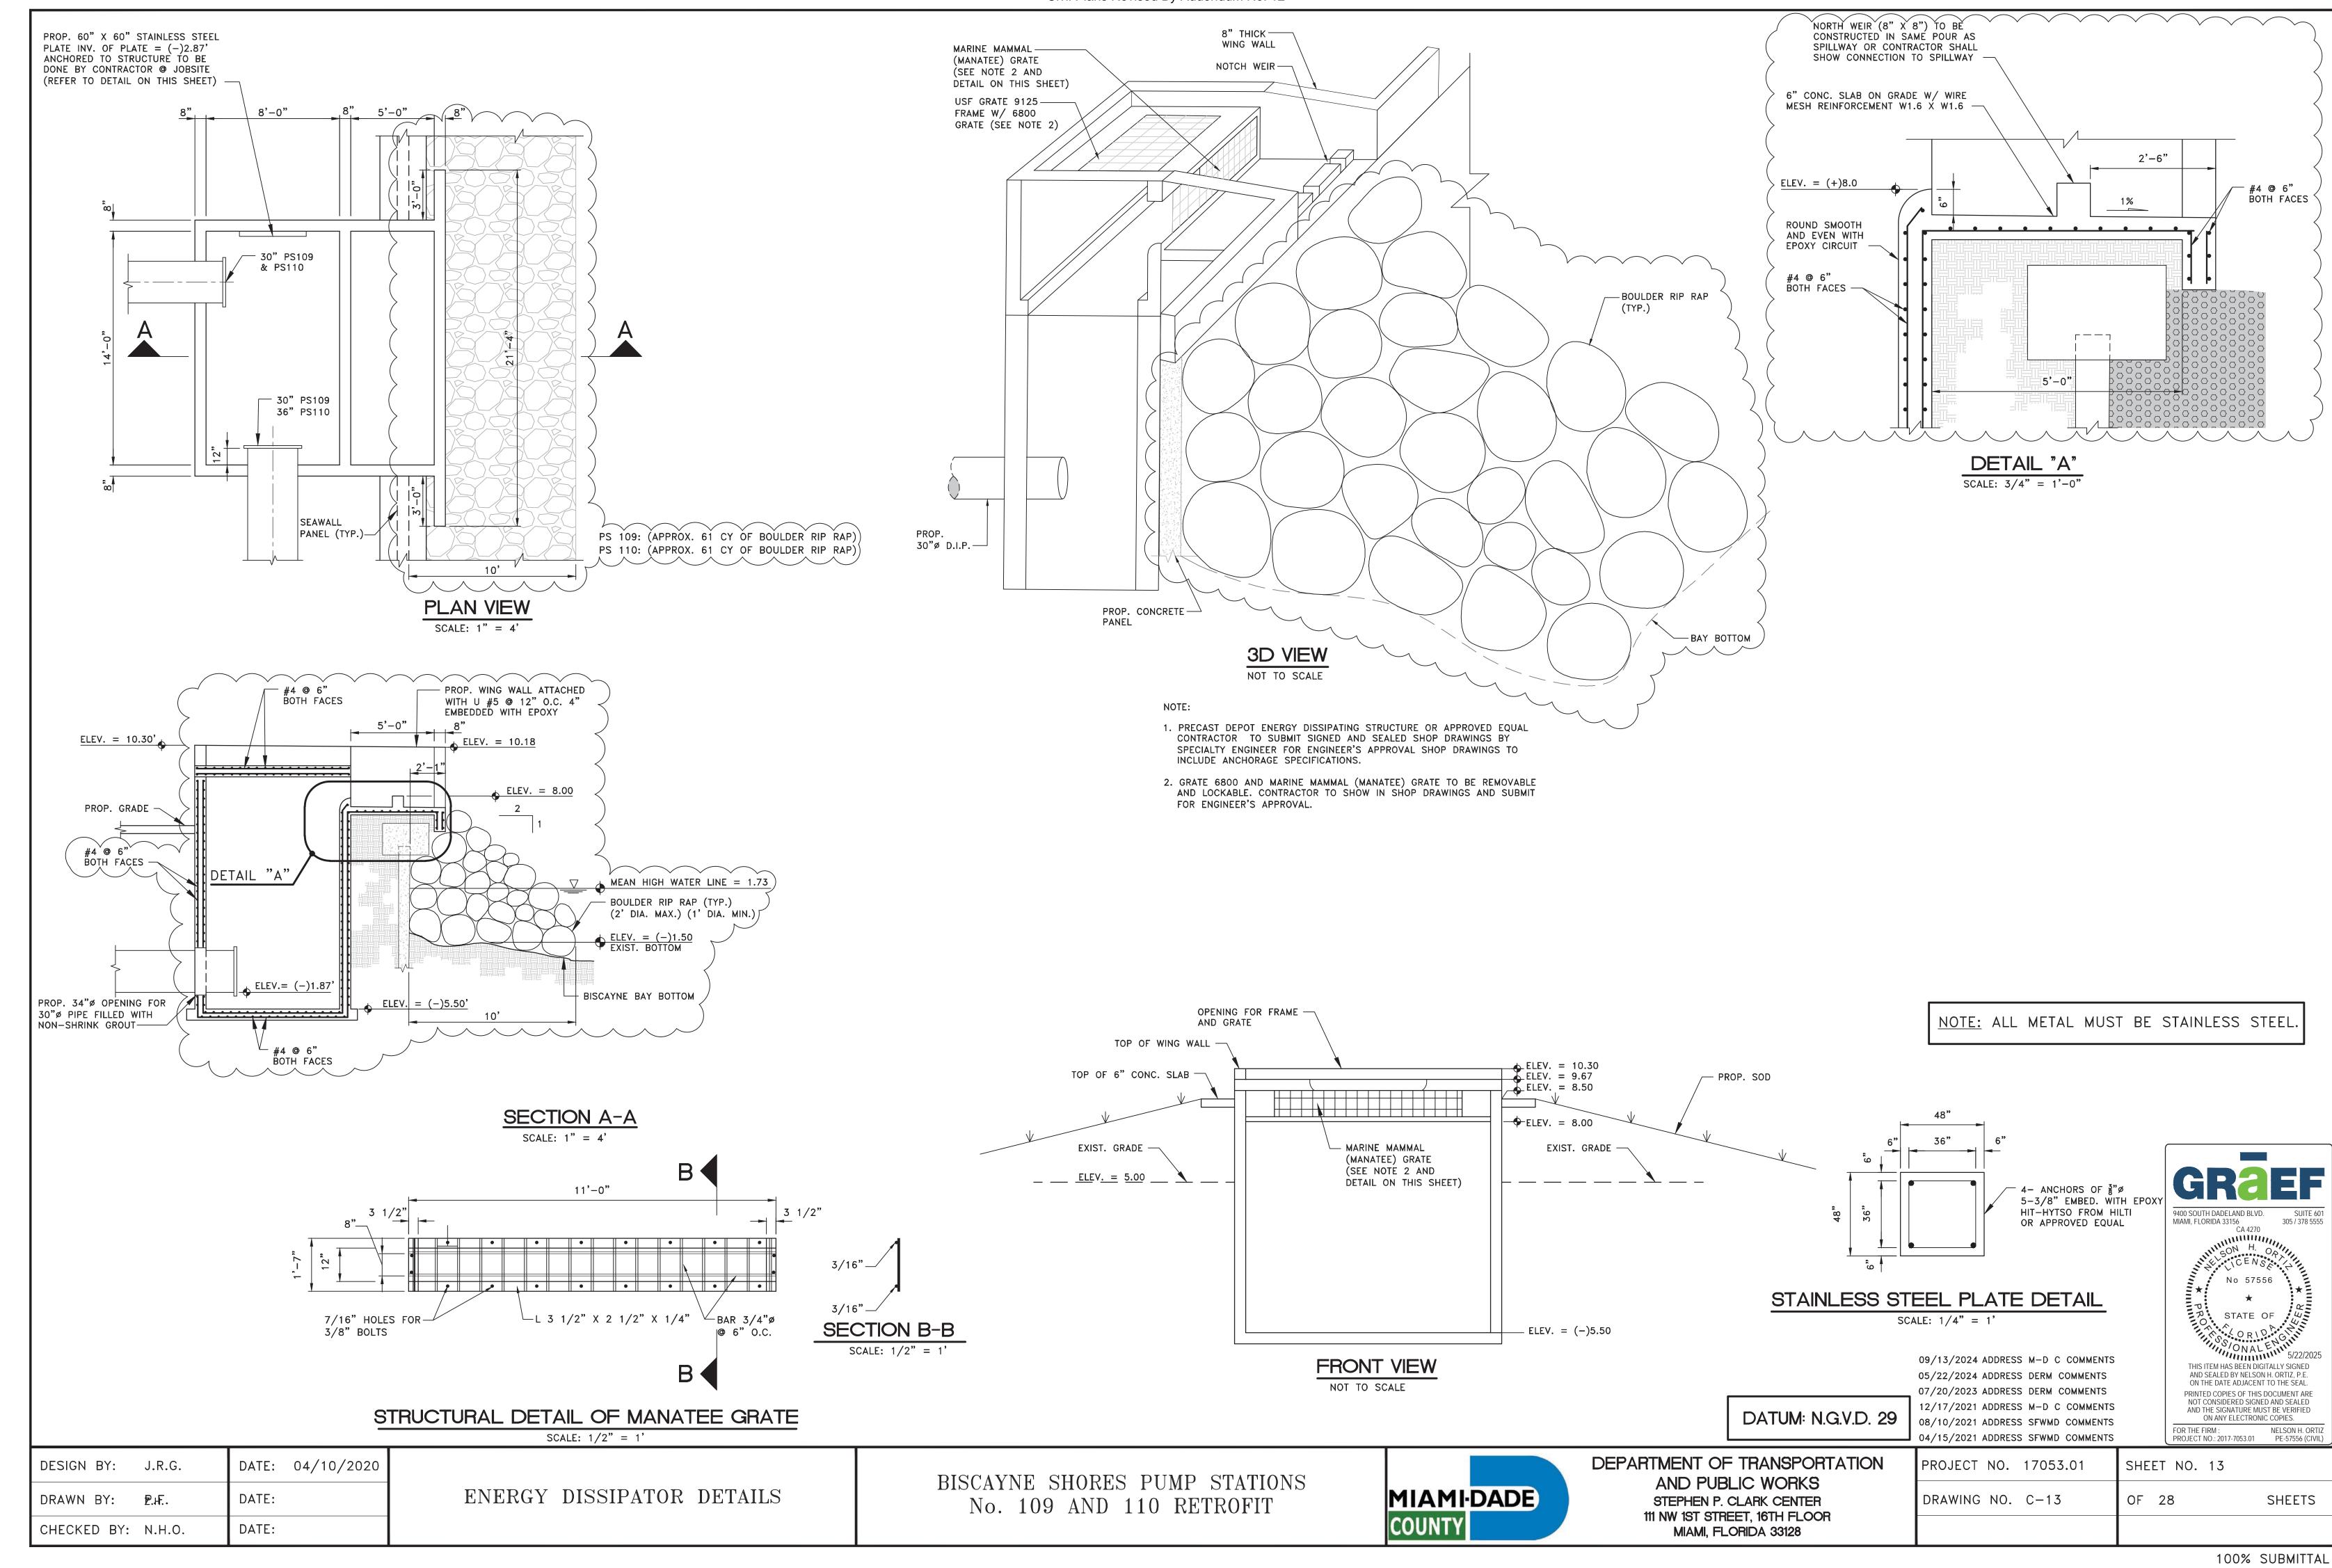

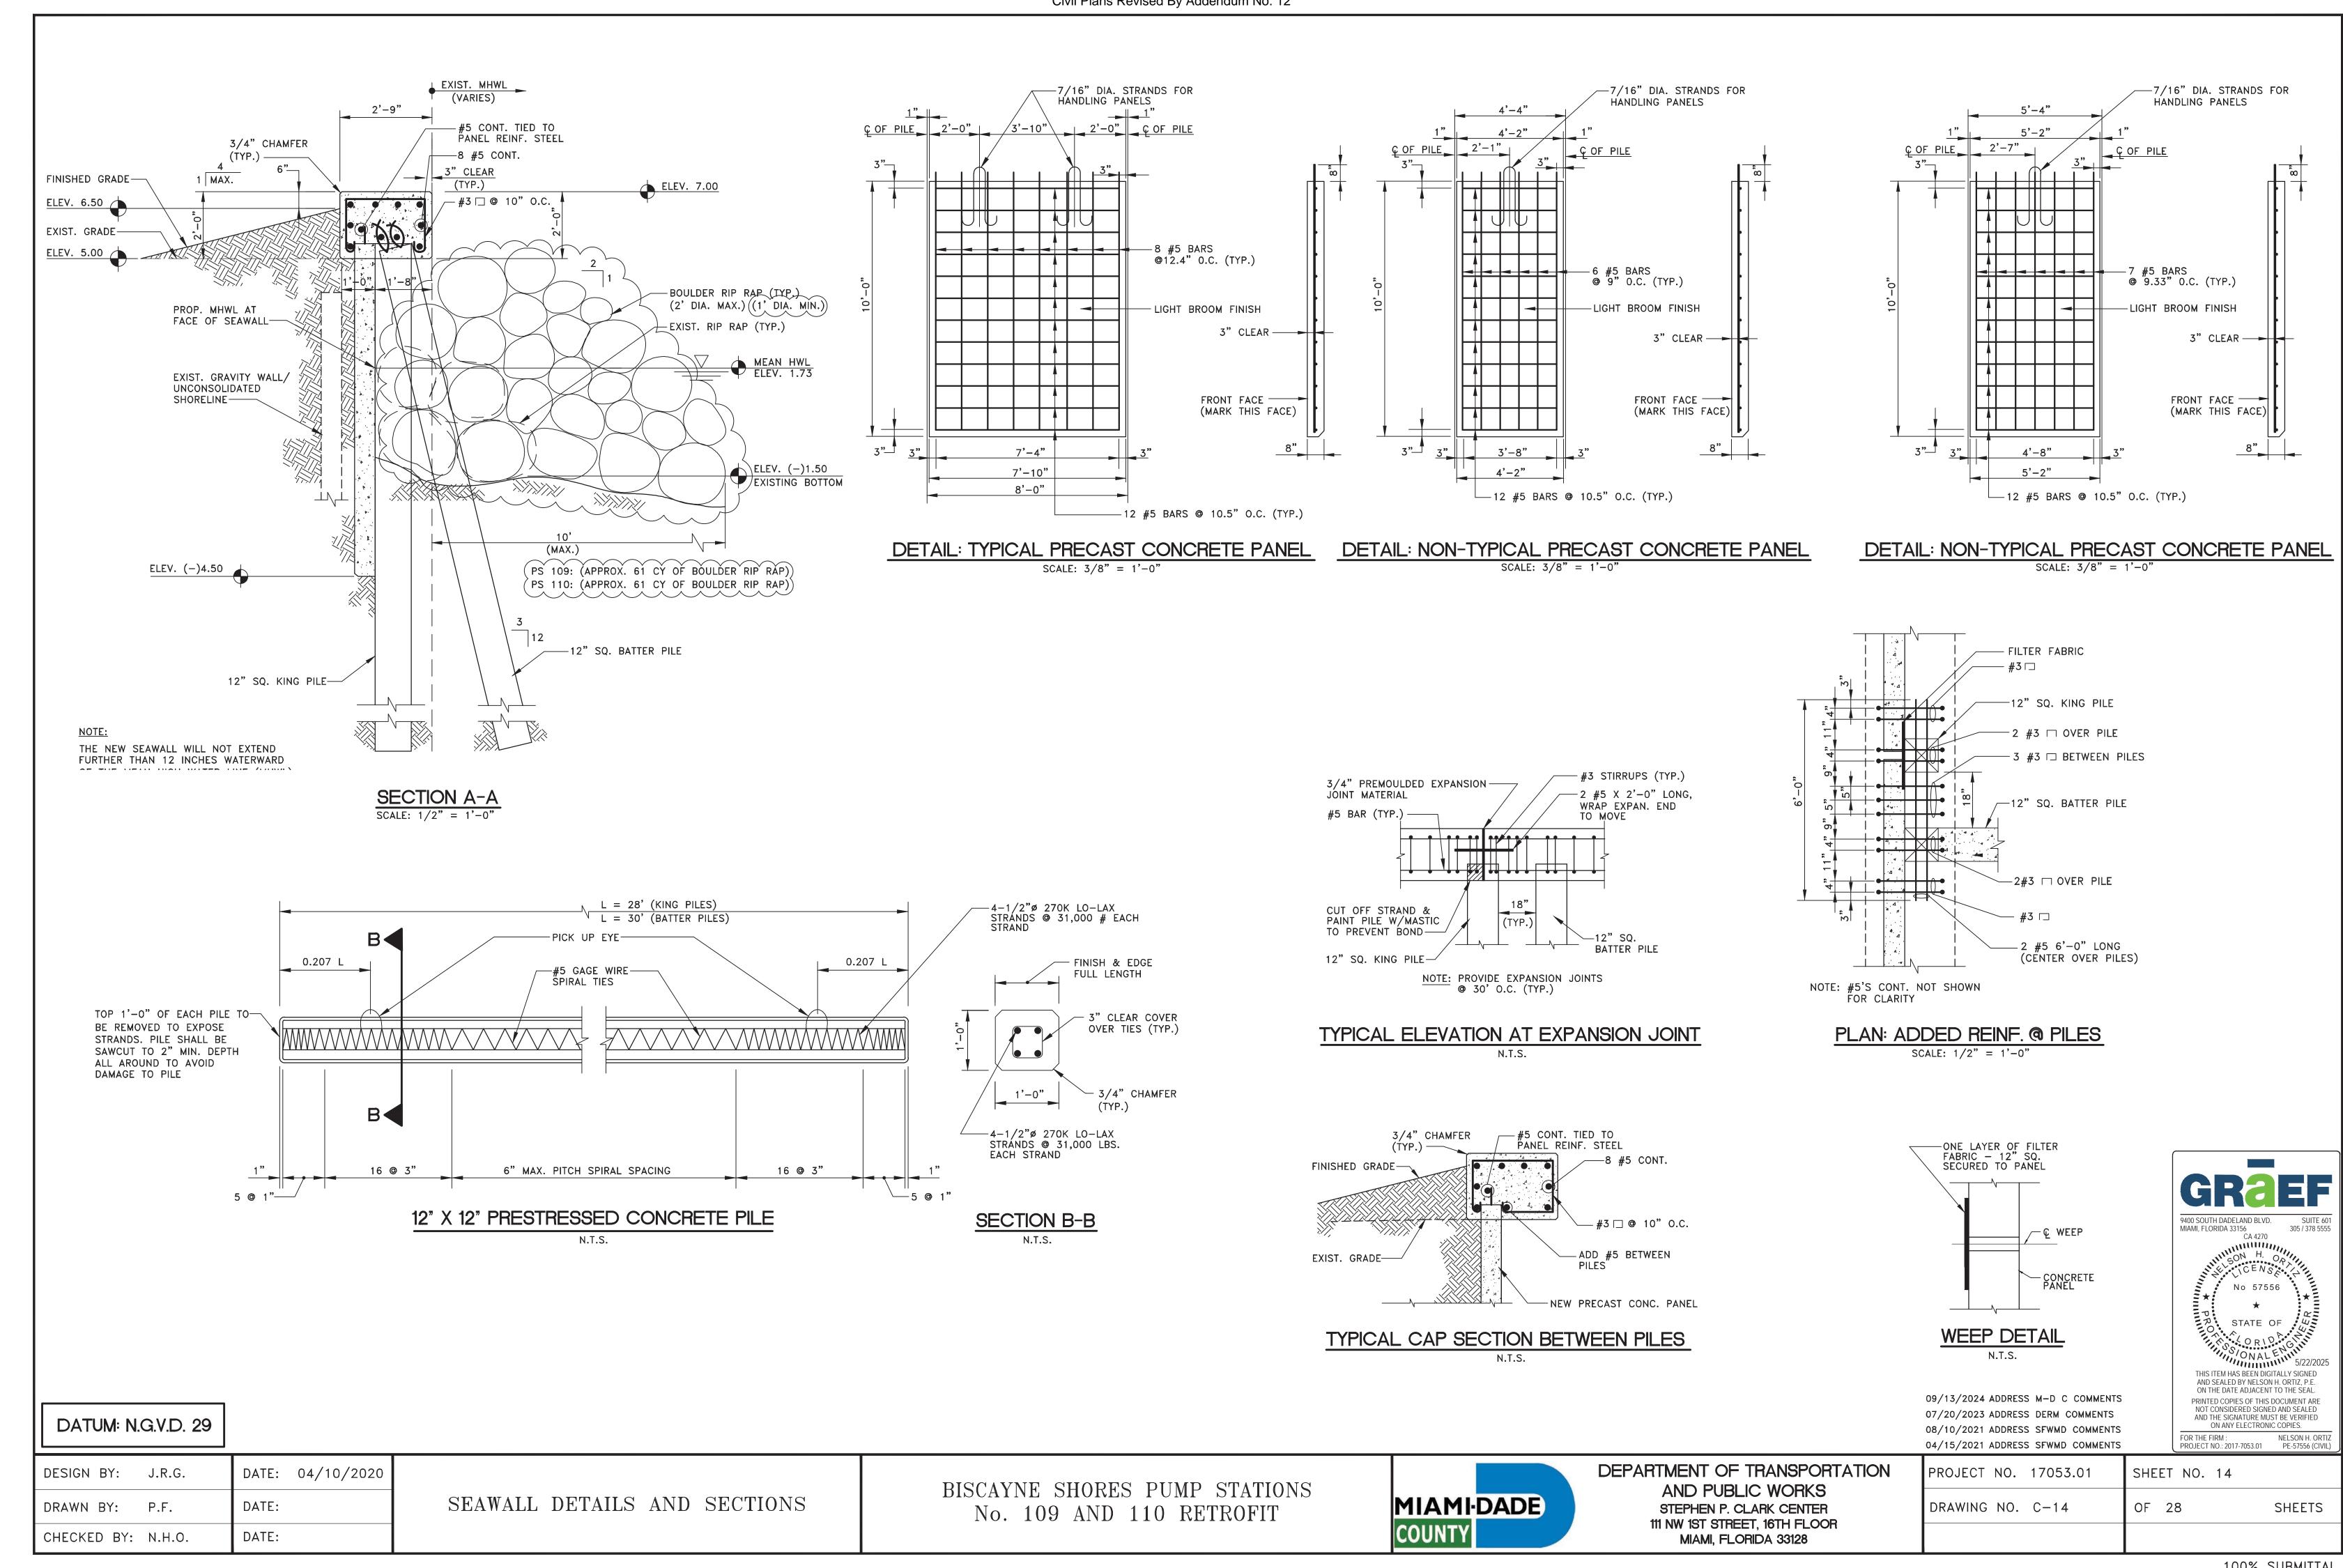


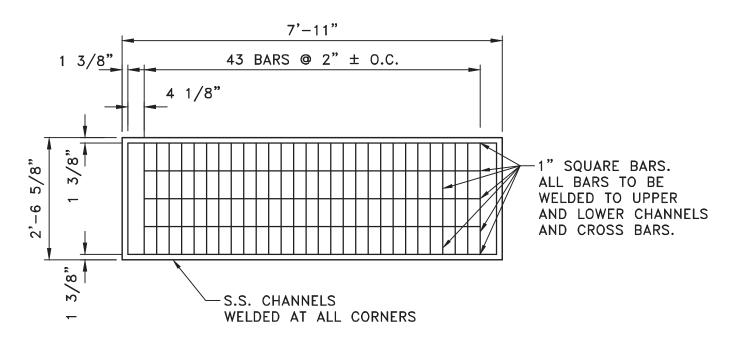


P.S. 109 TRASH RACK DETAIL

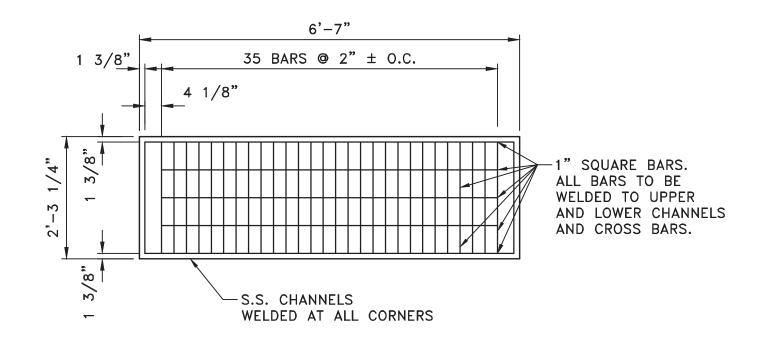


P.S. 110 TRASH RACK DETAIL

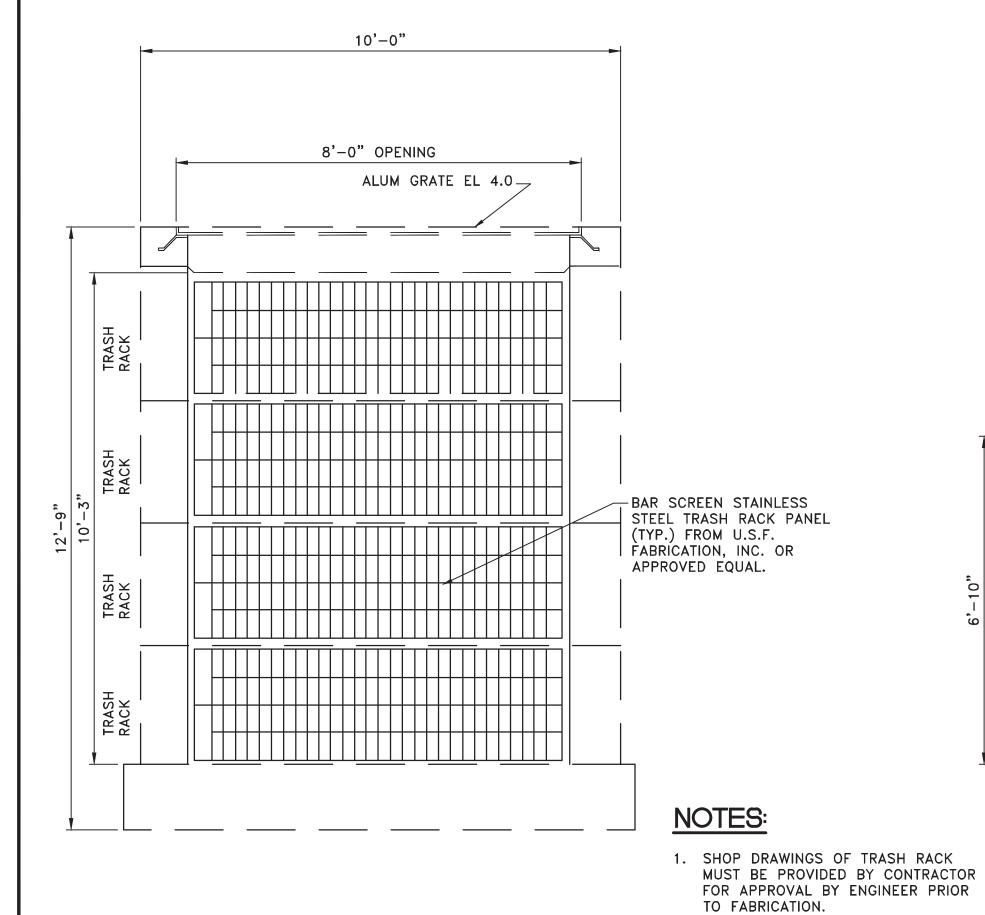


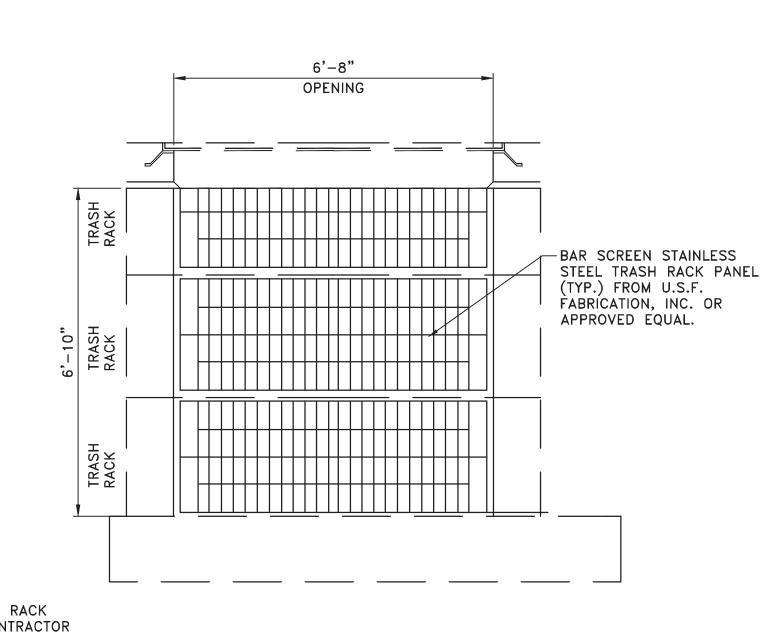


P.S. 110 STAINLESS STEEL TRASH RACK SCALE: 1/2" = 1'

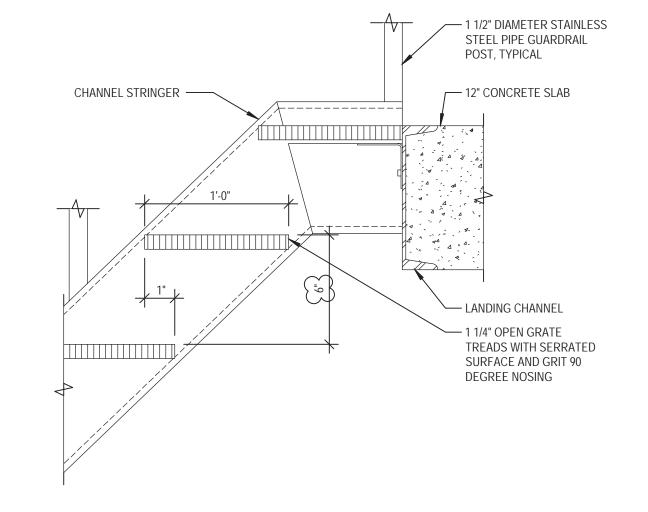

GRATE TREADS WITH OPEN RISERS AT LANDING CONNECTION DETAIL SCALE: 1-1/2" = 1'-0"

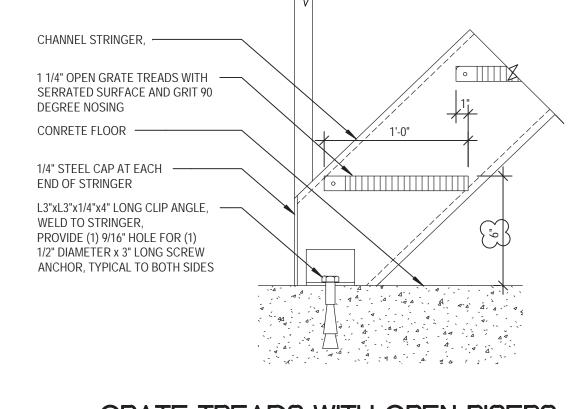

GRATE TREADS WITH OPEN RISERS FLOOR CONNECTION DETAIL SCALE: 1-1/2" = 1'-0"

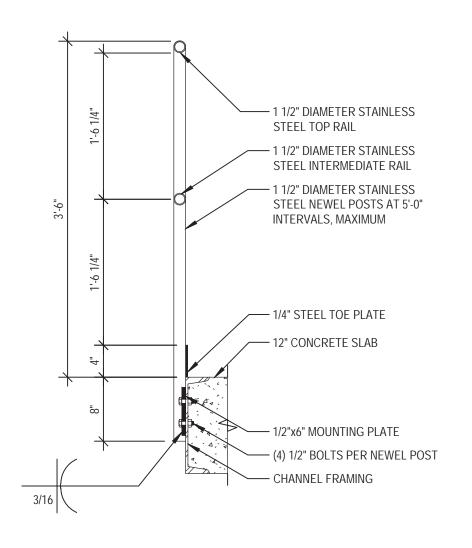



MIAMI-DADE

COUNTY

1 1/2" DIAMETER STAINLESS STEEL PIPE RAIL WITH INTERNAL SPLICE — 1 1/2" DIAMETER STAINLESS STEEL HANDRAIL WITH MOUNTING BRACKET — 1 1/2" DIAMETER STAINLESS STEEL PIPE INTERMEDIATE RAIL WITH INTERNAL SPLICE — 1 1/2" DIAMETER STAINLESS STEEL POSTS AT 6'-0" INTERVALS, MAXIMUM — STAIR STRINGER — 1 1/4" OPEN GRATE TREADS WITH SERRATED SURFACE AND GRIT 90 DEGREE NOSING ----- STAIR STRINGER

STAIR GUARRAIL	AND HANDRAIL	SECTION
OTAIL GOALLIAL	AND HANDINAL	<u>OLOTICIA</u>

SCALE: 1" = 1'-0"

NOTE: CONTRACTOR SHALL PROVIDE

SHOP DRAWINGS FOR FABRICATION.
DEPARTMENT OF TRANSF
AND PUBLIC WOR
STEPHEN P. CLARK CEN
111 NW 1ST STREET, 16TH F

12/17/2024 ADDRESS M-D C COMMENTS 09/13/2024 ADDRESS M-D C COMMENTS

	GRaEF
	9400 SOUTH DADELAND BLVD. SUITE 601 MIAMI, FLORIDA 33156 305 / 378 5555 CA 4270
	CA 4270  CA 4270  CA 4270  CA 4270  No 57556
	* * * * * * * * * * * * * * * * * * *
	STATE OF ORIDAGIAN
<u>1</u>	No 57556  No 57556  No 57556  No STATE OF  ONAL  5/22/2025  THIS ITEM HAS BEEN DIGITALLY SIGNED AND SEALED BY NELSON H. ORTIZ, P.E. ON THE DATE ADJACENT TO THE SEAL.
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	FOR THE FIRM: NELSON H. ORTIZ PROJECT NO.: 2017-7053.01 PE-57556 (CIVIL)

DESIGN BY: J.R.G. DATE: 04/10/2020 DATE: DRAWN BY: P.F.

CHECKED BY: N.H.O.

DATE:

P.S. 109 STAINLESS STEEL TRASH RACK


SCALE: 1/2" = 1'

TRASH INTERCEPTOR DETAILS

BISCAYNE SHORES PUMP STATIONS No. 109 AND 110 RETROFIT

**SPORTATION** RKS FLOOR MIAMI, FLORIDA 33128

• •		
PROJECT NO. 17053.01	SHEET NO. 15	
DRAWING NO. C-15	OF 28	SHEETS

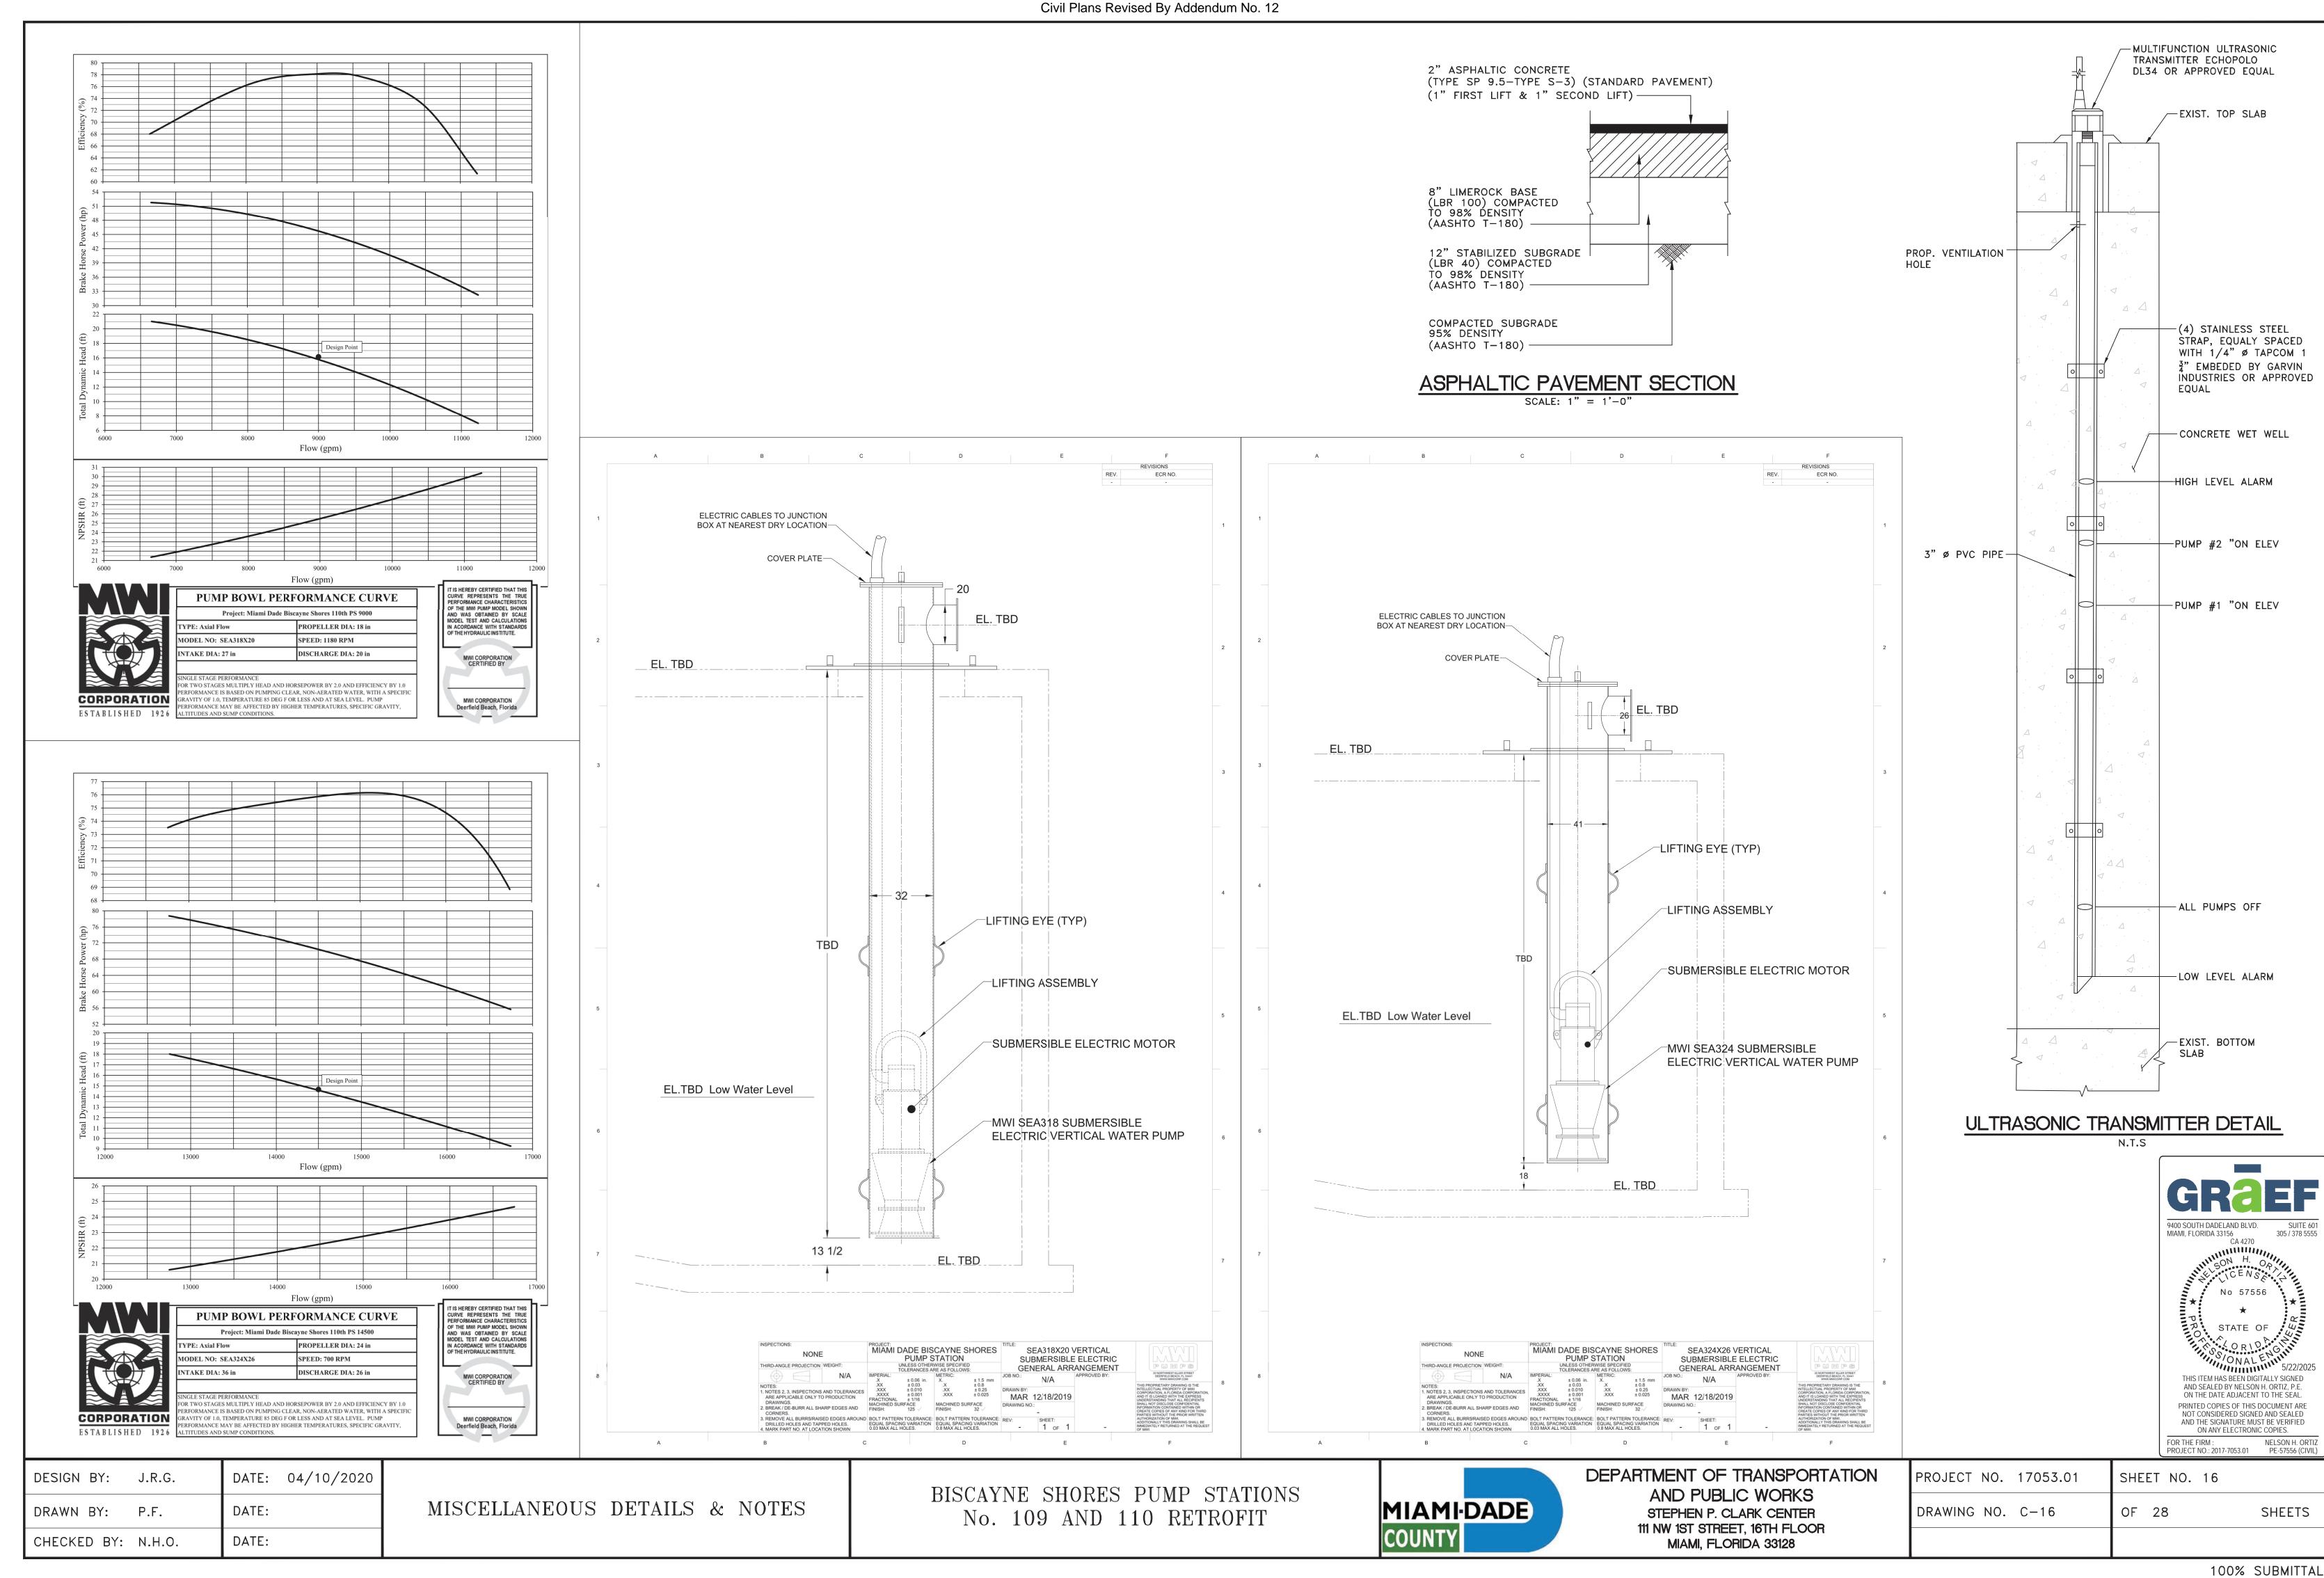

#### A. GENERAL NOTES

ENVIRONMENTAL CONTROL FEATURES AS PROVIDED IN PLANS ARE TO BE INSTALLED AT ALL AREAS OF EXCAVATION OR FILL FOR DRAINAGE SYSTEM OR STRUCTURE CONSTRUCTION PRIOR TO SUCH EXCAVATION OR FILL. INLET ENTRANCES ARE ALSO TO BE PROTECTED FROM SILTATION AS DETAILED IN THE FDOT STANDARDS.

ALL ENVIRONMENTAL CONTROL FEATURES ARE TO BE MAINTAINED THROUGHOUT THE LIFE OF THE PROJECT IN ACCORDANCE WITH FDEP'S NPDES REQUIREMENTS. THE CONTRACTOR MUST ENSURE THAT ALL EROSION CONTROL FEATURES FUNCTION PROPERLY AT ALL TIMES.

ALL EROSION AND MATERIAL DEPOSITS MUST BE CONTAINED WITHIN THE PROJECT LIMITS.

CONTRACTOR'S SUBMITTALS: THE CONTRACTOR IS RESPONSIBLE FOR SUBMITTING THE FOLLOWING ITEMS TO FDEP IN ORDER FOR THE NPDES PERMIT TO BE PROCESSED:

IF THIS SWPPP IS ADOPTED BY THE CONTRACTOR, THE SWPPP SHEETS AND OTHER PLAN SHEETS SHALL BE INCLUDED BY REFERENCE IN THE NOTICE OF INTENT (NOI) SUBMITTAL. THE CONTRACTOR MAY ELECT TO SUBMIT A REVISED SWPPP THAT IS IN COMPLIANCE WITH THE STORM WATER REGULATIONS AT 40 CFR 122.26(B)(14) AND STATE WATER QUALITY STANDARDS. SIGNED CONTRACTOR CERTIFICATION FORMS (2). THESE FORMS MUST BE SIGNED BY BOTH THE PRIME CONTRACTOR AND SUB-CONTRACTOR (IF APPLICABLE) PERFORMING SOIL-DISTURBING ACTIVITIES. HAZARDOUS MATERIAL SPILL CONTROL PLAN.

STAGING AREAS, STOCKPILE LOCATIONS AND STABILIZATION PRACTICES. BRIDGE CONSTRUCTION METHOD AND SEQUENCING (IF APPLICABLE). DEWATERING PLAN (IF APPLICABLE).

NO SOIL DISTURBING ACTIVITIES CAN BE CONDUCTED UNTIL THE NPDES PACKAGE HAS BEEN MAILED TO THE FDEP.

ANY DAMAGED OR INEFFECTIVE BAGS ARE TO BE REPLACED WITH NEW ONES. THE LOCATION OF ROCK BAG INSTALLATION IS AS MENTIONED IN EROSION CONTROL PLANS. THE PROJECT ENGINEER MAY SPECIFY OTHER AREAS AS NECESSARY.

DITCH BOTTOM INLETS SHALL BE PROTECTED FROM SEDIMENT INTAKE UNTIL PROJECT IS COMPLETE. ELEVATION OF GROUND OUTSIDE INLET TOP SHALL NOT BE HIGHER THAN INLET TOP. ROCK BAGS SHALL BE INSTALLED AROUND INLET TOP.

COMPLETED INLETS IN PAVED AREAS SHALL ALSO BE PROTECTED WITH ROCK BAGS TO PREVENT SEDIMENT INTAKE FROM OTHER AREAS.

CURB INLETS ALSO SHALL BE PROTECTED FROM SEDIMENT INTAKE UNTIL THE PROJECT IS COMPLETE. ALL FILL EMBANKMENT AND GRADED AREAS SHALL BE PROTECTED AGAINST EROSION BY METHODS STATED IN "SECTION ID4" FDOT STANDARDS SPECIFICATIONS FOR BRIDGE AND ROAD CONSTRUCTION.

STOCKPILED MATERIALS SHALL NOT BE LEFT IN EROSION PRONE AREAS UNLESS PROTECTED BY COVER AND/OR OTHER APPROPRIATE EROSION CONTROL MEASURES.

INSPECTION OF EROSION CONTROL MEASURES AND CONDITION OF ADJACENT PROPERTIES SHALL BE PERFORMED DAILY BY THE CONTRACTOR'S REPRESENTATIVE AND THE PROJECT ENGINEER. DEFICIENCIES SHALL BE NOTED AND CORRECTED.

ANY OFFSITE SEDIMENT DISCHARGE TO A MUNICIPALLY SEPARATE STORM SEWER SYSTEM ARISING FROM THE CONTRACTOR'S ACTIVITIES SHALL HAVE EROSION CONTROLS PROVIDED FOR THOSE INLETS.

THE AGGREGATE LAYER OF ALL CONSTRUCTION ENTRANCE GRAVEL BEDS MUST BE AT LEAST 6 INCHES THICK. IT MUST EXTEND THE FULL WIDTH OF THE VEHICULAR INGRESS AND EGRESS AREA. THE LENGTH OF THE ENTRANCE MUST BE AT LEAST 50 FEET. THE ENTRANCE MUST WIDEN AT ITS CONNECTION TO THE ROADWAY IN ORDER TO ACCOMMODATE THE TURNING RADIUS OF LARGE TRUCKS.

#### B. <u>SITE DESCRIPTION</u>

1. CONSTRUCTION ACTIVITY:

CLEARING AND DEMOLITION; DRAINAGE AND UTILITY INSTALLATION, NEW BUILDING, LAND DEVELOPMENT.

MIAMI-DADE COUNTY PS 109 AND 110 LOCATED IN BISCAYNE SHORES BETWEEN N. BAYSHORE DRIVE AND BISCAYNE BAY.

PROJECT DESCRIPTION:

REPLACE EXISTING PUMPS AT PS 110 AND DISCONNECT ELECTRIC DEPENDANCY AT PS 109 FROM PS 110. SEAWALL REPLACEMENT AT BOTH SITES WITH CONCRETE PILE AND PANEL AND INSTALLATION OF NEW DISSIPATOR STRUCTURES. CONSTRUCTION OF NEW GENERATOR HOUSE AND REPLACEMENT OF ROOF AND FLOOR OF EXISTING PUMP HOUSE.

2. MAJOR SOIL DISTURBING ACTIVITIES:

DEMOLITION; CLEARING; EXCAVATION FOR STORMWATER FACILITIES, PARKING, AND OTHER UTILITIES.

3. TOTAL PROJECT AREA: 0.324 ACRES

TOTAL AREA TO BE DISTURBED: 0.324 ACRES

4. LOCATIONS OF DRAINAGE AREAS AND OUTFALLS: SEE ATTACHED PLAN.

5. THE DRAINAGE SYSTEM RECEIVING WATER IN THE EVENT OF A MAJOR STORM EVENT WILL BE BISCAYNE BAY AT LATITUDE AND LONGITUDE 25°52'37.0"N / 80°09'50.0"W AND 25°52'34.2"N / 80°09'50.2"W.

6. AREA OF DISCHARGE FOR THIS PROJECT IS ACRES = 14,424 SF

7. SOILS ARE CLASSIFIED AS URBAN LAND AND QUALITY OF DISCHARGE IS LIMEROCK FILL AND SAND.

8. LATITUDE AND LONGITUDE OF DIRECT DISCHARGE POINTS ARE 25°52'37.0"N / 80°09'50.0"W AND 25°52'34.2"N / 80°09'50.2"W.

#### C. CONTROLS

NARRATIVE - SEQUENCE OF SOIL DISTURBING ACTIVITIES AND IMPLEMENTATION OF CONTROLS.

- CLEARING AND DEMOLITION
- 2. CONSTRUCTION OF REPLACEMENT SEAWALL AT PS 109 AND PS 110.
- 3. REPLACEMENT OF PUMPS AT PS 110.
- 4. CONSTRUCTION OF NEW GENERATOR HOUSE.
- 5. REPLACEMENT OF FLOOR AND ROOF OF EXISTING PUMP HOUSE.

PRIOR TO COMMENCEMENT OF CONSTRUCTION ACTIVITIES, ALL EROSION CONTROLS MUST BE IMPLEMENTED.

1. TEMPORARY STABILIZATION:

DISTURBED PORTIONS OF THE SITE (E.G. EMBANKMENT AT TEMPORARY RAMPS) WHERE CONSTRUCTION ACTIVITY CEASES FOR AT LEAST 21 DAYS, SHALL BE STABILIZED WITH TEMPORARY SOD OR TEMPORARY SEEDING AND MULCHING NO LATER THAN 14 DAYS FROM THE LAST CONSTRUCTION ACTIVITY IN THAT AREA.

PERMANENT STABILIZATION: DISTURBED PORTIONS OF THE SITE WHERE CONSTRUCTION ACTIVITY PERMANENTLY CEASES SHALL BE STABILIZED WITH SOD NO LATER THAN 14 DAYS AFTER THE LAST CONSTRUCTION ACTIVITY.

EROSION AND SEDIMENT CONTROLS:

(1) STABILIZATION PRACTICES: TEMPORARY SODDING TEMPORARY GRASSING \_ PERMANENT SODDING, SEEDING OR SEED & MULCH TEMPORARY MULCHING ARTIFICIAL COVERING BUFFER ZONES PRESERVATION OF NATURAL RESOURCES

#### OTHER:

(2) STRUCTURAL PRACTICES: SAND BAGGING

X SILT FENCES ROCK BAGS BERMS

DIVERSION, INTERCEPTOR, OR PERIMETER DITCHES PIPE SLOPE DRAINS

FLUMES \_ ROCK BEDDING AT CONSTRUCTION EXIT

TIMBER BEDDING AT CONSTRUCTION EXIT DITCH LINER

SEDIMENT TRAPS SEDIMENT BASINS

RIP RAP

X STORM INLET SEDIMENT TRAP STONE OUTLET STRUCTURES

CURBS AND GUTTERS \_\_\_\_X\_\_ STORM SEWERS VELOCITY CONTROL DEVICES X TURBIDITY BARRIER

2. DESCRIPTION OF STORM WATER MANAGEMENT:

THE STORMWATER MANAGEMENT SYSTEM CONSISTS OF RAINWATER LEADERS THAT CONVEY STORMWATER INTO CATCH BASINS, AND EXFILTRATION TRENCHES THAT TREAT THE WATER QUALITY REQUIREMENTS.

OTHER CONTROLS

(1) WASTE DISPOSAL: IN APPROVED OFFSITE AREAS PROVIDED BY THE CONTRACTOR.

(2) OFFSITE VEHICLE TRACKING:

\_\_\_\_X\_\_ HAUL ROADS DAMPENED FOR DUST CONTROL X LOADED HAUL TRUCKS TO BE COVERED WITH TARPAULIN

X EXCESS DIRT ON ROAD REMOVED DAILY X STABILIZED CONSTRUCTION ENTRANCE

#### 3. OTHER:

(1) SANITARY WASTE: ALL SANITARY WASTE WILL BE COLLECTED FROM THE PORTABLE UNITS AS NECESSARY OR AS

REQUIRED BY LOCAL REGULATION OF A LICENSED SANITARY WASTE MANAGEMENT CONTRACTOR. (2) FERTILIZERS AND PESTICIDES: FERTILIZER TO BE APPLIED ONLY IN THE MINIMUM AMOUNTS RECOMMENDED BY THE MANUFACTURER. ONCE APPLIED, FERTILIZER WILL BE WORKED INTO THE SOIL TO LIMIT EXPOSURE TO STORMWATER. IF STORED ON-SITE, STORAGE WILL BE IN COVERED SHED. THE CONTENT OF ANY PARTIALLY USED BAGS OF FERTILIZER WILL BE TRANSFERRED TO A SEPARATE PLASTIC BIN TO AVOID SPILLS.

(3) NON-STORM WATER DISCHARGE (INCLUDING SPILL REPORTING) THE CONTRACTOR IS RESPONSIBLE FOR REPORTING SPILLS TO MIAMI-DADE COUNTY DEPARTMENT OF REGULATORY AND ECONOMIC RESOURCES (RER). DEWATERING IS NOT ANTICIPATED.

#### 4. REMARKS:

IF CONTAMINATED SOIL OR GROUNDWATER IS ENCOUNTERED OR HAZARDOUS SPILLS OCCUR DURING CONSTRUCTION THE MIAMI-DADE COUNTY DEPARTMENT OF REGULATORY AND ECONOMIC RESOURCES (RER) SHALL BE CONTACTED AT THEIR HOTLINE: (305) 372-6955.

APPROVED STATE, LOCAL PLANS, OR STORM WATER PERMITS: MIAMI-DADE COUNTY BUILDING DEPARTMENT, MIAMI-DADE COUNTY DEPARTMENT OF TRANSPORTATION AND PUBLIC WORKS AND MIAMI-DADE COUNTY RER.

#### D. MAINTENANCE

CONSTRUCTION ENTRANCE

SILT FENCE

ALL CONTROLS SHALL BE MAINTAINED IN PROPER WORKING ORDER AT ALL TIMES

DURING CONSTRUCTION. IF A REPAIR IS NECESSARY, IT WILL BE INITIATED WITHIN 24 HOURS OF BEING NOTED IN CONTRACTOR'S DAILY INSPECTION REPORT.

WHEN THE CONSTRUCTION ENTRANCE GRAVEL BEDS BECOME LOADED WITH


SEDIMENTS, REWORK BEDS TO DISPLACE SEDIMENT LOAD AND RE-ESTABLISH EFFECTIVENESS OF THE GRAVEL BEDS.


ALL CONTROLS SHALL BE MAINTAINED IN PROPER WORKING ORDER AT ALL TIMES

DURING CONSTRUCTION. IF A REPAIR IS NECESSARY, IT WILL BE INITIATED WITHIN 24 HOURS OF BEING NOTED IN CONTRACTOR'S DAILY INSPECTION REPORT.

#### E. <u>INSPECTION</u>

THE CONTRACTOR SHALL INSPECT ALL EROSION CONTROL FEATURES AT LEAST ONCE EVERY SEVEN CALENDAR DAYS AND WITHIN 24 HOURS OF THE END OF A STORM OF 0.5" OR GREATER. IN ADDITION, A DAILY REVIEW OF THE LOCATION OF SILT FENCES SHALL BE MADE IN AREAS WHERE CONSTRUCTION ACTIVITIES HAVE CHANGED THE NATURAL CONTOUR AND DRAINAGE RUNOFF. IN ORDER TO INSURE THAT SILT FENCES AND OTHER EROSION CONTROL DEVICES ARE PROPERLY LOCATED FOR EFFECTIVENESS. A FORM ACCEPTABLE TO THE FDEP WILL BE USED TO REPORT ALL INSPECTION FINDINGS AND CORRECTIVE ACTIONS TAKEN AS A RESULT OF THE INSPECTION. EACH INSPECTION REPORT SHALL BE SIGNED AND SUBMITTED WEEKLY TO THE PROJECT ENGINEER. IF A REPAIR IS NECESSARY, IT WILL BE INITIATED WITHIN 24 HOURS OF BEING NOTED IN CONTRACTOR'S INSPECTION REPORT.

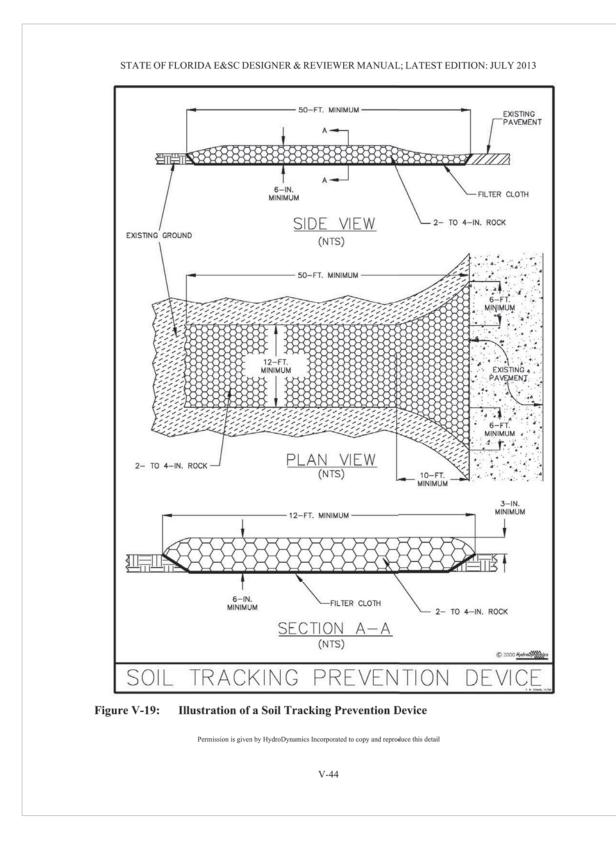

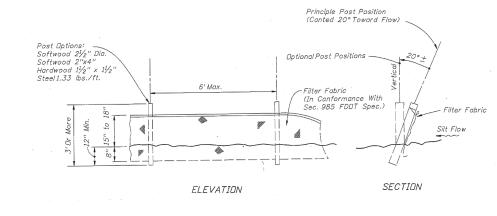

TYPE III SILT FENCE DETAIL (FDOT INDEX 102)



DESIGN BY:	J.R.G.	DATE:	04/10/202
DRAWN BY:	P.F.	DATE:	
CHECKED BY:	N.H.O.	DATE:	


STORMWATER POLLUTION PREVENTION PLAN DETAILS AND NOTES


BISCAYNE SHORES PUMP STATIONS No. 109 AND 110 RETROFIT




DEPARTMENT OF TRANSPORTATION AND PUBLIC WORKS STEPHEN P. CLARK CENTER 111 NW 1ST STREET, 16TH FLOOR MIAMI, FLORIDA 33128

PROJECT NO. 17053.01	SHEET NO. 17	
DRAWING NO. C-17	OF 28	SHEETS

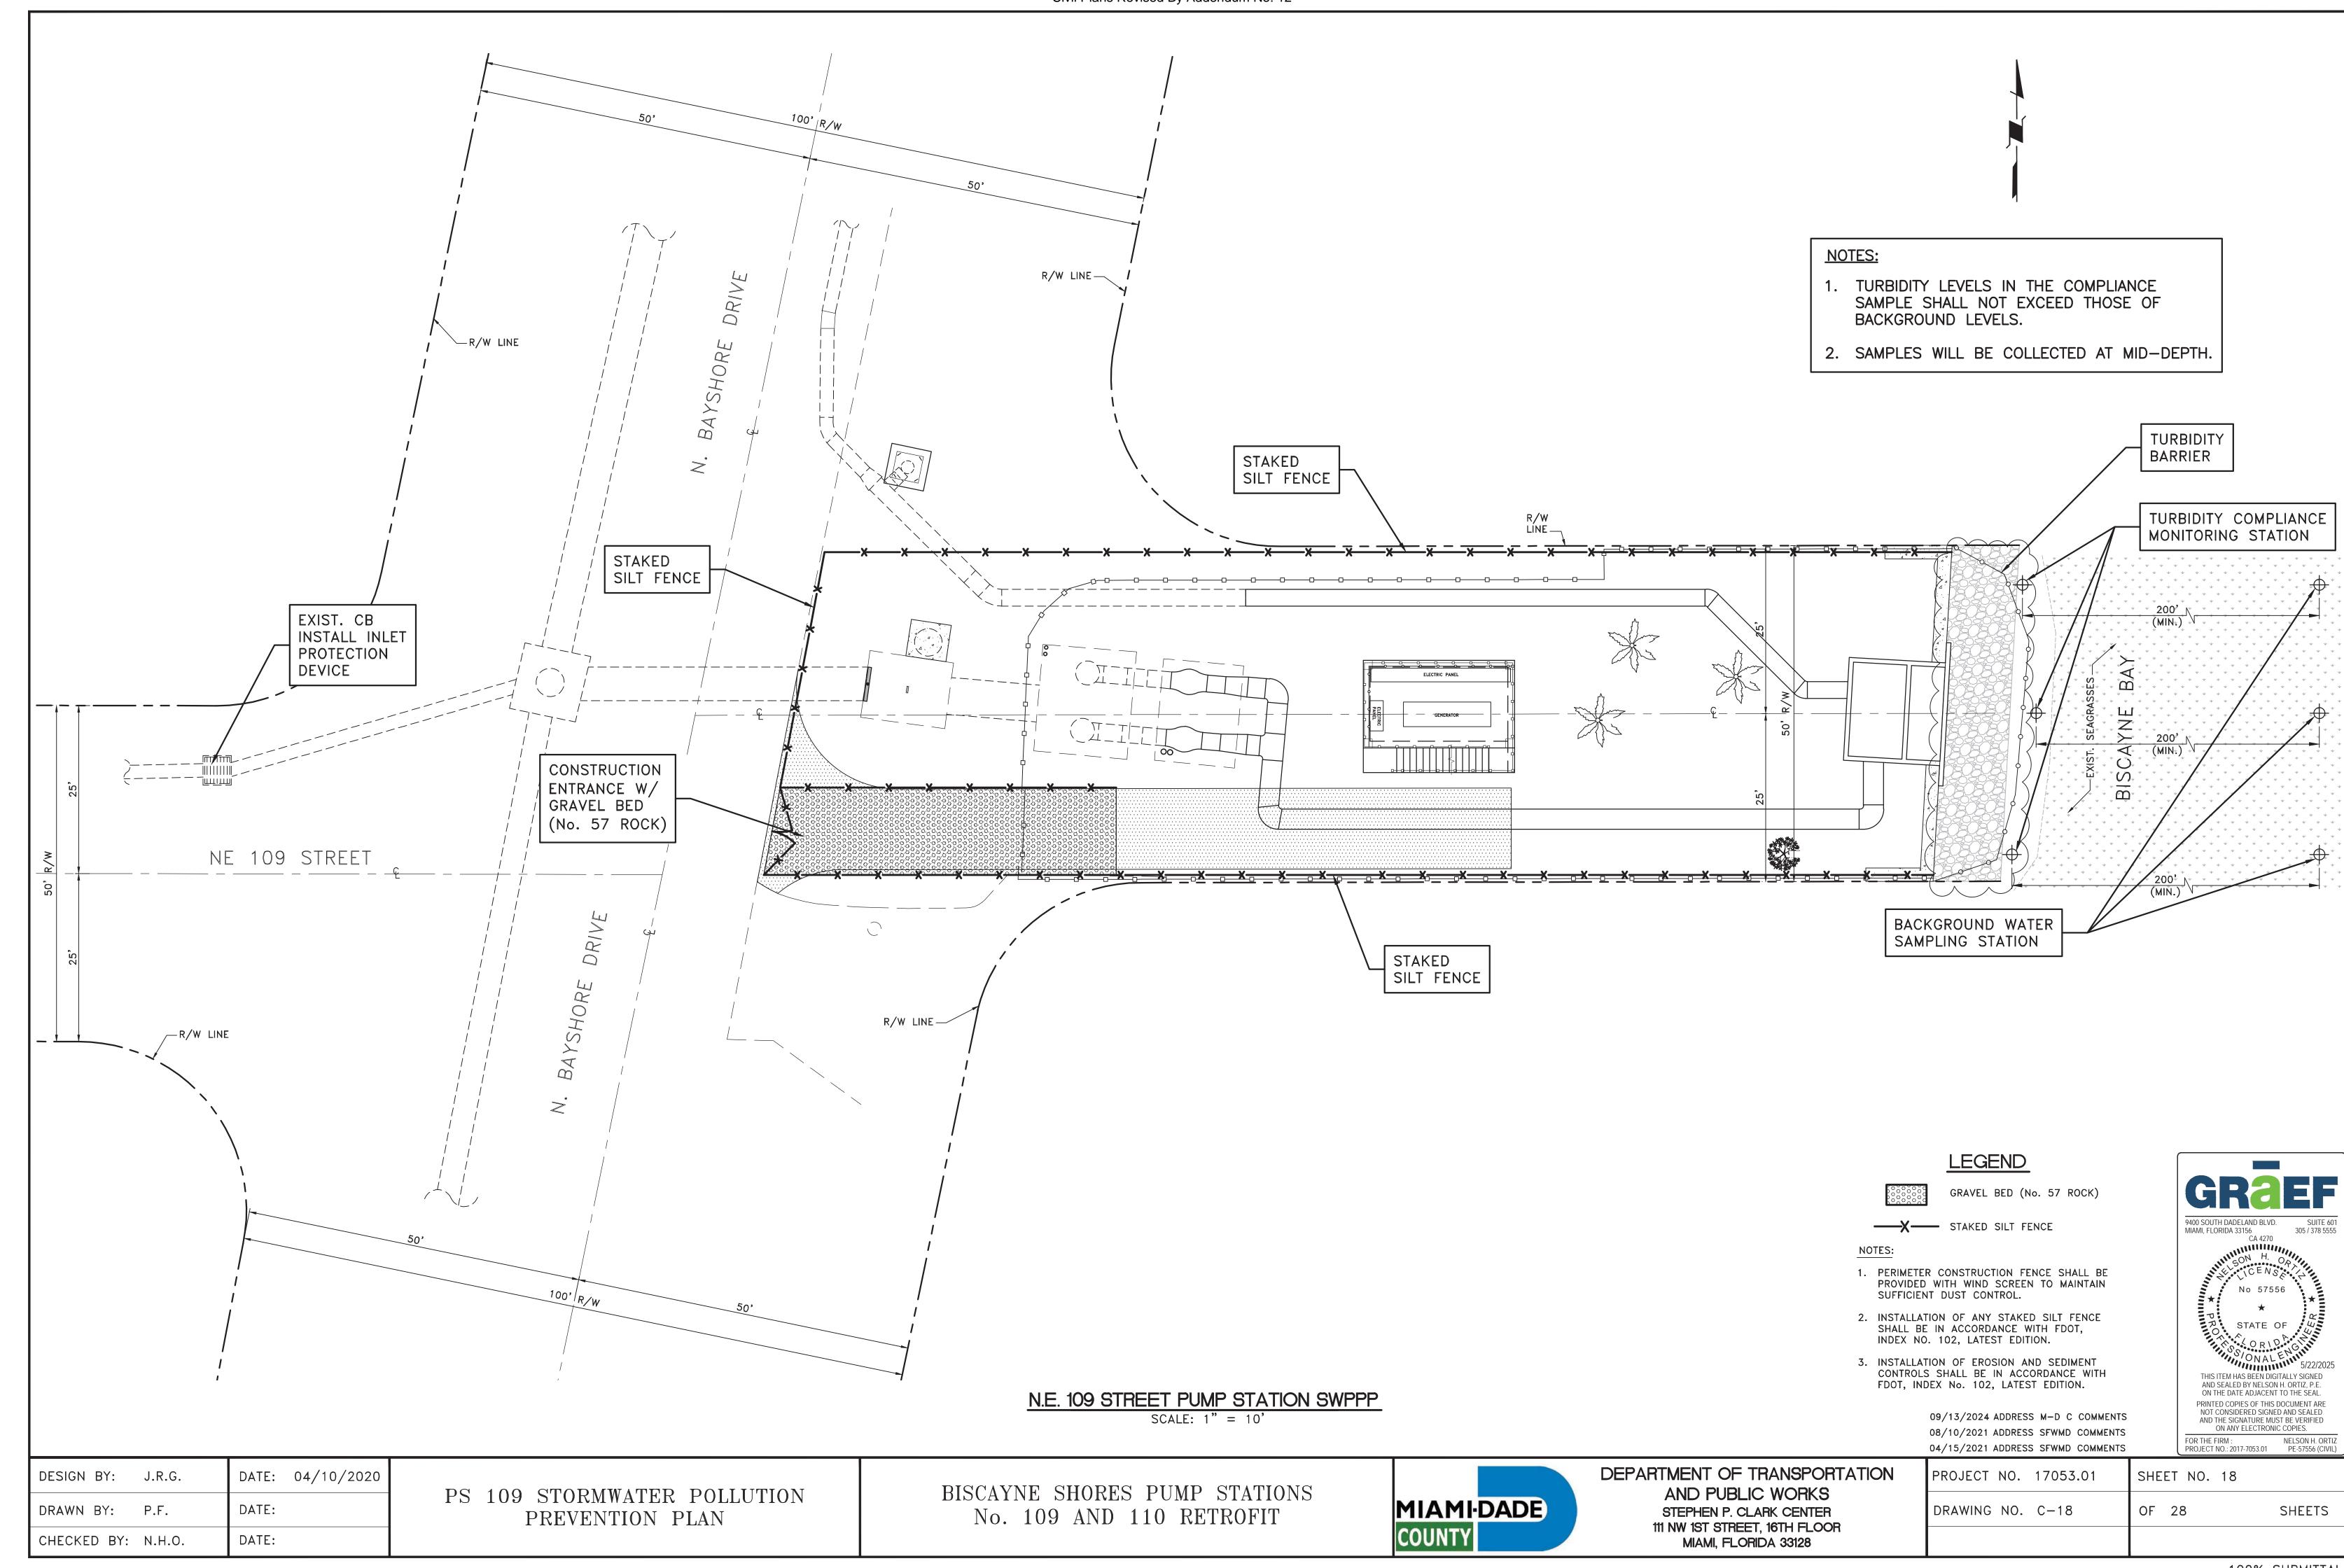

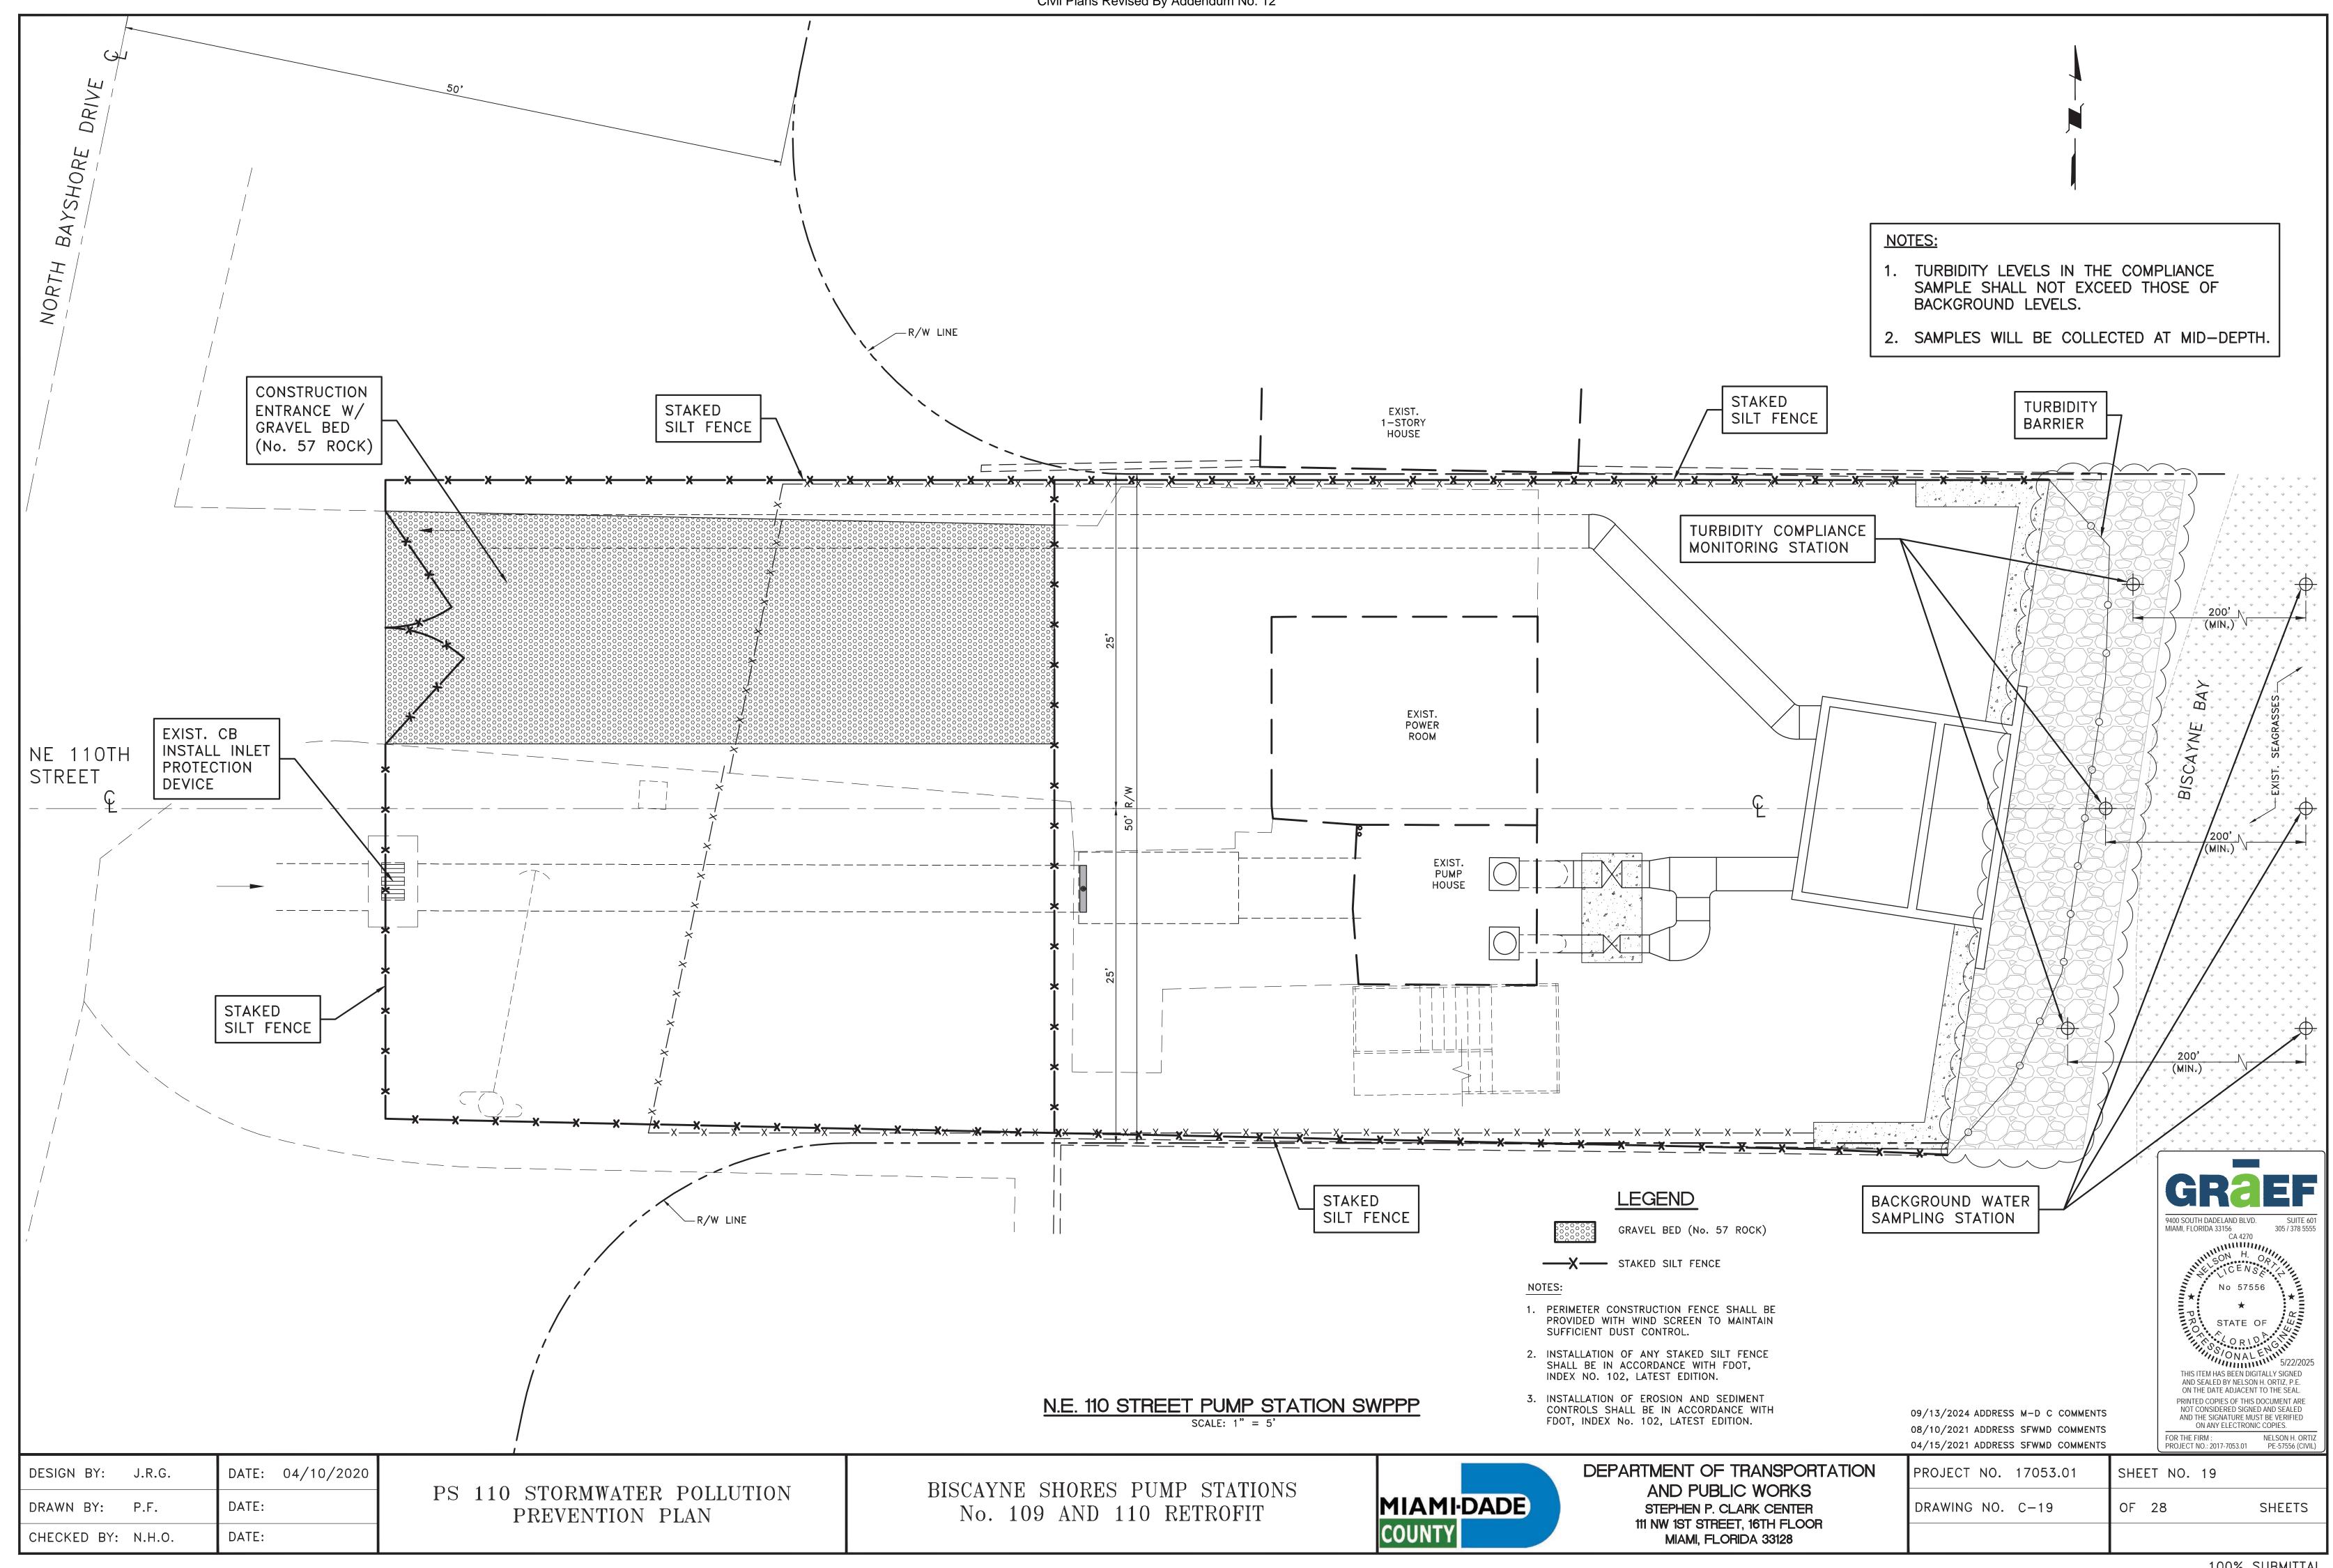

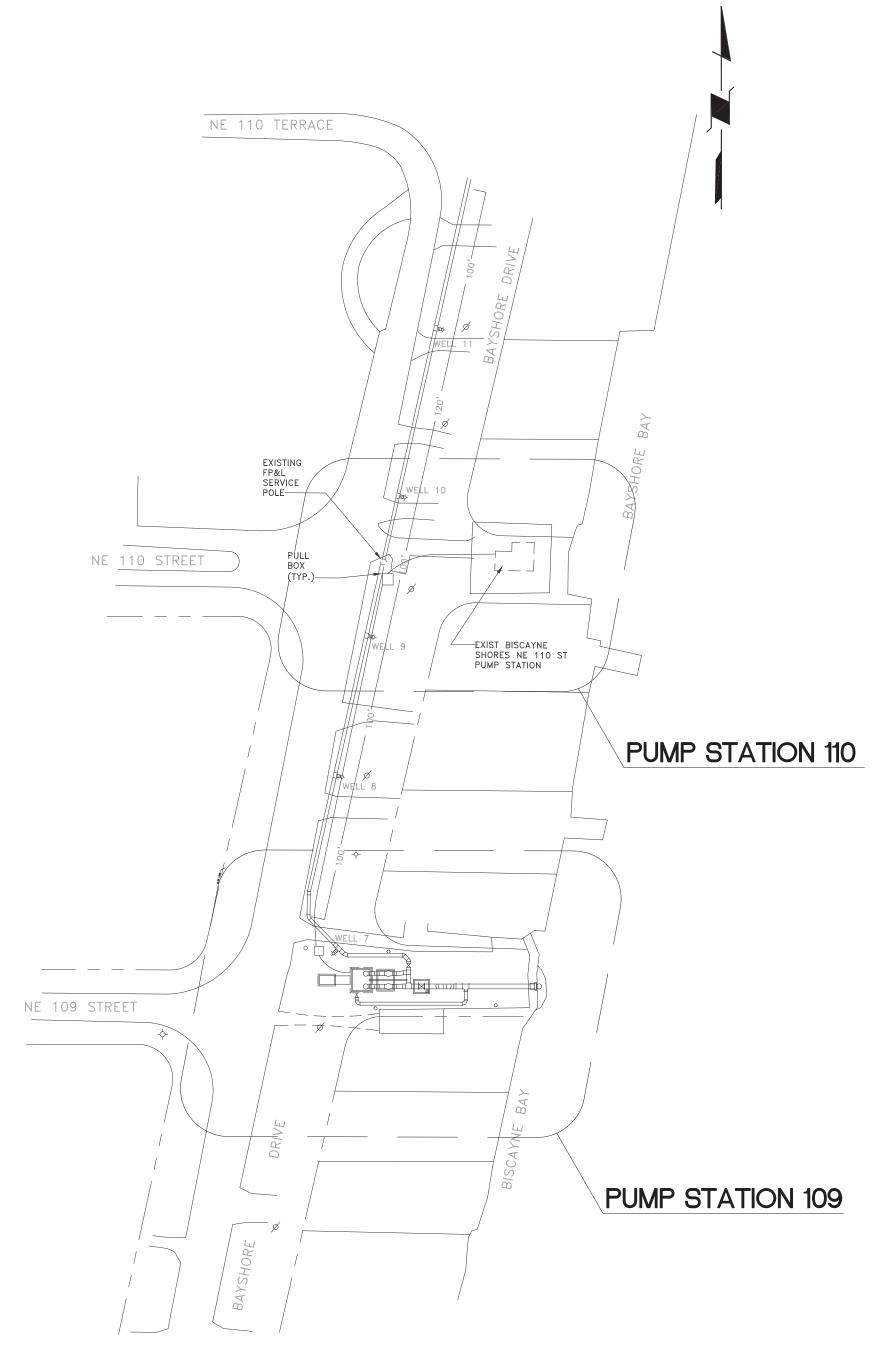

# SITE LOCATION PLAN

SCALE: NONE

# GENERAL DEMOLITION NOTES

- 1. PROVIDE ELECTRICAL DEMOLITION WORK NECESSARY TO INSTALL NEW WORK. ELECTRICAL CONTRACTOR SHALL RE-ROUTE AND RECONNECT ANY CIRCUITS THAT REMAIN IN USE BUT INTERFERE WITH NEW CONSTRUCTION.
- 2. MAINTAIN CONTINUITY OF ALL EXISTING CIRCUITS TO REMAIN OR PORTIONS THEREOF AFFECTED BY NEW WORK.
- 3. ALL MATERIALS REMOVED UNDER DEMOLITION, AND NOT TO BE RE-USED OR NOT TO BE RELOCATED, SHALL BECOME THE PROPERTY OF THE CONTRACTOR AND SHALL BE REMOVED COMPLETELY FROM THE SITE.
- 4. CONTRACTOR SHALL EXERCISE CARE IN REMOVING DEMOLITION ITEMS AND SHALL REPAIR OR REPLACE AT HIS COST ANY DAMAGE CAUSED TO EXISTING CONSTRUCTION AND EQUIPMENT TO REMAIN.
- 5. DRAWINGS ARE BASED ON EXISTING PLANS AND FIELD INVESTIGATION WITHOUT DEMOLITION. CONTRACTOR SHALL VISIT THE SITE AND FAMILIARIZE HIMSELF WITH EXISTING CONDITIONS AND SHALL EXAMINE ALL RELATED DRAWINGS TO AVOID CONFLICTS. FAILURE TO REVIEW ALL CONTRACT DOCUMENTS AND/OR VISIT THE SITE WILL NOT RELIEVE THE CONTRACTOR OF HIS RESPONSIBILITY TO PERFORM ALL WORK REQUIRED AT NO ADDITIONAL COST TO THE OWNER.

# GENERAL ELECTRICAL NOTES

- ALL WORK SHALL BE IN ACCORDANCE WITH THE CURRENT ADOPTED EDITION OF THE NATIONAL ELECTRICAL CODE, FLORIDA BUILDING CODE AND OTHER APPLICABLE CODES, ORDINANCES AND STANDARDS.
- 2. IT IS THE CONTRACTORS RESPONSIBILITY TO BE FULLY COGNIZANT WITH ALL CODE SECTIONS AS THEY APPLY TO THE WORK/INSTALLATION AT HAND WHETHER OR NOT SHOWN ON THE DRAWINGS BUT REQUIRED BY CODE. IF ANY DISCREPANCY ARISÉS BETWEEN ANY DESIGN ISSUES AND CODE REQUIREMENTS, CONTRACTOR MUST ADHERE TO THE MOST STRINGENT
- THE DRAWINGS ARE DIAGRAMMATIC AND DO NOT SHOW ALL OFFSETS, BENDS AND BOXES REQUIRED TO MAKE A COMPLETE INSTALLATION IN ACCORDANCE WITH THE NEC.
- IF CONFLICTS ARISE IN LOCATING WIRING DEVICES, ELECTRICAL EQUIPMENT, DISCONNECTS, PANELBOARDS, OR OTHER MISCELLANEOUS ELECTRICAL EQUIPMENT, DUE TO FIELD CONDITION OR IMPROPER FIELD COORDINATION, THEN THE CONTRACTOR SHALL BRING THE ISSUE TO THE A/E FOR RESOLUTION, AND SHALL RELOCATE THE ITEM AT NO EXTRA COST TO THE OWNER.
- THE CONTRACTOR SHALL EVALUATE FIELD CONDITIONS BY VISITING THE SITE PRIOR TO BIDDING/STARTING WORK. THE CONTRACTOR SHALL COORDINATE HIS WORK WITH ALL TRADES PRIOR TO ROUGH-IN.
- CONTRACTOR SHALL FURNISH AND INSTALLING ALL ELECTRICAL SYSTEMS EQUIPMENT, COMPONENTS, MATERIALS AND CONTROLS FOR A COMPLETE WORKING SYSTEM IN ACCORDANCE WITH APPLICABLE CODES AND EQUIPMENT/SYSTEM MANUFACTURER RECOMMENDATIONS.
- THE CONTRACTOR SHALL SATISFACTORILY REPAIR/REPLACE EQUIPMENT OR PART OF STRUCTURE DAMAGED AS A RESULT OF HIS WORK. SURFACES AND FINISHED AREAS SHALL BE RESTORED TO MATCH ADJACENT AREAS.
- APPROVAL SHALL BE OBTAINED FROM THE ARCHITECT/STRUCTURAL ENGINEER, IN WRITING, PRIOR TO CUTTING OR DRILLING ANY STRUCTURAL SUPPORT MEMBER.
- NOT USED.
- ALL DEVICES INSTALLED OUTDOORS TO HAVE WEATHERPROOF COVERS.
- 8. WIRE SIZE SHALL BE 12 AWG THHN/THWN UNLESS OTHERWISE NOTED ON PLANS. CONDUCTORS 6 AWG AND LARGER SHALL
- 9. ALL CONDUCTORS SHALL BE COPPER.
- 10. ALL CONDUCTORS SHALL BE RUN IN PVC CONDUIT. AN EQUIPMENT GROUND CONDUCTOR SIZED IN ACCORDANCE WITH NEC 250-122 SHALL BE RUN WITH ALL FEEDERS AND BRANCH CIRCUITS. EXPOSED EXTERIOR CONDUIT SHALL BE SCHEDULE 80 PVC WITH COMPATIBLE FITTINGS.
- 11. ALL MATERIALS SHALL BE U.L. LISTED.
- TYPEWRITTEN PANEL DIRECTORIES, REFLECTING WORK PERFORMED, SHALL BE FURNISHED AFTER JOB IS COMPLETED. THIS APPLIES TO NEW AND EXISTING PANELBOARDS.
- 13. PANELBOARDS SHALL BE PROPERLY PHASE BALANCED.
- 14. CONTRACTOR SHALL SEAL ALL OPENINGS WITH AN APPROVED FIRE SEAL SIMILAR TO 'OZ' FLAMESEAL.
- 15. ALL BRANCH CIRCUITS TO HAVE A GREEN INSULATION EQUIPMENT GROUNDING CONDUCTOR SIZED PER NEC 250.122.
- 16. ALL EMPTY CONDUITS TO BE PROVIDED WITH NYLON PULL STRING. EXPOSED CONDUIT SHALL BE RUN PERPENDICULAR (PLUMB) TO BUILDING CONSTRUCTION LINES.
- 17. FUSES SHALL BE DUAL ELEMENT, TIME DELAY TYPE UNLESS OTHERWISE NOTED.
- 18. RISERS ARE DIAGRAMMATIC IN NATURE AND DO NOT SHOW EVERY BEND, OFFSET, OR ELBOW REQUIRED FOR THE INSTALLATION.
- ALL WIRING SHALL BE RUN WITHOUT SPLICES EXCEPT AS OTHERWISE INDICATED.
- ALL PULL AND JUNCTION BOXES SHALL BE ACCESSIBLE AT COMPLETION OF WORK.
- 21. EXACT POINT AND METHODS OF CONNECTION SHALL BE DETERMINED IN FIELD.
- 22. ALL WORK SHALL BE PERFORMED IN A NEAT AND WORKMANLIKE MANNER IN ACCORDANCE WITH NECA. NEMA AND THE NEC.
- 23. BRANCH CIRCUIT BREAKERS SHALL BE OF THE BOLT-ON TYPE. PLUG-IN CIRCUIT BREAKERS WILL NOT BE ACCEPTED.
- 24. ELECTRICAL SYSTEM CONDUCTOR COLOR CODE SHALL BE AS FOLLOWS OR AS DIRECTED BY MIAMI-DADE:

	208Y/120V-3ø-4W SYSTEM	480Y/277V-3ø-4W
PHASE 'A'	BLACK	ORANGE
PHASE 'B'	RED	BROWN
PHASE 'C'	BLUE	PURPLE
NEUTRAL	WHITE	GRAY
GROUND	GREEN	GREEN W/YELLOW STRIPE

- 25. ALL ROUGH—IN DIMENSIONS ARE TO CENTER LINE OF DEVICE UNLESS OTHERWISE NOTED
- 26. ALL CONDUCTOR SPLICES IN EXTERIOR LOCATED JUNCTION/PULL BOXES EXPOSED TO THE WEATHER SHALL BE WEATHER SEALED WITH AN APPROVED METHOD SUCH AS 3M SCOTCHLOCK CONNECTOR EPOXY SEALING PACKS OR SIMILAR.
- WHEN ITEMS ARE REQUIRED BY LOCAL, STATE OR NATIONAL CODES, CONTRACTOR SHALL INCLUDE THEM WHETHER SHOWN ON THE DRAWINGS OR NOT.


#### DRAWING INDEX

- E-O SITE LOCATION, LEGEND AND NOTES
- E-1 PS 110 EXISTING SITE CONDITIONS / DEMOLITION PLAN
- E-2 PUMP STATION 110 ELECTRICAL DEMOLITION PLAN
- E-3 PUMP STATION 110 ELECTRICAL NEW WORK PLAN
- E-4 PUMP STATION 109 SITE CONDITIONS / DEMOLITION PLAN
- E-5 PUMP STATION 109 ELECTRICAL NEW WORK PLAN
- E-6 POWER RISER DIAGRAMS
- E-7 PANEL SCHEDULES AND GENERATOR SPECIFCATIONS

### BUILDING CODES

- FFPC FLORIDA FIRE PREVENTION CODE CHAPTER 69A-60 (8TH EDITION) NFPA 110 LIFE SAFETY CODE(2019 EDITION) NFPA 1 FIRE CODE (2021 EDITION)
- NFRA 70 NEC (2020 EDITION) NFPA 30 (2018 EDITION)

#### GENERATOR NFPA 110 LABLING

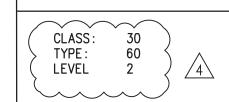

# GENERATOR NOTES

GENERATORS SHALL BE INSTALLED IN ACCORDANCE WITH NFPA 37(STANDARDS FOR THE INSTALLATION AND USE OF STAIONARY COMBUTIONENGINES AND GAS TURBINES & NFPA 70 ,1:11.7.1.

GENERATORS SHALL BE INCOMPLIANCE WITH NFPA30(2018 EDITION) FOR FLAMMABLE AND COMBUSTABLE LIQUIDS.

PROVIDE NFPA 704 PLACARD FOR DIESEL FUEL ON SITE.


# MIAMIDADE

# TRANSPORTATION AND PUBLIC WORKS DEPARTMENT STEPHEN P. CLARK CENTER 111 NW 1ST STREET, 16TH FLOOR MIAMI, FLORIDA 33128

	ELECTRICAL LEGEND
SYMBOL	DESCRIPTION
□ □ □ □ □ □ □ □ □ □ □ □ □ □ □ □ □ □ □	FLUORESCENT FIXTURE  FLUORESCENT FIXTURE, BARE STRIP  WALL MOUNTED LUMINAIRE  EXIT LIGHT FIXTURE (CLG/WALL MTD)  SINGLE-POLE TOGGLE SWITCH, 20A-125/277V, +48", SWITCH "a"  THREE-WAY TOGGLE SWITCH, 20A-125/277V, +48"  DUPLEX RECEPTACLE OUTLET, 20A-125V-3W, +18"  JUNCTION BOX  MOTOR, SIZE AS INDICATED  MOTOR STARTER OR CONTROLLER
3 30	DISCONNECT SWITCH; 3 = NUMBER OF POLES; 30 = AMP RATING; 20 = FUSE SIZE; F = FUSE SIZE RECOMMENDED BY EQUIPMENT MANUFACTURER  LIGHTING AND APPLIANCE PANELBOARD  DISTRIBUTION PANELBOARD  CONDUIT RUN CONCEALED IN WALL OR CEILING  QUADRUPLEX RECEPTACLE NEMA 5-20R, 20A-125V-3W, +18" U.O.N.
GFIP P	GROUND FAULT CIRCUIT INTERRUPTER RECEPTACLE NEMA 5-20R, 20A-125V-3W, HEIGHT AS DENOTED ON PLANS.  SINGLE RECEPTACLE OUTLET, 20A,125V,+18" UNLESS OTHERWISE NOTED  ISOLATED GND DUPLEX RECEPTACLE (ORANGE) NEMA 5-20R, 20A, 125V,3W  CONDUIT RUN EXPOSED  BRANCH CIRCUIT HOMERUN. SHORT CROSSMARKS = NUMBER OF PHASE CONDUCTORS, LONG CROSSMARKS = NEUTRAL, IG = ISOLATED GROUND CONDUCTOR, FLAGGED CROSSMARK OR G = GROUND CONDUCTOR.
WP EC AFF 3R NFPA N.I.C M.L.O DISC JB NEC GFCI AFCI AGFCI SPD	FLEXIBLE CONDUIT  DENOTES 'WEATHERPROOF' EQUIPMENT EMPTY CONDUIT  ABOVE FINSHED FLOOR  NEMA '3R' ENCLOSURE (RAINTIGHT)  NATIONAL FIRE PROTECTION ASSOCIATION  NOT IN CONTRACT  MAIN LUG ONLY  DISCONNECT SWITCH  JUNCTION BOX  NATIONAL ELECTRICAL CODE  DENOTES KEY NOTE #1 SEE APPROPRIATE DWG FOR KEY NOTE DESCRIPTION.  GROUND FAULT CIRCUIT INTERRUPTER  ARC FAULT CIRCUIT INTERRUPTER  COMBINATION ARC/GROUND FAULT CIRCUIT INTERRUPTER  SURGE PROTECTION DEVICE

#### SCOPE OF WORK

- 1. PROVIDE DEMOLITION AND NEW WORK AS INDICATED BY THE PLANS.
- MAINTAIN POWER, CONTROLS, AND COMMUNICATIONS TO INFRASTRUCTURE TO REMAIN AS REQUIRED.
- COORDINATE THE POWER OUTAGE(S) WITH FPL PRIOR TO STARTING WORK.
- 4. DEVELOP A SEQUENCE OF WORK TO BE APPROVED IN WRITING BY
- BUILDING PENETRATIONS SHALL BE APPROVED BY ARCHITECT AND STRUCTURAL ENGINEER PRIOR TO ANY ROUGH-IN.
- 6. SEAL BUILDING ENVELOPE PENETRATIONS AND REPAIR FINISHES AS DIRECTED BY ARCHITECT.
- 7. COORDINATE INSTALLATION OF NEW FEEDERS AND ASSOCIATED DISTRIBUTION EQUIPMENT WITH EXISTING INFRASTRUCTURE AND MEP/FP SERVICES.
- 8. PROVIDE TEMPORARY BY-PASS SYSTEMS AND SERVICES AS REQUIRED TO ACCOMPLISH WORK INDICATED BY THE PLANS.
- CONTRACTOR SHALL MAINTAIN SITE IN ORDERLY CONDITION AT THE END OF EACH DAY BY REMOVING AND DISPOSING OF CONSTRUCTION DEBRIS AND STORING EQUIPMENT AND MATERIALS IN ASSIGNED/DESIGNATED AREAS.
- 10. PROVIDE FULL FUEL TANKS FOR GENERATORS AFTER TESTING AND COMMISSIONING THE PROJECT.

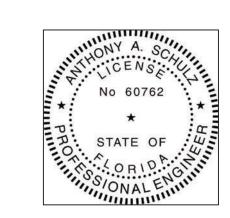

ENGINEERS FL CA Lic. # 444

E-0

PROJECT NO. 17053.01

DRAWING NO.

HUFSEY • NICOLAIDES • GARCIA • SUAREZ CONSULTING ENGINEERS 4800 SW 74TH COURT MIAMI, FLORIDA 33155 (305) 270-9935 Fax (305)665-5891

PERMIT SET 02-02-2022

SHEET NO.

OF 17

DESIGN BY: A.E.W. DATE: 12/16/19 DATE: DRAWN BY: CHECKED BY: A.E.W.

DATE:

03-14-25 REVISION 4 ADDRESS MDC COMMENTS

08-29-24 REVISION 2 ADDRESS MDC COMMENTS


02-04022 REVISION 1 ADDRESS MDC COMMENTS

SITE LOCATION, LEGEND, AND NOTES

BISCAYNE SHORES PUMP STATIONS No. 109 AND 110 RETROFIT

SHEETS

# Electrical Plans Revised by Addendum No. 12

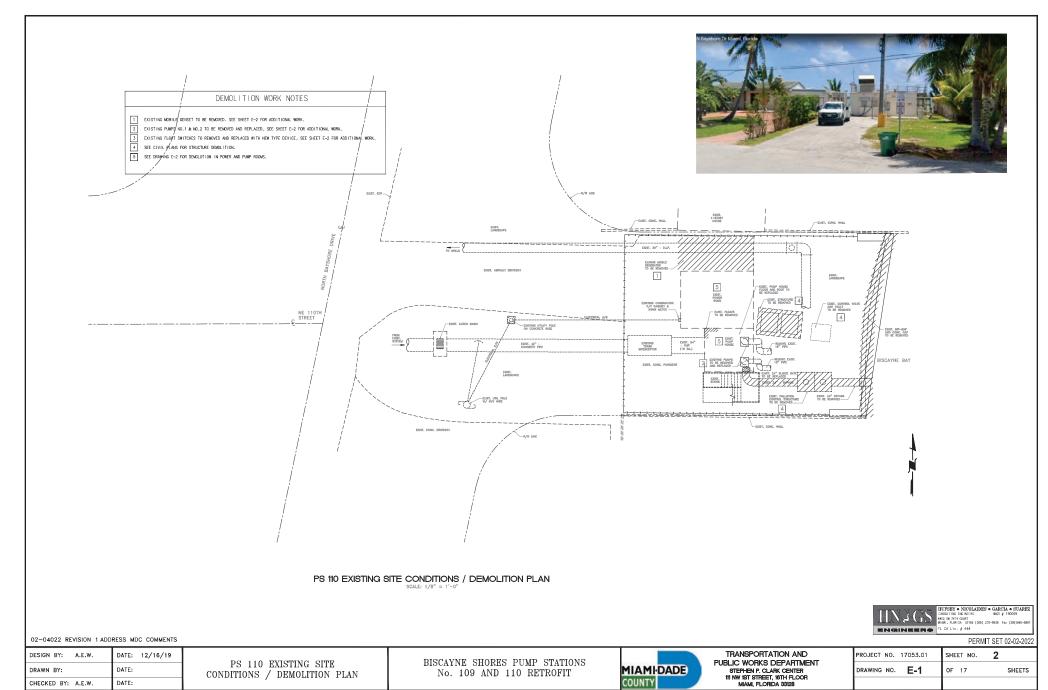

#### MCC DEVICES 1A INCOMING SECTION (MLO) TO REMAIN. DEMOLITION WORK NOTES 1B CIRCUIT MONITOR TO REMAIN. 1C EXISTING 110TH ST PUMP 2 STARTER TO REMAIN. EXISTING PUMP NO. 1, 100HP-480V-3ø. REMOVE PUMP, FEEDER AND CONTROL BACK TO SOURCE. PROVIDE NEW AS 2A EXISTING SPD TO REMAIN. INDICATED ON DRAWING E-3. SEE POWER RISER DIAGRAM DRAWING E-7 FOR ADDITIONAL WORK. 2B LIGHTING PANEL LP EXISTING PUMP NO. 2, 50HP-480V-3ø. REMOVE PUMP, FEEDER AND CONTROL BACK TO SOURCE. PROVIDE NEW AS INDICATED ON DRAWING E-3. SEE POWER RISER DIAGRAM DRAWING E-7 FOR ADDITIONAL WORK. 2C TRANSFORMER EXISTING DETROIT DIESEL 300KW DIESEL GENSET. DRAIN FUEL AND SAVE FOR REUSE IN NEW GENSET. REMOVE GENSET EXISTING 109TH ST PUMP 1 STARTER TO BE DELETED PROVIDE BLANK COVER PLATE COMPLETE WITH OUTPUT FEEDER, CONTROL WIRING, ASSOCIATED APPURTENANCES BACK TO SOURCE. SEE DRAWING E-3 AND E-7 FOR NEW WORK. 4 EXISTING 110TH ST PUMP 1 STARTER TO REMAIN. REMOVE EXISTING FLOAT SWITCHES (QUANTITY TO BE VERIFIED ON SITE). MAKE PROVISIONS FOR NEW EQUIPMENT AS EXISTING 109TH ST PUMP 2 STARTER TO BE DELETED PROVIDE BLANK COVER PLATE REQUIRED. SEE DRAWING E-3 FOR NEW WORK. 6A EXISTING MOTORIZED VALVE 110TH ST DISC SWITCH TO BE DELETED PROVIDE BLANK COVER PLATE EXISTING STRUCTURES TO BE REMOVED. SEE CIVIL PLANS FOR WORK. REMOVE POWER AND LOW VOLTAGE WIRING BACK TO SOURCE OR LAST DEVICE TO REMAIN ACTIVE. SEE DRAWING E-3 FOR NEW WORK. 6B EXISTING MOTORIZED VALVE 109TH ST DISC SWITCH TO BE DELETED PROVIDE BLANK COVER PLATE 6 EXISTING MCC TO REMAIN. SEE DRAWING E-3 FOR NEW WORK. BATTERY CHARGER -REMOVE EXISTING NORMAL AND EMERGENCY LUMINAIRES, IN PUMP HOUSE AND ELECTRICAL ROOM, INCLUDING ALL WIRING AND CONTROLS BACK TO SOURCE. PROVIDE NEW AS INDICATED IN NEW WORK, SEE DRAWING E-3 AND E-7. 9 ( EXISTING PUMP CONTROL PANEL. REMOVE COMPLETE WITH ALL CONTROL POWER AND CONTROL WIRING. ABANDON UNDERGROUND CONDUITS IN PLACE, SEAL ENDS AT FLOOR AND WALL PENETRATIONS AS DIRECTED. \_\_\_\_\_ 2#10-1" REMOVE EXISTING VENTILATION FAN, STORE FOR SAFEKEEPING AND REINSTALL IN NEW WORK. LP-2PUMP CONTROL PANEL GEN. BKR. BATTERIES J\_\_\_\_\_ - JACKET WATER HEATER GENERATOR 3 ACCESS -16#15-1" TO PCP LP-1,3,5HATCH VIA DUCT BANK MCC 6 TO MCC 6A 1B | 2B MCB ATS L1 - 96B <u> 10 | 20 |</u> EXISTING 480V-3ø-4W MCC FP&L SERVICE — (LS)(LS)FLOAT SWITCHES - PUMP No.1 (PS2) (TYP. 6) -1 4 7 WELL/OUTFALL 5 ELECTRIC 5 WP OPERATOR - PUMP No.2 L1−9 < $\bigcirc$ WP 2 50 $-\infty$ ACCESS 3#10-1" -HATCH SUMP RECEPTACLE OPEN STAIR PU;MP STATION 110 ELECTRICAL DEMOLITION PLAN N.T.S. HUFSEY · NICOLAIDES · GARCIA · SUAREZ CONSULTING ENGINEERS · HNGS # 190069

08-29-24 REVISION 2ADDRESS MDC COMMENTS 02-04022 REVISION 1 ADDRESS MDC COMMENTS

DESIGN BY: A.E.W.	DATE: 12/16/19	PUMP STATION 110
DRAWN BY:	DATE:	ELECTRICAL DEMOLITION PLAN
CHECKED BY: A.E.W.	DATE:	

BISCAYNE SHORES PUMP STATIONS No. 109 AND 110 RETROFIT




TRANSPORTATION AND
PUBLIC WORKS DEPARTMENT
STEPHEN P. CLARK CENTER
111 NW 1ST STREET, 16TH FLOOR
MIAMI, FLORIDA 33128

ROJECT NO. 1	7053.01	SHEET NO.	3
RAWING NO.	E-2	OF 17	SHEETS

ENGINEERS FL CA Lic. # 444

PERMIT SET 02-02-2022

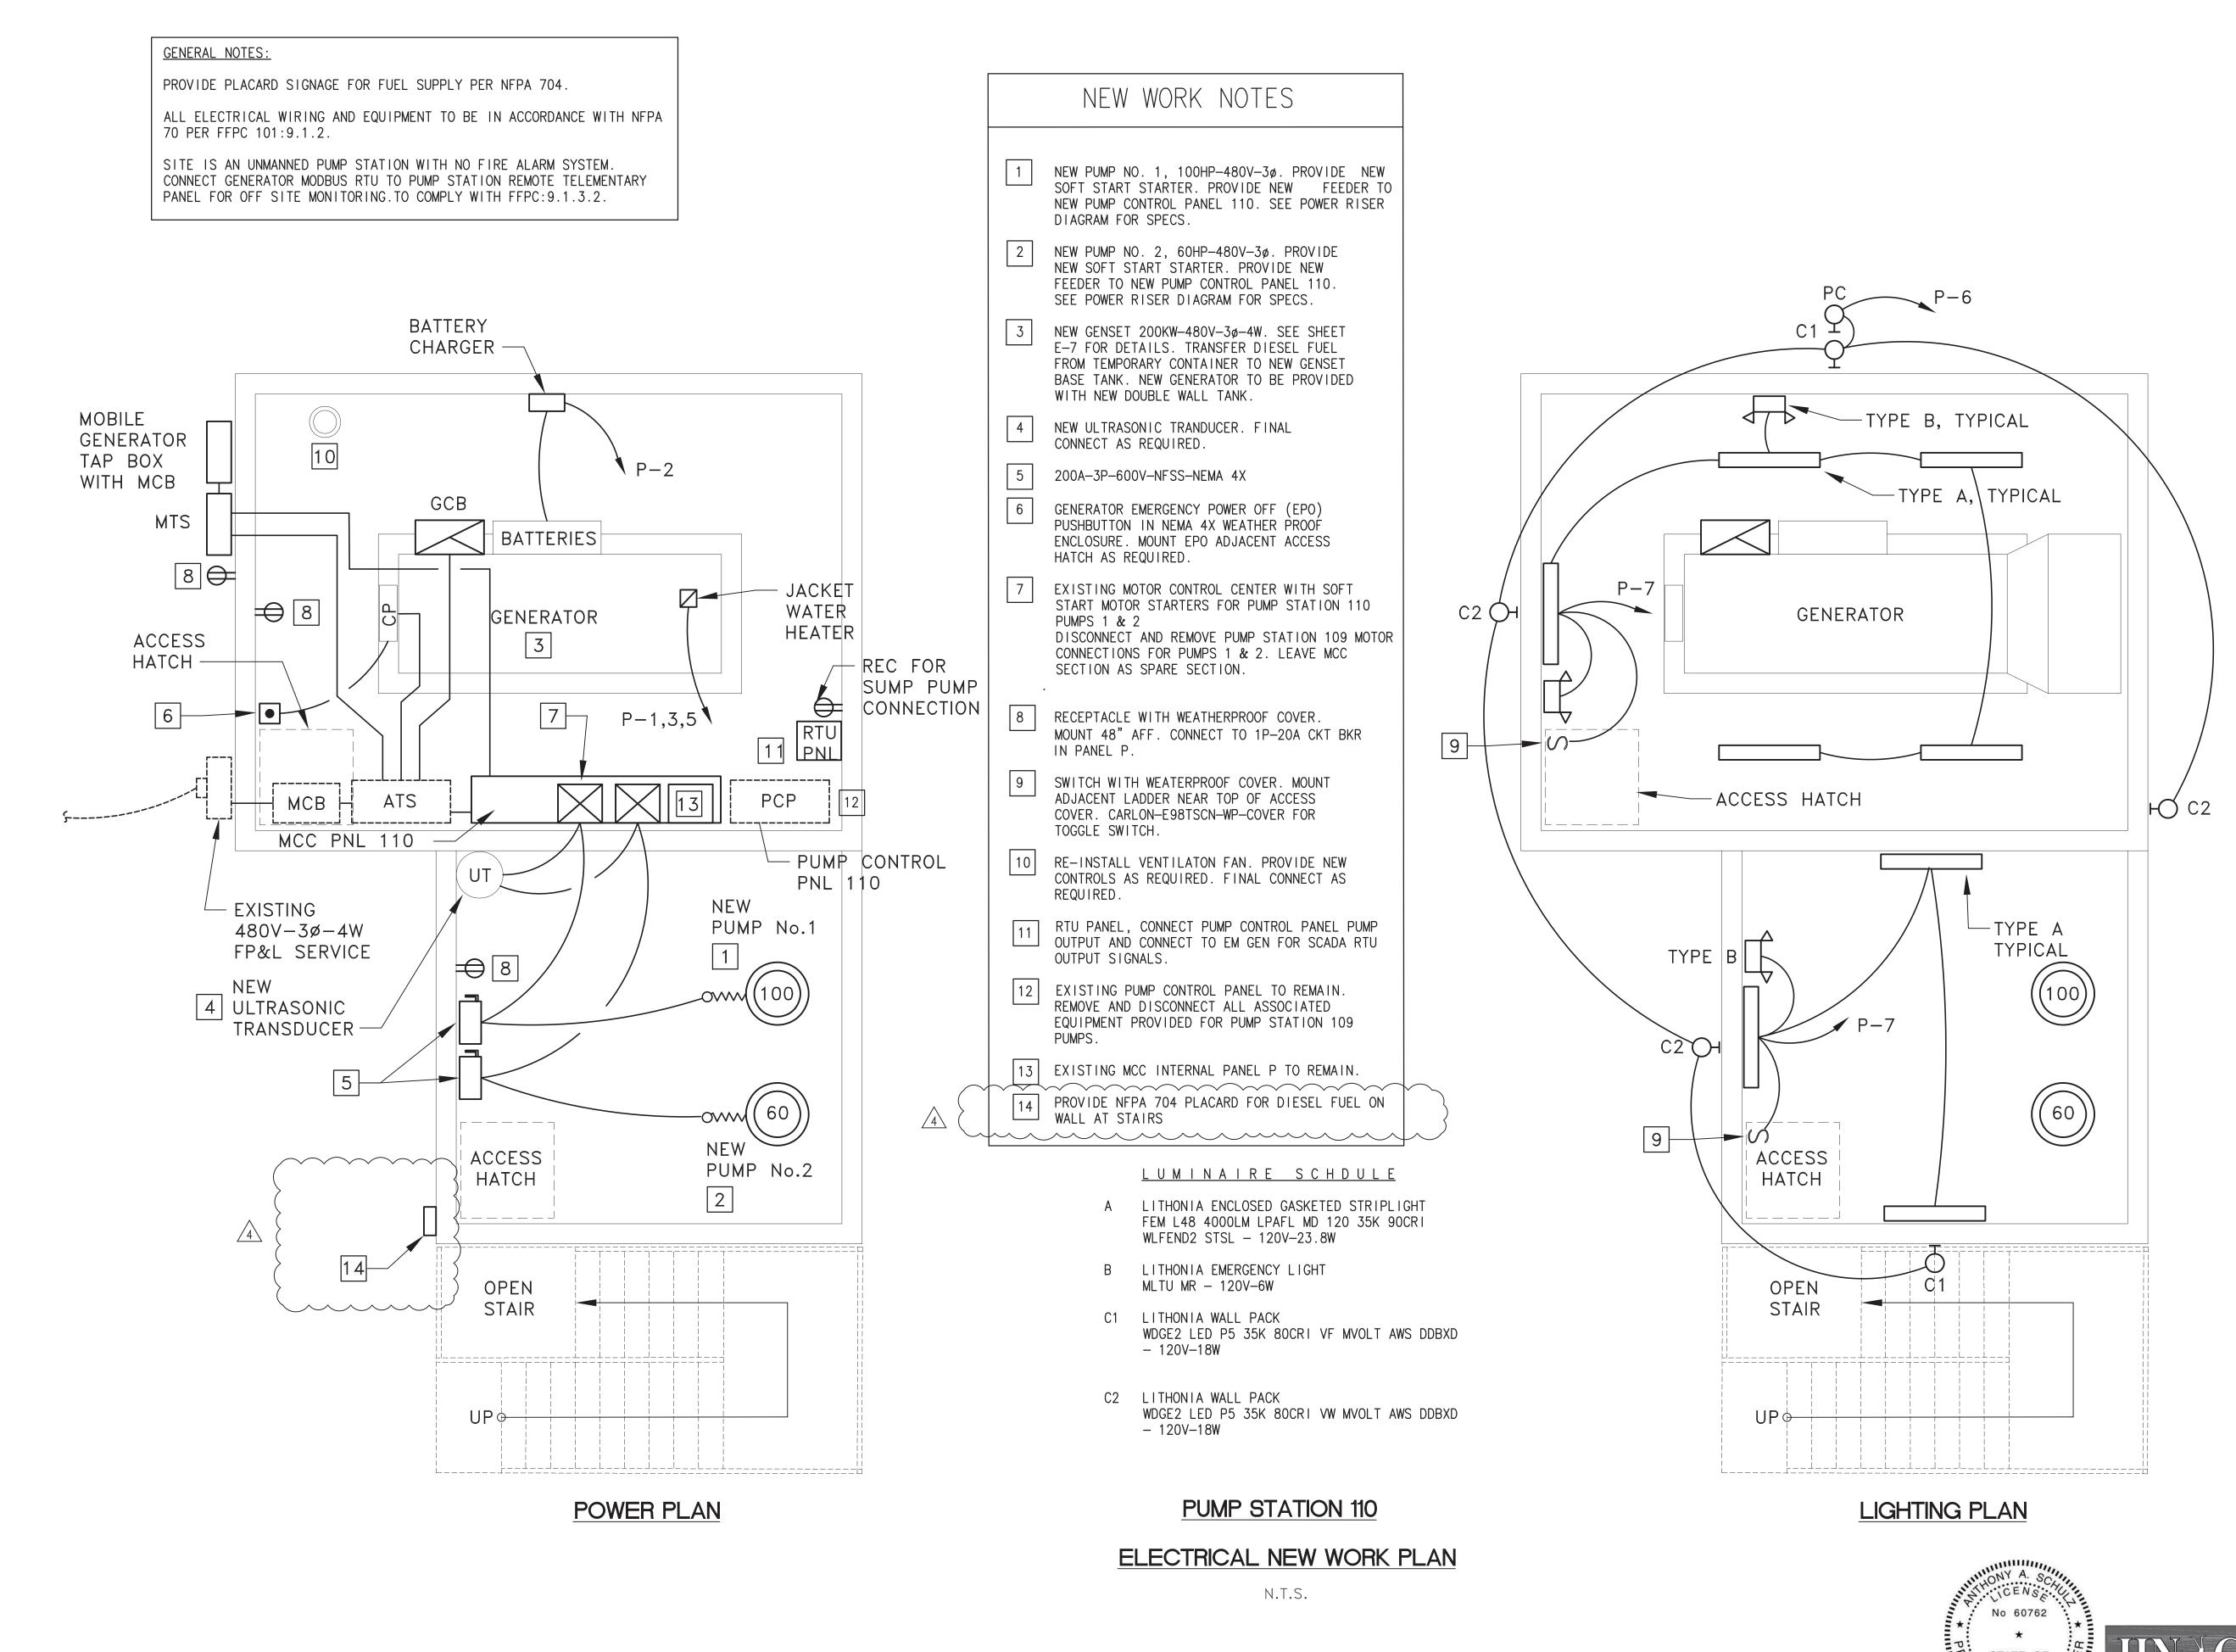

03-14-25 REVISION 4 ADDRESS MDC COMMENTS 01-06-25 REVISION 3 ADDRESS MDC COMMENTS 08-29-24 REVISION 2 ADDRESS MDC COMMENTS 02-04022 REVISION 1 ADDRESS MDC COMMENTS

DESIGN BY: A.E.W. DATE: 12/16/19

DRAWN BY: DATE:

CHECKED BY: A.E.W. DATE:

PUMP STATON 110 ELECTRICAL NEW WORK PLAN BISCAYNE SHORES PUMP STATIONS No. 109 AND 110 RETROFIT



TRANSPORTATION AND
PUBLIC WORKS DEPARTMENT
STEPHEN P. CLARK CENTER
111 NW 1ST STREET, 16TH FLOOR
MIAMI, FLORIDA 33128

PROJECT NO.	17053.01	SHEET NO.	4
DRAWING NO.	E-3	OF 17	SHEETS


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HUFSEY · NICOLAIDES · GARCIA · SUAREZ

MIAMI, FLORIDA 33155 (305) 270-9935 Fax (305)665-5891

# Electrical Plans Revised by Addendum No. 12



HUFSEY • NICOLADES • GARCIA • ST COMPATING BERRESS • HOSS # 10008 • 98 # 74m Court | # 1000 # 100 (200) 270 + 00.5 Fee (300)

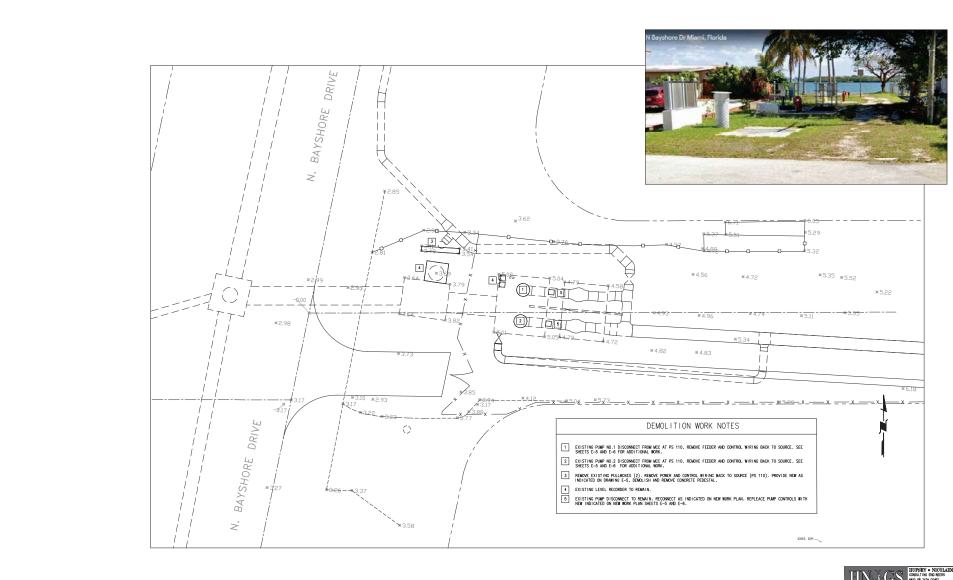PERMIT SET 02-02-2022

DESIGN BY: A.E.W. DATE: 12/16/19

DRAWN BY: DATE: DEMOLITION PLAN

CHECKED BY: A.E.W. DATE:


02-04022 REVISION 1 ADDRESS MDC COMMENTS

BISCAYNE SHORES PUMP STATIONS No. 109 AND 110 RETROFIT



TRANSPORTATION AND PUBLIC WORKS DEPARTMENT STEPHEN P. CLARK CENTER 111 NW 15T STREET, 16TH FLOOR MAMI, FLORIDA 33128


PROJECT NO. 17053.01	SHEET NO.	5	
DRAWING NO. E-4	OF 17		SHEETS

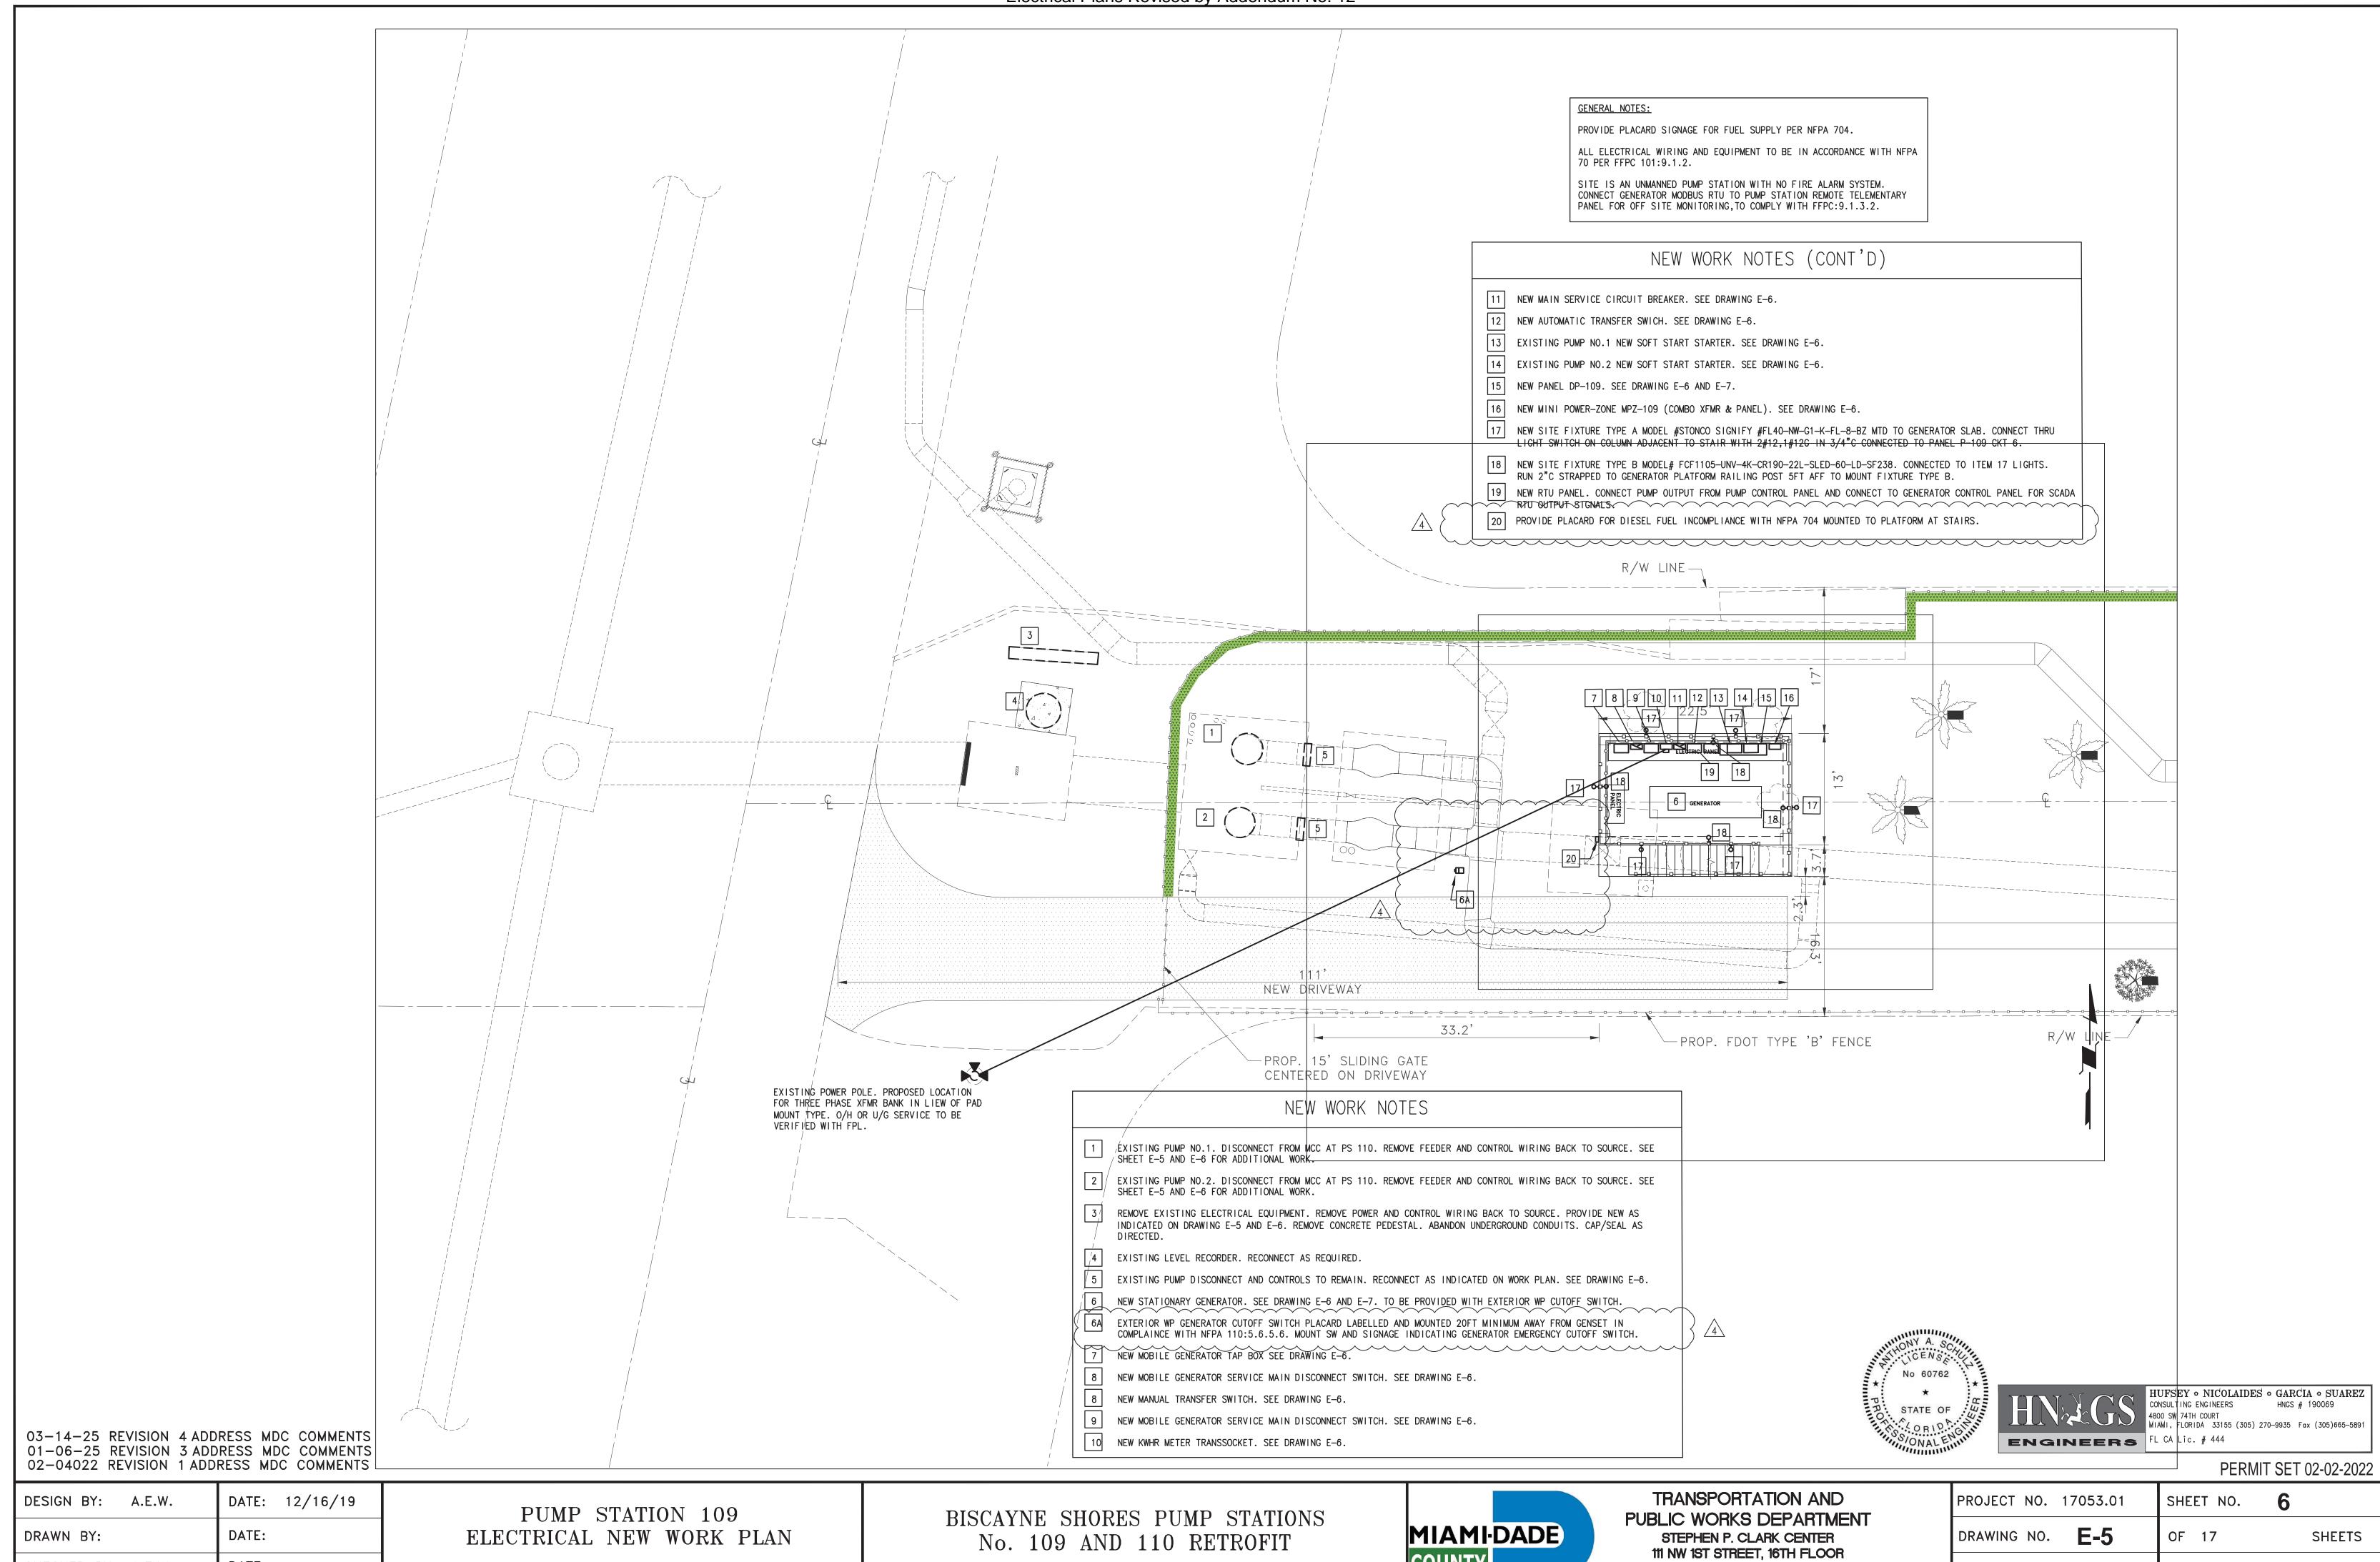

DATE:

CHECKED BY: A.E.W.

MIAMI, FLORIDA 33128

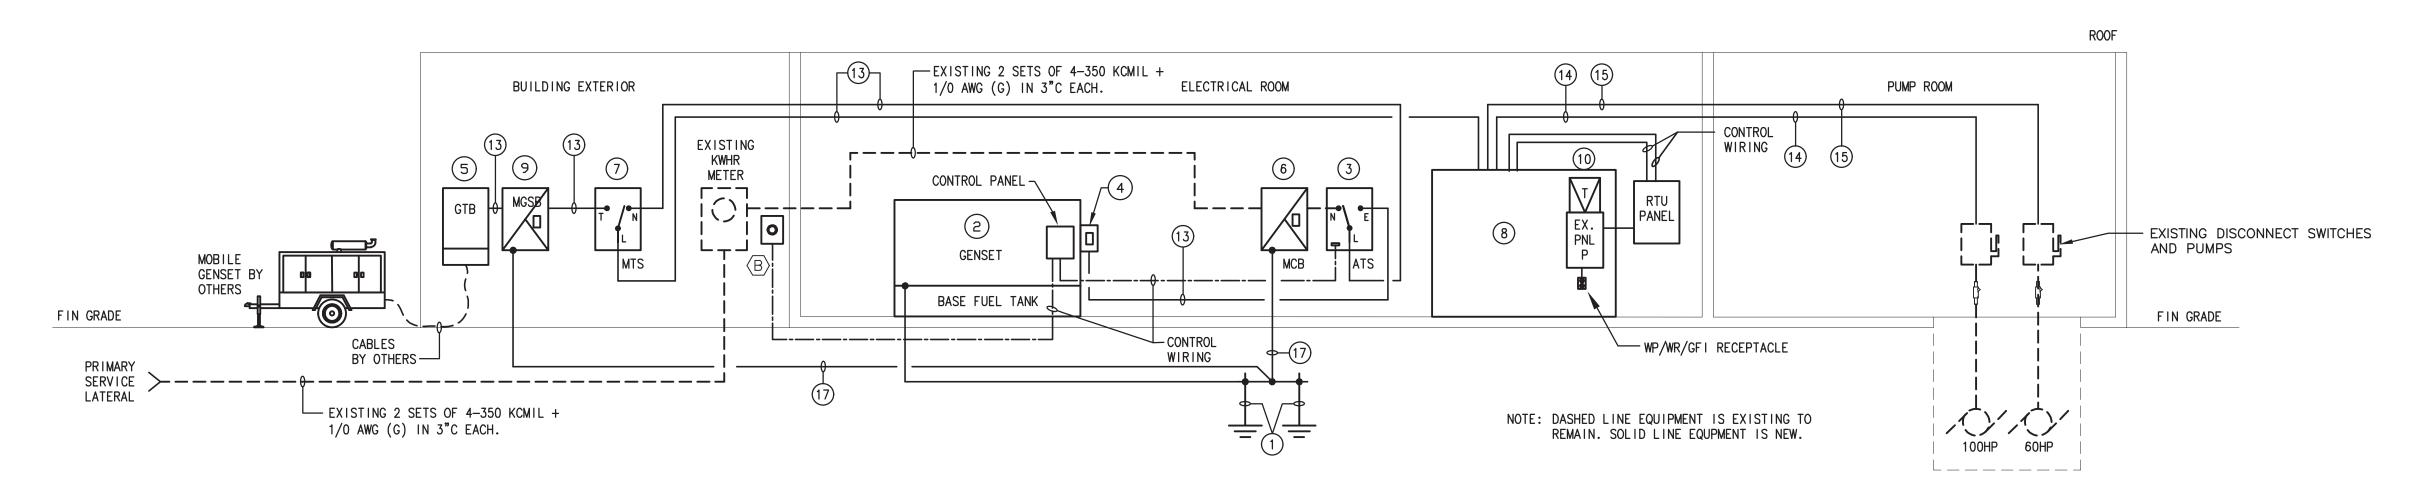

B GENERATOR EMERGENCY STOP ELECTRICAL CONTRACTOR

PS 110 GENERATOR.

REQUIRED TO SUBMIT TO ENGINEER OF RECORD SHOP DRAWINGS FOR THE LOCATION OF THE ELECTRICAL EQUIPMENTS ON THE

WALL FOR APPROVAL PRIOR TO ORDERING THE EQUIPMENTS FOR

FOR PS109 OUTDOOR GENERATOR, MOUNT GENERATOR SHUT-OFF SWITCH TO A CONCRETE POST 20 FEET AWAY MINIMUM FROM

GENERATOR AND PROVIDE SIGNAGE PLACARD TO POST.

PS 110 POWER RISER DIAGRAM E-5 SCALE: NONE

POWER RISER DIAGRAM IS DIAGRAMMATIC IN NATURE. INSTALLATION AND FINAL CONFIGURATION TO BE DETERMINED BY ACTUAL EQUIPMENT

NOTE:
ALTERNATE POLE MOUNTED TRANSFORMER BANK NOTE:
ALL TRANSFER SWITCHES TO BE ASCO AND WATER MAY BE SELECTED/PROPOSED BY FPL. CONTROL PANEL -FPL TRANSFORMER GENSET MCB CABLES BY OTHERS — MEW PLATFORM
BY OTHERS METER BASE FUEL TANK WIRING 13 - WP/WR/GFI RECEPTACLE FIN GRADE **PRIMARY** SERVICE LATERAL CONTROL WIRING

> PS 109 POWER RISER DIAGRAM E-5 SCALE: NONE

NOTE:
POWER RISER DIAGRAM IS DIAGRAMMATIC IN NATURE. INSTALLATION
AND FINAL CONFIGURATION TO BE DETERMINED BY ACTUAL EQUIPMENT

STATE OF

ENGINEERS FL CA Lic. # 444

HUFSEY • NICOLAIDES • GARCIA • SUAREZ
CONSULTING ENGINEERS + 190069 MIAMI, FLORIDA 33155 (305) 270-9935 Fax (305)665-5891

PERMIT SET 02-02-2022

DATE: 12/16/19 DESIGN BY: A.E.W. DATE: DRAWN BY: DATE: CHECKED BY: A.E.W.

03-14-25 REVISION 4 ADDRESS MDC COMMENTS

01-06-25 REVISION 3ADDRESS MDC COMMENTS 02-04022 REVISION 1 ADDRESS MDC COMMENTS

PS 109 NEW WORK PLAN

BISCAYNE SHORES PUMP STATIONS No. 109 AND 110 RETROFIT

TRANSPORTATION AND PUBLIC WORKS DEPARTMENT STEPHEN P. CLARK CENTER 111 NW 1ST STREET, 16TH FLOOR MIAMI, FLORIDA 33128

MIAMI-DADE

COUNTY

PROJECT NO. 17053.01	SHEET NO.	7	
DRAWING NO. <b>E-6</b>	OF 17		SHEETS

1 1-1/0 AWG TO TWO (2) COPPER CLAD STEEL GROUND RODS AND BOND TO FOUNDATION REBARS. INSTALL RODS MINIMUM SIX (6) FEET ON CENTER. PROVIDE 10' LONG BY 3/4" DIAMETER RODS.

KEY NOTES


- 200KW-480V-3ø-3W EMERGENCY STAND-BY DIESEL GENERATOR WITH ALUMINUM SOUND ATTENUATED, WEATHERPROOF AND HURRICANE RESISTANT ENCLOSURE. GENSET INCLUDES A SUB-BASE FUEL TANK PROVIDING 24 HOURS RUN TIME.
- 3 NEW AUTOMATIC TRANSFER SWITCH (ATS) 3P-400A-480V, 45KAIC IN NEMA 4X ENCLOSURE.
- 4) 3P-400A-600V-45KAIC GENERATOR MOUNTED CIRCUIT BREAKER.
- GENERATOR TAP BOX. 400A-3P-3W IN NEMA 4X ENCLOSURE. PROVIDE WITH FEMALE KAM-LOC CONNECTORS. POWERTRON SERIES 400 OR APPROVED EQUAL.
- (6) NEW MCB 400A-3P-480V IN NEMA 4X ENCLOSURE.
- 7) MANUAL TRANSFER SWITCH (MTS) 3P-400A, 480V, IN NEMA 4X ENCLOSURE.
- (8) EXISTING MOTOR CONTROL CENTER MCC TO REMAIN.
- (8A) PUMP CONTROL PANEL 109 BY OTHERS TO BE FURNISHED WITH MAIN 3P-400A BREAKER, 3P-175A BREAKER FOR PUMP #1 AND 175A BREAKER FOR PUMP #2, FURNISH 2P-30A FOR MINI-POWER ZONE. FURNISH SOFT START STARTERS SIZED PER MANUFACTURER'S RECOMMENDATION, PROVIDE HOA SWITCHES, PUMP HR METERS AND LED PUMP RUNNING INDICATORS AND PUSH TO START BUTTONS. CONTROL PANEL TO COMPLY WITH MDC PUBLIC WORKS STANDARDS. PROVIDE CONTROL PANEL AC UNIT.
- (9) MGSB (MOBILE GENSET SERVICE BREAKER) 400A-3P-480V IN NEMA 4X ENCLOSURE.
- (10) EXISTING MCC INTERNAL TRANSFORMER AND PANEL P TO REMAIN..
- PROVIDE STAND ALONE KWHR DEMAND METER AND CT CABINET OR COMBINATION UNIT AS REQUIRED BY FPL.
- SOFT START STARTERS WITHIN CONTROL PANEL ENCLOSURE. SIZE AND TYPE WITH ACCESSORIES AS RECOMMENDED BY PUMP MANUFACTURER. SEE DETAIL ON SHEET E-9.
- (13) NEW 2 SETS OF 4-4/0 AWG + 2 AWG (G) IN 2.5"C EACH.
- (14) NEW 3-4/0 AWG + 4 AWG (G) IN 2"C.
- 15) NEW 3-1/0 AWG + 6 AWG (G) IN 2"C.
- 16 NOT USED.
- (17) 3-2/0 AWG + 1-6AWG (G) IN 2" C.
- (18) 2-10 AWG + 1-10 AWG (G) IN 3/4" C.

EXISTING DISCONNECT SWITCHES AND PUMPS

NOTE: DASHED LINE EQUIPMENT IS EXISTING TO REMAIN. SOLID LINE EQUPMENT IS NEW.

FIN GRADE

## Electrical Plans Revised by Addendum No. 12

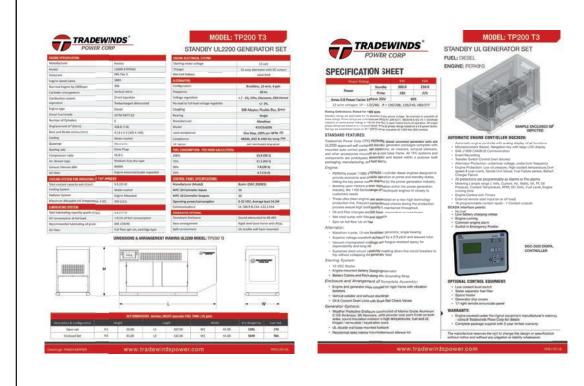

VOLTAGE: 480Y/277V 3PH 4W	TYPE: SE						PANEL			PANEL COVER	SHALL	BE N	ARKED 'DANGER: POTENTIAL ARC FLAS	H HAZARD"	7
BUS: 400A MAN: CRCUIT BREAKER MAN SIZE: 400A OPTION: SPD	MOUNT: SU LOCATION: SERVES:					D	P-1	10				PA	NEL AIC: 42,000 SYMM		
+ GAT LOAD DESCRIPTION		DAM		RING AND	_		ONNECTED	YA.	_	WRING AND		NA.	LOAD DESCRIPTION	NO LT	-
NO CONDUCTOR	. p	TR#		ONDUIT RISER DIAG	34333	21220	8	_	C	SEE RISER DAG	3 3	TRP	PUMP NO. 2	2 N	
3 -			OCE /	PEGEN UNG	34303	21329	34333 213	129		SEE PISER UNG		150	- OMP NO. 2	4 N	1
5 -			-				J.1000; 2.10		33 2132	9		-		6 N	
7 PANEL P TRANSFORMER	2	30	3-10,1	1-10G/3/4°C	5000			-		4-10+1-10G	3	30	SPO		7
9 -							5000							10	
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		h.		ELANEOUS				1.		120/49					
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				PTACLES	>10kVA			0.5							
		K	KITCH	HEN				0.6	55	0					
DLTAGE: 120/240V 1PH 3W	TYPE	E SIE	MENS				PANE	L	D	PANEL COVE	ERS	HALL	BE MARKED "DANGER: POTENTIAL	ARC FLASHI	HAZA
DLTAGE: 120/240V 1PH 3W BUSS: 100A MAN: 60A MCB	TYPE MOUNTING LOCATION	E SIE					PANE	L	D .	PANEL COVE			BE MARKED "DANGER: POTENTIAL I'. RATING: 10 KAIC MAX.	ARC FLASHI	HAZA
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BUSS: 100A MAIN: 60A MCB DPTION: KT LOAD DESCRIPTION 1 LIGHTS - ELEC RM 3 LIGHTS - PUMP RM	MOUNTING LOCATION SERVES	SIE	KR TRIP 20 20	WIRING CONI 2-12-12G 2-12-12G	34°C 34°C	131	P-1' CONNECTI	10	180	PANEL COVI BRANCH CK WIRING AND CONDUIT 2:12-12G3I*C 2:12-12G3I*C	T BKI	KR TRIF 20	F. RATING: 10 KAIC MAX.  LOAD DESCRIPTION RECEPTACLE - ELEC RM RECEPTACLE - PUMP RM		CKT NO 2
BUSS: 100A MAN: 60A MCB PPTION: KT LOAD DESCRIPTION 1 LIGHTS - ELEC RM 3 LIGHTS - PUMP RM	MOUNTING LOCATION SERVES	SIES	KR TRIP	WIRING CONI 2-12+12G	34°C 34°C		P-1' CONNECTI	10	180	PANEL COVE BRANCH CK WRING AND CONDUIT 2-12-12G3/4°C	B P	KR TRIF	RATING: 10 KAIC MAX.  LOAD DESCRIPTION  RECEPTAGLE - ELEC RM		CK1 NO
BUSS: 100A MAIN: 90A MCB OPTION:  LOAD DESCRIPTION UICHTS - PUMP RM UICHTS - PUMP RM UICHTS - PUMP RM R	MOUNTING LOCATION SERVES	SIE	KR TRIP 20 20	WIRING CONI 2-12-12G 2-12-12G	34°C 34°C 34°C	131	P-1' CONNECTIA 180	10	180	PANEL COVI BRANCH CK WRING AND CONDUIT 242-12634°C 242-12634°C 242-12634°C 242-12634°C	B P 1 1 1 1 1	KR TRIF 20 20 20 20 20	RATING: 10 KAIC MAX.  LOAD DESCRIPTION  RECEPTACLE - ELEC RM  RECEPTACLE - PUMP RM  RECEPTACLE - ROOF  CONTROLS		CK1 NO 2 4 6
BUSS: 100A MAR: 60A MCB OPTION:  LOAD DESCRIPTION  LOAD DESCRIPTION  LUGHTS - ELEC RM  LUGHTS - PUMP RM  LUGHTS - EXTERIOR  LUGHTS - EXTERIOR  ATTERY CHARGER  9	MOUNTING LOCATION SERVES	SIE	KR TRIP 20 20 20 30	WIRING CONI 2-12-12G 2-12-12G 2-12-12G	34°C 34°C 34°C	131	P-1' CONNECTIA 180	10 ED VA B	180	PANEL COVI BRANCH CK WRING AND CONDUIT 2121-12634°C 2121-12634°C 2121-12634°C 2121-12634°C 2121-13634°C	B P 1 1 1 1 1 1 1	KR TRIF 20 20 20 20 20	RATING: 10 KAIC MAX.  LOAD DESCRIPTION RECEPTACLE - PLUMP RM RECEPTACLE - PROMP RM RECEPTACLE - ROOF CONTROLS EXHAUST FAN		CK1 NO 2 4 6 8
BUSS: 100A MAIN: 60A MCB PPTON:  COLOR LOAD DESCRIPTE  LOAD DE	MOUNTING LOCATION SERVES	SIE SIE SUF SIE	KR TRIP 20 20 20 30	WIRING CONI 2-12-12G 2-12-12G 2-12-12G	34°C 34°C 34°C	131	P-1' CONNECTIA 180	10 ED VA B	180	PANEL COVI BRANCH CK WRING AND CONDUIT 242-12634°C 242-12634°C 242-12634°C 242-12634°C	B P 1 1 1 1 1 1 1 1	KR TRIF 20 20 20 20 20 20	RATING: 10 KAIC MAX.  LOAD DESCRIPTION RECEPTACLE - ELEC RM RECEPTACLE - PUMP RM RECEPTACLE - ROOF CONTROLS EXHAUST FAN SUMP PUMP		CK1 NO 2 4 6 8 10
BUSS: 100A MAN: 90A MCB OPTION  LOAD DESCRIPTI  JUSTIS - ELEC RM  LIGHTS - ELEC RM  LIGHTS - EXTERIOR  BATTERY CHARGER  1 SPACE  3 SPACE	MOUNTING LOCATION SERVES	SIE SIE SUF SIE	KR TRIP 20 20 20 30	WIRING CONI 2-12-12G 2-12-12G 2-12-12G	34°C 34°C 34°C	131	P-1' CONNECTIA 180	10 ED VA B	180	PANEL COVI BRANCH CK WRING AND CONDUIT 2121-12634°C 2121-12634°C 2121-12634°C 2121-12634°C 2121-13634°C	B P 1 1 1 1 1 1 1 1 1 1 1 1 1 1 1 1 1 1	KR TRIF 20 20 20 20 20	RATING: 10 KAIC MAX.  LOAD DESCRIPTION RECEPTACLE - ELEC RM RECEPTACLE - PUMP RM RECEPTACLE - ROOF CONTROLS EXHAUST FAN SUMP PUMP SPACE SPACE		CK1 NO 2 4 6 8 10 12
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BUSS: 100A MAIN: 90A MCB POPTION  CONTROL LOAD DESCRIPTIN  I LIGHTS - FLEE RM  3 LIGHTS - PLAMP RM  1 SPACE  1 SPACE  1 SPACE  9 SPACE	MOUNTING LOCATION SERVES	SIE	KR TRIP 20 20 20 30	WIRING CONI 2-12-12G 2-12-12G 2-12-12G	34°C 34°C 34°C	131	P-1' CONNECTIA 180	10 ED VA B	180	PANEL COVI BRANCH CK WRING AND CONDUIT 2121-12634°C 2121-12634°C 2121-12634°C 2121-12634°C 2121-13634°C	B P 1 1 1 1 1 1 1 1 1 1 1 1 1 1 1 1 1 1	KR TRIF 20 20 20 20 20 20	RATING: 10 KAIC MAX.  LOAD DESCRIPTION  RECEPTACLE: ELEC RM  RECEPTACLE: PUMP RM  RECEPTACLE: ROOF  CONTROLS  EVIDALIST FAM  SPACE  SPACE  SPACE  SPACE  SPACE		CK1 NO 2 4 6 8 10 12 14 16 18
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BUSS 100A MAN 80A MCB OPTON  LOAD DESCRIPTI  LUGHTS - ELEC PM  LUGHTS - ELEC PM  LUGHTS - EXTERIOR  LUGHTS - EXTERIOR  BATTERY CHARGER  11 SPACE 15 SPACE 15 SPACE 17 SPACE 19 SPACE	MOUNTING LOCATION SERVES	SIE	RFACE	WIRING CONICONNECT TOTAL C LARGES MISCELL MISCELL CON CONTINUL CARGES MISCELL MISCELL CON CONTINUL CARGES MISCELL CON CONTINUL CARGES MISCELL CON CONTINUL CARGES MISCELL CARGES MISCEL	ED VA: ONNECT TIMOTOUS TIMOTOUS	131 90 3000	PANE P-1  CONNECTI A  180  180  864	10 ED VA B 77	180 600 200	PANEL COVI BRANCH CK WRING AND CONDUIT 2302-100-3FC 2302-100-3FC 2302-100-3FC 2302-100-3FC 2302-100-3FC 2302-100-3FC 2302-100-3FC 2302-100-3FC 2302-100-3FC 2302-100-3FC	B P 1 1 1 1 1 1 1 1 1 1 1 1 1 1 1 1 1 1	RS N KR 20 20 20 20 20 	RATING: 10 KAC MAX.  LOAD DESCRIPTION  RECEPTACLE: FLEE RM  RECEPTACLE: PUMP RM  RECEPTACLE: POMP RM  RECEPTACLE: POMP RM  RECEPTACLE: POMP RM  RECEPTACLE: POMP RM  SUMP PUMP  SPACE  SPACE  SPACE  SPACE  SPACE  SPACE		CKT NO 2 4 6 8 10 12 14 16 18 20 22
BUSS 100A MAN 80A MCB OPTON  LOAD DESCRIPTI  LUGHTS - ELEC PM  LUGHTS - ELEC PM  LUGHTS - EXTERIOR  LUGHTS - EXTERIOR  BATTERY CHARGER  11 SPACE 15 SPACE 15 SPACE 17 SPACE 19 SPACE	MOUNTING LOCATION SERVES	SIE	IKR TRIP 20 20 30 	VMRING CONN 2:12-126 2:12-126 2:12-120 2:10-106  CONNECT  TOTAL C  LOAD TWI LARGES	ED VA: ONNECT TIMOTOUS TIMOTOUS	131 90 3000	PANE P-1  CONNECTI A  180  180  864	10 ED VA B 77	180 600 200	PANEL COVIDER AND CONDUIT 2241-103-8FC 2441-103-8FC 2441-	B P 1 1 1 1 1 1 1 1 1 1 1 1 1 1 1 1 1 1	RS N KR 20 20 20 20 20 	RATING: 10 KAC MAX.  LOAD DESCRIPTION  RECEPTACLE: FLEE RM  RECEPTACLE: PUMP RM  RECEPTACLE: POMP RM  RECEPTACLE: POMP RM  RECEPTACLE: POMP RM  RECEPTACLE: POMP RM  SUMP PUMP  SPACE  SPACE  SPACE  SPACE  SPACE  SPACE		CKT NO 2 4 6 8 10 12 14 16 18 20 22

\	OLT	AGE: 120/240V 1PH 3W TYPE:	SE	MENS			PAI	NEL		PANEL COV	ER SI	ALL B	E MARKED "DANGER: POTENTIAL ARC FLASH	HAZA	RD"
N	MIN	USS: 100A MOUNTING:  SIZE: 60A MCB LOCATION:  SERVES:	SUF	RFACE		F	<b>-</b> 1	09		BRANCHCK	ТВК	RS INT.	RATING: 18 KAIC MAX.		
ıт	CKT	LOAD DESCRIPTION		KR	WIRING AND	CONNECTED				WIRING AND	BKR		LOAD DESCRIPTION	CK	
.,	NO		Р	TRIP	CONDUIT	A		В		CONDUIT	Р	TRIP		NO	
M	1	BATTERY CHARGER	1	20	2-12+12G-3/4°C	1440	180			2-12+12G-3/4°C	- 1	20	RECEPTACLE	2	R
M	3	BLOCK HEATER	1	20	2-12+12G-3/4°C			1500	200		1	20	CONTROLS	4	M
M	5	OIL PRE-HEATER	1	20	2-12+12G-3/4°C		500			2-12+12G-3/4°C	1	20	EXTERIOR LTG 1	- 6	C
	7	SPACE	1	-							1	-	SPACE	8	
	9	SPACE	1	-							1	-	SPACE	10	П
	11	SPACE	1	-							1	-	SPACE	12	П
					CONNECTED VA-		2120		1700						
_					TOTAL CONNECT	TED VA:		3820	TOTAL	CONNECTED A:	16		PANEL REQUIRED AMPACITY: 16		
1 VIA 2 POLE ASTRONOMIC TIME CLOCK				LT	LOAD TYPE					VA					
				С	CONTINUOUS	625									
					LARGEST MOTO	R				0					
					MISCELANEOUS					3140					
				R	RECEPTACLES					180					
										3845					

	VAIN	DUG: 400A GIRGU	NT: SU	NOTE			D	P-		9		PANEL GOVERS	SHALI		IARKED "DANGER: POTENTIAL ARC FLASH H INEL AIC: 42,000 SYMM	AZAND'	
	ICK			IKR	WRINGAND			CONNEC	TED VA			WRINGAND	- 8	KR		CK	n
LΤ	NO		P	TRIP	CONDUIT	A		-		-		CONDUIT	p	TRP	LOAD DESCRIPTION	NO	LT
L		PUMP NO. 1	3	175	SEE RISER DIAG	26600	26600					SEE RISER DIAG	3		PUMP NO. 2	2	м
1.	3	-	-	-				20000	26600				-			- 4	
L	5	-	-							26600	26600		-		-	6	M
011	T	PANEL F TRANSFORMER	2	30	3-10,1-100,3/4°C	3700						4-10=1-103	3	30	SFD	0	
М	9		-	-				3750					-	-	-	10	П
		SPACE	1										-		-	12	
		SPACE	1													14	т
		SPACE	1													16	П
	17	SPACE	- 1													19	
	19	SPACE	1	-												20	П
		SPACE	- 1													22	П
	23	SPACE	1													24	П
					CONNECTED VA:		56950		56950		53200						
					TOTAL CONNEC	TED VA:		167100			TOTAL	CONNECTED A:	201		PANEL REQUIRED AMPACITY: 2	25	
				IT	LOAD TYPE					FACTOR	,	VA					
				C	CONTINUOUS					1.25		0					
				Ť	LARGEST MOTO	2				1.25		99750					
				M	MISCELANEOUS					1.00		87300					
				R	RECEPTACLES				0.000								
					RECEPTACLES:												
				K	KIICHEN					0.65		0					
				_			TO	TAL CAL	CLEATE	DIOAD		187050					

HUNSEY • NICOLAIDES • 6

COMSULTING INHORES

460 SH 74H COURT
WHAT TURNING 3355 (MS) 270-8

FL. CA LIC. 4 444

02-04022 REVISION 1 ADDRESS MDC COMMENTS

PANEL SCHECULES AND GENERATOR SPECIFICATIONS


BISCAYNE SHORES PUMP STATIONS No. 109 AND 110 RETROFIT




TRANSPORTATION AND PUBLIC WORKS DEPARTMENT STEPHEN P. CLARK CENTER 111 NW 1ST STREET, 1STH FLOOR MIAMI, FLORIDA 33128

PROJECT NO.	17053.01	SHEET NO.	8
DRAWING NO.	E-7	OF 17	SHEETS

PERMIT SET 02-02-202

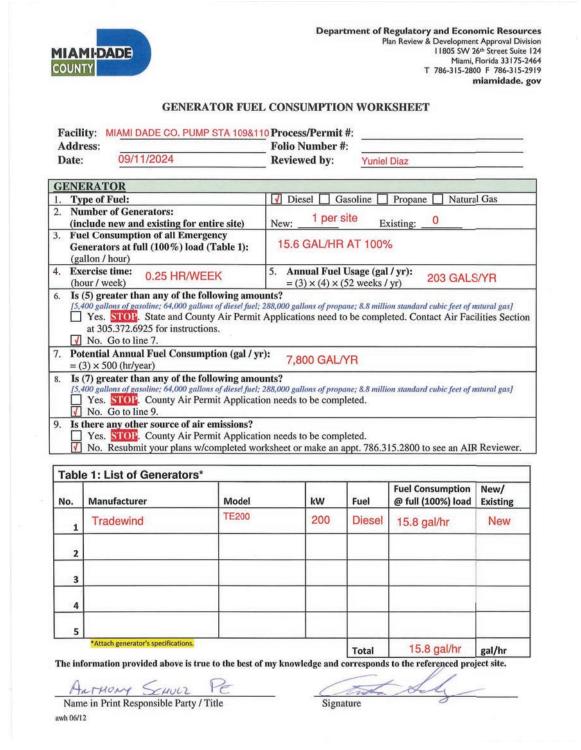

- NOTE: 1- TANK SIZE IS 474 GALLONS
- 2- FUEL TYPE IS DIESEL
- 3- TANK IS A STEEL DOUBLE WALL UL142 4- ALL APPLICABLE EQUIPMENT WILL BE FDEP APPROVED.
- 5- ALL GENERATOR TANKS WILL BE NEW.
  6- TANK TO BE MANUFACTURED BY TRADEWINDS POWER CORP.
- 7— OVERFILL EQUIPMENT IS MANUAL OPERATION.
- 8- INTERSTITIAL SPACE LEAK DETECTION IS WIRED TO THE GENERATOR CONTROL PANEL AND CONNECTED REMOTELY WITH THE SCADA INTERFACE CONNECTION. CONTROL PANEL TO SOUND ALARM UPON LEAK DETECTION.

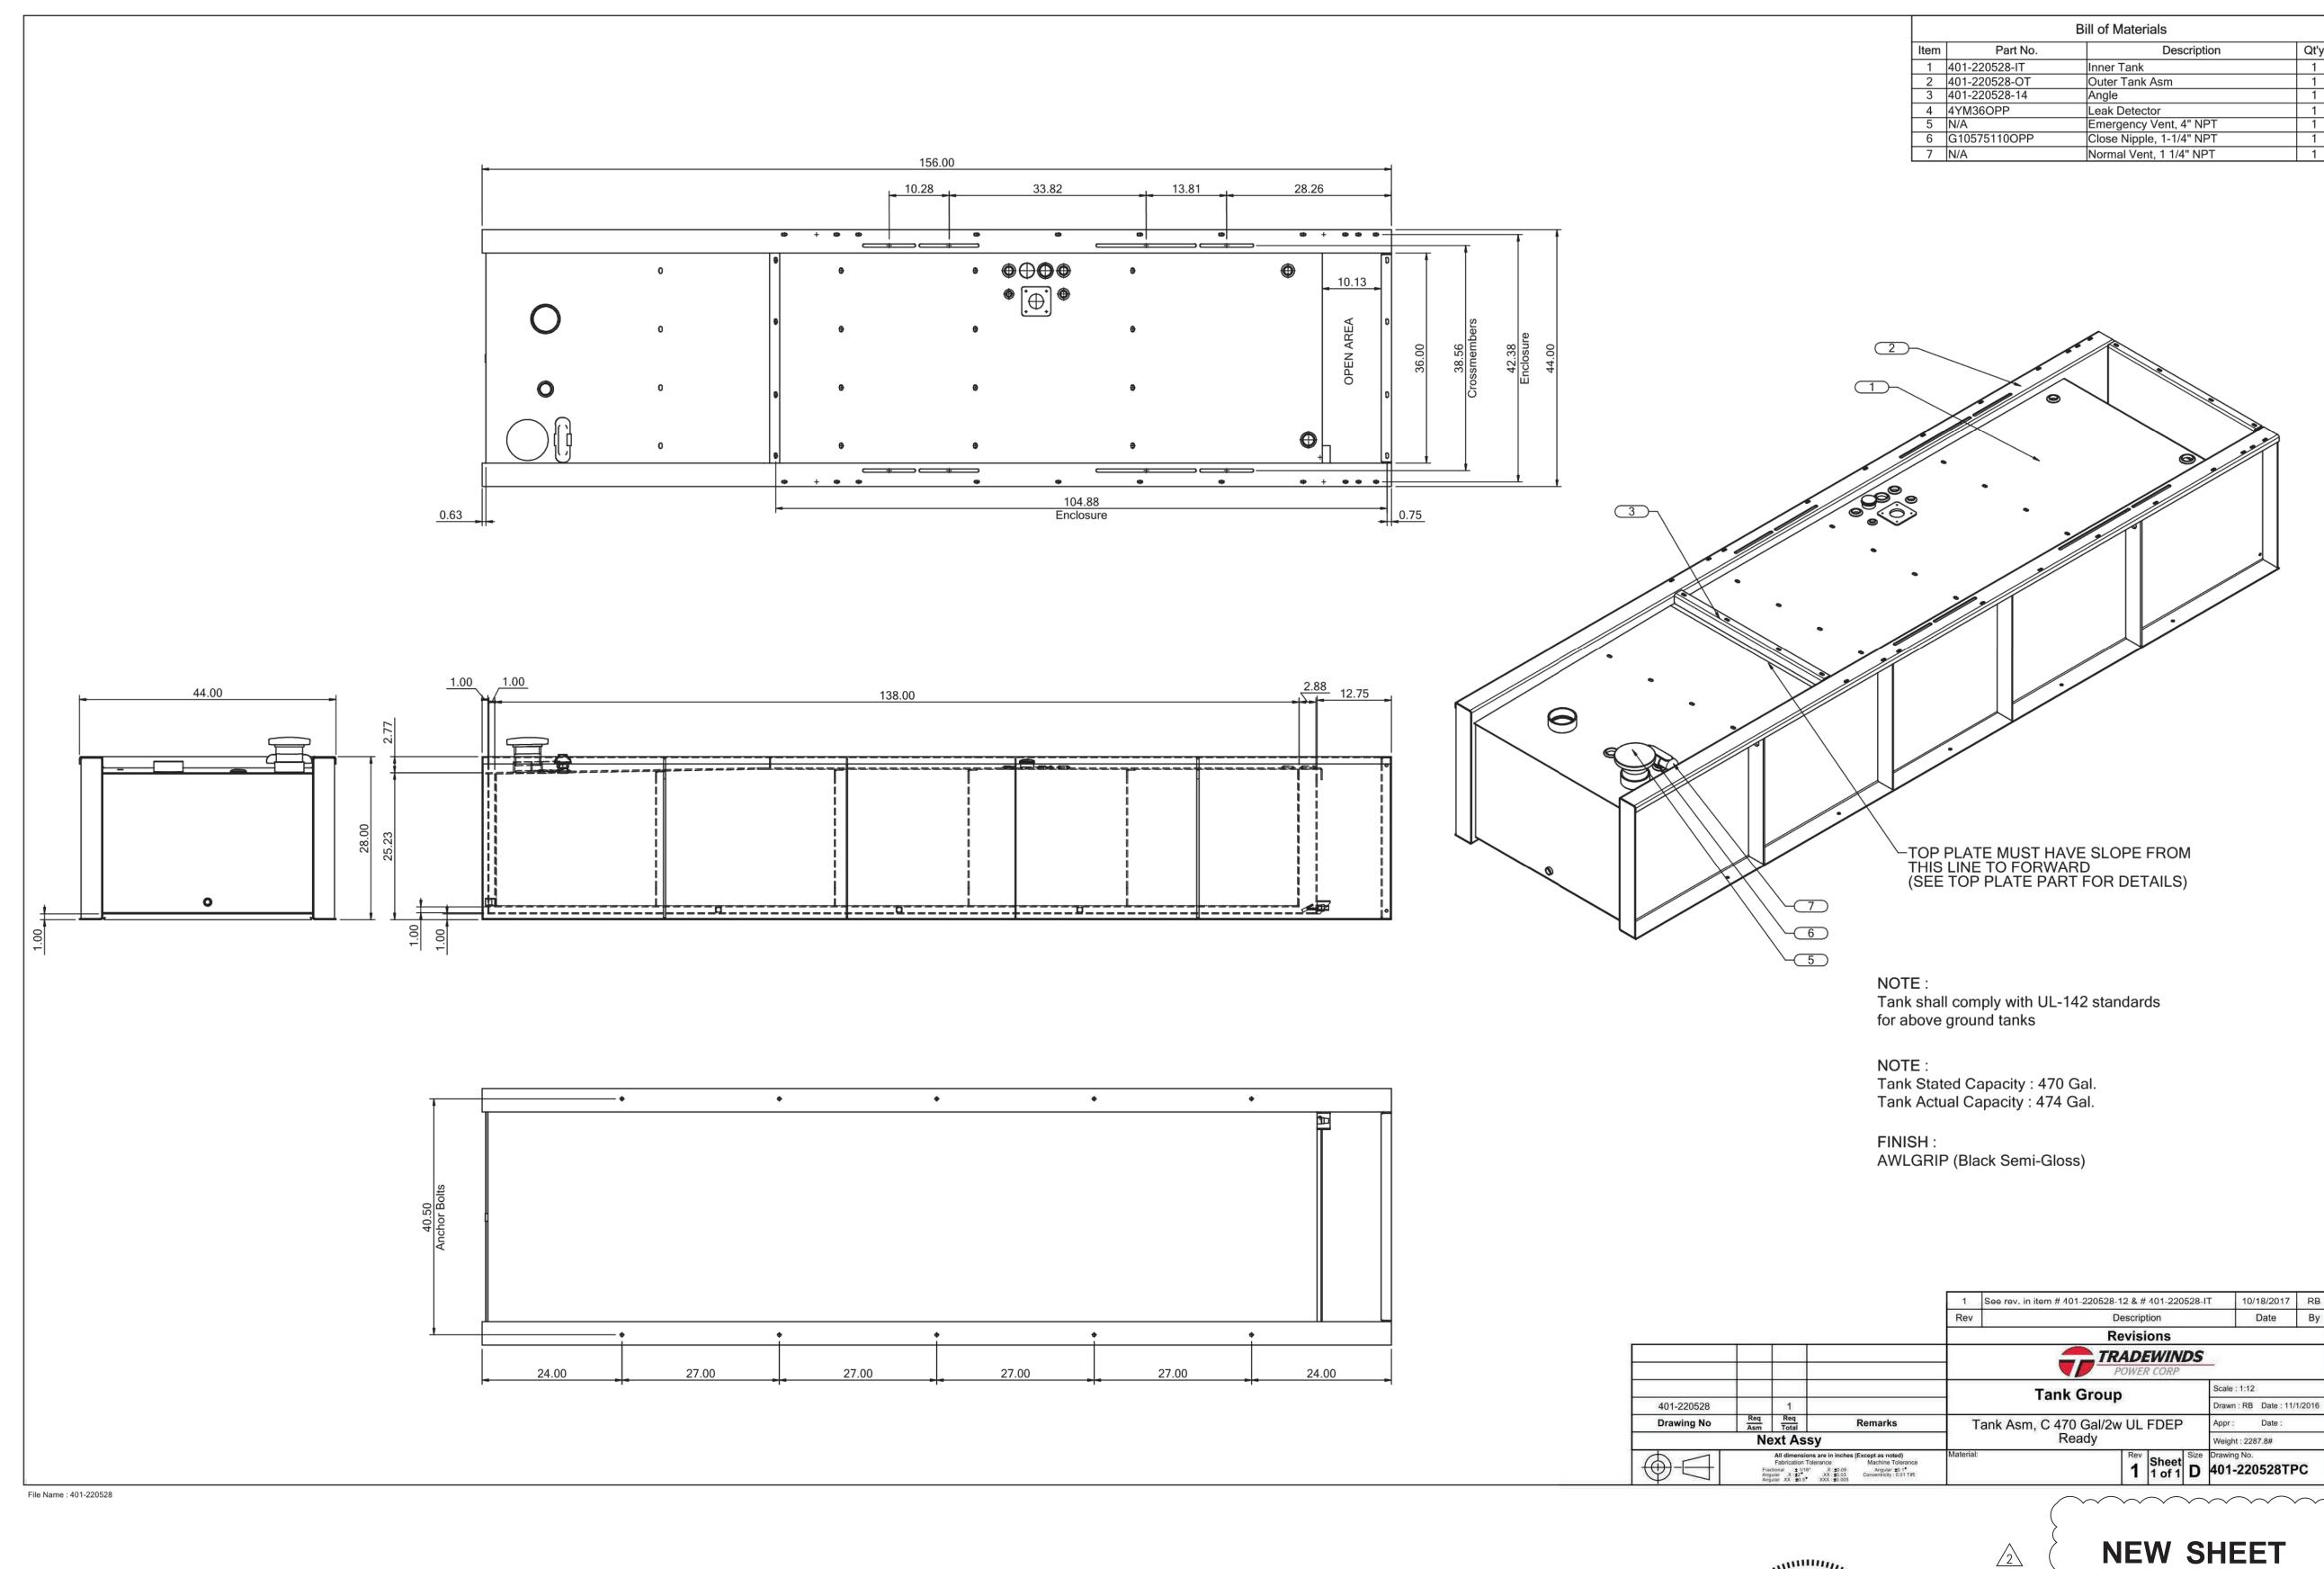

08-29-24 REVISION 2ADDRESS MDC COMMENTS 02-04022 REVISION 1 ADDRESS MDC COMMENTS

DESIGN BY: A.E.W.	DATE: 12/16/19
DRAWN BY:	DATE:
CHECKED BY: A.E.W.	DATE:

GENERATOR TANK DRAWING

BISCAYNE SHORES PUMP STATIONS No. 109 AND 110 RETROFIT



TRANSPORTATION AND
PUBLIC WORKS DEPARTMENT
STEPHEN P. CLARK CENTER
111 NW 1ST STREET, 16TH FLOOR
MIAMI, FLORIDA 33128

DJECT NO.	17053.01	SHEET NO.	9
AWING NO.	E-8	OF 17	SHEETS

ENGINEERS FL CA Lic. # 444

PERMIT SET 02-02-2022

HUFSEY • NICOLAIDES • GARCIA • SUAREZ
CONSULTING ENGINEERS HNGS # 190069