


## PLANS FOR PROPOSED DRAINAGE IMPROVEMENTS TO

## INDEX OF SHEETS

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## EAST MOWRY DRIVE

MIAMI-DADE COUNTY PROJECT NO. 20240057  
FUNDING SOURCE: STORMWATER UTILITY (SWU)

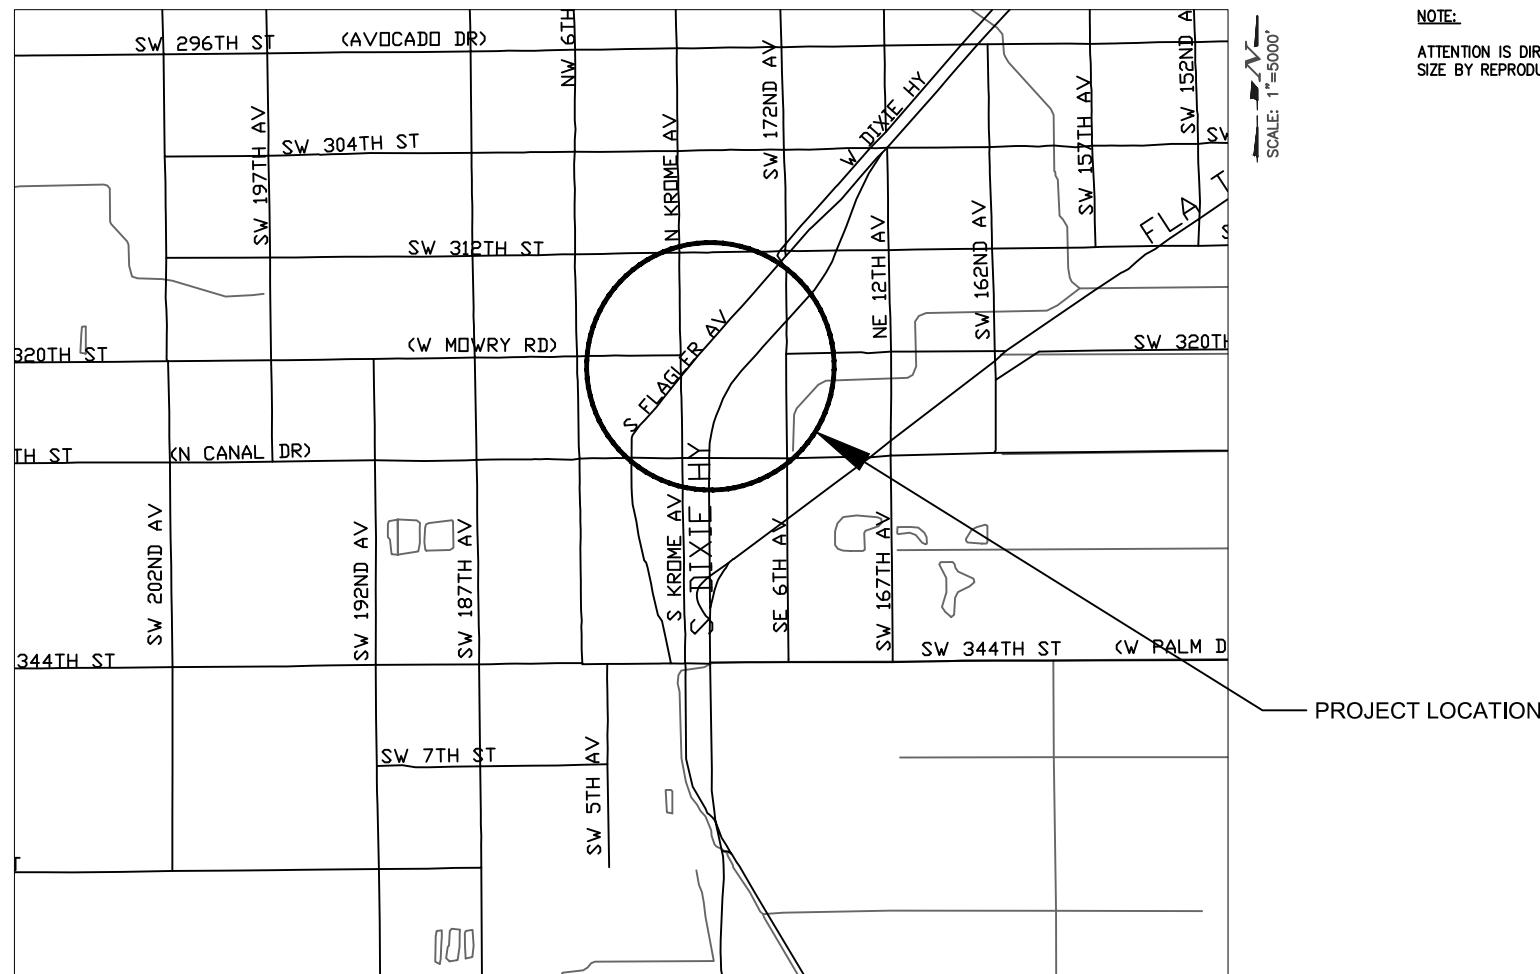



THESE PLANS HAVE BEEN PREPARED IN ACCORDANCE WITH AND ARE GOVERNED BY THE MIAMI-DADE COUNTY PUBLIC WORKS DEPARTMENT STANDARDS AND SPECIFICATIONS PARTS 1, 2 AND 3. THE MANUAL OF UNIFORM MINIMUM STANDARDS FOR DESIGN, CONSTRUCTION AND MAINTENANCE FOR STREETS AND HIGHWAYS. THE FLORIDA DEPARTMENT OF TRANSPORTATION ROADWAY AND TRAFFIC DESIGN STANDARDS, AND THE FLORIDA DEPARTMENT OF TRANSPORTATION STANDARD SPECIFICATIONS, AS AMENDED BY CONTRACT DOCUMENTS.



MIAMI-DADE COUNTY DEPARTMENT OF  
TRANSPORTATION AND PUBLIC WORKS  
ROADWAY ENGINEERING AND  
RIGHT OF WAY DIVISION  
STORMWATER DRAINAGE DESIGN SECTION

STEPHEN P. CLARK CENTER  
111 NW 1 ST, SUITE 1510  
MIAMI, FLORIDA 33128

NOTE:  
ATTENTION IS DIRECTED TO THE FACT THAT THESE PLANS MAY HAVE BEEN REDUCED IN SIZE BY REPRODUCTION. THIS MUST BE CONSIDERED WHEN OBTAINING SCALED DATA.

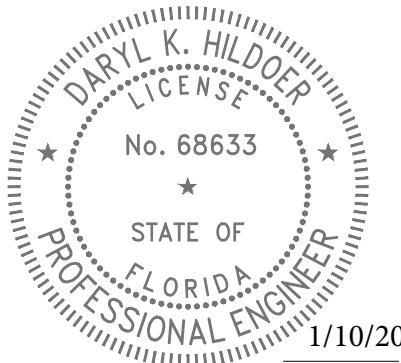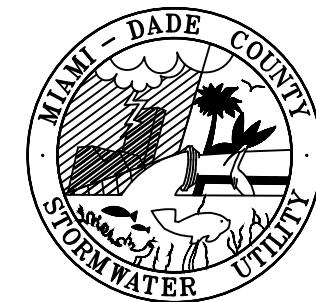

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DESIGN	G.S.	CHECK	L.H.
		DRAWN	E.E.
DATE	08-05-24	SHEET	1 OF 9

**GENERAL NOTES:**

1. ALL ELEVATIONS REFER TO THE MSL, 1929 NATIONAL GEODETIC VERTICAL DATUM (NGVD)
2. ALL DRAINAGE CONSTRUCTION SHALL BE IN STRICT ACCORDANCE WITH THE PERMITTING REQUIREMENTS OF MIAMI DADE COUNTY REGULATORY AND ECONOMIC RESOURCES AND THE MIAMI-DADE COUNTY DEPARTMENT OF TRANSPORTATION AND PUBLIC WORKS.
3. IT IS THE INTENT THESE PLANS TO BE IN ACCORDANCE WITH APPLICABLE CODES AND AUTHORITIES HAVING JURISDICTION. ANY DISCREPANCIES BETWEEN THESE PLANS AND APPLICABLE CODES SHALL BE IMMEDIATELY BROUGHT TO THE ATTENTION OF THE ENGINEER.
4. CATCH BASINS, SEEPAGE DRAINS, PAVEMENT RESTORATION AND PAVEMENT AROUND CATCH BASINS TO BE ACCORDING TO THE DETAILS AND APPLICABLE REQUIREMENTS OF THE MIAMI-DADE COUNTY DEPARTMENT OF TRANSPORTATION AND PUBLIC WORKS.
5. WHERE NEW PAVEMENT MEETS EXISTING, CONNECTION SHALL BE MADE IN A NEAT STRAIGHT LINE AND FLUSH WITH EXISTING PAVEMENT.
6. CONTRACTOR IS TO VERIFY THE EXACT LOCATION OF ALL EXISTING TREES, STRUCTURES, AND UTILITIES WHICH MAY NOT BE SHOWN ON PLANS. ANY EXISTING STRUCTURE, PAVEMENT, TREES OR OTHER EXISTING IMPROVEMENT NOT SPECIFIED FOR REMOVAL WHICH IS TEMPORARILY DAMAGED, EXPOSED OR IN ANY WAY DISTURBED BY CONSTRUCTION PERFORMED UNDER THIS CONTRACT, SHALL BE REPAIRED, PATCHED OR REPLACED AT NO ADDITIONAL COST TO THE OWNER.
7. THE LOCATION AND SIZE OF ALL EXISTING UTILITIES SHOWN ON THESE DRAWINGS ARE APPROXIMATE; ADDITIONAL UTILITIES MAY EXIST WHICH ARE NOT SHOWN ON THESE DRAWINGS. THE CONTRACTOR SHALL BE RESPONSIBLE FOR THE LOCATION OF ALL EXISTING UTILITIES. THE CONTRACTOR SHALL VERIFY ALL UTILITIES BY ELECTRONIC METHODS AND BY HAND EXCAVATION IN COORDINATION WITH ALL UTILITY COMPANIES; PRIOR TO BEGINNING ANY CONSTRUCTION OPERATION, ANY AND ALL CONFLICTS OF EXISTING UTILITIES WITH PROPOSED IMPROVEMENTS MUST BE RESOLVED BY THE ENGINEER AND THE OWNER. THIS WORK BY THE CONTRACTOR SHALL BE CONSIDERED INCIDENTAL TO THE CONTRACT AND NO ADDITIONAL COMPENSATION SHALL BE ALLOWED.
8. CONTRACTOR SHALL CONTACT THE SUNSHINE STATE ONE CALL OF FLORIDA, INC. AT 1 (800) 432-4770 AT LEAST 48 HOURS PRIOR TO PERFORMING ANY DIGGING TO VERIFY THE EXACT LOCATION OF EXISTING UTILITIES.
9. EXISTING TREES SHALL BE REMOVED ONLY IF REQUIRED FOR CONSTRUCTION. THOSE TREES NOT INTERFERING WITH CONSTRUCTION SHALL BE PROTECTED IN PLACE. THE CONTRACTOR IS ADVISED THAT A TREE PERMIT MAY BE REQUIRED FOR TREE REMOVAL. CONTRACTOR SHALL NOTIFY REGULATORY AND ECONOMIC RESOURCES DEPARTMENT AND MUNICIPALITIES WITH JURISDICTION PRIOR TO REMOVING ANY TREES.
10. EXISTING GRADES WERE TAKEN FROM THE BEST AVAILABLE DATA AND MAY NOT ACCURATELY REFLECT PRESENT CONDITIONS. CONTRACTOR SHALL BE RESPONSIBLE FOR FAMILIARIZING HIMSELF WITH CURRENT SITE CONDITIONS, AND SHALL REPORT ANY DISCREPANCIES TO THE ENGINEER PRIOR TO STARTING WORK.
11. THE CONTRACTOR SHALL PREPARE AND SUBMIT SHOP DRAWINGS FOR ALL ITEMS LISTED IN PROJECT SPECIFICATION.
12. UNDER NO CIRCUMSTANCES SHALL THE CONTRACTOR LEAVE EXCAVATED TRENCHES, OR PARTS OF, EXPOSED OR OPEN AT THE END OF THE WORKING DAY, WEEKENDS, HOLIDAYS OR OTHER TIMES. WHEN THE CONTRACTOR IS NOT WORKING, UNLESS OTHERWISE DETERMINED, ANY TRENCH SHALL BE COVERED, FIRMLY SECURED AND MARKED ACCORDINGLY FOR PEDESTRIAN TRAFFIC.
13. THE CONTRACTOR SHALL MAINTAIN ACCESS TO ALL ADJACENT PROPERTIES AT ALL TIMES.
14. ALL EXCAVATED MATERIAL REMOVED FROM THIS PROJECT SHALL BE DISPOSED OF PROPERLY BY THE CONTRACTOR AT THE CONTRACTOR'S EXPENSE.
15. CAST IRON PRODUCTS: HEAVY-DUTY CLASSIFICATION SUITABLE FOR HIGHWAY TRAFFIC LOADS, OR 16,000 LB. WHEEL LOADS.
16. STEEL GRATING AND COVERS: TRAFFIC CLASSIFICATION H-20 AASHTO H20: 16,000 LBS. OVER 8" X 20" AREA.
17. ALL STRUCTURES MUST BE CAPABLE OF SUSTAINING HEAVY TRAFFIC LOADS.
18. ALL GRASS AREAS AFFECTED BY CONSTRUCTION SHALL BE RE-SODDED.
19. THE CONTRACTOR SHALL BE RESPONSIBLE FOR THE PROVISION, INSTALLATION AND MAINTENANCE OF ALL TRAFFIC CONTROL AND SAFETY DEVICES, IN ACCORDANCE WITH SPECIFICATIONS OUTLINED IN SECTION C2 AND SECTION R19 OF THE PUBLIC WORKS DEPARTMENT MANUAL. IN ADDITION, THE CONTRACTOR IS RESPONSIBLE FOR THE RESETTING OF ALL TRAFFIC CONTROL AND INFORMATION SIGNING REMOVED DURING CONSTRUCTION PERIOD.
20. EXCAVATED OR OTHER MATERIAL STORED ADJACENT TO OR PARTIALLY UPON A ROADWAY PAVEMENT SHALL BE ADEQUATELY MARKED FOR TRAFFIC SAFETY AT ALL TIMES.
21. TEMPORARY PATCH MATERIAL MUST BE ON THE JOB SITE WHENEVER PAVEMENT IS CUT, OR THE INSPECTOR WILL SHUT THE JOB DOWN.
22. CONTRACTOR SHALL MAINTAIN TRAFFIC ACCORDING TO CORRESPONDING TYPICAL CONTROL DETAIL AS OUTLINED IN MIAMI-DADE COUNTY PUBLIC WORKS MANUAL.
23. CONTRACTOR SHALL MAINTAIN AT LEAST THE FOLLOWING NUMBER OF TRAFFIC LANES FOR CORRESPONDING TIME PERIODS: MONDAY - FRIDAY 7-9 A.M. AND 4-6 P.M.; NO INTERRUPTION TO TRAFFIC IS PERMITTED. ALL OTHER TIMES:
  - A) MAINTAIN ONE LANE FOR TWO-WAY OPERATION WITH FLAGMAN.
  - B) MAINTAIN ONE LANE IN EACH DIRECTION FOR TRAFFIC.
24. CONTRACTOR MUST PROVIDE FLASHER ARROW BOARD FOR ANY LANE THAT IS CLOSED OR DIVERTED.
25. CONTRACTOR SHALL NOTIFY LAW ENFORCEMENT AND FIRE PROTECTION SERVICES TWENTY-FOUR (24) HOURS IN ADVANCE OF THE DETOUR IN ACCORDANCE WITH SECTION 336.07 OF FLORIDA STATUTES.
26. COMPLETE AS-BUILT INFORMATION RELATIVE TO LOCATION AND DEPTH OF PIPES, MANHOLES, ETC. SHALL BE ACCURATELY RECORDED BY THE CONTRACTOR. THREE (3) SETS LABELED "AS-BUILT" MUST BE SUBMITTED, SIGNED AND SEALED BY A PROFESSIONAL ENGINEER REGISTERED IN THE STATE OF FLORIDA, TO THE ENGINEER OF RECORD PRIOR TO FINAL ACCEPTANCE OF THE WORK.
27. IT IS RESPONSIBILITY OF THE CONTRACTOR TO SELECT AND OBTAIN THE APPROPRIATE PERMISSION FROM MIAMI-DADE COUNTY OR APPLICABLE AGENCY THAT HAS JURISDICTION ON THE "PROPOSED" STAGING AREAS.

28. DRAINAGE/UTILITY TRENCHES SHALL NOT BE LEFT OPEN OVERNIGHT. A TEMPORARY COVER WITH A CAPACITY OF H-20 LOADING SHALL BE PLACED AS DIRECTED BY THE ENGINEER AT NO EXTRA COST TO MIAMI-DADE COUNTY.

29. PROVIDE FLOWABLE FILL OVER PIPE AS COVER WHERE MINIMUM PIPE COVER OF 2 FEET CANNOT BE ACCOMPLISHED UNDER PAVED AREAS. HOWEVER, THE COVER WITH FLOWABLE FILL SHALL BE NO LESS THAN 12 INCHES.

30. ALL STATIONS AND OFFSETS REFER TO [CENTERLINE] [BASELINE] OF CONSTRUCTION, UNLESS OTHERWISE STATED.

31. CONTRACTOR SHALL COMPLY WITH THE REQUIREMENTS OF THE EPA AND THE NATIONAL POLLUTION DISCHARGE ELIMINATION SYSTEM (NPDES).

32. MIAMI-DADE WATER AND SEWER DEPARTMENT REQUIRES THAT ACCESS TO ALL WATER AND SEWER VALVES, SANITARY MANHOLES, AND OTHER CONTROL MECHANISMS BE MAINTAINED THROUGHOUT CONSTRUCTION IN THE EVENT OF AN EMERGENCY TO ENSURE THE PUBLIC HEALTH AND SAFETY. COVERING VALVE BOXES AND MANHOLES CAN BE CONSIDERED UNAUTHORIZED CONSTRUCTION OF AND TAMPERING WITH DEPARTMENT UTILITIES. ALL REQUESTS FOR UTILITY ADJUSTMENTS MUST BE MADE IN WRITING AT LEAST TWO (2) WEEKS IN ADVANCE. FOR MANHOLE AND VALVES, CONTACT UTILITY COORDINATOR PATRICK CHONG AT 786-268-5255. THE DEPARTMENT WILL MAKE ONE FINAL AND PERMANENT ADJUSTMENT AT NO COST TO THE REQUESTING AGENCY. FOR THE ADJUSTMENT OF WATER METERS, CONTACT THE CHIEF OF METER OPERATIONS AND MAINTENANCE: 786-268-5469. FOR ANY FIRE HYDRANTS THAT ARE DAMAGED OR BUMPED DURING CONSTRUCTION, CONTACT THE MDWASD HYDRANT SHOP AT 305-552-4926, BEFORE POURING CONCRETE FOR THE SIDEWALK. IN THE EVENT OF A WATER OR SEWER EMERGENCY, WASD EMERGENCY NUMBER 305-552-8901. THIS LINE IS OPEN 24 HOURS, 7 DAYS A WEEK.

33. THE CONTRACTOR IS ADVISED THAT PROPERTIES ADJACENT TO THE PROJECT HAVE ELECTRIC, TELEPHONE, GAS, WATER AND/OR SEWER SERVICE LATERALS WHICH MAY NOT BE SHOWN IN PLANS. THE CONTRACTOR MUST REQUEST THE LOCATION OF THESE LATERAL SERVICES FROM THE UTILITY COMPANIES. THE ADDITIONAL COST OF EXCAVATING, INSTALLING, BACKFILLING, AND COMPACTING AROUND THESE SERVICES MUST BE INCLUDED IN THE BID RELATED ITEM FOR THE WORK BEING DONE.

34. THE CONTRACTOR SHOULD TAKE SPECIAL NOTE OF SOIL CONDITIONS THROUGHOUT THIS PROJECT. ANY SPECIAL SHORING, SHEETING OR OTHER PROCEDURES NECESSARY TO PROTECT ADJACENT PROPERTY, PUBLIC OR PRIVATE, DURING THE EXCAVATION OF SUBSOIL MATERIAL AND EXFILTRATION TRENCH, OR FILLING OF ANY AREA, OR FOR ANY OPERATION DURING CONSTRUCTION, SHALL BE THE SOLE RESPONSIBILITY OF THE CONTRACTOR.

35. IF SHEETING, SHORING OR DEWATERING, INCLUDING WELL POINTS ARE NECESSARY, THE CONTRACTOR MUST MONITOR AND CONTROL ALL WORK THAT MAY CAUSE CRACKING TO ANY ADJACENT BUILDING, STRUCTURE, OR PROPERTY AREA. THE CONTRACTOR SHALL BE RESPONSIBLE FOR ANY DAMAGES CAUSED BY THESE OPERATIONS. COST OF SHEETING, SHORING, OR DEWATERING, SHALL BE INCLUDED IN THE RELATED BID ITEM FOR THE WORK BEING DONE.

36. ALL DITCH EXCAVATIONS SHALL BE PERFORMED IN FULL COMPLIANCE WITH THE PROVISIONS OF THE TRENCH SAFETY ACT.

37. ANY KNOWN OR SUSPECTED HAZARDOUS MATERIAL FOUND ON THE PROJECT BY THE CONTRACTOR SHALL BE IMMEDIATELY REPORTED TO THE PROJECT ENGINEER, WHO SHALL DIRECT THE CONTRACTOR TO PROTECT THE AREA OF KNOWN OR SUSPECTED CONTAMINATION FROM FURTHER ACCESS. THE ENGINEER WILL ARRANGE FOR INVESTIGATION, IDENTIFICATION, AND REMEDIATION OF THE HAZARDOUS MATERIAL. THE CONTRACTOR SHALL NOT RETURN TO THE AREA OF CONTAMINATION UNTIL APPROVAL IS PROVIDED BY THE PROJECT ENGINEER.

38. THE CONTRACTOR SHALL USE A STREET SWEEPER (USING WATER) OR OTHER EQUIPMENT CAPABLE OF CONTROLLING AND REMOVING DUST. APPROVAL OF THE USE OF SUCH EQUIPMENT IS CONTINGENT UPON ITS DEMONSTRATED ABILITY TO DO THE WORK.

39. WHEN DISSIMILAR MATERIAL CONNECTIONS ARE MADE, SUCH AS CONCRETE TO METAL, THE DISSIMILAR MATERIAL SHALL BE SEPARATED BY COATING THE CONTACT SURFACE WITH BITUMASTIC MATERIAL.

40. PRIOR TO CONSTRUCTION THE CONTRACTOR WILL INSPECT ALL EXISTING STRUCTURES WHICH ARE TO REMAIN AND NOTIFY THE ENGINEER OF ANY OBVIOUS STRUCTURAL DEFICIENCIES.

41. WHERE CONNECTIONS TO EXISTING SIDEWALKS AND DRIVEWAYS ARE NOT INDICATED ON PLANS, PROPER CONNECTIONS ARE TO BE MADE AS DIRECTED BY THE ENGINEER. DROP CURB AND DRIVEWAY CONNECTIONS SHALL BE PROVIDED FOR ACCESS TO ALL PRIVATE PROPERTIES ADJACENT TO THE PROJECT. PAYMENT SHALL BE INCLUDED IN THE COST OF RELATED BID ITEMS.

42. CONTRACTOR TO INSTALL  $\frac{1}{2}$ " PERFORMED EXPANSION JOINT WHEN PROPOSED SIDEWALK IMPROVEMENTS IS IMMEDIATELY ADJACENT TO EXISTING CONCRETE SLAB AND/OR BUILDING.

43. THE SIDEWALK AT DRIVEWAY TURNOUTS SHALL BE 6" CONCRETE.


44. ALL BUS STOP SIGNS TO BE FURNISHED BY MIAMI-DADE TRANSPORTATION AND PUBLIC WORKS DEPARTMENT. ENGINEER TO CONTACT MIAMI-DADE COUNTY TRANSPORTATION AND PUBLIC WORKS DEPARTMENT AT (305) 637-3753 ONE (1) WEEK PRIOR TO POURING SIDEWALKS AND COORDINATE THE REMOVAL AND REPLACEMENT OF BUS STOP SIGNS AND BENCHES.

45. THE INFORMATION PROVIDED IN THESE DRAWINGS IS SOLELY TO ASSIST THE CONTRACTOR IN ASSESSING THE NATURE AND EXTENT OF CONDITIONS WHICH WILL BE ENCOUNTERED DURING THE COURSE OF WORK. THE CONTRACTORS ARE DIRECTED, PRIOR TO BIDDING, TO CONDUCT WHATEVER INVESTIGATIONS THEY DEEM NECESSARY TO ARRIVE AT THEIR OWN CONCLUSION REGARDING THE ACTUAL CONDITIONS THAT WILL BE ENCOUNTERED AND UPON WHICH BIDS WILL BE BASED.

46. ANY SURVEY MONUMENT, BENCH MARK, ETC., FOUND DURING CONSTRUCTION ACTIVITIES ARE TO BE RESTORED TO ITS ORIGINAL LOCATION AND COORDINATES AS DEPICTED IN COUNTY RECORDS PLAT AND BOOK. RESTORATION WILL BE AT NO ADDITIONAL COST AND MUST BE SHOWN ON AS-BUILT PLANS.

47. FOR THE INSTALLATION OF SOD IN SWALE AREAS ADJACENT TO ROADWAYS, SIDEWALKS, DRIVEWAY APPROACHES OR ANY OTHER PAVED SURFACES, THE SWALE MUST BE RESTORED TO FORM A "V" SHAPE AS PER THE DETAILS INCLUDED IN THE MIAMI DADE COUNTY PUBLIC WORKS MANUAL. SPECIFICALLY, THE ELEVATION OF THE TOP OF THE SOD MUST MATCH THE ABUTTING AREAS (EDGE OF PAVEMENT, SIDEWALK OR DRIVEWAY APPROACH) AND THE CENTERLINE OF THE SWALE SHALL BE ON AVERAGE 3 INCHES BELOW THE ROADWAY EDGE OF PAVEMENT ELEVATION UNLESS OTHERWISE DIRECTED BY THE ENGINEER.

48. ANY DRAINAGE IMPROVEMENT PROJECT REQUIRING THE RESURFACING OF THE ENTIRE ROADWAY INTERSECTION WILL REQUIRE THE CONTRACTOR TO UPGRADE THE EXISTING RAMPS AND CONNECTORS SITUATED WITHIN THE INTERSECTION TO ADA STANDARDS, AS NECESSARY. IF NO RAMPS AND CONNECTORS ARE PRESENT, THE CONTRACTOR MUST INSTALL NEW ADA COMPLIANT SIDEWALK RAMPS AND CONNECTORS. THIS REQUIREMENT IS CONTINGENT UPON THE PRESENCE OF EXISTING SIDEWALKS REQUIRING CONNECTION.

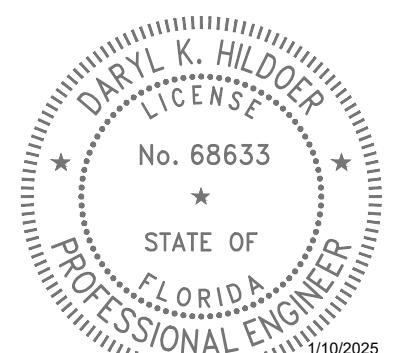

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REVISIONS					
DATE	BY	DESCRIPTION	DATE	BY	DESCRIPTION

EAST MOWRY DRIVE

DESIGNED BY	G.S.	DATE	DRAWN BY	E.E.	DATE
CHECKED BY	L.H.		CHECKED BY		
SUPERVISED BY:					

DEPARTMENT OF TRANSPORTATION  
AND PUBLIC WORKS  
ROADWAY ENGINEERING AND  
RIGHT OF WAY DIVISION  
STEPHEN P. CLARK CENTER  
MIAMI, FLORIDA 33126

GENERAL NOTES

# SURVEYOR'S NOTES:

- Survey performed by DTPW Survey Section.
- Survey Date: 01-18-24
- Survey as per
- F.B. 3003 Page 46-48
- (Krome AV and Mowry DR)
- The elevations are based on NGVD 1929, Miami Dade County
- BM-Name = X-50R
- BM Elev = 8.19'
- SW 320 ST = 18' North of C/L; SW 177 AVE = 53' E of C/L
- R/R Tracks = 37' NW of NW Rail

PK nail and Alum. Washer in concrete sidewalk.

- Section 18, Township 57, Range 39.
- Benchmark for vertical control information was recorded by DTPW Survey Section.
- Right-of-Way Lines shown hereon as per existing plats.

## LOCATION MAP & KEY MAP




**KEY SHEET**  
**TRS 57-39-18**

## LEGEND AND ABBREVIATIONS:

(M)	= MEASURES
(P)	= BY PLAT
F; Fd	= FOUND
CND	= CONCRETE NAIL & DISK
PKF	= PK NAIL FOUND
CNDF	= CONCRETE NAIL & DISK FOUND
CNF	= CONCRETE NAIL & DISK FOUND
CNC	= CONCRETE NAIL CUT
DHF	= DRILL HOLE FOUND
NF	= NAIL FOUND
PKDF	= PK NAIL & DISK FOUND
R/W	= RIGHT OF WAY
RBAC	= ROCK BASE ASPHALT COMPO.
R	= BASE LINE
R	= CENTER LINE
R	= RADIUS
L	= LENGTH OF CURVE
C&G	= CURB & GUTTER
VG	= VALLEY GUTTER
E/P	= EDGE OF PAVEMENT
T/B	= TOP OF BANK
E/W	= EDGE OF WATER
PCP	= PERMANENT CONTROL POINT
RLS	= REGISTERED LAND SURVEYOR
PLS	= PROFESSIONAL LAND SURVEYOR
¶	= STREET SIGN
—	= ALUM. FLASHING SCHOOL LIGH
□	= MAILBOX
●	= DECORATIVE LIGHT POLE
○	= METAL LIGHT POLE
◎	= METAL TRAFFIC LIGHT POLE
⊗	= METAL POWER POLE
□	= CONCRETE LIGHT POLE
⊗	= CONCRETE POWER POLE
○	= WOOD LIGHT POLE
⊗	= WOOD POWER POLE
○	= WOOD TELEPHONE POLE
⊗	= FIBERGLASS LIGHT POLE
○	= WATER MANHOLE
○	= SANITARY MANHOLE
○	= SANITARY SEWER VALVE (FM)
○	= CABLE TV PEDESTRIAN
○	= TV CABLE RISER BOX
○	= TV CONTROL BOX
○	= CABLE BOX
○	= TELEPHONE HANDHOLE
○	= TELEPHONE MANHOLE
○	= TELEPHONE UTILITY BOX
○	= TELEPHONE RISER BOX
○	= TELEPHONE RISER CONTROL
○	= TELEPHONE CONTROL BOX
○	= BOX
×	= CROSSING SIGN
○	= POST
○	= INTERCOM
○	= GAS VALVE
○	= PVC POST
○	= GUY WIRE
○	= SPRINKLE HEAD
○	= CENTRAL ANGLE OF CURVE
○	= MONITORING WELL
○	= PETROLEUM PIPELINE
○	= ELECTRIC HANDHOLE
○	= ELECTRIC MANHOLE
○	= FIRE HYDRANT
○	= WATER VALVE
○	= WATER METER
○	= TRAFFIC SIGN MANHOLE
○	= TRAFFIC SIGN HANDHOLE
○	= TRAFFIC CONTROL BOX
○	= TRAFFIC SIGNAL BOX
○	= ELECTRICAL CONTROL BOX
○	= RAIL ROAD CROSSING (LIGHT)

	= CONCRETE
	= ASPHALT
	= UNIMPROVED DRIVEWAY
	= GRAVEL
	= BRICK
	= STAMPED CONCRETE
	= CONCRETE BLOCK FENCE
◇	= TREE DIAMETER
○	= EXISTING CATCH BASIN
○	= EXISTING STORMWATER MANHOLE
○	= PROPOSED CATCH BASIN
○	= PROPOSED STORMWATER MANHOLE
—	= EXISTING SOLID PIPE
—	= EXISTING FRENCH DRAIN
—	= PROPOSED SOLID PIPE
—	= PROPOSED FRENCH DRAIN
—	= RIGHT-OF-WAY LINE
—	= WOOD FENCE
—	= CHAIN LINK FENCE
—	= IRON FENCE
—	= EXISTING SIDEWALK
—	= F.P.L. OVERHEAD
—	= F.P.L. UNDERGROUND
—	= WATER LINE MAIN
—	= GAS MAIN
—	= FORCE MAIN
—	= CABLE TV
—	= BELL SOUTH TELEPHONE CONDUIT
—	= BASELINE
—	= SANITARY SEWER

	AVOCADO TREE
	ARECA TREE
	AUST. PINE TREE
	ALMOND TREE
	BLACK OLIVE TREE
	MANGO TREE
	BOTTLE BRUSH TREE
	BISMARCK PALM
	BUSH TREE
	BISCHOFIA TREE
	BOTTLE PALM
	BANANA TREE
	BANYAN TREE
	BRAZILIAN PEPPER
	CABBAGE TREE
	COCONUT TREE
	CLUSTER PALM
	CYPRESS TREE
	CANARY PALM
	COCOS PLUMOSA
	CACTUS
	DATE PALM
	FICUS TREE
	FLORIDA ORCHID TREE
	FOX TAIL TREE
	GUMBO LIMBO TREE
	HIBISCUS TREE
	IXORA TREE
	JUNIPER TREE
	JACARANDA TREE
	KAPOK TREE
	HEDGES

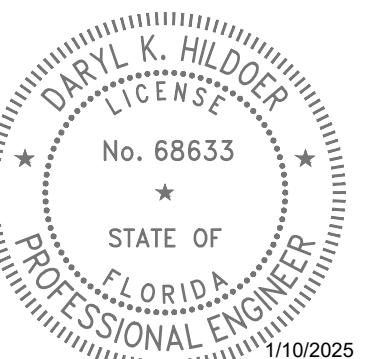

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EAST MOWRY DRIVE


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CHECKED BY	L.H.		CHECKED BY	
SUPERVISED BY				




DEPARTMENT OF TRANSPORTATION  
AND PUBLIC WORKS  
ROADWAY ENGINEERING AND  
RIGHT OF WAY DIVISION  
STEPHEN P. CLARK CENTER  
MIAMI, FLORIDA 33128

SURVEYOR'S NOTES, KEY SHEET  
LEGEND AND ABBREVIATIONS

SCALE: 1" = 30'

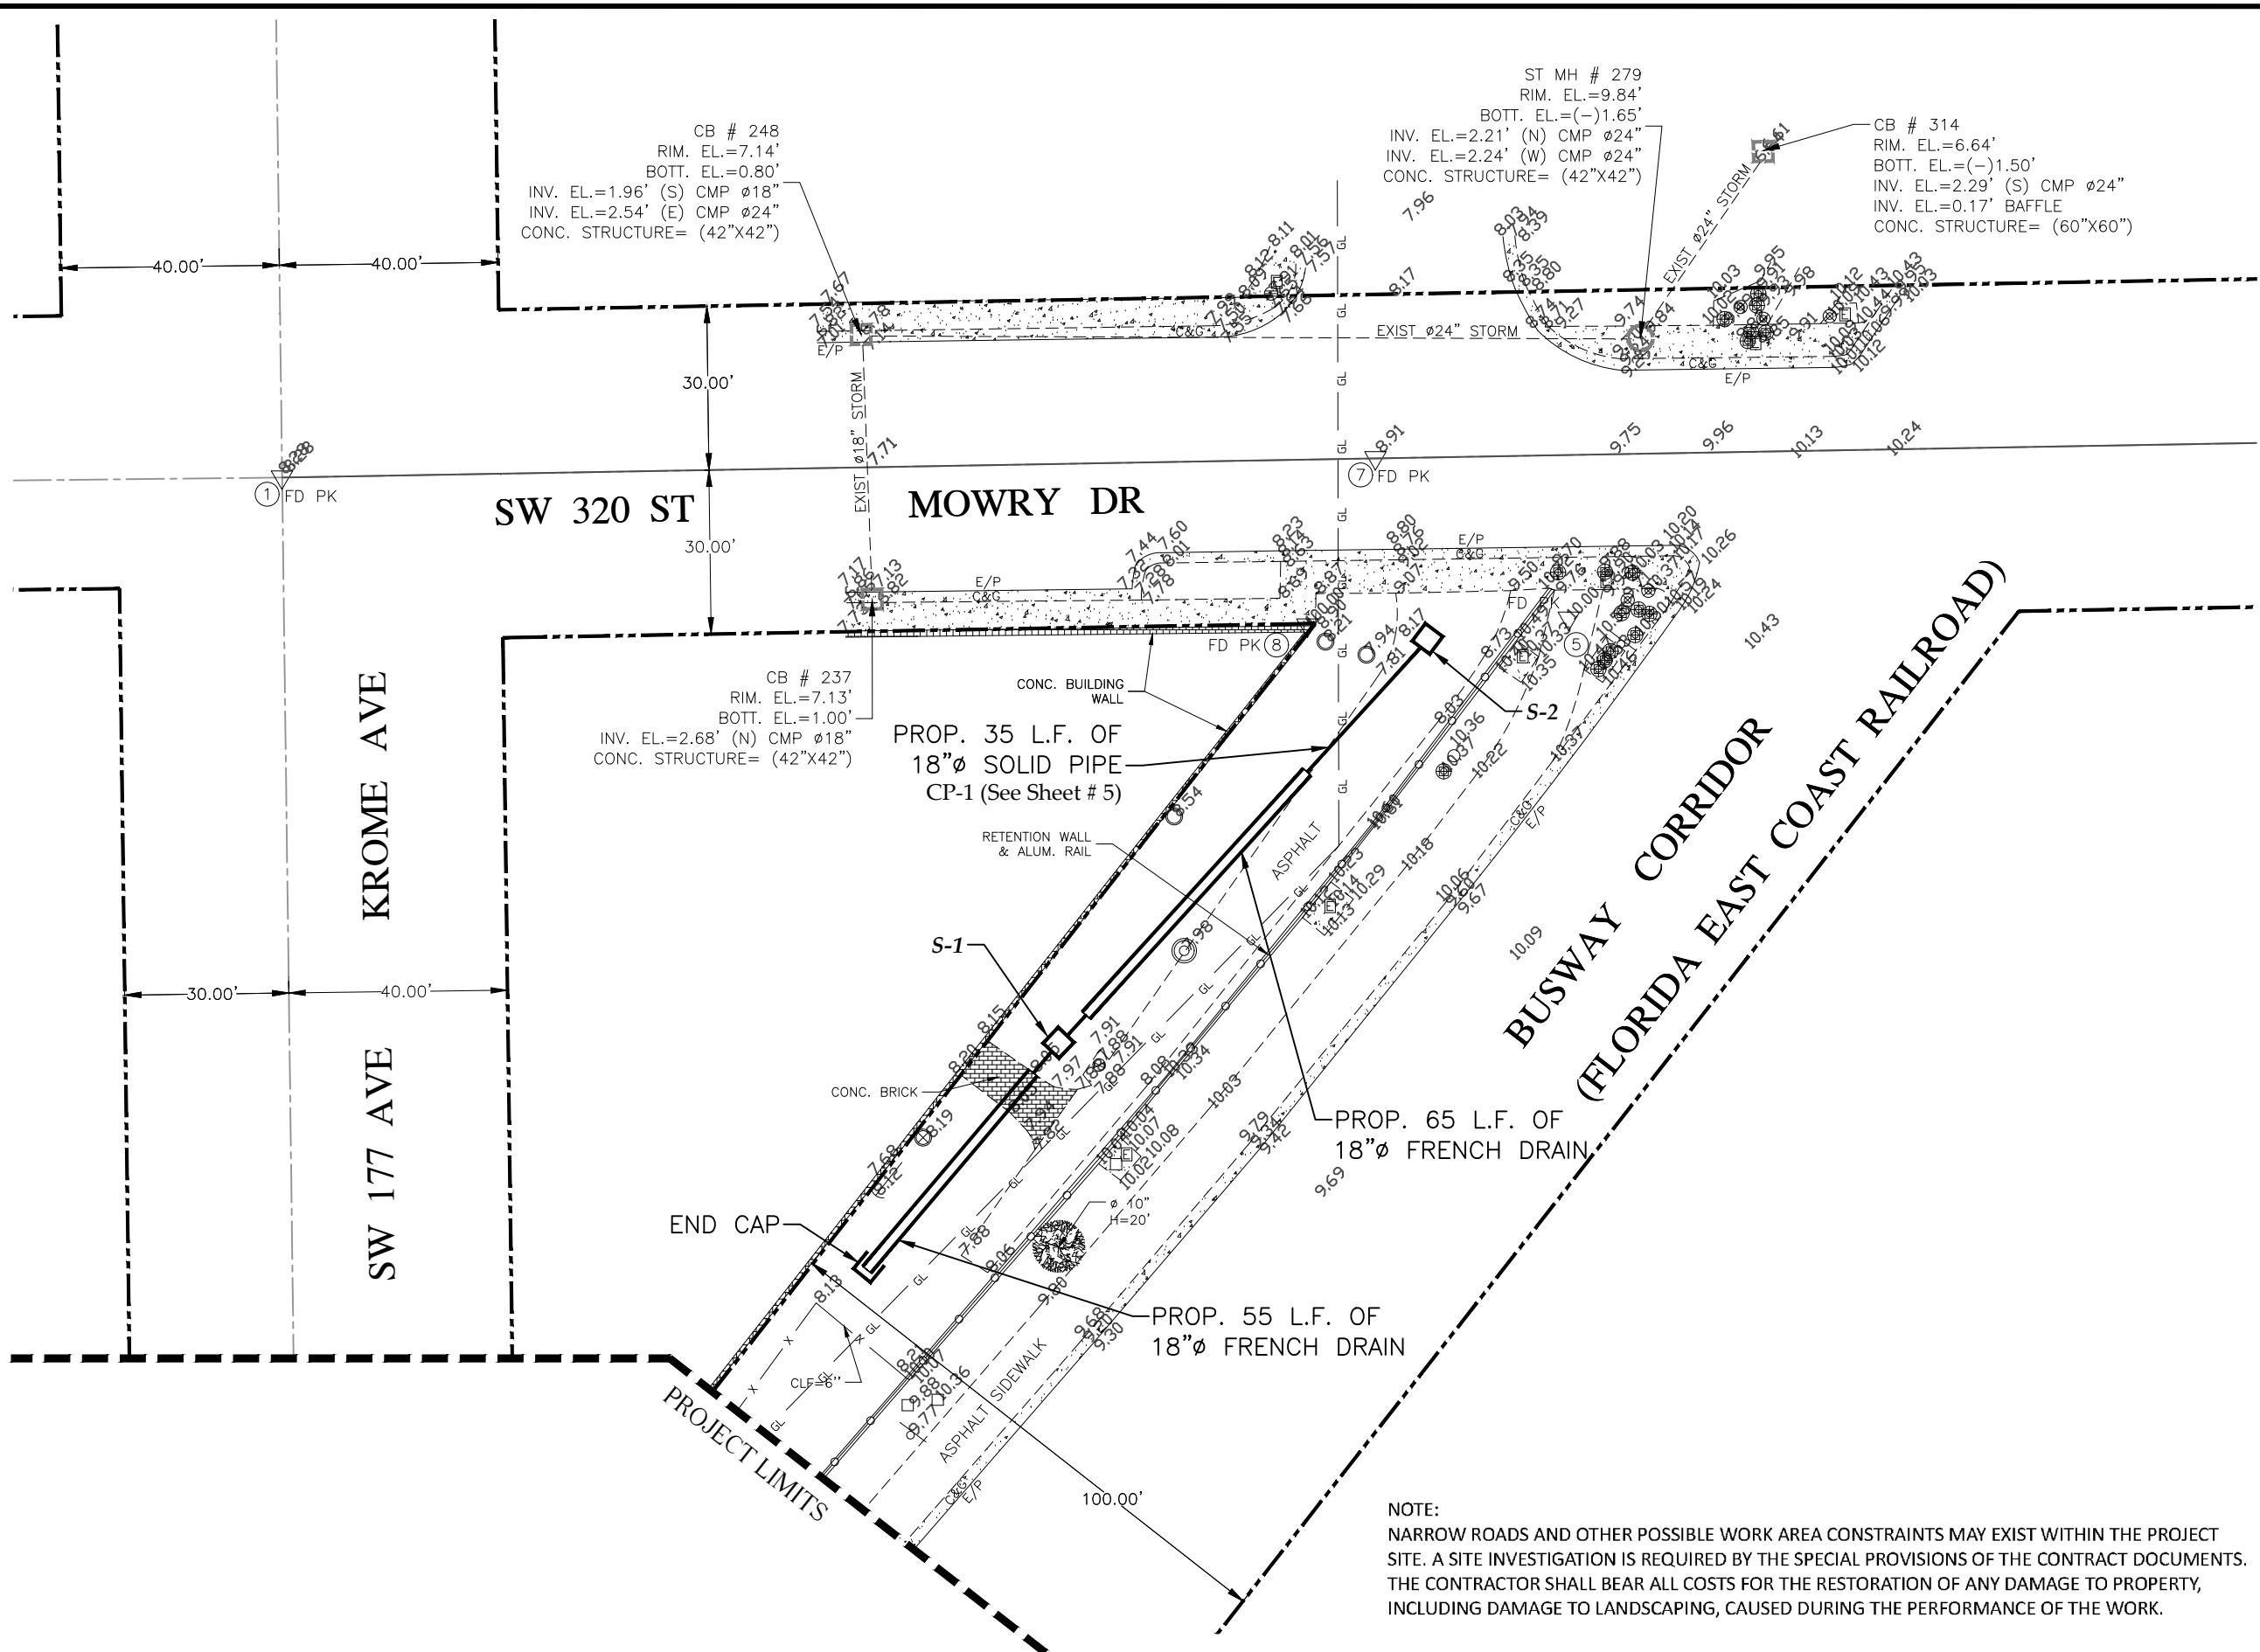

NOTE:  
NARROW ROADS AND OTHER POSSIBLE WORK AREA CONSTRAINTS MAY EXIST WITHIN THE PROJECT SITE. A SITE INVESTIGATION IS REQUIRED BY THE SPECIAL PROVISIONS OF THE CONTRACT DOCUMENTS. THE CONTRACTOR SHALL BEAR ALL COSTS FOR THE RESTORATION OF ANY DAMAGE TO PROPERTY, INCLUDING DAMAGE TO LANDSCAPING, CAUSED DURING THE PERFORMANCE OF THE WORK.

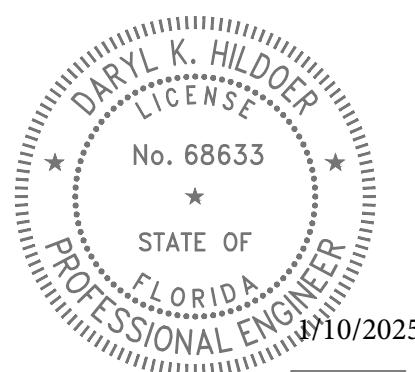

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## EAST MOWRY DRIVE

RY DRIVE	NAME	DATE	NAME	DATE	MIAMI-DADE COUNTY	
	DESIGNED BY	G.S.	DRAWN BY	E.E.		08-05-24
	CHECKED BY	L.H.	CHECKED BY			
	CHIEF ENGINEER					

DEPARTMENT OF TRANSPORTATION  
AND PUBLIC WORKS  
ROADWAY ENGINEERING AND  
RIGHT OF WAY DIVISION  
STEPHEN P. CLARK CENTER  
111 NW 1 ST

## DRAINAGE PLAN

# SUMMARY OF QUANTITIES


Item No.	Description	Unit	Quantity
102-74-1	Barricades (Temporary - Types I, II, VP and Drum)	EA./DAY	3600
102-74-2	Barricades (Temporary, Type III, 6')	E.A./day	240
102-76A	Advanced Warning Arrow Panel	EA./DAY	120
104-10-3	Sediment Barrier	L.F.	100
104-18	Inlet Protection System	EA.	3
110-4	Remove and Dispose Existing Pavement	S.Y.	40
119-01B	Driveway Restoration (Specialty pavers, tile, stamp concrete, chatahoochee or similar, decorative blocks, etc., includes restoration of base as needed and/or headers and removal, disposal and replacement)	S.Y.	22
327-7-01	Milling Existing Pavement - [(1" Depth) (Up to 5,000 S.Y.)]	S.Y.	300
331-72-10A-HMA	Roadway Pavement Restoration ( Replace and match existing base thickness and asphalt course with 8" minimum, primed Limerock Base and 1" thick of HMA, Asphalt Work Category 3)	S.Y	217
331-72-10B-HMA	Inlet Pavement (Includes 6" Limerock Base and 1" thick of HMA, Asphalt Work Category 2)	S.Y.	33
334-2-13-1	Hot Mix Asphalt, Traffic C, SP-9.5	TON	25
400-1-15	Class I Concrete [(Miscellaneous) (Trench build-up, collars, pipe plugs, structure plugs etc.) (This item is contingent upon field conditions and may increased decreased or eliminated by the Engineer)]	C.Y.	5
425-1-1	Swale Inlet Type D-3 (36" Dia.) (Less than 10 feet deep)	EA.	2
430-171-118	Pipe Culvert - 18" Diameter (Round)	L.F.	35
443-70-4-2	French Drain (18" diameter pipe, trench depth 10 ft bls)	L.F.	120
575-2A	Sodding - St. Augustine, or match existing, includes watering and maintenance. Contingent item based on field conditions, may be increased, or decreased by the engineer)	S.Y.	300

## CONFLICT TABLE

Conflict Point	Drainage		Gas	
	Invert	Pipe Dia.	Top of Pipe	Pipe Dia.
CP-1	2.40	18	5.30 (A)	Unkn

*Elevations of pipes were not provided by the Utility Company, therefore, standard cover was assumed.*









PROPOSED DRAINAGE STRUCTURE SCHEDULE									
Structure	Type	Inside Dimensions	Rim Elevation	Bottom Elevation	Pipe Inverts				
					NE	S	E	SW	Remarks
S-1	D-3	36"Ø	7.40	0.40	2.40			2.40	
S-2	D-3	36"Ø	7.40	0.40				2.40	

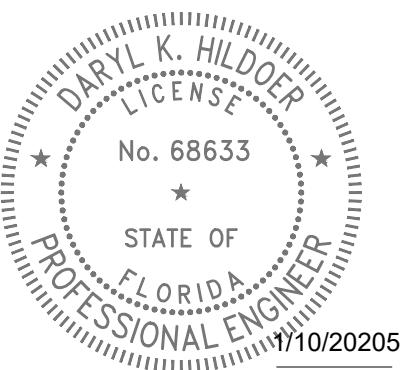


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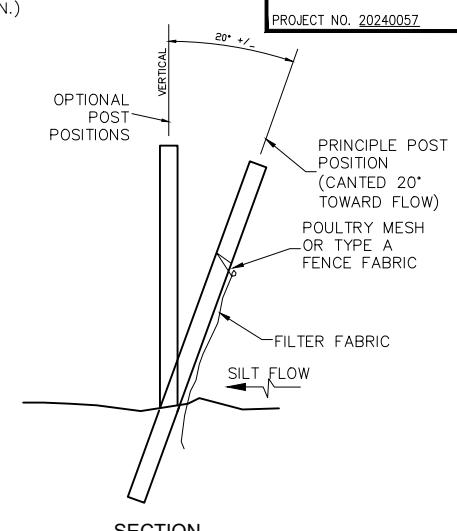
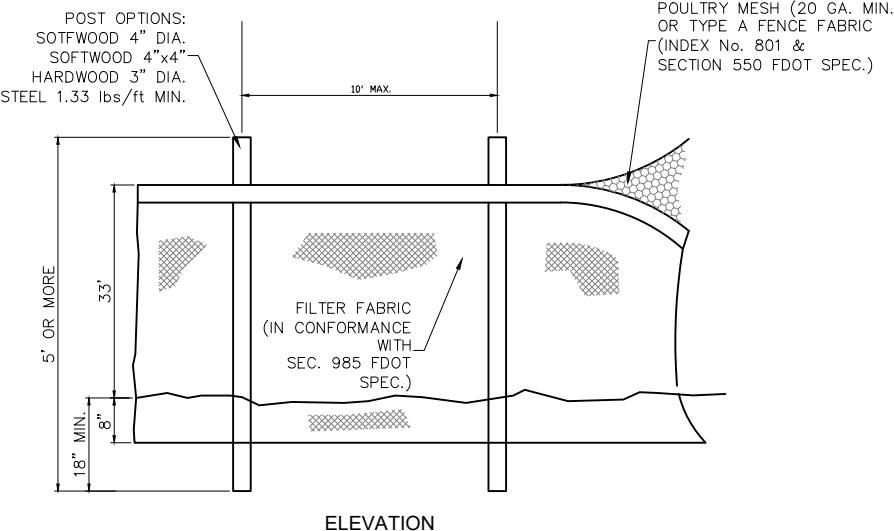
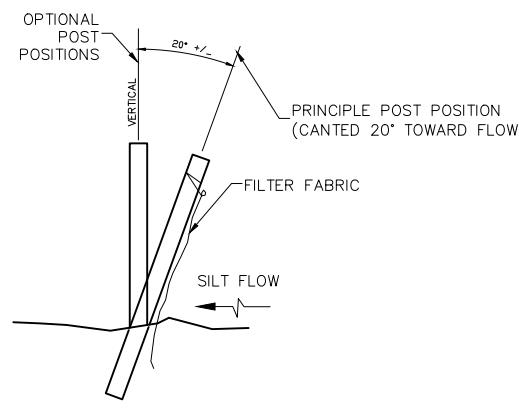
REVISIONS				EAST MOWRY DRIVE	SUPERVISED BY:	NAME	DATE	NAME	DATE	MIAMI-DADE COUNTY	DEPARTMENT OF TRANSPORTATION AND PUBLIC WORKS ROADWAY ENGINEERING AND RIGHT OF WAY DIVISION STEPHEN P. CLARK CENTER MIAMI, FLORIDA 33128	PROPOSED DRAINAGE STRUCTURE TABLE, CONFLICT TABLE AND SUMMARY OF QUANTITIES		
DATE	BY	DESCRIPTION	DATE			DATE	BY	DESCRIPTION	DATE		NAME	DATE		
										DESIGNED BY	G.S.	DRAWN BY	E.E.	08-05-24
										CHECKED BY	L.H.	CHECKED BY		




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TYPE III SILT FENCE (TYP.)

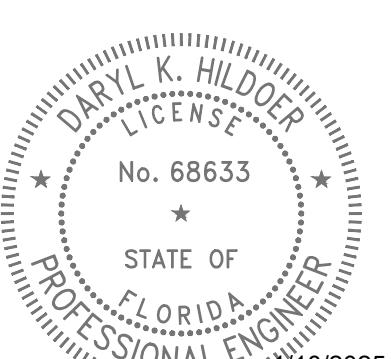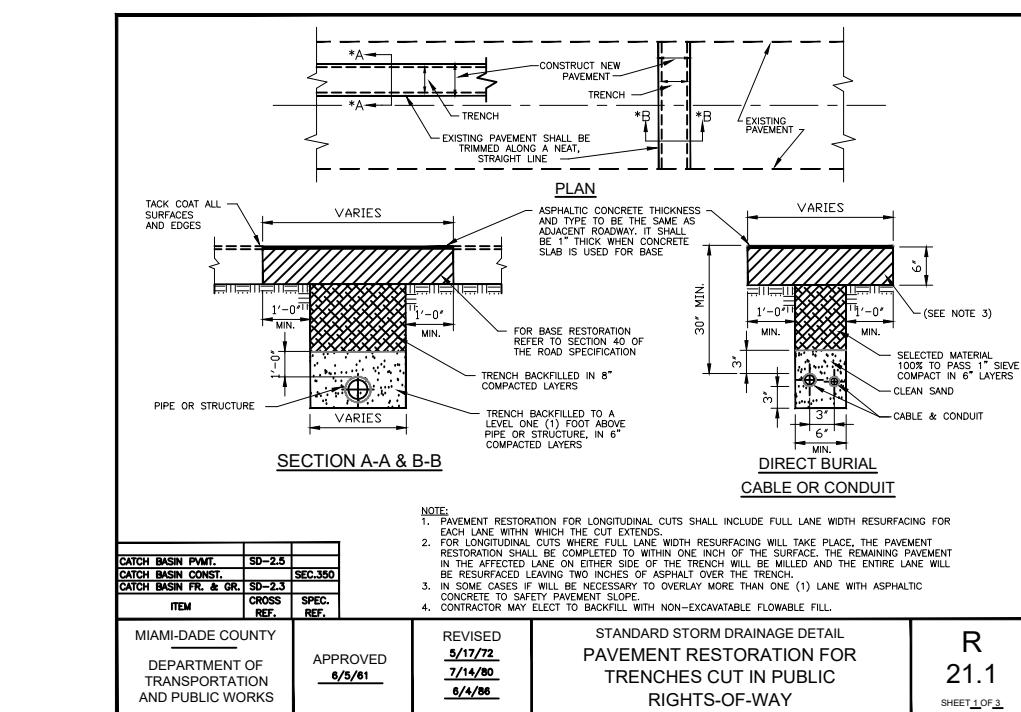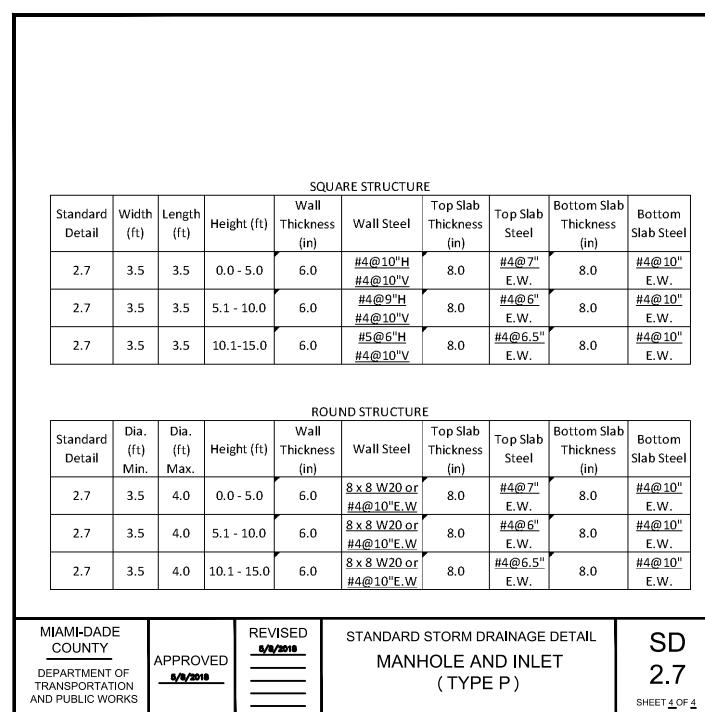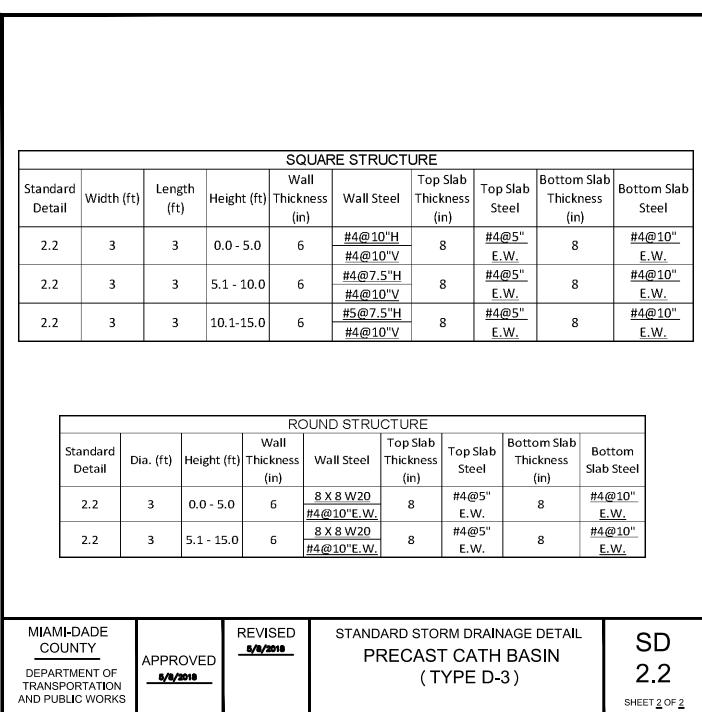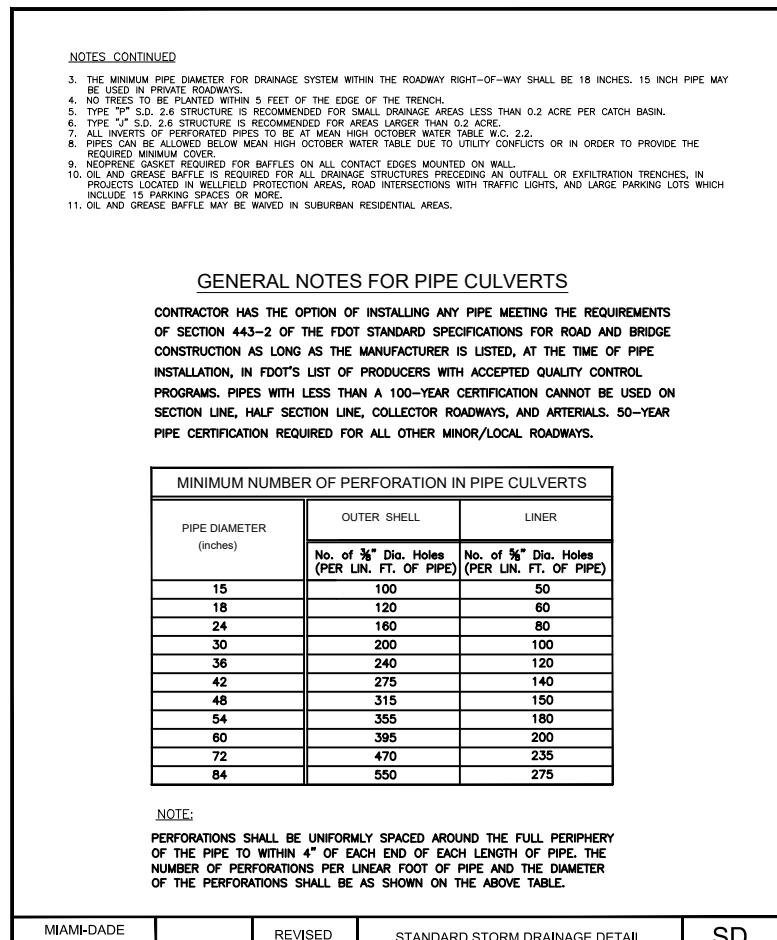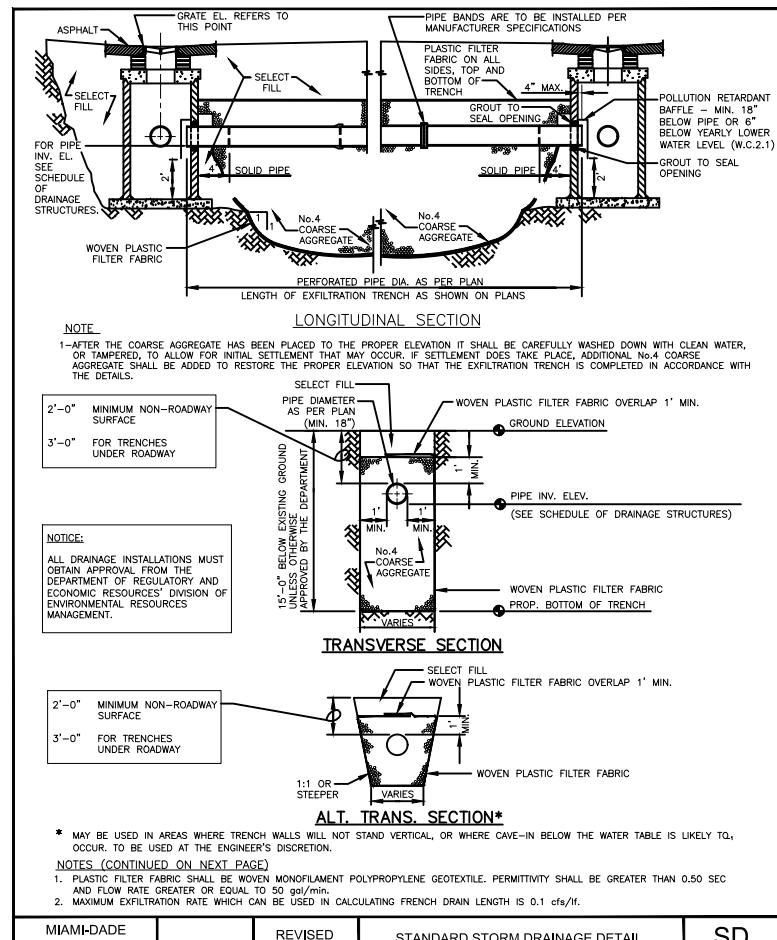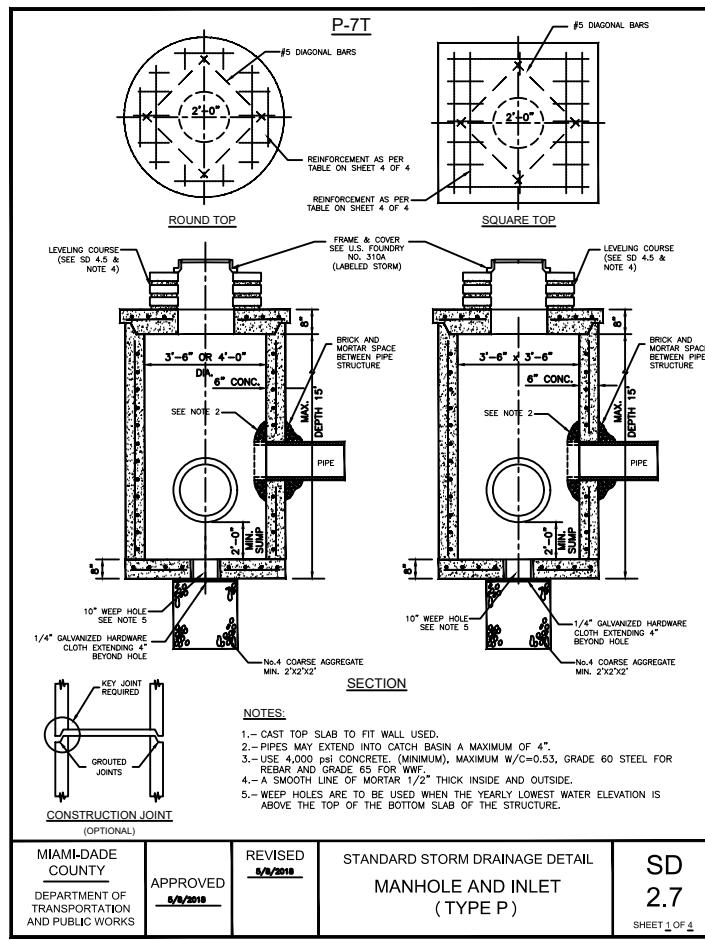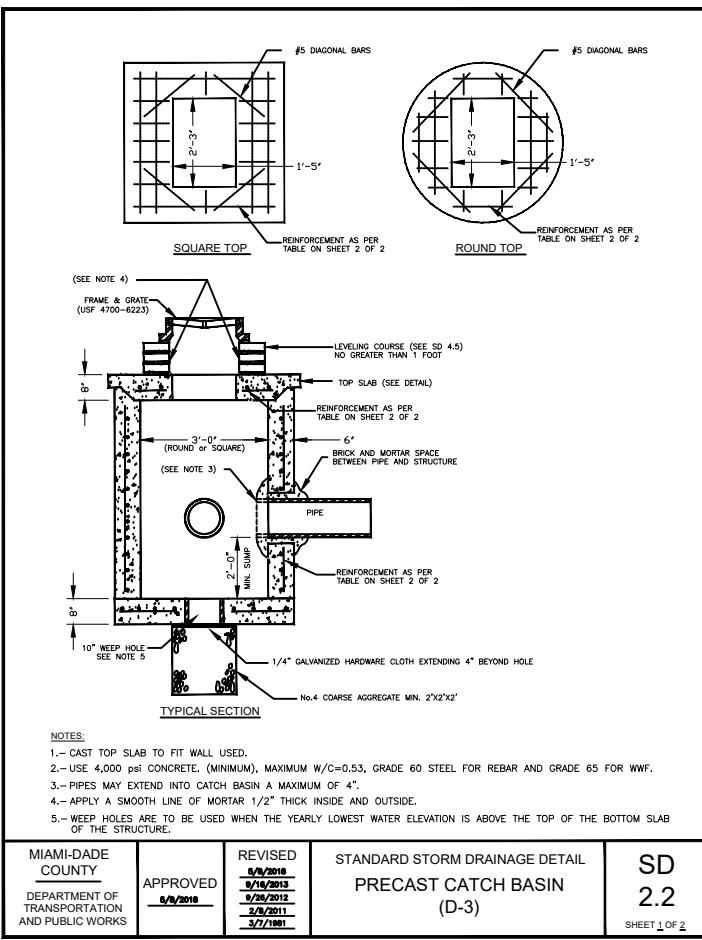

TYPE IV SILT FENCE (TYP.)

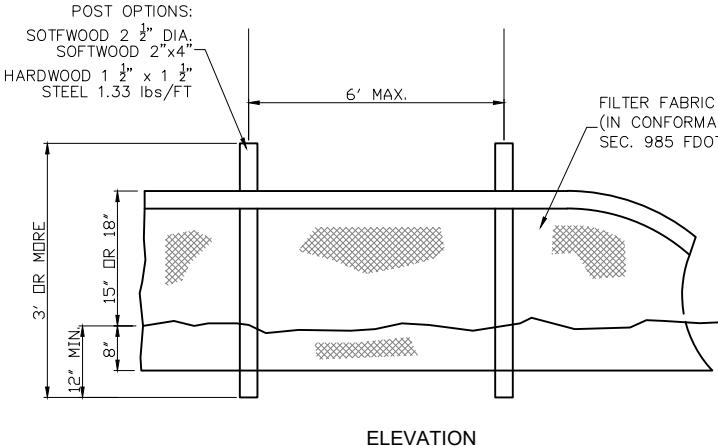

SILT FENCE APPLICATIONS (TYP.)

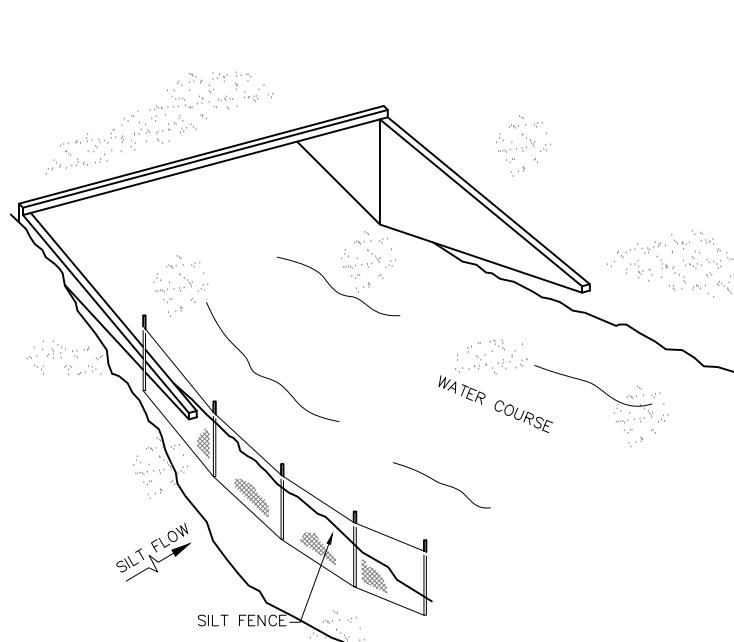NOTES FOR SILT FENCES:

1- TYPE III SILT FENCE TO BE USED AT MOST LOCATIONS. WHERE USED IN DITCHES, THE SPACING FOR TYPE III SILT FENCE SHALL BE IN ACCORDANCE WITH CHART 1, SHEET 1 OF 2010 FDOT DESIGN STANDARDS INDEX 102.

2- TYPE IV SILT FENCE TO BE USED WHERE LARGE SEDIMENT LOADS ARE ANTICIPATED. SUGGESTED USE IS WHERE FILL SLOPE IS 1:2 OR STEEPER AND LENGTH OF SLOPE EXCEEDS 25 FEET. AVOID USE WHERE THE DETAINED WATER MAY BACK INTO TRAVEL LANES OR OFF THE RIGHT OF WAY.

3- DO NOT CONSTRUCT SILT FENCES ACROSS PERMANENT FLOWING WATERCOURSES. SILT FENCES ARE TO BE AT UPLAND LOCATIONS AND TURBIDITY BARRIERS USED AT PERMANENT BODIES OF WATER.

4- WHERE USED AS SLOPE PROTECTION, SILT FENCE IS TO BE CONSTRUCTED ON 0% LONGITUDINAL GRADE TO AVOID CHANNELIZING RUNOFF ALONG THE LENGTH OF THE FENCE.


## SEDIMENT BARRIERS (TYP.) OR APPROVED ALTERNATIVE

REVISIONS					
DATE	BY	DESCRIPTION	DATE	BY	DESCRIPTION

EAST MOWRY DRIVE

DESIGNED BY	NAME	DATE	DRAWN BY	NAME	DATE
	G.S.			E.E.	08-05-24

SUPERVISED BY:

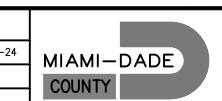


DEPARTMENT OF TRANSPORTATION  
AND PUBLIC WORKS  
ROADWAY ENGINEERING AND  
RIGHT OF WAY DIVISION  
STEPHEN P. CLARK CENTER  
MIAMI, FLORIDA 33128

SEDIMENT BARRIERS DETAILS




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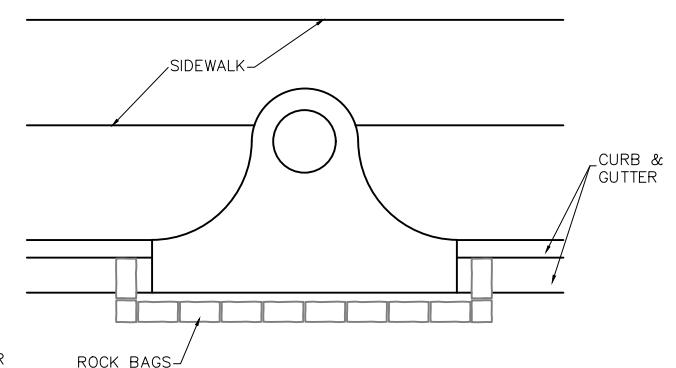


PREFABRICATED FILTER INSERT - TYPE 1

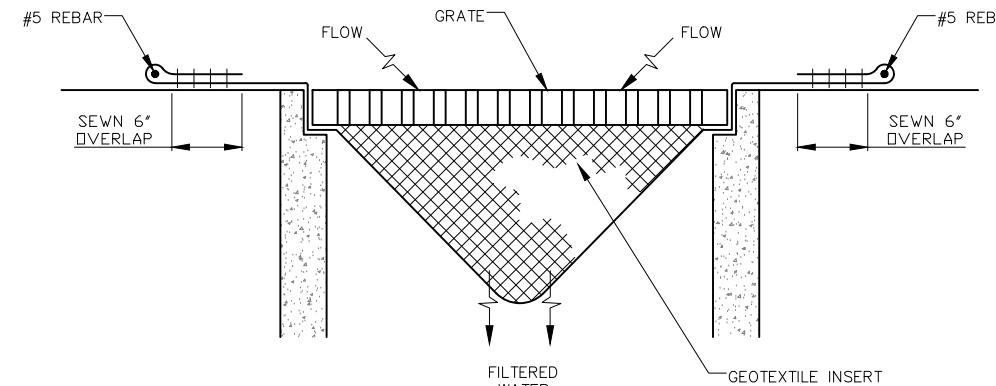
NOT TO SCALE




PARTIAL INLET

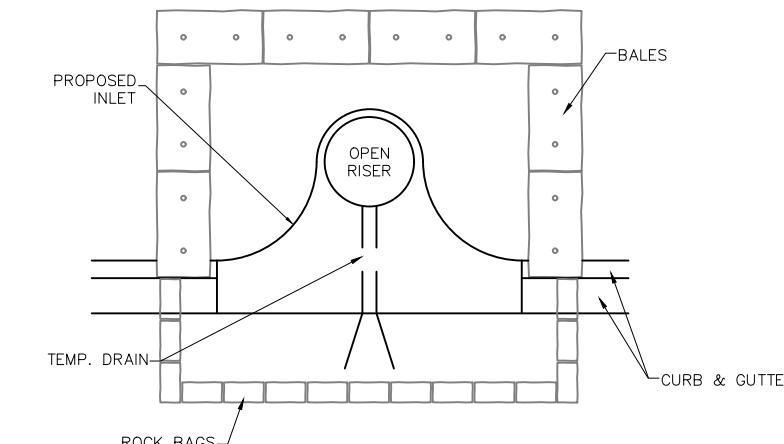

COMPLETED INLET

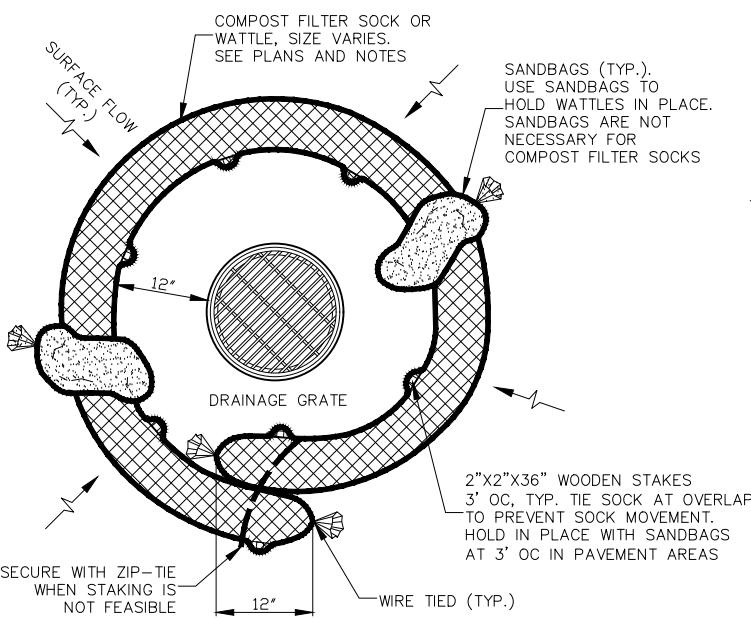

AREA DRAIN PLAN

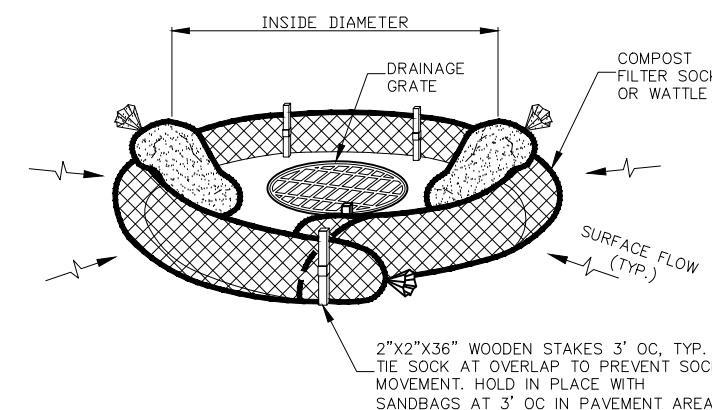


AREA DRAIN PERSPECTIVE VIEW

NOTES FOR PREFABRICATED FILTER INSERTS AND FILTER SOCK

TYPE 1 – PREFABRICATED FILTER INSERTS  
INSTALL PREFABRICATED FILTER INSERTS ACCORDING TO THE PLANS, SPECIAL PROVISIONS, AND MANUFACTURER RECOMMENDATIONS. PREFABRICATED INSERTS WITH PROVISIONS FOR OVERFLOW ARE ALLOWED ONLY WHEN ACCOMPANIED BY ADDITIONAL BMP's TO PREVENT THE POTENTIAL OF SEDIMENTS ENTERING PROJECT STORM SYSTEMS. FIELD FABRICATED INSERTS ARE NOT ALLOWED.

TYPE 2 – COMPOST FILTER SOCK  
DRIVE 2"X2" WOOD STAKES A MINIMUM OF 6" INTO GROUND AND FLUSH WITH THE TOP OF THE SOCK. OVERLAP ENDS OF SOCK PER MANUFACTURERS RECOMMENDATIONS (12" MIN., 36" MAX.). USE 8" TO 12" DIA SOCK ON CURBSIDE IN TRAFFIC AREAS. USE 12" TO 18" DIA SOCK IN NON-TRAFFIC AREAS OR AREAS WHERE THE LARGER SOCKS CAN BE USED SAFELY. USE SYNTHETIC MESH SOCKS FOR TEMPORARY INSTALLATIONS.

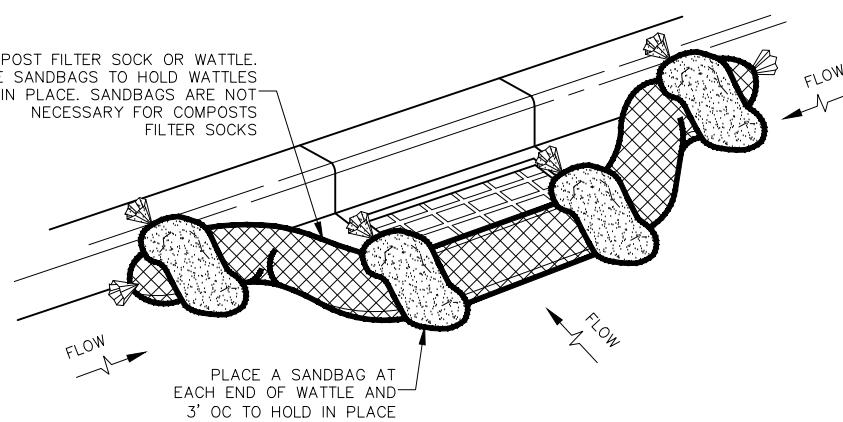


COMPOST FILTER SOCK OR WATTLE - TYPE 2

NOT TO SCALE

**PROTECTION ALONG INLETS WITH ROCK BAGS BALES OR APPROVED ALTERNATIVES**

NOTES FOR SYNTHETIC BALES OR BALE TYPE BARRIERS:

- 1 – TYPE I AND II SYNTHETIC BARRIER SHOULD BE SPACED IN ACCORDANCE WITH CHART 1, SHEET 1 OF 2010 FDOT DESIGN STANDARDS INDEX 102.
- 2 – BALES SHALL BE ANCHORED WITH TWO (2) 1"x2" (or 1" dia.) x 4' WOOD STAKES. STAKES OF OTHER MATERIAL OR SHAPE PROVIDING EQUIVALENT STRENGTH MAY BE USED IF APPROVED BY THE ENGINEER. STAKES OTHER THAN WOOD SHALL BE REMOVED UPON COMPLETION OF THE PROJECT.
- 3 – RAILS AND POSTS SHALL BE 2"x4" WOOD. OTHER MATERIALS PROVIDING EQUIVALENT STRENGTH MAYBE USED IF APPROVED BY THE ENGINEER.
- 4 – ADJACENT BALES SHALL BE BUTTED FIRMLY TOGETHER.
- 5 – WHERE USED IN CONJUNCTION WITH SILT FENCE, BALES SHALL BE PLACED ON THE UPSTREAM SIDE OF THE FENCE.

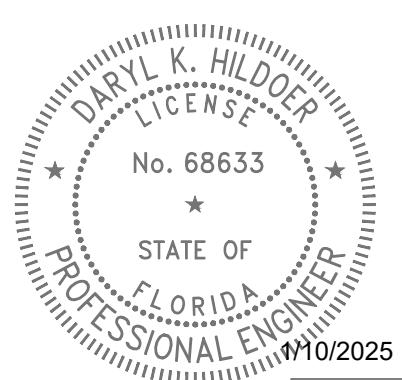

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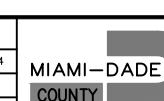
**INLET PROTECTION SYSTEM (TYP.) OR APPROVED ALTERNATIVE**

REVISIONS					
DATE	BY	DESCRIPTION	DATE	BY	DESCRIPTION

EAST MOWRY DRIVE

DESIGNED BY	NAME	DATE	DRAWN BY	NAME	DATE
	G.S.			E.E.	08-05-24
CHECKED BY	L.H.		CHECKED BY		

SUPERVISED BY:



DEPARTMENT OF TRANSPORTATION  
AND PUBLIC WORKS  
ROADWAY ENGINEERING AND  
RIGHT OF WAY DIVISION  
STEPHEN P. CLARK CENTER  
MIAMI, FLORIDA 33128

INLET PROTECTION SYSTEMS DETAILS

