



June 13, 2025

RESPONSE LETTER NO. 1 TO REQUEST FOR INFORMATION

Project Title: **Diesel Exhaust Fuel (DEF) System Installation**
Project No.: **ID-0000000785**

Email from Mr. Saide Rangel, from SCR Mechanical; on June 5, 2025, at 12:33 PM (Email Attached).

QUESTION No.1: Please provide Technical Specifications for the DEF piping to be installed.

ANSWER No.1: Refer to Article 2.06 of the Technical Specification issued under Addendum No.1.

QUESTION No.2: Please provide detailed piping route for the proposed new system.

ANSWER No.2: Refer to Article 2.06 of the Technical Specification issued under Addendum No.1. All pipes to be above ground. Detailed pipe route to be proposed by the contractor.

QUESTION No.3: Please provide technical Specifications for the DEF Tank.

ANSWER No.3: There should be 4 double wall tanks with 750 gallons capacity each. Refer to Article 2.02 of the Technical Specification issued under Addendum No.1.

QUESTION No.4: Please provide detailed instrumentation required for the DEF piping and storage system.

ANSWER No.4: Refer to Article 2.03 of the Technical Specification, issued under Addendum No.1.

Email from Mr. Saide Rangel, from SCR Mechanical; on June 6 2025, at 1:06 PM (Email Attached).

QUESTION No.1: Please provide detailed plans for this project.

ANSWER No.1: The County does not have detail plans, please refer to attached construction permit drawing dated September 2000 under addendum No. 1

QUESTION No.2: **Do Prevailing Wages apply for this project? If yes, does Building or Heavy wages apply?.**

ANSWER No.2: No. Prevailing wages do not apply to this project

Email from Mr. Ricardo Montijo, from RicMon Group, LLC; on June 9, 2025, at 12:50 PM (Email Attached).

QUESTION No.1: **Please provide the existing electrical system as-built and panel schedule for the fuel pump system, fuel System as-built, site plan as-built for the gas station.**

ANSWER No.1: The County does not have detail plans, please refer to attached construction permit drawing dated September 2000 under addendum No. 1.

QUESTION No.2: **Does this project have working hours restrictions.**

ANSWER No.2: Hours of operations are from Monday to Friday 6:00 AM to 7:00 PM. Please coordinate with the facility supervisor and Mr. Scott Stephens the schedule before commencing the Work.
Call 14 day in advance, in the event the contractor needs to work on weekend or holidays.

QUESTION No.3: **Please indicate the amount of dispenser/ hoses required.**

ANSWER No.3: County is requesting 4 dispensers. Refer to Article 2.03 of the Technical Specifications.

QUESTION No.4: **Does the County have any equipment preference?.**

ANSWER No.4: No, the County does not have preference for any brand.

QUESTION No.5: **Please provide the tank capacity that County would like to have**

ANSWER No.5: Please refer to answer to question No. 3 from SCR Mechanical; dated June 5, 2025, above.

QUESTION No.6: Will EJ Wall pedestal have control relays for the activation of the DEF pump?

ANSWER No.6: Yes, EJ Ward does have the ability to use control relays for pump activation.

QUESTION No.7: We would like to know the amount of tank required and their capacity

ANSWER No.7: Please refer to answer to question No. 3 from SCR Mechanical; dated June 5, 2025, above.

QUESTION No.8: Are new bollards are going required or new ones are required ? Which size?

ANSWER No.8: Yes, new bollards will be required to match existing, Article 2.05 of the Technical Specification issued under Addendum No.1.

QUESTION No.9: Can you extend the bid due date?

ANSWER No.9: Yes, bid due date has been extended to July 2, via addendum No.1.

QUESTION No.10: Where's required to deliver the bid package?

ANSWER No.10: Bid package to be delivered to the office of the Clerk of the Board located at 111 NW 1st Street, Miami Florida 33128, 17th Floor, before 2:00 PM. Late bids will not be accepted. A clarification has been issued under Addendum No. 1. Bids submitted via e-mail will be rejected.

END OF REQUEST FOR INFORMATION No. 1

Sincerely,



Alfredo E. Munoz, P.E.
Program Management Manager, Fleet Management Division
Internal Services Department (ISD)

AM:fp

cc:

Frances Perez-TeXidor, ISD	Caesar Suarez, SBD
Scott Stephens, PIOD	Pete Moolah, PIOD
Laurie Johnson, ISD	Yliana Serra, PIOD
Project File	Clerk of the Board


CONSTRUCTION DRAWINGS

ABOVEGROUND STORAGE TANK REMOVAL / INSTALLATION


SEPTEMBER 1999

WORK ORDER No. 03-9050

MIAMI-DADE GSA FLEET MANAGEMENT
58th STREET LANDFILL FUELING FACILITY
G.S.A. SHOP 3
8801 N.W. 58th STREET
MIAMI, FL. 33166

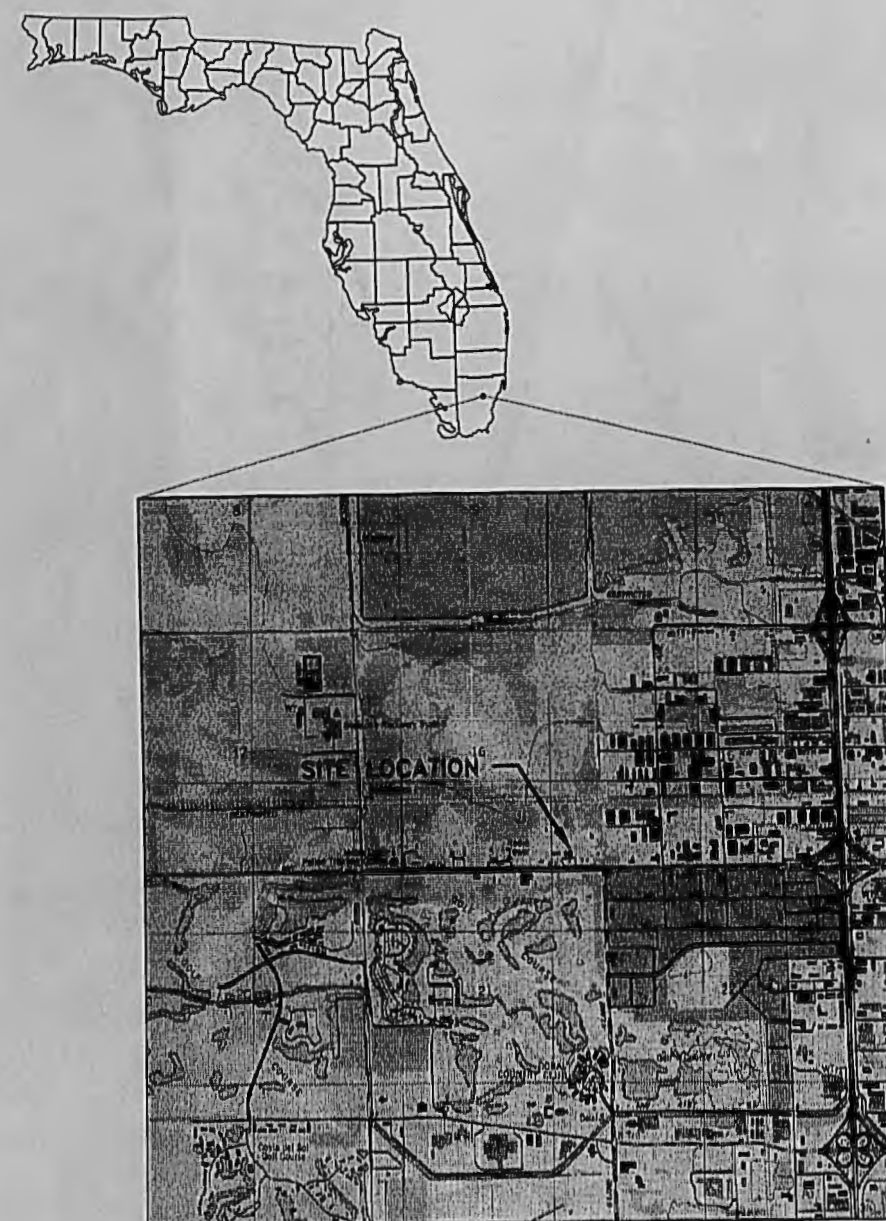

LOCATION MAP

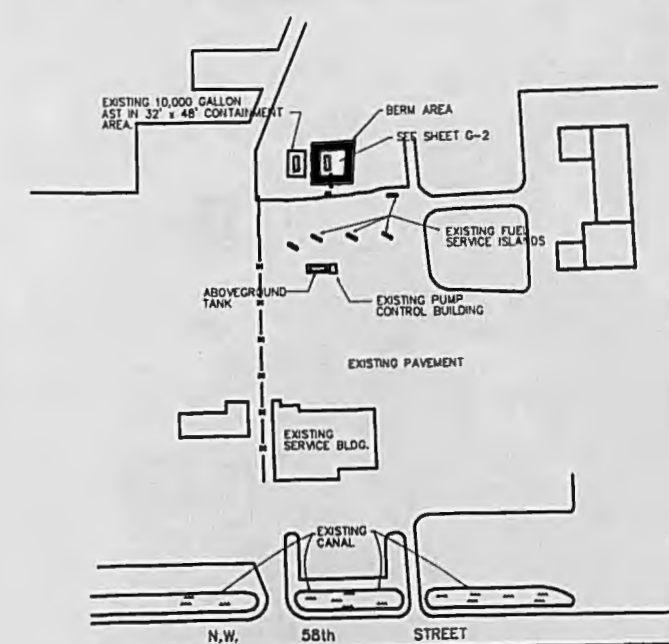

SITE MAP

NOT TO SCALE

INDEX TO DRAWINGS

- COVER SHEET
- G-1 GENERAL NOTES & SCOPE OF WORK
- G-2 EXISTING SITE PLAN
- G-3 PROPOSED SITE PLAN
- G-4 DRAINAGE PLAN AND DETAILS
- M-1 ISOMETRIC TANK & PIPING DIAGRAM
- M-2 EXISTING 10,000 GALLON AST (TANK "C") DETAILS
- M-3 EXISTING 12,000 GALLON AST (TANKS "D" & "E") DETAILS
- M-4 SIMPLEX DAY TANK DETAILS
- M-5 SIMPLEX FUEL PORT DETAILS
- M-6 MECHANICAL DETAILS
- M-7 TANK "B" DETAILS
- S-1 STRUCTURAL LAYOUT
- S-2 ELECTRICAL BUILDING
- S-3 STRUCTURAL DETAILS
- S-4 STRUCTURAL DETAILS
- S-5 CONCRETE SECTIONS AND DETAILS
- E-1 ELECTRICAL PLAN
- E-2 ELECTRICAL RISER
- E-3 ELEMENTARY CONTROL DIAGRAMS
- E-4 ELECTRICAL PANELS AND NOTES
- E-5 ELECTRICAL DETAILS

PREPARED FOR:

GENERAL SERVICES ADMINISTRATION (G.S.A.)
FLEET MANAGEMENT DIVISION
111 N.W. 1st STREET
SUITE 2530
MIAMI, FL. 33128

BBL

ENVIRONMENTAL SERVICES, INC.
Remedial Action Management and Construction

MIAMI-DADE COUNTY DERM
POLLUTION CONTROL DIVISION
POLLUTION REMEDIATION SECTION
DISAPPROVED: *[Signature]* DATE: 9/10/99

GENERAL NOTES

1. THE CONTRACTOR SHALL BE SOLELY RESPONSIBLE FOR INITIATING, MAINTAINING, AND SUPERVISING ALL SAFETY PRECAUTIONS AND PROGRAMS IN CONNECTION WITH THE WORK. HE SHALL TAKE ALL NECESSARY PRECAUTIONS FOR THE SAFETY OF AND SHALL PROVIDE THE NECESSARY PROTECTION TO PREVENT DAMAGE, INJURY, OR LOSS TO ALL EMPLOYEES ON THE WORK SITE AND ANY OTHER PERSONS WHO MAY BE AFFECTED THEREBY.
2. THE CONTRACTOR SHALL COMPLY WITH ALL APPLICABLE LAWS, ORDINANCES, RULES, REGULATIONS, AND ORDERS OF PUBLIC BODIES HAVING JURISDICTION FOR THE SAFETY OF PERSONS OR PROPERTY OR TO PROTECT THEM FROM DAMAGE, INJURY, OR LOSS, INCLUDING, WITHOUT LIMITATION, THE DEPARTMENT OF LABOR SAFETY AND HEALTH REGULATIONS FOR CONSTRUCTION PROMULGATED UNDER THE OCCUPATIONAL SAFETY AND HEALTH ACT OF 1970 (PL 91-596) AND UNDER SECTION 107 OF THE CONTRACT WORK HOURS AND SAFETY STANDARDS ACT (PL 91-54) AND AMENDMENTS THERE TO. HE SHALL ERECT AND MAINTAIN AS REQUIRED BY THE CONDITIONS AND THE PROGRESS OF THE WORK, ALL NECESSARY SAFEGUARDS FOR EMPLOYEE SAFETY AND PROTECTION AND SHALL COMPLY WITH ALL APPLICABLE RECOMMENDATIONS OF THE MANUAL OF ACCIDENT PREVENTION IN CONSTRUCTION OF THE ASSOCIATED GENERAL CONTRACTORS OF AMERICA.
3. CONTRACTORS SHALL FURNISH AND PLACE PROPER GUARDS FOR PREVENTION OF ACCIDENTS, PROVIDE ALL TRENCH SHORING, SCAFFOLDING, SHIELDING, DUST/FUME PROTECTION, MECHANICAL/ELECTRICAL PROTECTION, SPECIAL GROUNDING, SAFETY RAILINGS, BARRIERS, OR OTHER SAFETY FEATURES REQUIRED TO SECURE SAFETY OF LIFE OR PROPERTY.
4. THE CONTRACTOR SHALL BE AWARE THAT CERTAIN SOILS AND GROUNDWATER SUBJECT TO THIS CONTRACT MAY CONTAIN GASOLINE AND DIESEL FUEL CONSTITUENTS (BTEX) AND MAY CONTAIN OTHER CHEMICAL CONSTITUENTS. MATERIALS EXCAVATED AND REQUIRING OFF-SITE DISPOSAL SHALL BE TESTED AND HANDLED IN ACCORDANCE WITH THE LATEST EDITION OF CHAPTER 62-761, 62-770, AND 62-777 FLORIDA ADMINISTRATIVE CODE (FAC). IF ENCOUNTERED, FREE FLOATING PRODUCT SHALL BE REMOVED BY THE DESIGNATED GSA LIQUID WASTE DISPOSAL CONTRACTOR, CLIFF BERRY, AND COORDINATED BY THE CONTRACTOR. TANK CLOSURE SHALL BE IN ACCORDANCE WITH MIAMI-DADE COUNTY DEPARTMENT OF ENVIRONMENTAL RESOURCES MANAGEMENT (DERM) AND FLORIDA DEPARTMENT OF ENVIRONMENTAL PROTECTION (FDEP) STORAGE TANK SYSTEM CLOSURE ASSESSMENT REQUIREMENTS.
5. THE TEMPORARY DIESEL FUEL DISPENSING AREA MUST BE MAINTAINED DURING CONSTRUCTION ACTIVITIES. ALL CONSTRUCTION ACTIVITIES SHALL BE COORDINATED WITH THE RESPONSIBLE MIAMI-DADE FLEET MANAGEMENT / DERM REPRESENTATIVE PRIOR TO COMMENCING ON-SITE ACTIVITIES.
6. THE CONTRACTOR IS REQUIRED TO OBTAIN ALL APPLICABLE LOCAL, STATE AND FEDERAL PERMITS AND TO MAKE ARRANGEMENTS FOR LOCAL INSPECTIONS.
7. THE WORK SHALL BE SUBJECT TO INSPECTION BY THE LOCAL AUTHORITIES HAVING JURISDICTION, AND ALL WORK SHALL PASS SUCH INSPECTION.
8. INSTALL EQUIPMENT IN A NEAT AND WORKMANLIKE MANNER; ALIGN, LEVEL AND ADJUST FOR SATISFACTORY OPERATION; INSTALL SO THAT PARTS ARE EASILY ACCESSIBLE FOR INSPECTION, OPERATION, MAINTENANCE AND REPAIR; DEVIATIONS FROM INDICATED ARRANGEMENTS ARE SUBJECT TO REVIEW AND APPROVAL FROM THE ENGINEER PRIOR TO INSTALLATION.
9. IN THE AREAS WHERE EXPLOSION-PROOF WORK IS REQUIRED OR SPECIFIED, ALL WORK SHALL MEET THE REQUIREMENTS OF THE NATIONAL ELECTRIC CODE (NEC) FOR CLASS 1 DIVISION 1 OR CLASS 1 DIVISION 2 LOCATIONS AS REQUIRED BY NFPA-30, FLAMMABLE LIQUIDS CODE. ALL ELECTRICAL EQUIPMENT AND DEVICES SHALL BE MOUNTED A MINIMUM OF 18" ABOVE GRADE OR SLAB.
10. WATER IS ACCESSIBLE THROUGH A FIRE HYDRANT LOCATED APPROXIMATELY 250 FEET EAST OF THE SITE. IF WATER IS REQUIRED, CONTRACTORS SHALL BE RESPONSIBLE FOR COORDINATING HYDRANT ACCESS WITH THE MIAMI-DADE WATER AND SEWER DEPARTMENT.

SCOPE OF WORK

1. EXISTING 10,000 GALLON ABOVEGROUND STORAGE TANK (TANK "C") MUST REMAIN FULLY OPERATIONAL DURING ALL CONSTRUCTION ACTIVITIES.
2. OBTAIN ALL NECESSARY AND APPLICABLE PERMITS REQUIRED TO PERFORM THE SCOPE OF WORK, AND OPERATIONAL PERMITS REQUIRED FOR FUEL STORAGE AND DISPENSING FACILITIES.
3. CALL UTILITY CLEARANCE (SUNSHINE STATE ONE) AT LEAST 72 HOURS PRIOR TO INITIATING EXCAVATION ACTIVITIES.
4. ALL MAJOR AND SALVAGEABLE REMOVED EQUIPMENT (FUEL DISPENSERS, PROBES, ETC.) TO BE STORED ON SITE FOR FUTURE USE BY GSA.
5. REMOVE AND PROPERLY DISPOSE ALL CONTENTS FROM ONE (1) 10,000 GALLON ABOVEGROUND STEEL TANK (TANK "A").
6. REMOVE AND DISPOSE OF ONE (1) 10,000 GALLON ABOVEGROUND STEEL TANK (TANK "A") AND ALL ASSOCIATED PIPING, PIPING SUPPORTS, TANK ACCESSORIES, ELECTRICAL CONDUITS, REMOTE FILL WITH ASSOCIATED HOUSING, AND DIESEL DISPENSERS FROM FUELING ISLANDS 1 THROUGH 4. MOVE ONE (1) 10,000 GALLON ABOVEGROUND STEEL TANK (TANK "B") TO THE TANK "A" CONCRETE CRADLES. TANK "B" WILL BE INCORPORATED INTO THE FUELING SYSTEM, PRIOR TO TRANSFER OF TANK "B". CONTRACTOR SHALL VERIFY TANK "A" CRADLES CAN ACCEPT TANK "B" AND/OR MODIFY CRADLES AS REQUIRED.
7. INSTALL NEW ABOVEGROUND 3" STEEL DRAIN PIPING, INCLUDING 3" OPW 110 SPRING LOADED VALVE, AND CONNECT TO EXISTING UNDERGROUND DRAIN PIPING FOR EXISTING TANK "B" SECONDARY CONTAINMENT SLAB. PROPERLY SEAL PIPING PASSING THROUGH SECONDARY CONTAINMENT SLAB WITH WATER/FUEL RESISTANT SEALANT. INSPECT EXISTING SECONDARY CONTAINMENT SLAB AND RESEAL ANY DAMAGED AREAS AS REQUIRED. PROPERLY ABANDON EXISTING FLOOR DRAIN AND DISCONNECT EXISTING PIPING AT POINT OF NEW CONNECTION TO NEW ABOVEGROUND PIPING. ~~EXISTING SECONDARY CONTAINMENT SLAB SHALL BE "LEAK PROOF"~~
8. PROPERLY ABANDON IN PLACE ALL UNDERGROUND PIPING, FLUSH AND CAP PIPING IN ACCORDANCE WITH CHAPTER 62-761, FAC AND CHAPTER 24 OF THE MIAMI-DADE COUNTY CODE. REMOVE AND DISPOSE OF EXISTING TRANSFER PUMPS, CONCRETE CRADLES, ASSOCIATED PIPING, AND ELECTRICAL CONDUITS AT FORMER TANK "B" LOCATION.
9. PROVIDE PROFESSIONAL SERVICES TO PERFORM TANK CLOSURE ASSESSMENT AND SUBMIT CLOSURE ASSESSMENT REPORT TO DERM IN ACCORDANCE WITH ALL APPLICABLE CODES AND STANDARDS (INCLUDING CHAPTER 24 OF THE MIAMI-DADE COUNTY CODE AND CHAPTER 62-761, FAC), THE MOST STRINGENT OF WHICH SHALL APPLY.
10. CUT, FILL, AND COMPACT AS REQUIRED TO ATTAIN A MINIMUM COMPACTION OF 95% MAXIMUM DENSITY AND TO OBTAIN THE REQUIRED GRADES AND ELEVATIONS FOR PLACEMENT OF THREE (3) NEW REINFORCED CONCRETE SLABS. ALL ELEVATIONS NOTED IN THE PLANS WILL BE VERIFIED IN THE FIELD BY THE CONTRACTOR AND MODIFIED, IF REQUIRED, WITH THE APPROVAL OF THE ENGINEER. REMOVE UNSUITABLE SOILS WHEN ENCOUNTERED, ENSURING COMPLIANCE WITH ALL APPLICABLE LOCAL, STATE, AND FEDERAL REGULATIONS GOVERNING THEIR REMOVAL AND DISPOSAL.
11. FORM, PLACE AND FINISH NEW REINFORCED CONCRETE SLAB 1 DIRECTLY EAST AND ADJACENT TO EXISTING TANK "A" CRADLE AND SECONDARY CONTAINMENT SLAB. POUR 42'-8" X 40' X 12" THICK NEW CONCRETE SLAB 1 USING 4,000 PSI CONCRETE WITH #5 REBAR EACH WAY AT 12 INCH CENTERS.
12. SET TWO (2) NEW 12,000 GALLON ABOVEGROUND DIESEL TANKS "D" AND "E" AS SPECIFIED. TANKS TO BE PROVIDED BY GSA, FURNISH AND INSTALL TWO (2) NEW 1.5 HORSEPOWER RED JACKET SUBMERGED TURBINE PUMPS (STPs). ONE EACH FOR TANKS "D" AND "E".
13. FURNISH AND INSTALL SIMPLEX FUEL SYSTEM FILL PORT CABINET ADJACENT TO TANK "B" LOCATION. FURNISH AND INSTALL SIMPLEX SST-25 DAY TANK IN ELECTRICAL BUILDING.
14. FURNISH NEW 1.5 HORSEPOWER RED JACKET STP AND COVERED STAINLESS STEEL CONTAINMENT BOX. INSTALL STP WITHIN CONTAINMENT BOX ON TANK "B".
15. FURNISH AND INSTALL A PUMP MEASURE CONTROL DESIGN AUTO-SEQUENCING SYSTEM TO ALTERNATE DIESEL FUEL TANK DISPENSING ACTIVITIES. SEQUENCER WILL ALTERNATE PUMPS AND ACTIVATE AN ADDITIONAL PUMP FOR EACH DISPENSER ACTIVATED AT THE SAME TIME.
16. INSTALL NEW TOTAL CONTAINMENT DS 4221 (42" X 21" X 37") HDPE SUMP WITH CONTAINED SYSTEMS STEEL TRANSITION LID (42" X 21") AS SPECIFIED.
17. INSTALL NEW PRODUCT PIPING, VAPOR RECOVERY PIPING, VEEDER ROOT CONDUIT, ELECTRICAL CONDUIT, AND SENSOR AND TANK GAUGE CONDUIT AS SPECIFIED FROM THE TANK "B", "C", "D", AND "E" LOCATIONS TO THE NEW PIPING TRANSITION SUMP AS SPECIFIED. ALL ABOVEGROUND PRODUCT PIPING SHALL BE BLACK STEEL PRIMARY PIPING WITH FIBERGLASS SECONDARY PIPING. ALL ABOVEGROUND SECONDARY PIPING SHALL BE PAINTED WITH ULTRAVIOLET LIGHT RESISTANT PAINT.
18. INSTALL CANOPY STORMWATER DRAINAGE SYSTEM, INCLUDING 14" X 18" STORMWATER RETENTION POND, PRECAST CONCRETE OUTFALL, AND PVC PIPING.
19. PLACE FIFTEEN (15) NEW CONCRETE JERSEY CURB BARRIERS AT SPECIFIED LOCATIONS ON THE SOUTH SIDE OF NEW TANK FARM.
20. INSTALL ABOVEGROUND GROUNDING GRID IN THE VICINITY OF NEW CONCRETE SLAB 1. CONNECT TO NEW EQUIPMENT AS REQUIRED.
21. EXCAVATE TRENCHES FOR PLACEMENT OF ELECTRICAL CONDUIT, TELEPHONE, SENSOR AND TANK LEVEL GAUGE CONDUIT, AND PRODUCT AND VAPOR RECOVERY PIPING AS SPECIFIED. MAIN ELECTRICAL AND TELEPHONE FEEDS TO EXTEND FROM MAINTENANCE BUILDING TO NEW ELECTRICAL BUILDING ALONG EXISTING FENCE LINE.
22. FORM TWO (2) NEW FUEL DISPENSING ISLANDS 75' LONG X 4' WIDE X 4" HIGH IN THE POSITIONS SPECIFIED, FURNISH AND INSTALL FOUR (4) GASBOY (MODEL 9153AXTW-1) DUAL HOSE DIESEL DISPENSERS AND TWO (2) GASBOY (MODEL 9153AXTW-1) DUAL HOSE UNLEADED GASOLINE DISPENSERS. DIESEL DISPENSERS TO HAVE ALTERNATING DISPLAY COVERS ON BOTH SIDES, TO COINCIDE WITH GROUND LOOP OPERATION. ALL DISPENSERS TO BE EQUIPPED WITH STAINLESS STEEL CABINETS, SECONDARY CONTAINMENT SUMP, HOSES, FUEL FILTERS, BREAK AWAY CONNECTIONS, PEMCO 360 HOSE RETRIEVERS 1/2" 2" PIPE (DIESEL ONLY), AND NOZZLES. THE UNLEADED DISPENSERS MUST BE EQUIPPED WITH STAGE II VAPOR RECOVERY PIPING AND EQUIPMENT.
23. INSTALL NEW PRODUCT PIPING, VAPOR RECOVERY PIPING, AND ELECTRICAL CONDUIT AS SPECIFIED FROM NEW PIPING TRANSITION SUMP TO FUEL DISPENSING ISLANDS 1 AND 2 AS SPECIFIED. ALL UNDERGROUND PRODUCT PIPING SHALL BE DOUBLE WALL FIBERGLASS PIPING WITH COMPATIBLE CONNECTIONS.
24. FURNISH AND INSTALL 6" STEEL BOLLARDS FILLED WITH CONCRETE TO SURROUND NEW FUEL ISLANDS AND PROTECT EQUIPMENT AND COLUMNS AS SPECIFIED.
25. INSTALL CANOPY COLUMN FOOTERS WITHIN FUEL DISPENSING ISLANDS 1 AND 2. TYPICAL OF EIGHT. CANOPY (91' X 78' X 16' HIGH) TO BE INSTALLED BY ORANGE TATE INDUSTRIES (OTI) UNDER SEPARATE PERMITS. CANOPY INSTALLATION TO BE COORDINATED BY CONTRACTOR. CANOPY GUTTERS TO BE DIRECTED AS SHOWN ON CANOPY DRAWING.
26. FURNISH AND INSTALL 320W, 240 V METAL HALIDE LIGHTS WITH TWENTY (20) OVER THE CANOPY AND TWO (2) ON NORTH SIDE OF CANOPY FACING TANK FARM AND FEE (3) ON SOUTH SIDE FACING MAINTENANCE SHOP. LIGHTS UNDER THE CANOPY SHALL BE PROVIDED BY CANOPY MANUFACTURER.
27. FORM, PLACE AND FINISH NEW REINFORCED CONCRETE SLAB 2 (TANKER SLAB) BETWEEN TANK FARM AND DISPENSER ISLANDS. POUR 95' X 15' X 10" THICK NEW CONCRETE SLAB 2 USING 4,000 PSI CONCRETE WITH WWF 44-4 W4W4. POUR 120' X 4" X 4" CONCRETE CURB DIRECTLY SOUTH OF NEW CONCRETE SLAB 2.
28. FORM, PLACE AND FINISH NEW CONCRETE SLAB 3 DIRECTLY SOUTH AND ADJACENT TO NEW CONCRETE SLAB 2. POUR 85' X 72' X 9" THICK NEW CONCRETE SLAB 3 ROUNDED FURNISHED FUEL DISPENSING ISLANDS 1 AND 2 USING 4,000 PSI CONCRETE WITH WWF 44-4 W4W4. SLAB 3 TO INCLUDE 2" HIGH BY 2" WIDE CONCRETE BERM AS SHOWN ON RWS. PLACE TWO - 2" HIGH BY 18" WIDE ASPHALT SPEED BUMPS ON BOTH SIDES OF FUEL ISLAND.
29. SAW CUT NEW CONCRETE SLAB 3 AND INSTALL JOINTS AT SPECIFIED LOCATIONS. FURNISH AND INSTALL GROUND LOOPS FOR EJ WARD SYSTEM ON BOTH SIDES OF EJ DIESEL DISPENSER LOCATION. GROUND LOOPS TO BE CENTERED ON WEST NOZZLE R. NORTH SIDE OF DISPENSER AND EAST NOZZLE FOR SOUTH SIDE OF DISPENSER OR 2 VERSA.
30. RESURFACE GRADED AREAS ADJACENT TO CONCRETE SLABS 2 AND 3 AND TO PROVIDE A SMOOTH TRANSITION FOR TRAFFIC TO AND FROM THESE AREAS AND TO MAINTAIN PROPER DRAINAGE.
31. PAINT TRAFFIC YELLOW STRIPING ABOVE EACH INSTALLED GROUND LOOP, ALONG THE 4" CURB SEPARATING CONCRETE SLAB 2 AND 3, ALONG EACH SPEED BUMP, AND CONCRETE BERM, AND AT BASE OF FUEL DISPENSING ISLANDS 1 AND 2.
32. CONSTRUCT NEW 14' X 16' CONCRETE BLOCK ELECTRICAL BUILDING TO HOUSE NEW EMERGENCY GENERATOR, VEEDER ROOT SYSTEM, AND ELECTRICAL CONTROL PANELS.
33. INSTALL AND CONNECT A SINGLE PHASE, 240V MAIN ELECTRICAL FEED AND THREE (3) TELEPHONE LINES VIA TRENCHING FROM THE EXISTING MAINTENANCE SHOP TO THE NEW ELECTRICAL BUILDING. ONE (1) TELEPHONE LINE TO REMAIN ACCESSIBLE INSIDE THE ELECTRICAL BUILDING AND TWO (2) TELEPHONE LINES TO TERMINATE AT FUEL DISPENSING ISLAND 1 FOR CONNECTION WITH THE EJ WARD UNIT.
34. FURNISH AND INSTALL KOHLER 30KW DIESEL GENERATOR EQUIPPED WITH KOHLER AUTOMATIC SWITCHING CONTROLLER WITHIN NEW ELECTRICAL BUILDING. CONNECT DAY TANK SUPPLY AND RETURN PIPING TO EXISTING TANK "B" AND NEW EMERGENCY GENERATOR.
35. TRANSFER VEEDER ROOT TERMINAL FROM EXISTING PUMP CONTROL BUILDING TO NEW ELECTRICAL BUILDING. CONNECT VEEDER ROOT TERMINAL TO TANK/PIPING SENSORS AND CONTROLS. REPLACE MODULES AS REQUIRED.
36. TRANSFER EJ WARD CARD READER TERMINAL FROM EXISTING PUMP CONTROL BUILDING TO FUEL DISPENSING ISLAND 1 WITH PROPER CONNECTION TO TELEPHONE, ELECTRICAL, DISPENSERS, AND PUMPS.
37. FURNISH AND INSTALL TWO (2) GFI RECEPTICALS. ONE (1) TO BE LOCATED IN THE NEW ELECTRICAL BUILDING AND ONE (1) TO BE LOCATED AT FUEL DISPENSING ISLAND 1 ADJACENT TO THE EJ WARD UNIT.
38. FURNISH AND INSTALL POWER CONDITIONER WITHIN THE NEW ELECTRICAL BUILDING AND CONNECT WITH THE VEEDER ROOT TERMINAL AND EJ WARD UNIT.
39. FURNISH AND INSTALL EMERGENCY SHUT-OFF SWITCHES AT DESIGNATED LOCATIONS. EMERGENCY SHUT-OFF SWITCHES TO TERMINATE FUEL DISPENSING ACTIVITIES ONCE ACTIVATED.
40. PROVIDE START UP OPERATIONS FOR ENTIRE SYSTEM AND TEST FOR EFFICIENT OPERATION.
41. CONVERT TEMPORARY DIESEL STORAGE TANK "C" TO UNLEADED. REMOVE DIESEL PRODUCT, FLUSH TANK, PIPING, VALVES AND EQUIPMENT AND TRANSFER TANK FROM PRESENT LOCATION (ADJACENT TO EXISTING PUMP CONTROL BUILDING) TO NEW CONCRETE SLAB 1 AS SPECIFIED. CONNECT ELECTRICAL CONDUIT, SENSOR AND TANK GAUGE CONDUIT, AND NEW PRODUCT AND VAPOR RECOVERY PIPING. CONNECT TO NEW LIGHTNING PROTECTION GROUNDING GRID. PLACE HEAVY 400 ORVR VAPOR RECOVERY SYSTEM IN OPERATION.
42. DEMOLISH EXISTING PUMP CONTROL BUILDING AND PROPERLY DISPOSE OF DEBRIS. REMOVE EXISTING ELEVATED CONCRETE SLABS AT FORMER FUEL ISLANDS AND PIPING TRENCH AS SHOWN ON PLANS.
43. CLEAN UP DEBRIS FROM CONSTRUCTION AND RESTORE SITE TO ITS ORIGINAL CONDITION.
44. TOUCH UP TANKS "C", "D", AND "E" AT CONCLUSION OF TANK SETTING USING PAINT SUPPLIED BY GSA.
45. FURNISH AND INSTALL INTERIOR ELASTIC LAMINATE SURFACES AS REQUIRED.
46. IDENTIFY ALL PIPING AND CONNECTIONS AS FOLLOWS:
A) PROVIDE PRODUCT IDENTIFICATION AS LISTED BELOW FOR ALL ABOVEGROUND PIPING AND TANK CONNECTIONS. USE VINYL SELF-STICKING LETTERS AND BANDING TAPE OR PAINT AND STENCILED LETTERING.
B) PROVIDE A MINIMUM 4-INCH BAND FULL CIRCUMFERENCE OF PIPE AT EACH END OF LEGEND AND ARROWS TO INDICATE DIRECTION OF FLOW.

PRODUCT	COLOR/LEGEND
DIESEL	YELLOW
UNLEADED GASOLINE	LIGHT BLUE
VAPOR RECOVERY	ORANGE

P. STD-PC2/DL
9/2/99 TAM-84-JAR, D00-84-MJS
09/12/99 10:00 AM

Graphic Scale

No.	Date	Revisions
1.	9/2/99	MOOREY TANK "B" SECONDARY CONTAINMENT SLAB
2.	9/2/99	ADD CONCRETE JERSEY BARRIERS

THIS DRAWING IS THE PROPERTY OF BBL ENVIRONMENTAL SERVICES, INC. AND MAY NOT BE REPRODUCED OR ALTERED IN WHOLE OR IN PART WITHOUT THE EXPRESS WRITTEN PERMISSION OF BBL ENVIRONMENTAL SERVICES, INC.

Project Mgr. --- ALEX SANCHEZ	PSSSO License Holder:
Designed by --- ALEX SANCHEZ	ALEJANDRO E. SANCHEZ
Drawn by --- MICHAEL SCHNEIDER	License #: P00098813
Checked by --- GABINO GUEVAS, P.E.	Signature: <i>[Signature]</i>
Prof. Eng. --- ALEX SANCHEZ	Date: 9/2/99
PE License --- 221832	


BBL
ENVIRONMENTAL SERVICES, INC.
Remedial Action Management and Construction

GEN. SERVICES ADMINISTRATION
SHOP 3
801 NW 56TH STREET
MIAMI, FLORIDA 33166
CONSTRUCTION DRAWINGS
**GENERAL NOTES
AND SCOPE OF WORK**

File Number
650,12,001F
Date
SEPTEMBER 1999
BBL Environmental Services, Inc.
9775 NW 15th St.
Suite 310
Miami Lakes, FL 33016
305-428-3363

G-1

6

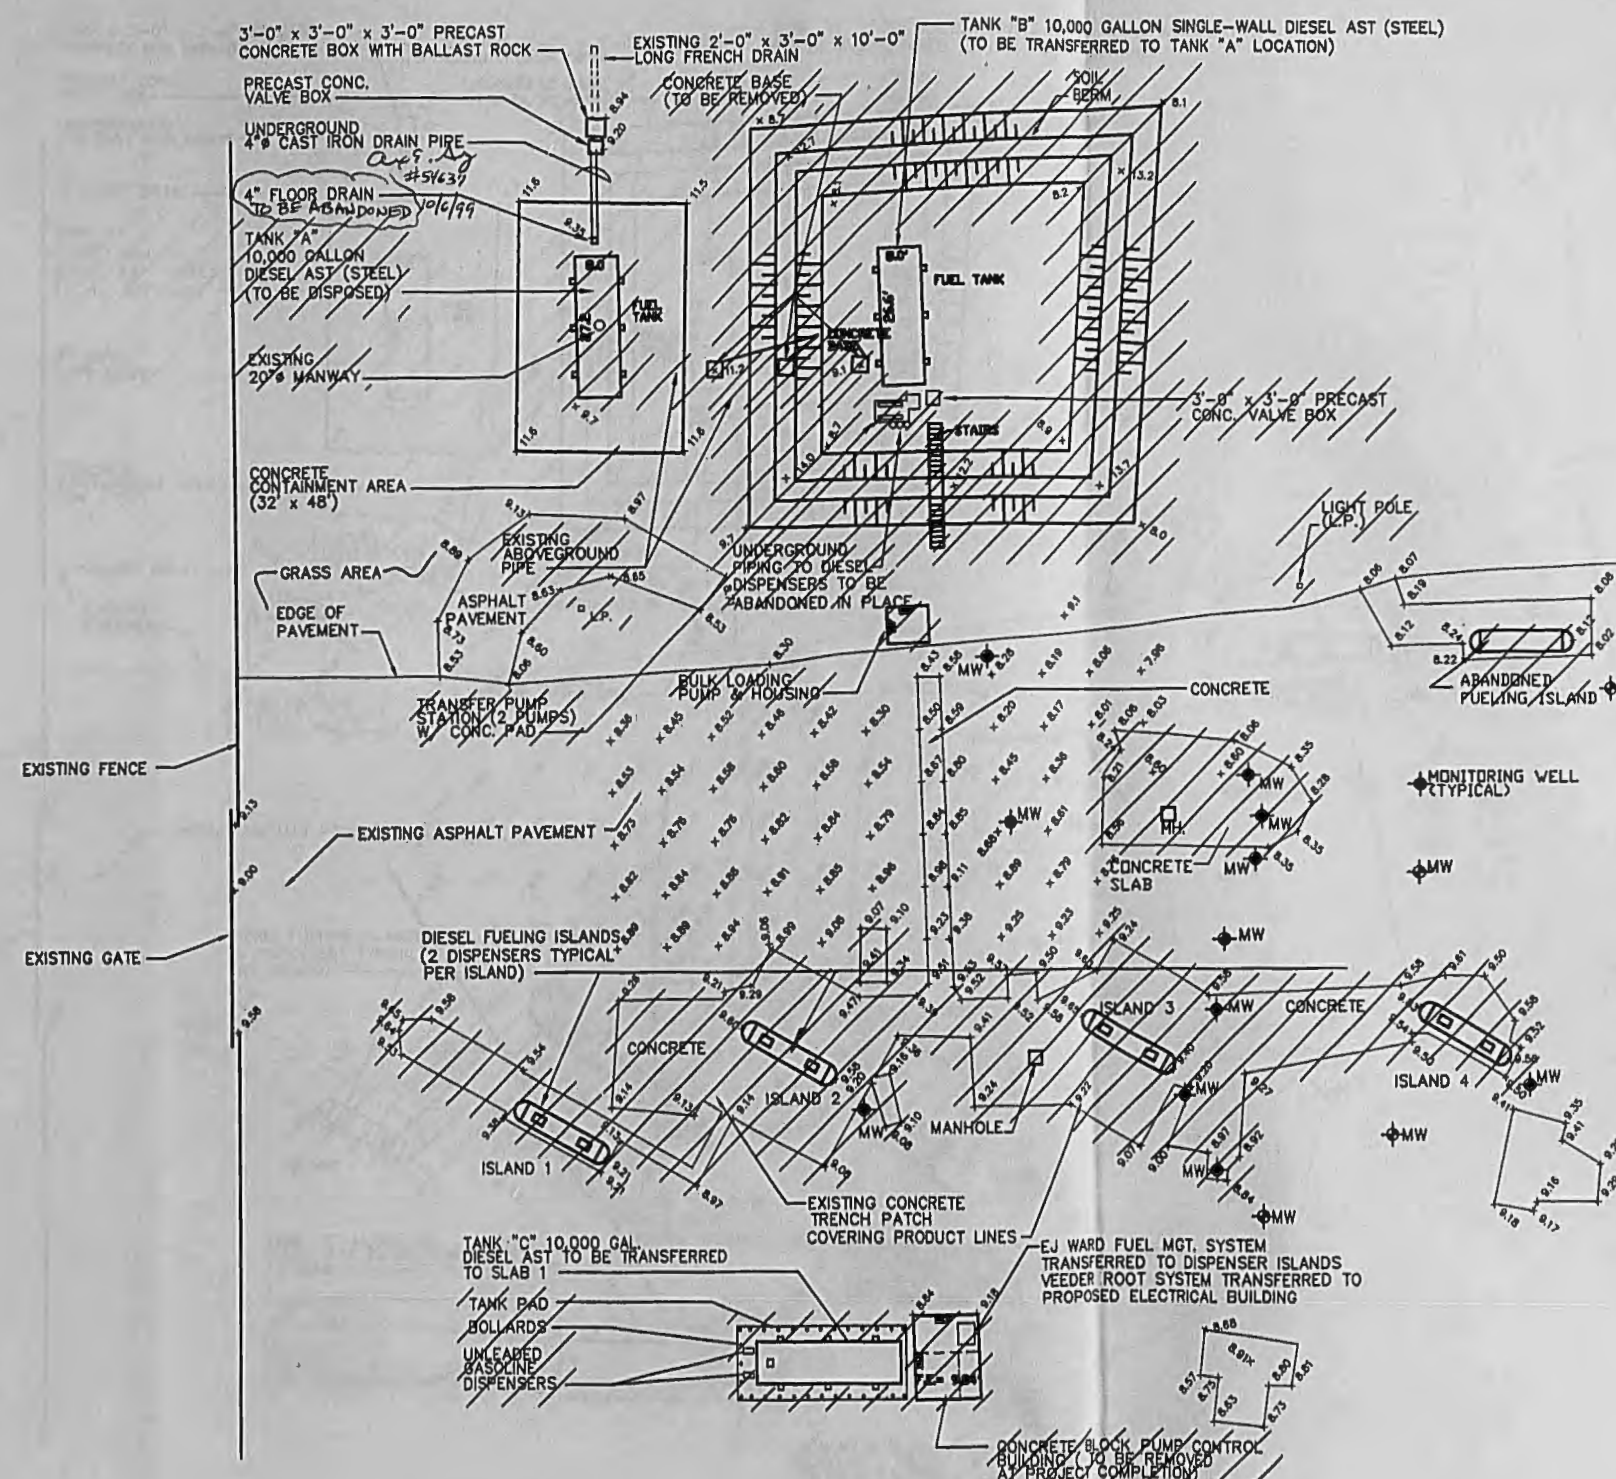

EXISTING TANK "B" SECONDARY CONTAINMENT CAPACITY

VOLUME = $H/3 (A + B + (A \times B)^{1/2})$
 H = CONTAINMENT DEPTH = 11.6 - 9.7 = 1.9'
 TOP TRAPEZOID AREA = 32' X 48' = 1536 SQ.FT.
 BOTTOM TRAPEZOID AREA = 10' X 31' = 310 SQ.FT.
 VOLUME = $1.9' / 3 (1536 \text{ SQ.FT.} + 310 \text{ SQ.FT.} + (1536 \times 310)^{1/2})$
 VOLUME (GALLONS) = 1805 CU.FT. X 7.48 GALLONS/CU.FT. = 12,008 GALLONS
 SAFETY FACTOR = CONTAINMENT CAPACITY / TANK CAPACITY
 SAFETY FACTOR = 12,008 GAL/10,000 GAL = 1.20

LEGEND

◆ EXISTING MONITORING WELL
 /// TO BE REMOVED

NOTE:
 ELEVATIONS BASED ON DADE COUNTY BENCHMARK
 LOCATOR # 3033
 NS34 7.42
 LOCATED AT N.W. 58th ST. AND 87th AVE.

PI: 8TD-PC2/DL
 9/2/99 TAU-54-JAR, MJS
 55612/556120-2.DWG

Graphic Scale
 1" = 20'

THIS DRAWING IS THE PROPERTY OF DBL ENVIRONMENTAL SERVICES, INC. AND MAY NOT BE REPRODUCED OR ALTERED IN WHOLE OR IN PART WITHOUT THE EXPRESS WRITTEN PERMISSION OF DBL ENVIRONMENTAL SERVICES, INC.

No.	Date	Revisions	Init.
1.	9/27/99	ADD TANK "B" SECONDARY CONTAINMENT CALCULATIONS	JAR

Project Mgr. --- ALEX SANCHEZ
 Designed by --- ALEX SANCHEZ
 Drawn by --- MICHAEL SCHROEDINGER
 Checked by --- GABINO CUEVAS, P.E.
 Prof. Eng. --- ALEX SANCHEZ
 PE License --- #54937

PSSC License Holder:
 ALEJANDRO E. SANCHEZ
 License #1 P00056813
 Signature: *Alex Sanchez*
 Date: 9/1/99


APPROVED
 H. 54137 9/1/99

BBL
 ENVIRONMENTAL SERVICES, INC.
 Remedial Action Management and Construction

SERVICES ADMINISTRATION
 SHOP 3
 501 NW 88TH STREET
 MIAMI, FLORIDA 33166
 CONSTRUCTION DRAWINGS
EXISTING SITE PLAN

File Number
 886.12.002F
 Date
 SEPTEMBER 1999
 BBL Environmental Services, Inc.
 7975 NW 154th St.
 Suite 310
 Miami Lakes, FL 33016
 305-820-3363

G-2

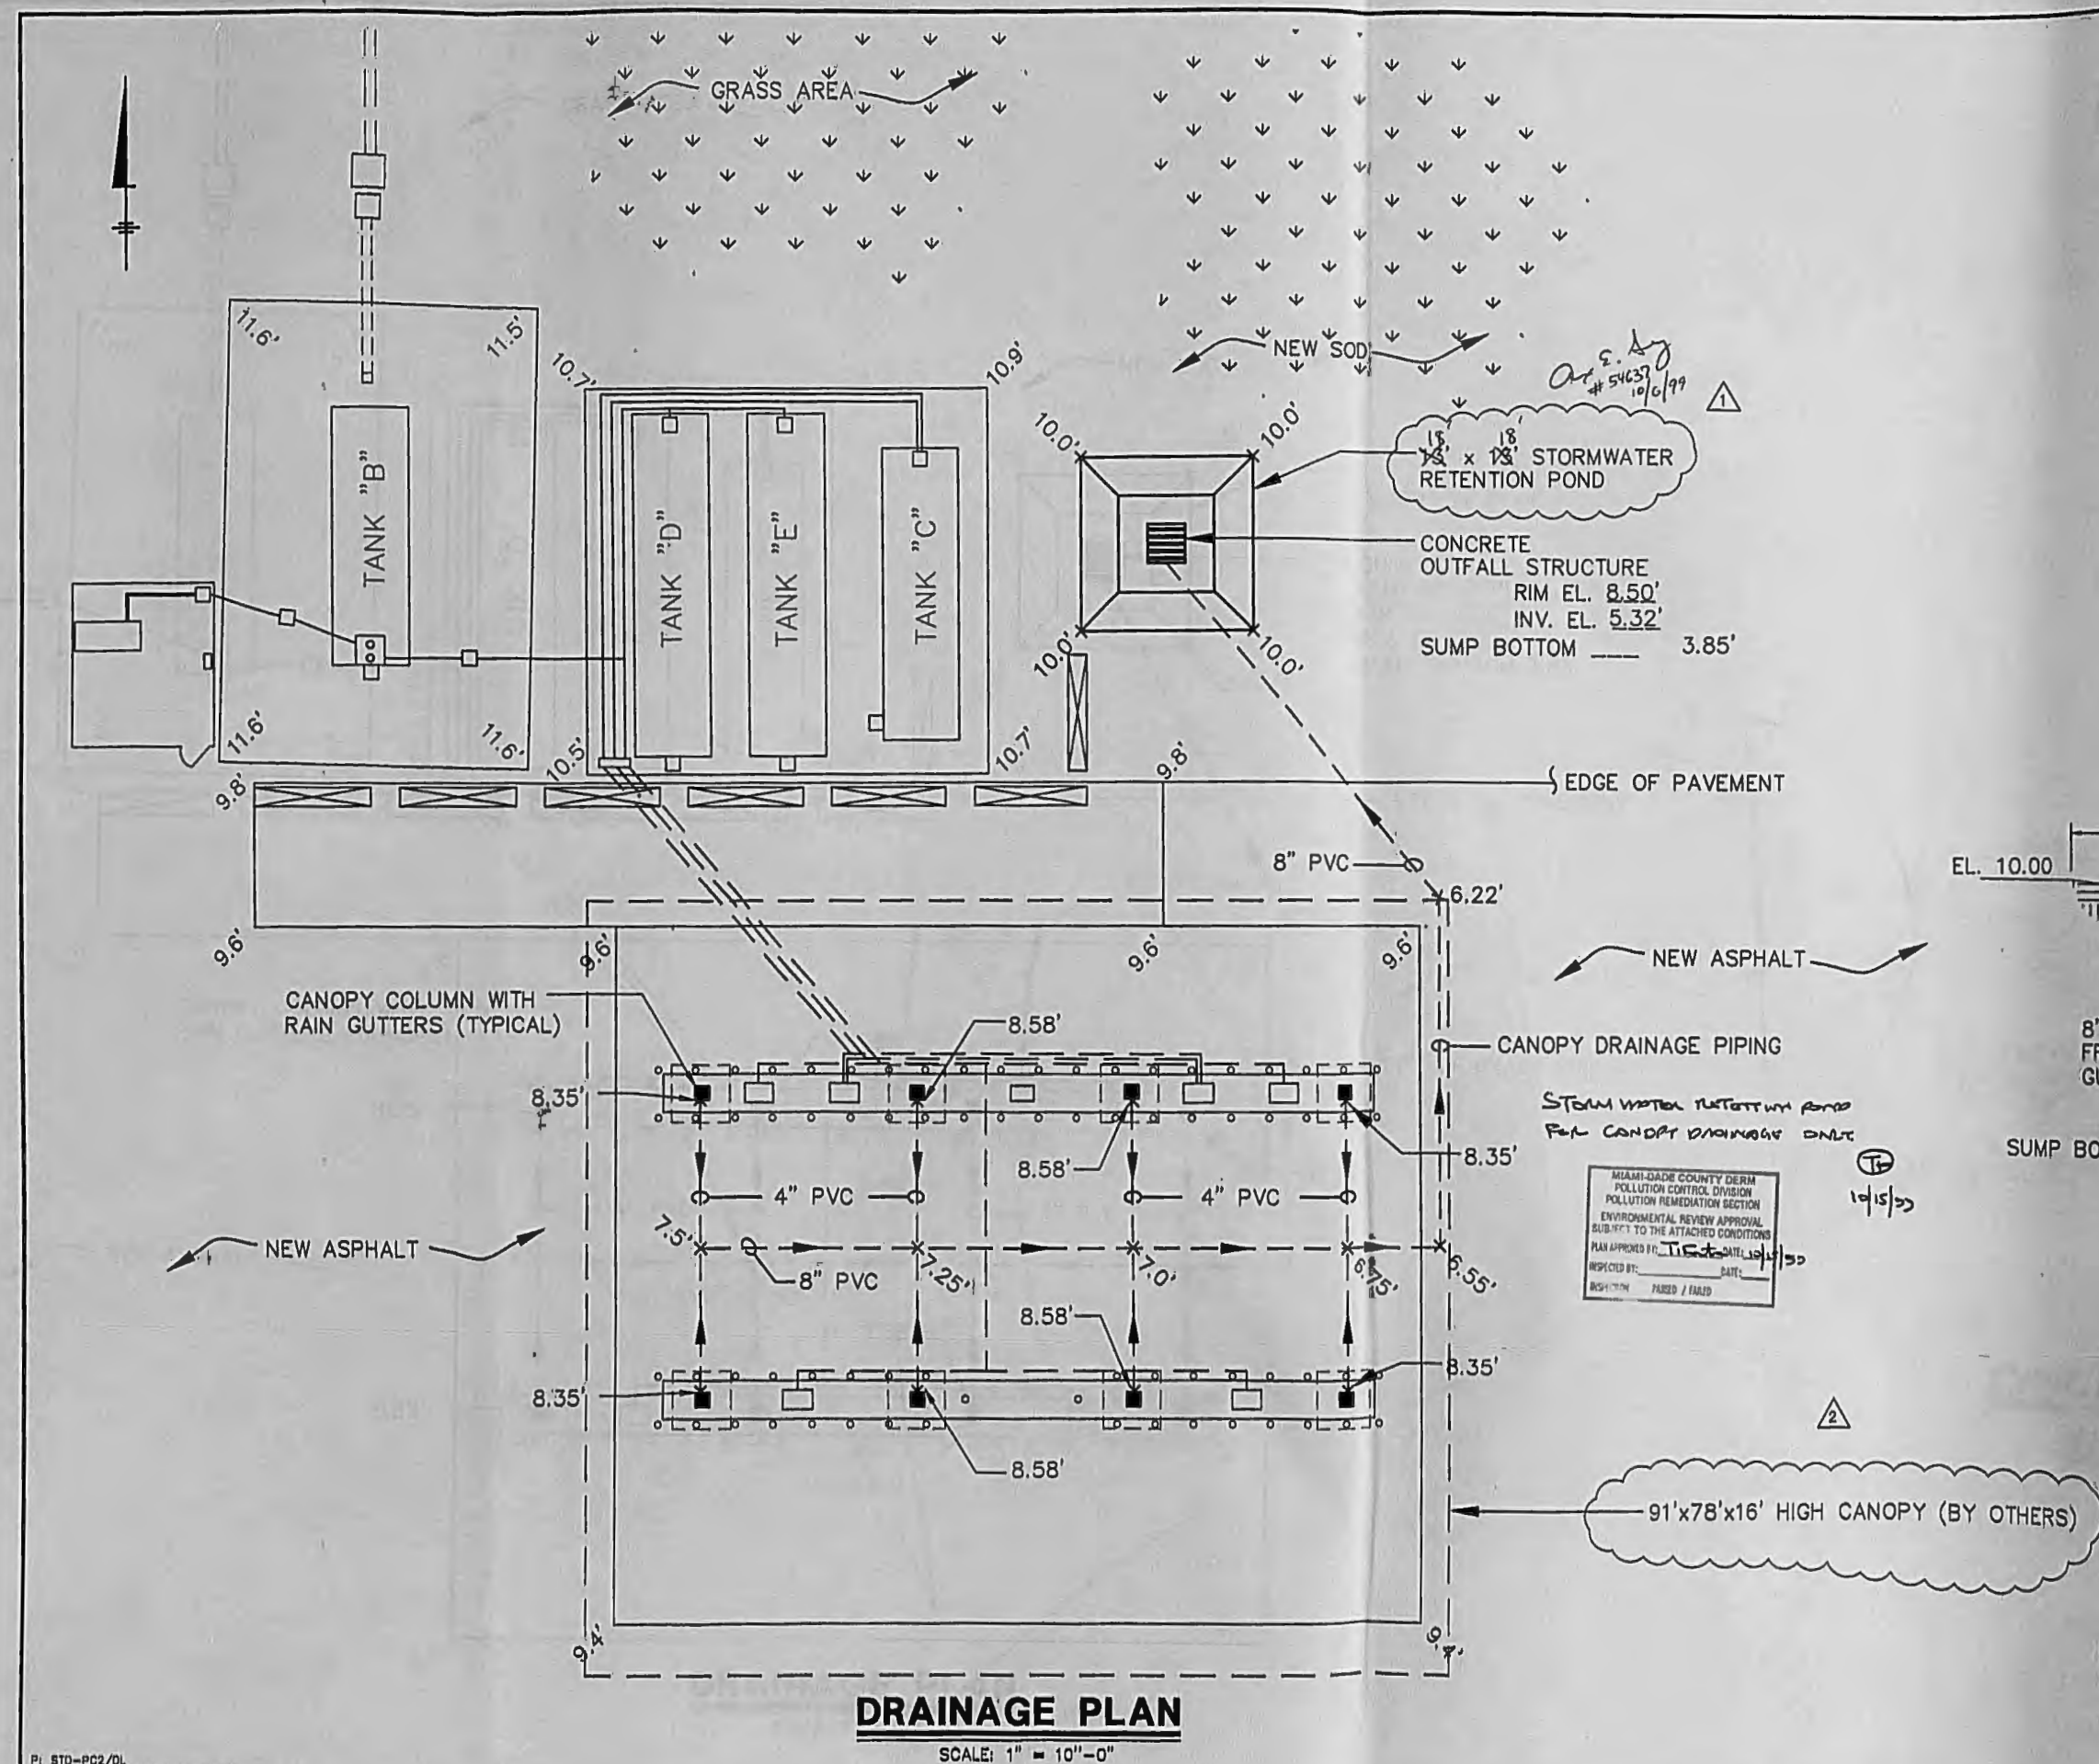

P: STD-PC2/DL
9/8/99 MIA-04-MJS TAM-04-JAR
05512/055120-4 DWG

Graphic Scale
0 10
APPROXIMATE SCALE IN FEET

THIS DRAWING IS THE PROPERTY OF BDL ENVIRONMENTAL SERVICES, INC. AND MAY NOT BE REPRODUCED OR ALTERED IN WHOLE OR IN PART WITHOUT THE EXPRESS WRITTEN PERMISSION OF BDL ENVIRONMENTAL SERVICES, INC.

No.	Date	Revisions	INIT.	Project Mgr.
1	9/07/98	MODIFY LOCATION OF RETENTION POND	JAR	ALEX SANCHEZ
2	9/08/99	SHOW CANOPY	JAR	ALEX SANCHEZ
				Designed by
				Drawn by
				Checked by
				Prof. Eng.
				P.E. License



Project Mgr. --- ALEX SANCHEZ
Designed by --- ALEX SANCHEZ
Drawn by --- MICHAEL SCHROEDER
Checked by --- GABRIEL GUEVARA, P.E.
Prof. Eng. --- ALEX SANCHEZ
P.E. License --- 284932

BBL
ENVIRONMENTAL SERVICES, INC.
Remedial Action Management and Construction

GENERAL SERVICES ADMINISTRATION
SHOP 3
301 NW 30TH STREET
MIAMI, FLORIDA 33136
CONSTRUCTION DRAWINGS
DRAINAGE PLAN AND DETAILS


File Number
05512.004F
Date
SEPTEMBER 1999
BDL Environmental Services, Inc.
7975 NW 154th St.
Suite 310
Miami Lakes, FL 33016
305-628-3303


G-4

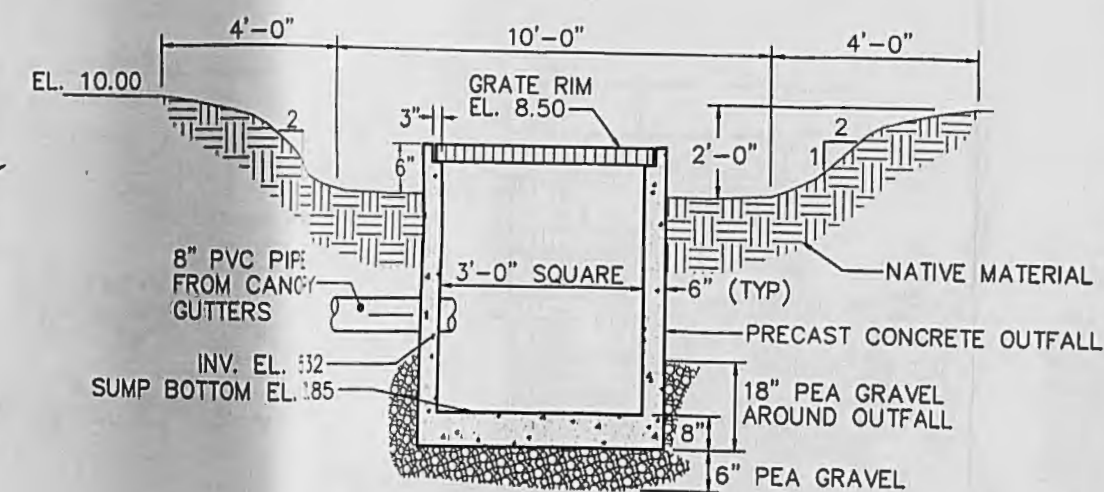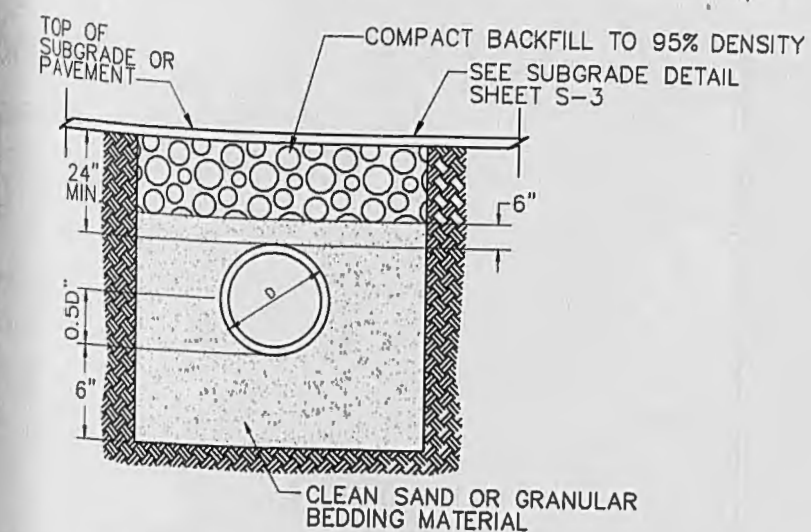


NOTES:
1. ELEVATIONS FOR DRAINAGE PIPE ARE PIPE INVERT ELEVATIONS.
2. GRASS AREA SURROUNDING STORMWATER RETENTION POND MUST BE REGRADED SO THAT POND IS NOT AREA LOW POINT.
3. ELEVATIONS FOR CONCRETE OR SOD ARE FOR TOP OF SURFACE.

MIAMI-DADE COUNTY DEPT.
POLLUTION CONTROL DIVISION
POLLUTION REMEDIATION SECTION
DISAPPROVED: [Signature] DATE: 9/15/99

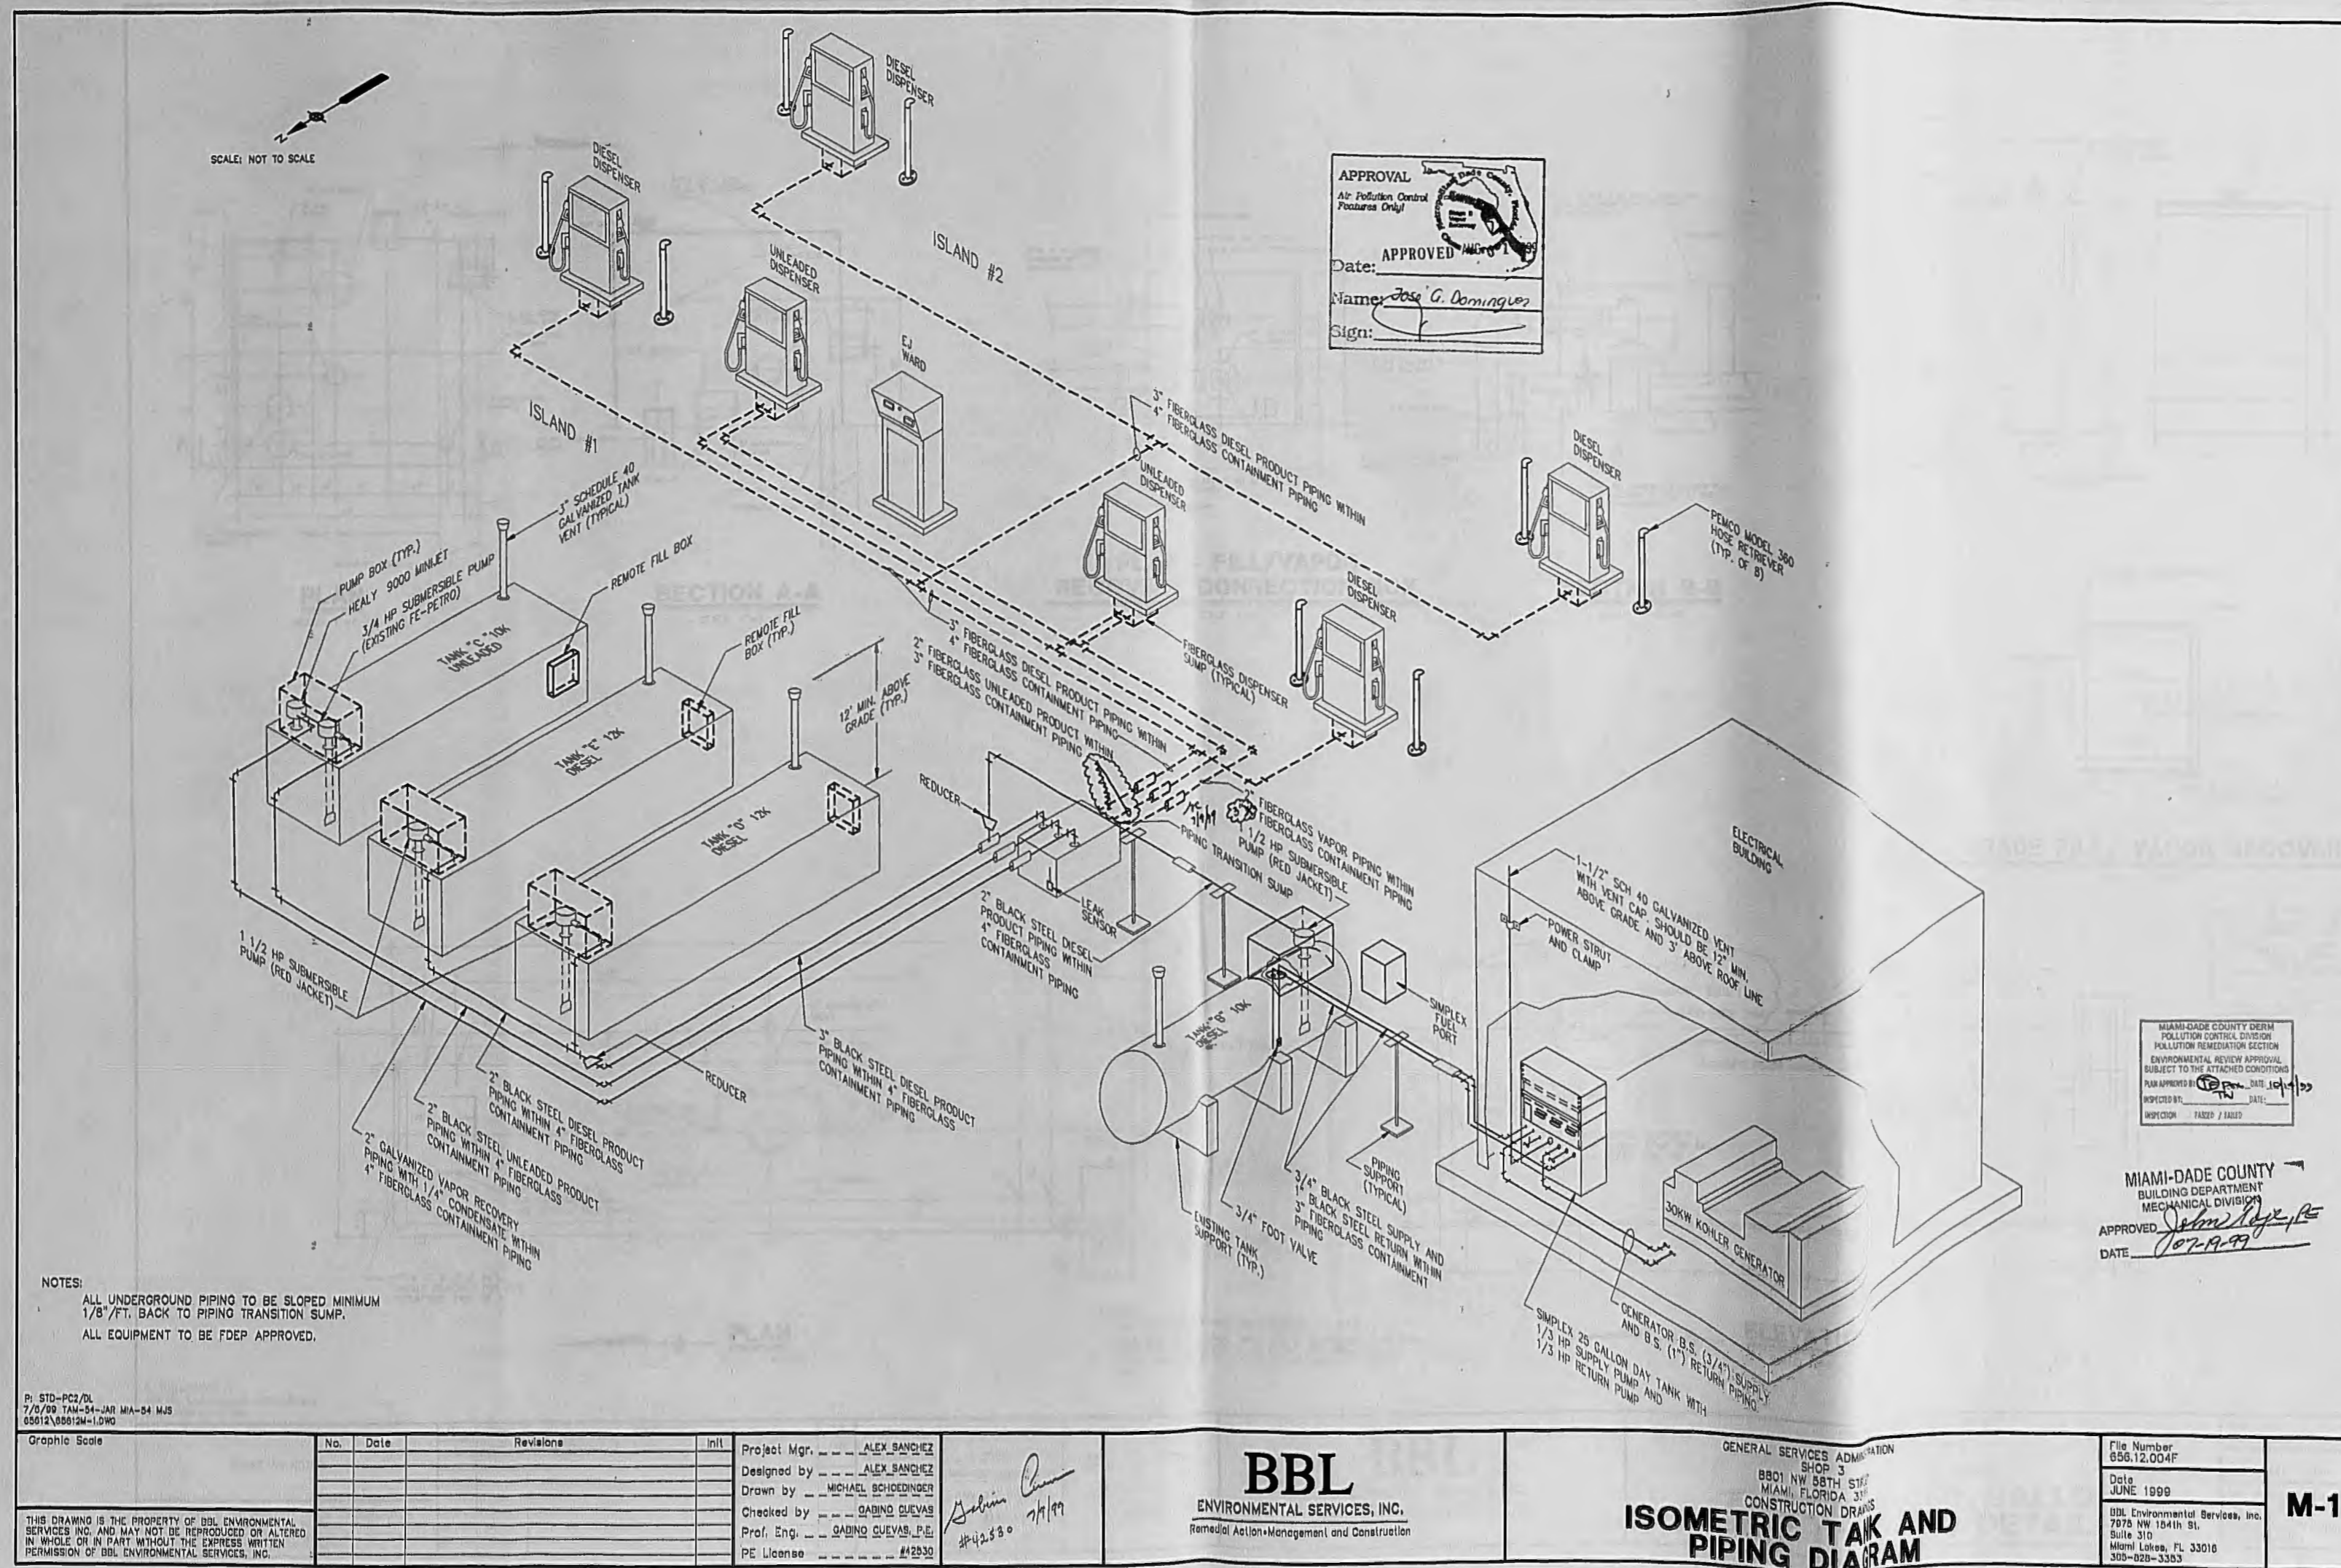


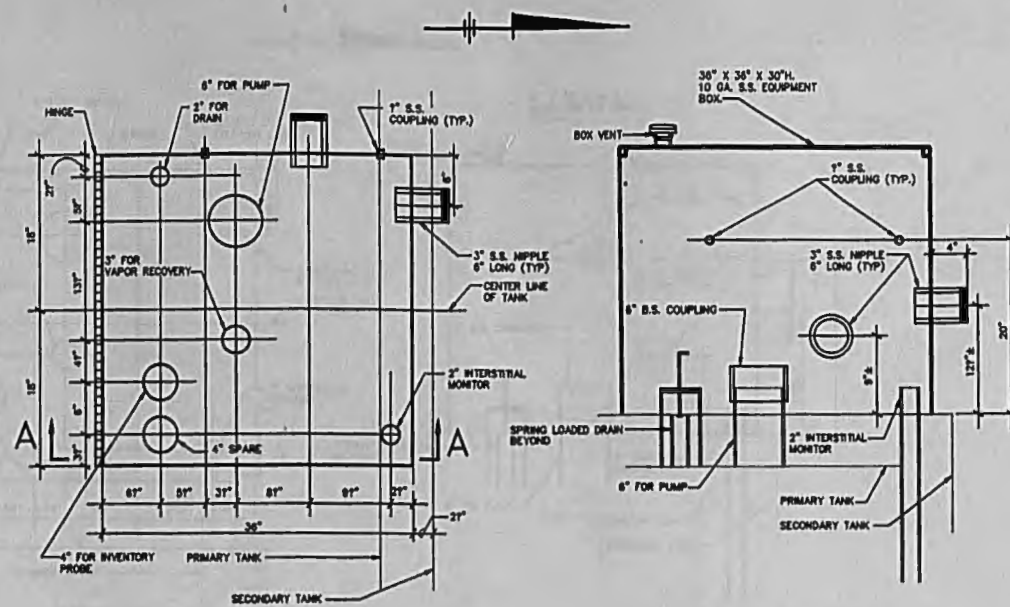


SECTION A-A
SCALE: 1"=1'-0"

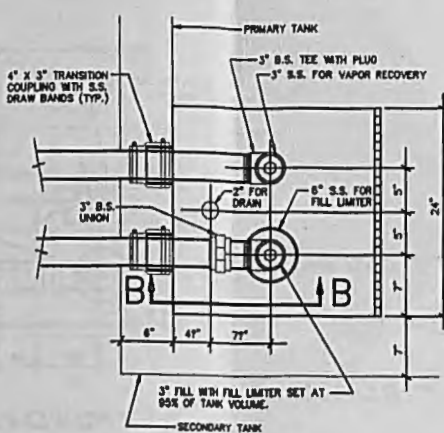


PLAN - FILL/VAPOR
RECOVERY CONNECTION BOX
SCALE: 1"=1'-0"

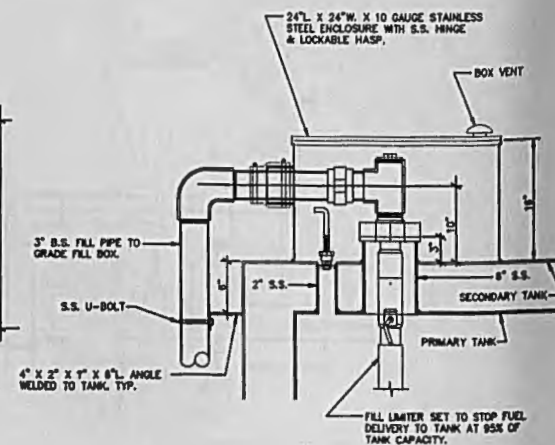


SECTION B-B
SCALE: 1"=1'-0"

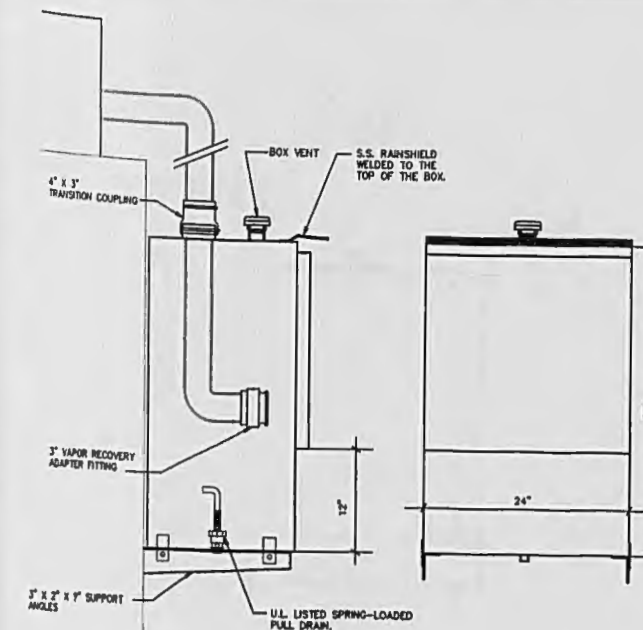

PLAN - GRADE FILL/VAPOR RECOVERY BOX
SCALE: 1"=1'-0"

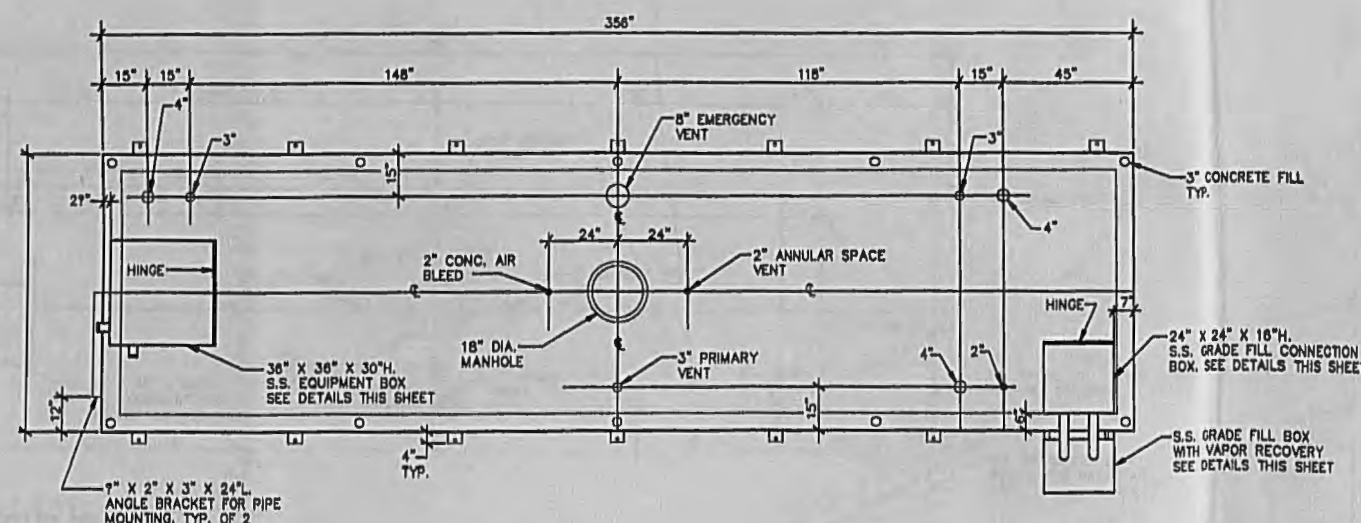

PLAN
SCALE: 1"=3'-0"

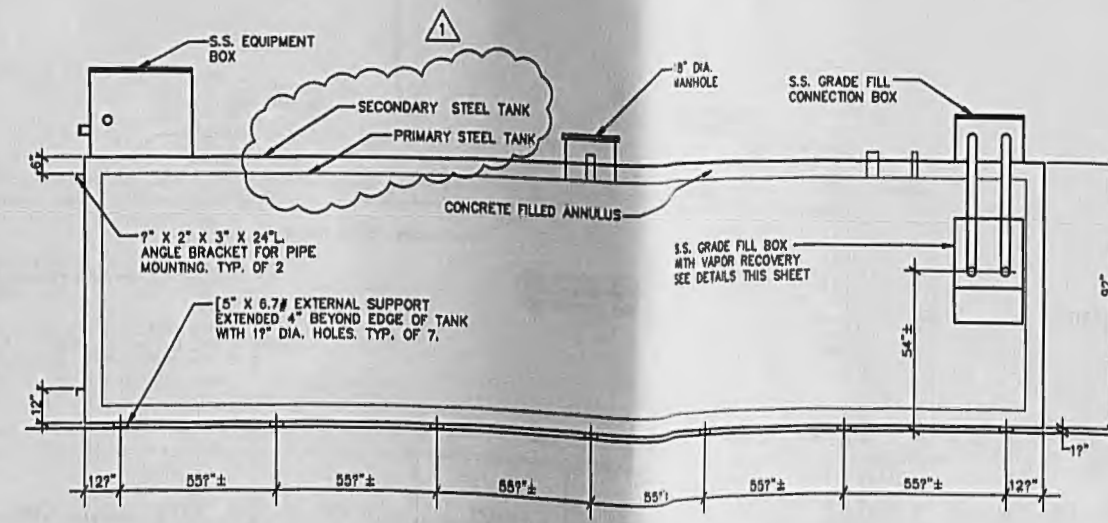

ELEVATION
SCALE: 1"=3'-0"

- NOTES:
1. ALL TANK TOP FITTINGS ARE THREADED S.S. PIPE.
 2. EXTERIOR FINISH: COMM. WHITE METAL SANDBLAST, 3 TO 4 MIL INORGANIC ZINC PRIMER, 8 TO 10 MIL INTERMEDIATE GLASS FLAKE EPOXY COAT & 2 TO 3 MIL POLYURETHANE TOP COAT.

P: STD-PC2/DL
9/8/99 TAM-54-JAR, DDD-54-MJS
001/2/0001/01-2-DWG

Graphic Scale
SCALE AS NOTED

THIS DRAWING IS THE PROPERTY OF BDL ENVIRONMENTAL SERVICES, INC. AND MAY NOT BE REPRODUCED OR ALTERED IN WHOLE OR IN PART WITHOUT THE EXPRESS WRITTEN PERMISSION OF BDL ENVIRONMENTAL SERVICES, INC.

No.	Date	Revisions	Init
1.	9/07/99	SHOW SECONDARY/PRIMARY TANK AS STEEL	JAR

Project Mgr. --- ALEX SANCHEZ
Designed by --- ALEX SANCHEZ
Drawn by --- MICHAEL SCHROEDER
Checked by --- GABINO QUEVAS, P.E.
Prof. Eng. --- ALEX SANCHEZ
PE License --- #54537

Rev. 5/1/99
54637
9/9/99


BBL
ENVIRONMENTAL SERVICES, INC.
Remedial Action Management and Construction

GEN. SERVICES ADMINISTRATION
SHOP 3
101 NW 56TH STREET
MIAMI, FLORIDA 33166
CONSTRUCTION DRAWINGS



**EXISTING 10,000 GALLON
AST (TANK "C") DETAILS**

File Number
05612.008F
Date
SEPTEMBER 1999
BDL Environmental Services, Inc.
7070 NW 184th St.
Suite 310
Miami Lakes, FL 33016
305-528-3353








M-2

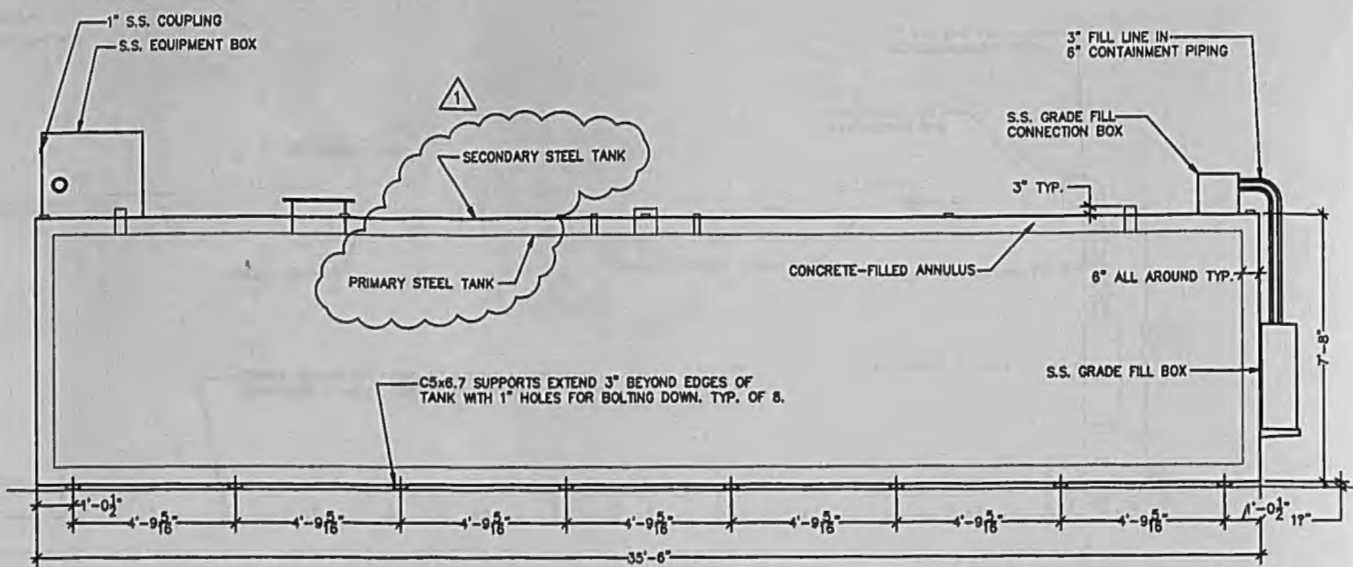

- NOTES:
1. ALL TANK TOP FITTINGS ARE THREADED S.S. PIPE.
 2. EXTERIOR FINISH: COMM. WHITE METAL SANDBLAST, 3 TO 4 MIL INORGANIC ZINC PRIMER, 8 TO 10 MIL INTERMEDIATE GLASS FLAKE EPOXY COAT & 2 TO 3 MIL POLYURETHANE TOP COAT.
 3. TANK SHALL BE PROVIDED WITH 1" THICK X FULL LENGTH NEOPRENE PADS FOR EACH OF THE TANK SUPPORT FEET.

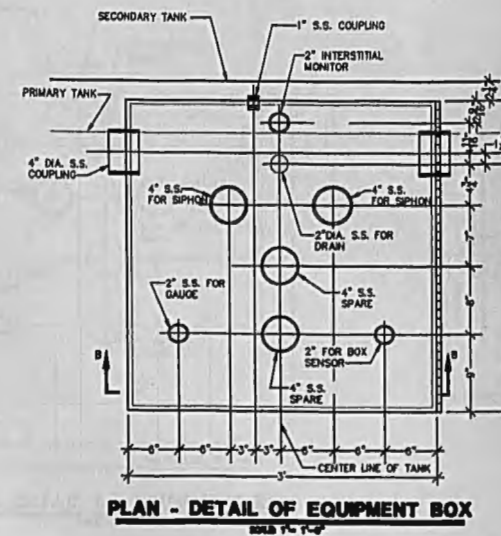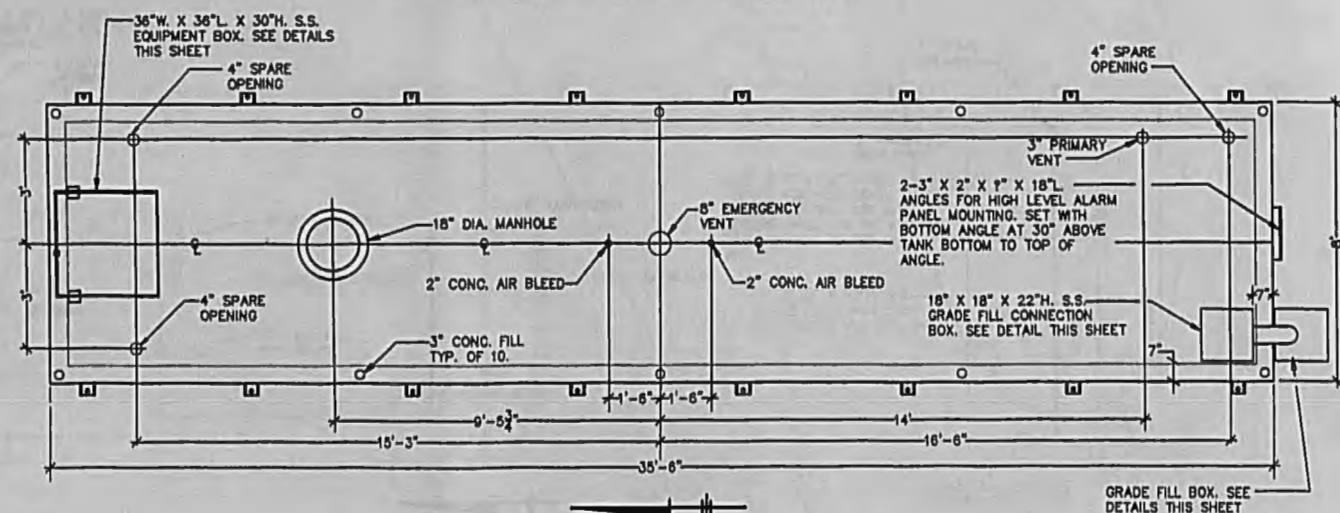

NOTE:
1. ALL TANK NIPPLES SHALL BE 304 STAINLESS STEEL.

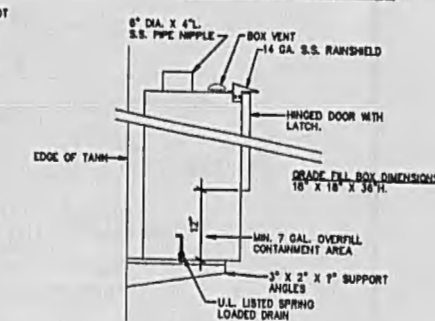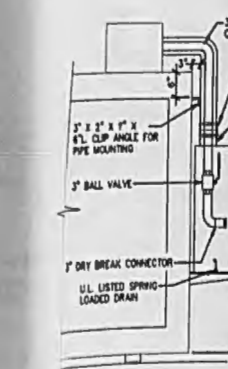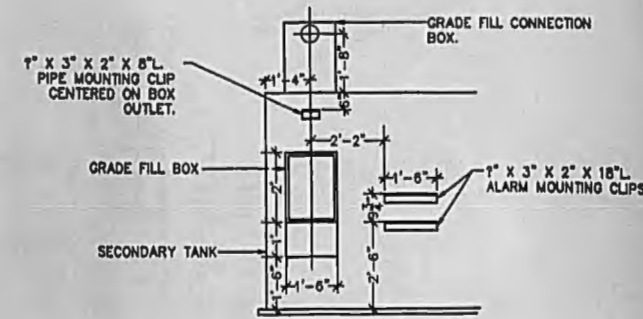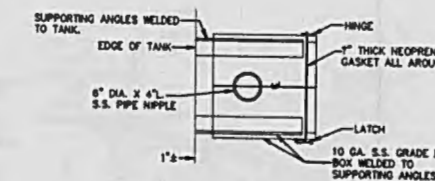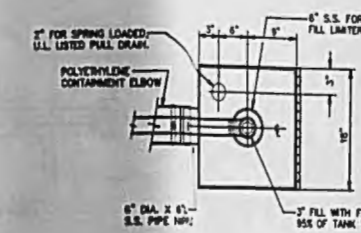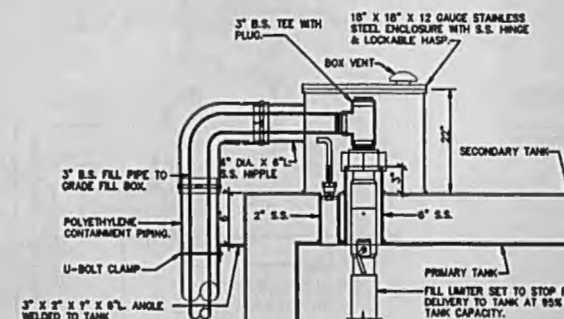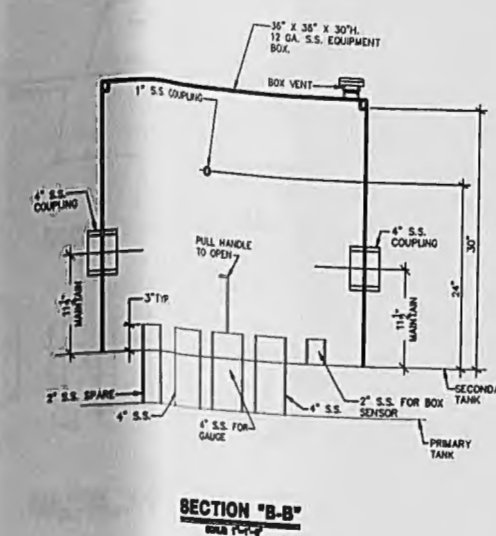

P: STD-PC2/OL
9/8/99 TAN-04-JAR, 000-04-MJS
05012/05012M-3.DWG

Graphic Scale

SCALE AS NOTED

THIS DRAWING IS THE PROPERTY OF BDL ENVIRONMENTAL SERVICES, INC. AND MAY NOT BE REPRODUCED OR ALTERED IN WHOLE OR IN PART WITHOUT THE EXPRESS WRITTEN PERMISSION OF BDL ENVIRONMENTAL SERVICES, INC.

No.	Date	Revisions	Init	Project Mgr.
1.	9/07/99	SHOW SECONDARY/PRIMARY TANK AS STEEL	JAR	ALEX SANCHEZ
				Designed by -- ALEX SANCHEZ
				Drawn by -- MICHAEL SCHROEDER
				Checked by -- GABINO GUEVARA, P.E.
				Prof. Eng. -- ALEX SANCHEZ
				PE License -- #24932

BBL
ENVIRONMENTAL SERVICES, INC.
Remedial Action-Management and Construction


GENERAL SERVICES ADMINISTRATION
SHOP 3
201 NW 58TH STREET
MIAMI, FLORIDA 33166
CONSTRUCTION DRAWINGS
**EXISTING 12000 GALLON AST
(TANK "D" & "E") DETAILS**

File Number
05012.0008F
Date
SEPTEMBER 1999
BDL Environmental Services, Inc.
7075 NW 154th St.
Suite 310
Miami Lakes, FL 33016
305-625-3353

M-3


TANK FITTING SCHEDULE		
PORT	DESCRIPTION	SIZE
A	ENGINE SUPPLY DROP TUBE	0.50" NPT, MALE
B	SIPHON DRAIN DROP TUBE	0.50" NPT, MALE
C	OVERFLOW PORT	1.00" NPT, FEMALE
D	ENGINE RETURN PORT	1.00" NPT, FEMALE
E	EXTRA PIPE FLANGE	1.00" NPT, FEMALE
F	TANK VENT PORT	1.50" NPT, FEMALE
G	MANUAL FILL PORT	2.00" NPT, FEMALE
H	HAND PUMP MOUNTING PORT	0.75" NPT, FEMALE
J	PUMP CONNECTION TO TANK DROP TUBE	0.50" NPT, MALE
K	FLOATSWITCH MTO/INSPECTION PORT	3.50" NPT, FEMALE
L	RUPTURE BASIN DRAIN	.375" NPT, FEMALE
M	PUMP MOTOR MOUNTING BRACKET	

PUMP INLET		
PUMP	GPM	INLET SIZE
STANDARD	2 GPM	.50" NPT INLET

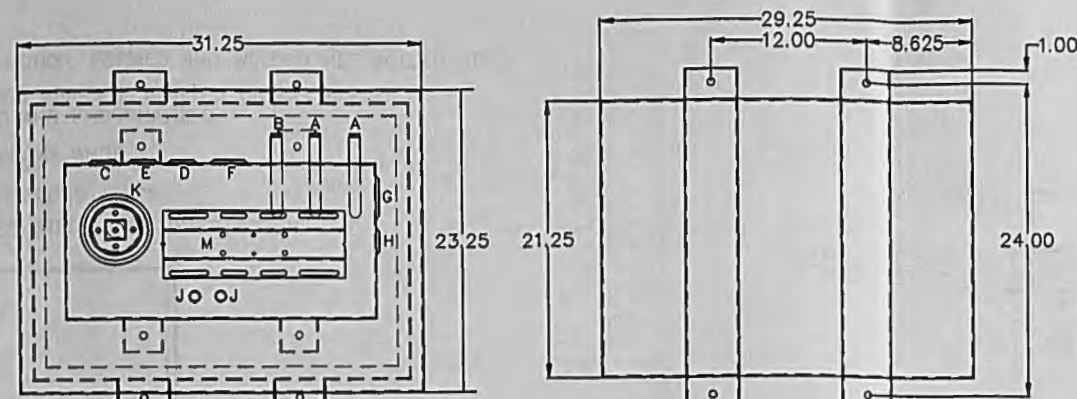


TANK FITTINGS
TOP VIEW


TANK MOUNTING DETAIL

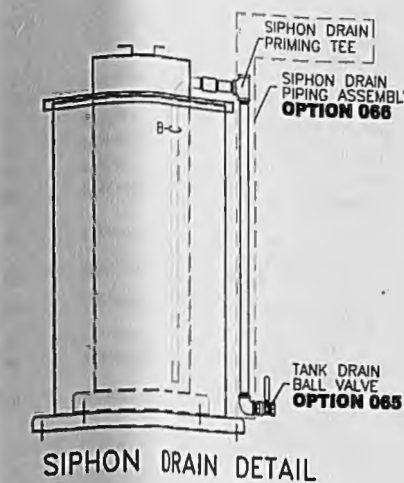


SIPHON DRAIN DETAIL

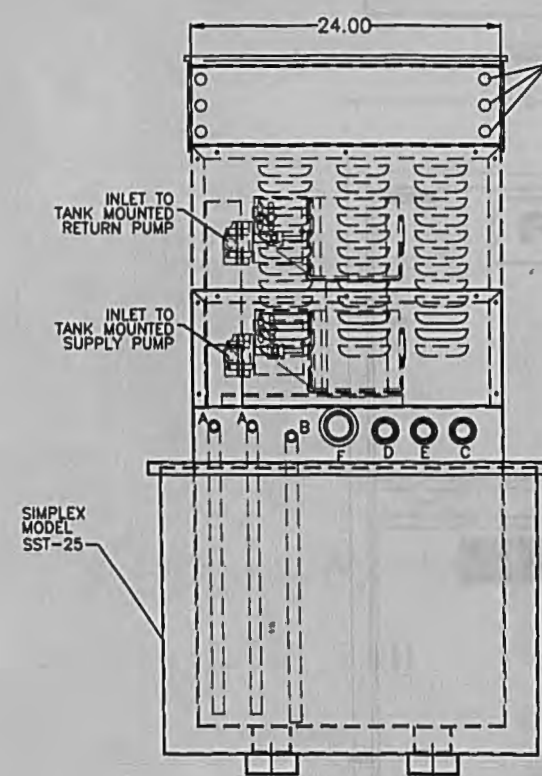


REAR VIEW

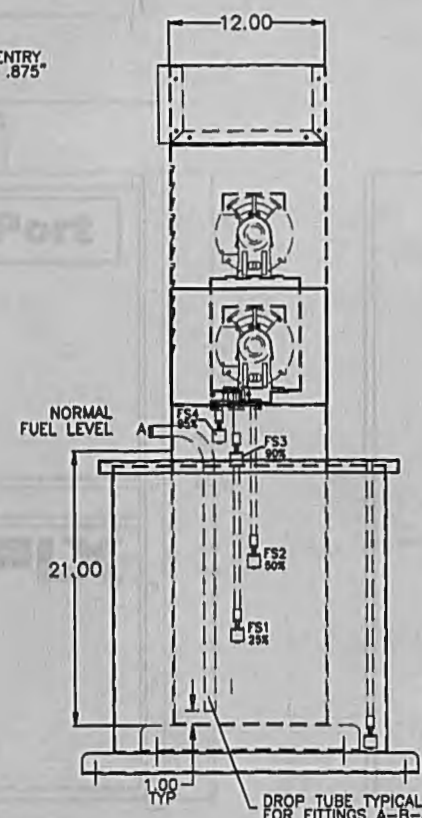

LEFT SIDE VIEW

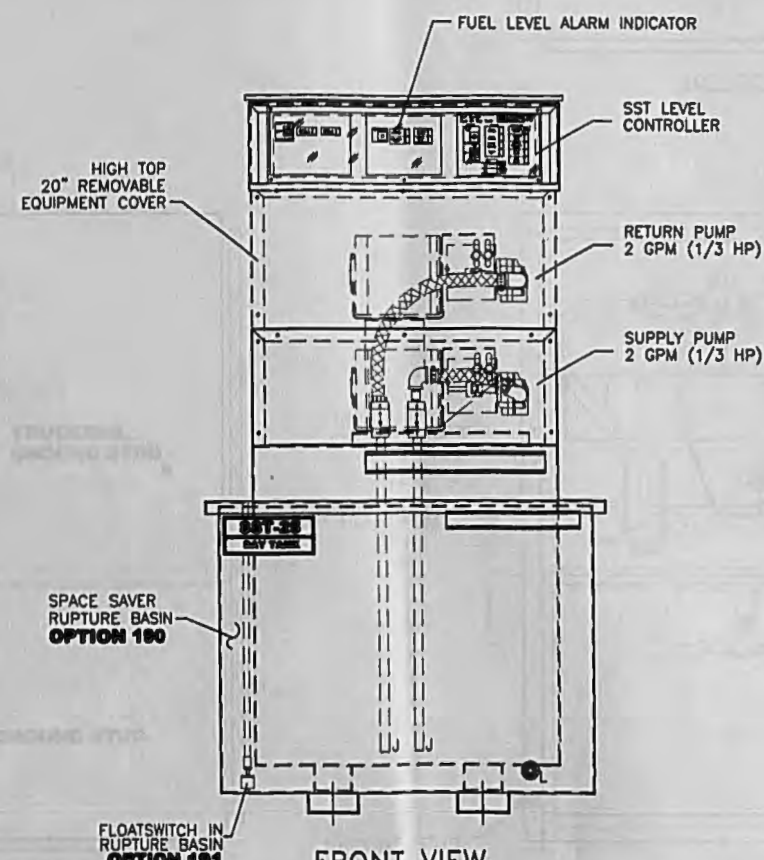

FRONT VIEW

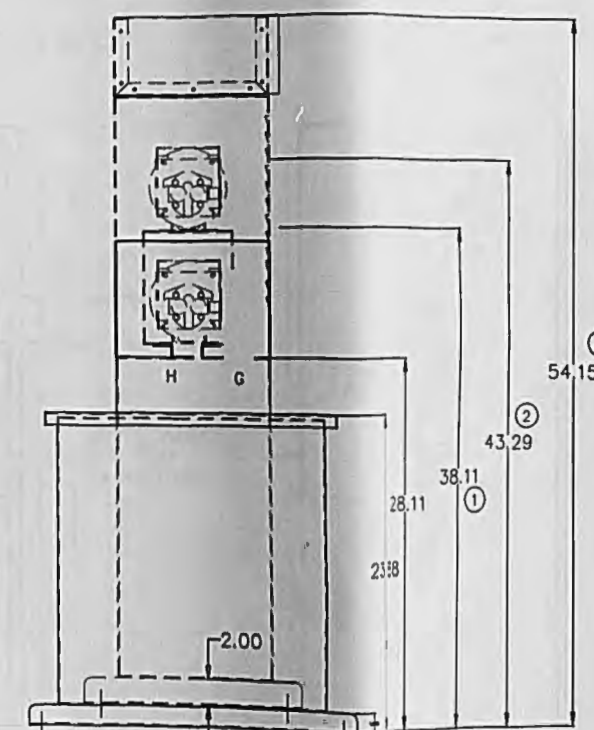

RIGHT SIDE VIEW

- DAY TANK HEIGHT**
- ① WITHOUT ON-BOARD PUMP
 - ② WITH SINGLE PUMP 1/3 & 1/2 H.P.
 - ③ WITH SINGLE PUMP 3/4 & 1 H.P. OR DUPLEX PUMPS

OPTIONS INSTALLED	OPTIONS SHIPPED LOOSE
<input type="checkbox"/> 065-TANK DRAIN BALL VALVE	<input type="checkbox"/> 060-FUEL STRAINER, Y-TYPE, .75" NPT., 40 MESH
<input type="checkbox"/> 066-SIPHON DRAIN PIPING ASSEMBLY	<input type="checkbox"/> 063-VENT CAP
<input type="checkbox"/> 069-SOLENOID VALVE, N.C. 120VAC	<input type="checkbox"/> 067-MANUAL SHUT-OFF BALL VALVE .50"NPT
<input type="checkbox"/> 100-SPACE SAVER RUPTURE BASIN	<input type="checkbox"/> 090-FOOT VALVE 1.00" NPT
<input type="checkbox"/> 101-FLOATSWITCH IN RUPTURE BASIN	
<input type="checkbox"/> 300-OVERFLOW RETURN PUMP & CONTROLLER	

- NOTES:
- 1) CONSTRUCTION: 12 GA HRS
 - 2) LISTING: UL 142
 - 3) RATING: ATMOSPHERIC TANK TESTED TO 5 PSI
 - 4) FINISH: TANK PRIMED AND FINISH PAINTED ASA 61 LIGHT GRAY
RUPTURE BASIN PRIMED AND FINISH PAINTED ASA 61 LIGHT GRAY
EQUIPMENT COVER PRIMED AND FINISH PAINTED ASA 61 POLYURETHANE GRAY
 - 5) DUE TO SYSTEM COMPLEXITY, SOME COMPONENTS MAY NOT BE VISIBLE IN ALL VIEWS
 - 6) ALL DIMENSIONS ±.125"
 - 7) TANK FITTINGS A-M ARE STANDARD ON ALL TANKS

MIAMI-DADE COUNTY
BUILDING DEPARTMENT
MECHANICAL DIVISION
APPROVED: *[Signature]*
DATE: 02-19-99

MIAMI-DADE COUNTY DEPT.
POLLUTION CONTROL DIVISION
POLLUTION REMEDIATION SECTION
ENVIRONMENTAL REVIEW APPROVAL
SUBJECT TO THE ATTACHED CONDITIONS
PERMIT APPROVAL: *[Signature]* DATE: 02-19-99
INSPECTED BY: *[Signature]* DATE: *[Signature]*
REVISION: PARSED 7 EMBD

P: STD-PC2/DL
7/6/90 TAM-54-JAR, WJS
65612/65612M04.DWG

Graphic Scale

NOT TO SCALE

THIS DRAWING IS THE PROPERTY OF BBL ENVIRONMENTAL SERVICES, INC. AND MAY NOT BE REPRODUCED OR ALTERED IN WHOLE OR IN PART WITHOUT THE EXPRESS WRITTEN PERMISSION OF BBL ENVIRONMENTAL SERVICES, INC.

No.	Date	Revisions	Init.

Project Mgr. --- ALEX SANCHEZ
Designed by --- ALEX SANCHEZ
Drawn by --- MICHAEL SCHOEDINGER
Checked by --- GABINO QUEVAS
Prof. Eng. --- GABINO QUEVAS, P.E.
PE License --- #42230

[Signature]
7/6/90

BBL
ENVIRONMENTAL SERVICES, INC.
Remedial Action/Management and Construction

GENERAL SERVICES ADMINISTRATION
SHOP 3
8901 NW 88TH STREET
MIAMI, FLORIDA 33181
CONSTRUCTION DRAWS


SIMPLEX DAY TANK DETAILS

File Number:
65612.007F
Date:
JUNE 1999
BBL Environmental Services, Inc.
7975 NW 154th St.
Suite 310
Miami Lakes, FL 33016
305-428-3303


M-4

NOTES:


1. CONSTRUCTION: FORMED AND WELDED HOT ROLLED STEEL
2. ALL PARTS ABRASIVE BLASTED OR CHEMICALLY CLEANED AND PHOSPHATIZED
3. PAINT: EPOXY WHITE
4. ALL DIMENSIONS $\pm .125$
5. STAINLESS STEEL BOX CONSTRUCTION

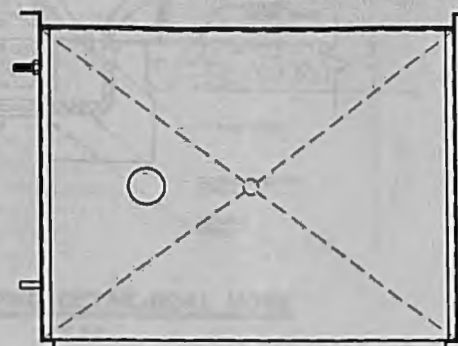


SECTION A-A

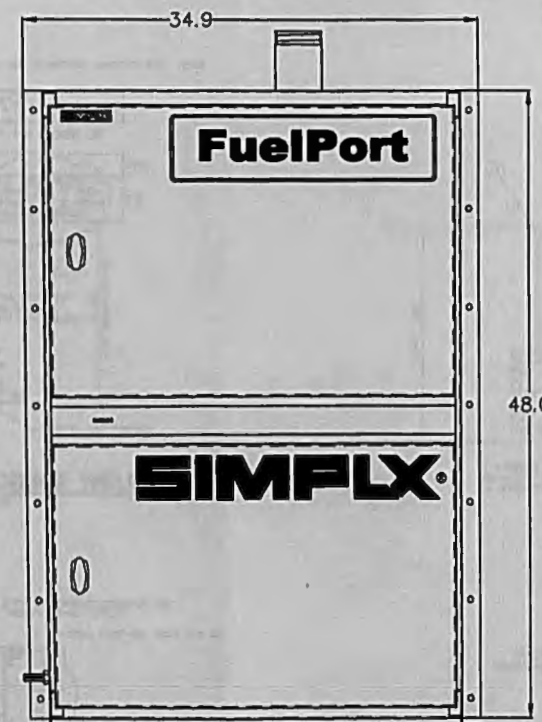


FRONT VIEW WITH DOORS

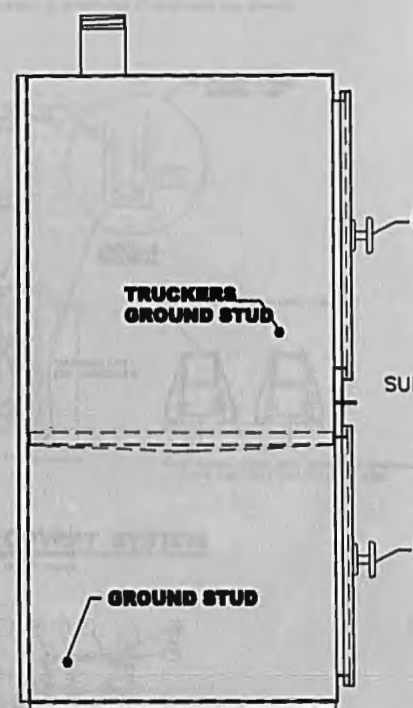

LEFT SIDE VIEW WITH DOORS

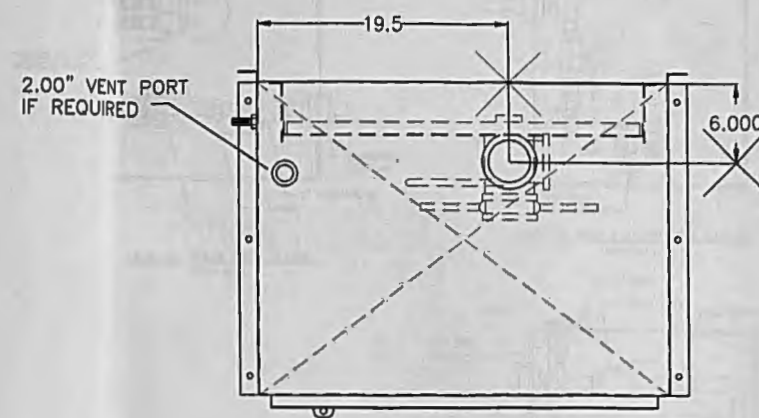


TOP VIEW

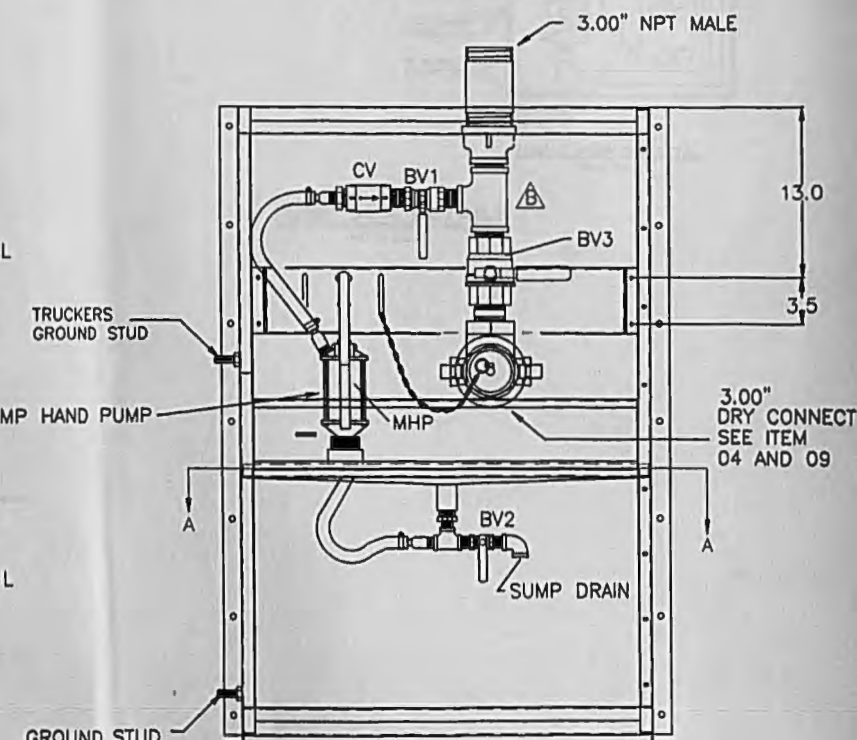

FRONT VIEW
LESS DOORS

PARTS LIST/LEGEND

QTY	DESCRIPTION	QTY	DESCRIPTION
01	1 22918201 BV	01	1 22918201 BV
02	1 22918050 BV	02	1 22918050 BV
03	1 22918010 BV	03	1 22918010 BV
04	1 22444401 AC	04	1 22444401 AC
05	1 22517001 NP1	05	1 22517001 NP1
06	1 22433001 R1	06	1 22433001 R1
07	1 22532001 R1	07	1 22532001 R1
08	4 22744999 H	08	4 22744999 H
09	1 22440763A B	09	1 22440763A B
10	1 24740001 NP	10	1 24740001 NP
11	3 NONE NP2	11	3 NONE NP2
12	1 NONE R1	12	1 NONE R1
13	2 22433000 R2	13	2 22433000 R2
14	2 22494000 NP3	14	2 22494000 NP3
15	3 22492350 NP4	15	3 22492350 NP4
16	1 22462350 EL	16	1 22462350 EL
17	4FT NONE KCE	17	4FT NONE KCE
18	2 15453000 L	18	2 15453000 L

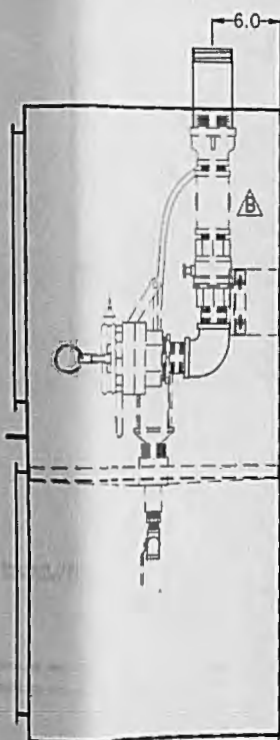

RIGHT SIDE VIEW
LESS DOORS

MIAMI-DADE COUNTY
BUILDING DEPARTMENT
MECHANICAL DIVISION
APPROVED: *[Signature]*
DATE: 07-19-99

MIAMI-DADE COUNTY DEPT.
POLLUTION CONTROL DIVISION
POLLUTION REMEDIATION SECTION
ENVIRONMENTAL REVIEW DIVISION
SUBJECT TO THE APPLICABLE CONDITIONS
HAS APPROVED BY: *[Signature]*
INSPECTED BY: *[Signature]*
DATE: 07-19-99

Ph. STD-PC2/DL
4/8/99 TAM-54-JAR, A.D.A.-J.L.L.
05612.06012M-5.DWG

Graphic Scale
NOT TO SCALE

THIS DRAWING IS THE PROPERTY OF BBL ENVIRONMENTAL SERVICES, INC. AND MAY NOT BE REPRODUCED OR ALTERED IN WHOLE OR IN PART WITHOUT THE EXPRESS WRITTEN PERMISSION OF BBL ENVIRONMENTAL SERVICES, INC.

No.	Date	Revisions	Init.

Project Mgr. -- ALEX SANCHEZ
Designed by -- ALEX SANCHEZ
Drawn by -- MICHAEL SCHROEDER
Checked by -- GABINO GUEVAS
Prof. Eng. -- GABINO GUEVAS, P.E.
PE License #2230

[Signature]
07/19/99
05612.06012M-5.DWG



BBL
ENVIRONMENTAL SERVICES, INC.
Remedial Action Management and Construction

GENERAL SERVICES ADMINISTRATION
SHOP 5
8801 NW 88TH STREET
MIAMI, FLORIDA 33181
CONSTRUCTION DRAWINGS

SIMPLEX FUEL PORT DETAILS



File Number
656,12,008F
Date
MAY 1999
BBL Environmental Services, Inc.
7976 NW 154th St.
Suite 310
Miami Lakes, FL 33016
305-628-3333

M-5

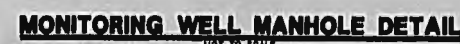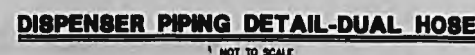

GENERAL NOTES FOR VAPOR RECOVERY SYSTEM

1. ALL PIPING AND FITTINGS SHALL BE INSTALLED IN ACCORDANCE WITH MANUFACTURER'S INSTRUCTIONS AND SPECIFICATIONS. METAL PIPE SHALL BE INSTALLED SCHEDULE 40 WELDED OR SEAMLESS STEEL PIPE PER ASTM A-53 OR ALUMINUM PIPE PER ASTM B-221. ALL NON-METALLIC PIPE AND FITTINGS SHALL BE UL LISTED.
2. VAPOR RETURN LINES AND VENT LINES TO BE 1" DIAMETER PIPE UNLESS OTHERWISE NOTED. SLOPE MUST BE MINIMUM 1/8" PER FOOT WITHOUT SAOS OR TRAPS, DRAINING UNIFORMLY TOWARD PRODUCT STORAGE TANK.
3. VENT LINES MUST BE SEPARATED BY PRODUCT.
4. VENT PIPES SHALL BE INSTALLED TO A MINIMUM HEIGHT OF 12 FEET ABOVE GRADE.
5. VAPOR RECOVERY EQUIPMENT TO BE INSTALLED IN ACCORDANCE WITH NFPA-10.

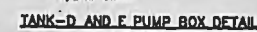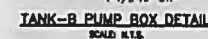

PUMP BOX DETAILS

[illegible]

Graphic Scale	No.	Date	Revisions	Init	
NOT TO SCALE	1.	9/07/99	MODIFY MW DETAIL - SHOW 2' SOLID RISER	JAR	
THIS DRAWING IS THE PROPERTY OF BBL ENVIRONMENTAL SERVICES INC. AND MAY NOT BE REPRODUCED OR ALTERED IN WHOLE OR IN PART WITHOUT THE EXPRESS WRITTEN PERMISSION OF BBL ENVIRONMENTAL SERVICES, INC.					Project Mgr. --- ALEX SANGHEE
					Designed by --- ALEX SANGHEE
					Drawn by --- MICHAEL SCHOFIELD/NOE
					Checked by --- GABING CHEVAS, P.E.
					Prof. Eng. --- ALEX SANGHEE
					PE License #24837

THIS DRAWING IS THE PROPERTY OF BBL ENVIRONMENTAL SERVICES INC. AND MAY NOT BE REPRODUCED OR ALTERED IN WHOLE OR IN PART WITHOUT THE EXPRESS WRITTEN PERMISSION OF BBL ENVIRONMENTAL SERVICES, INC.







BBL
ENVIRONMENTAL SERVICES, INC.
Remedial Action • Management and Construction

GENERAL SERVICES ADMINISTRATION
SHOP 3
6801 NW 58TH STREET
MIAMI, FLORIDA 33166
CONSTRUCTION DRAWINGS

MECHANICAL DETAILS

File Number 666.12.009F
Date SEPTEMBER 1999
DDL Environmental Services, Inc. 7975 NW 154th St. Suite 310 Miami Lakes, FL 33016 305-828-3353

M-6

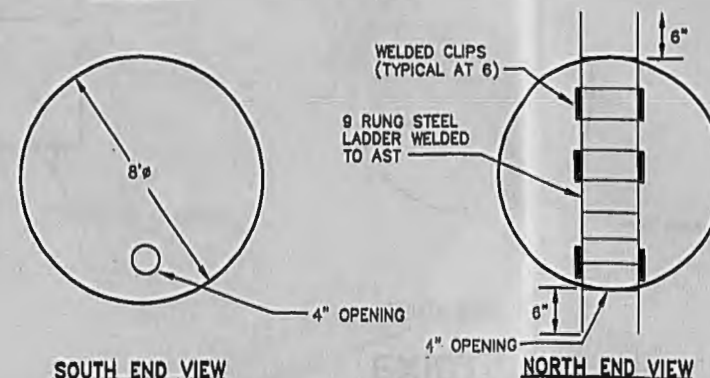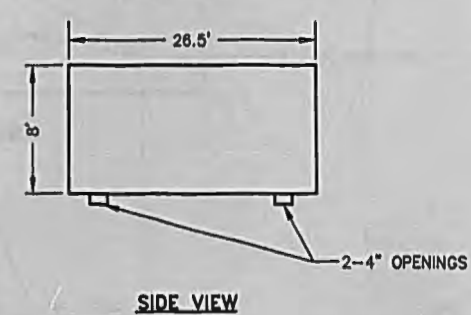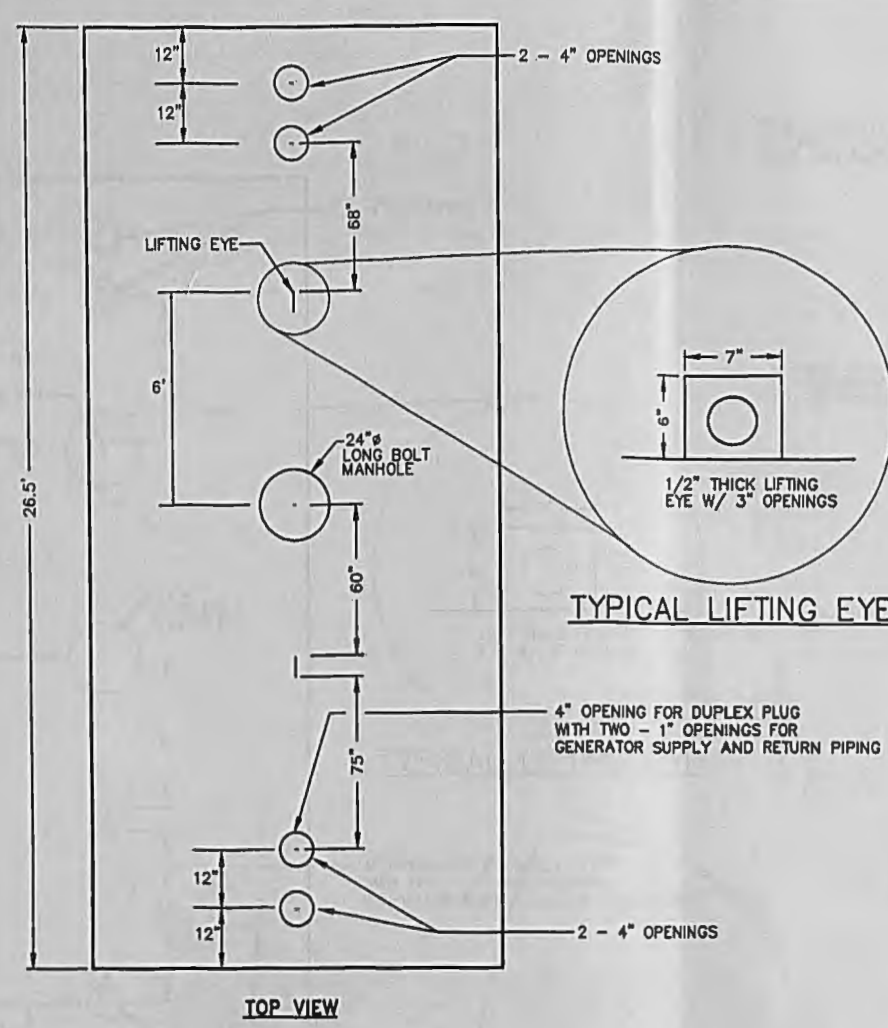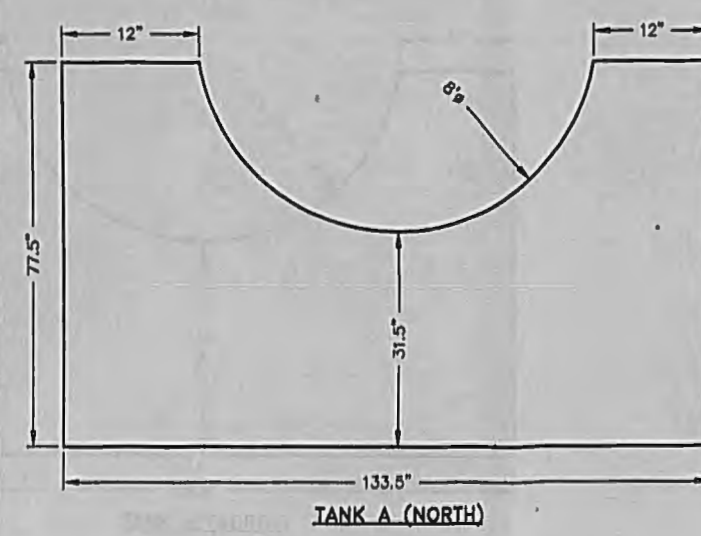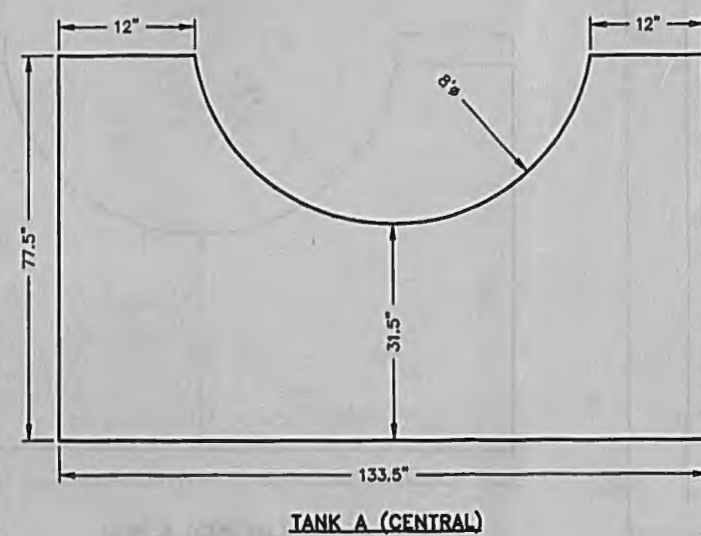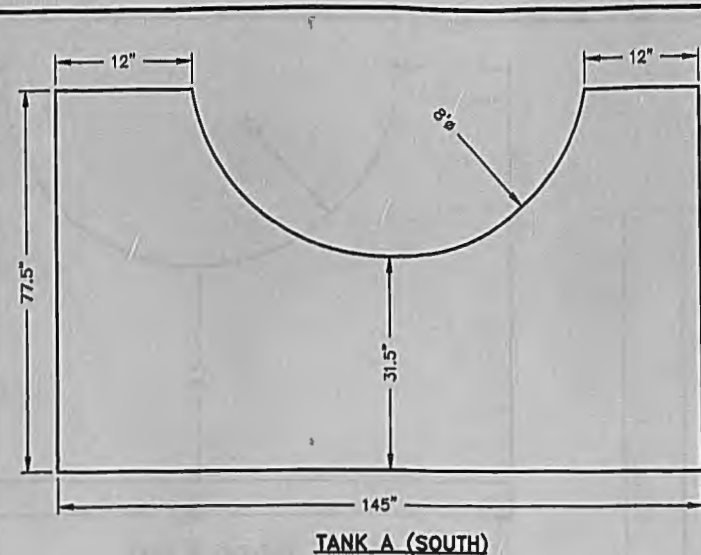

EXISTING TANK "A" CONCRETE CRADLES

NOTE: CONTRACTOR TO VERIFY CRADLES CAN ACCEPT TANK B PRIOR TO TRANSFER. ENSURE PLACEMENT OF TANK B IS LEVEL.

P: STD-PC2/DL
9/2/99 TAM-54-JAR, BOC-54-MJS
0812.0013M-7.DWG

Graphic Scale	No.	Date	Revisions	Init
NOT TO SCALE	1	9/07/99	ADD TANK "B" SECONDARY CONTAINMENT DETAILS	JAR





THIS DRAWING IS THE PROPERTY OF BBL ENVIRONMENTAL SERVICES, INC. AND MAY NOT BE REPRODUCED OR ALTERED IN WHOLE OR IN PART WITHOUT THE EXPRESS WRITTEN PERMISSION OF BBL ENVIRONMENTAL SERVICES, INC.

EXISTING TANK "B" - 10,000 GALLON SINGLE-WALL DIESEL AST DETAILS

NOTE: DIMENSIONS ARE APPROXIMATE

Project Mgr. --- ALEX SANCHEZ
Designed by --- ALEX SANCHEZ
Drawn by --- EMILE AMEDEE, A.D.A.
Checked by --- GABINO GUEVAS
Prof. Eng. --- ALEX SANCHEZ
PE License --- #24532


BBL
ENVIRONMENTAL SERVICES, INC.
Remedial Action Management and Construction

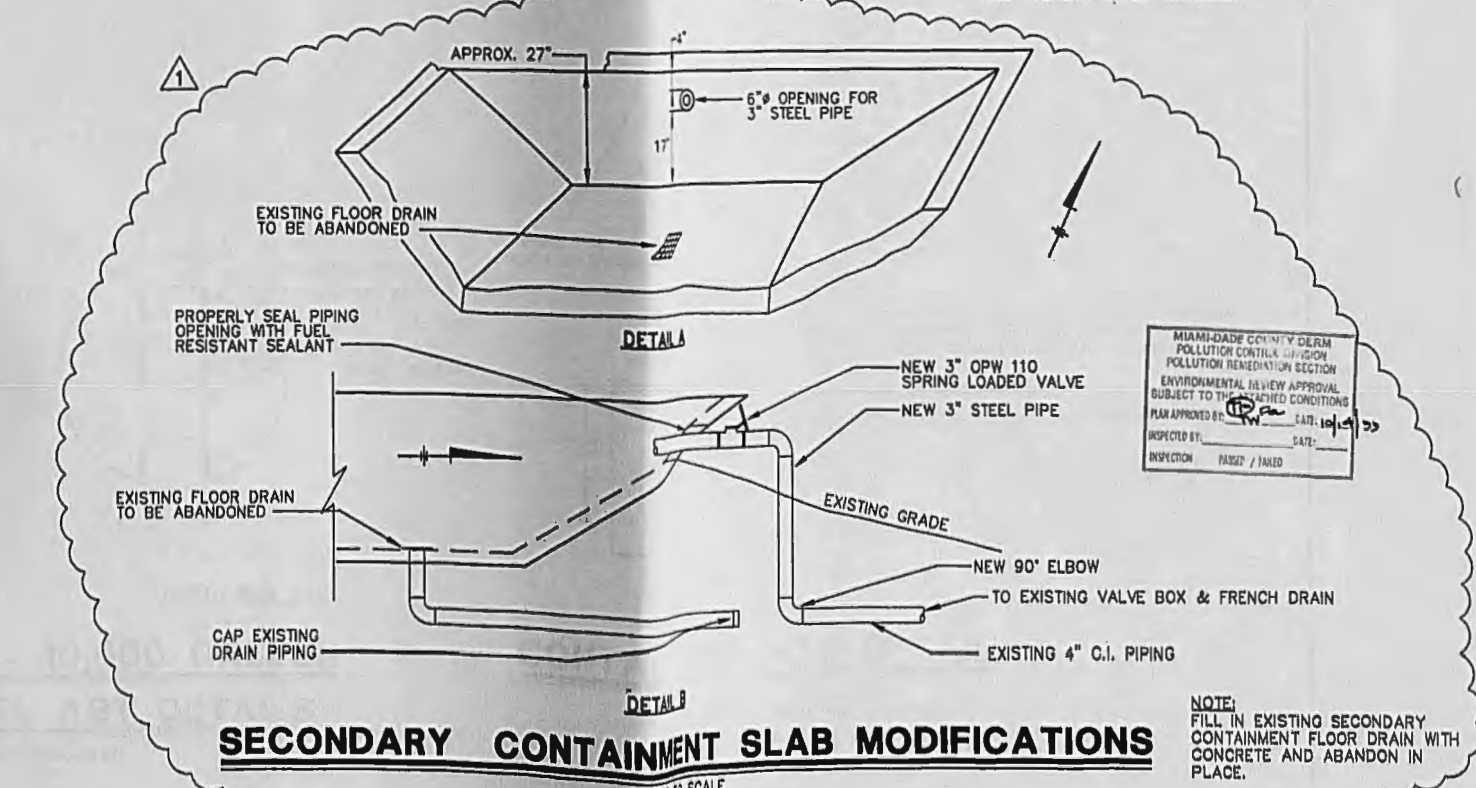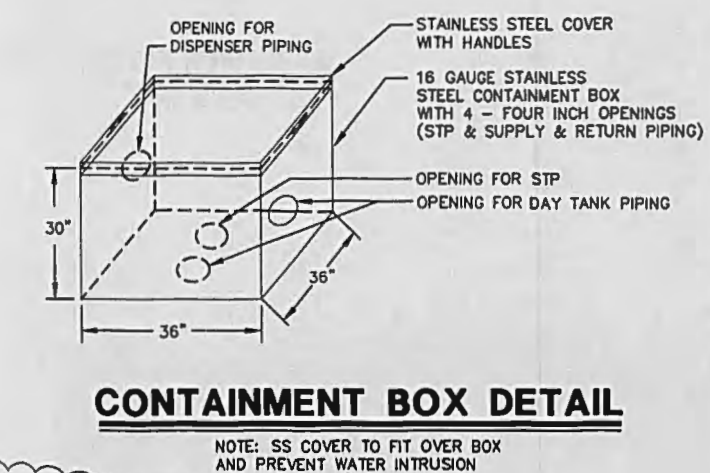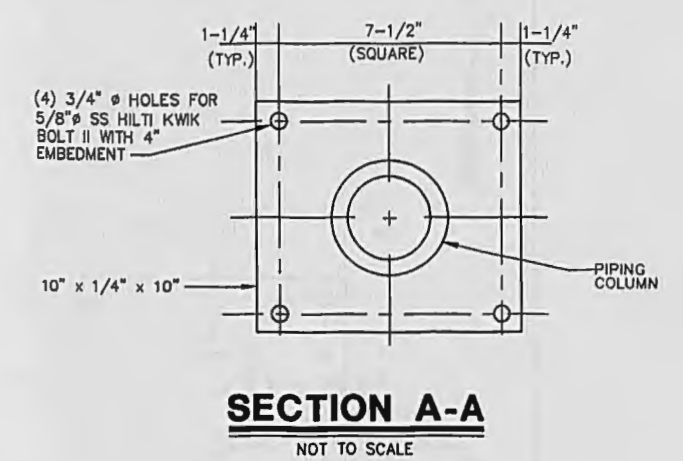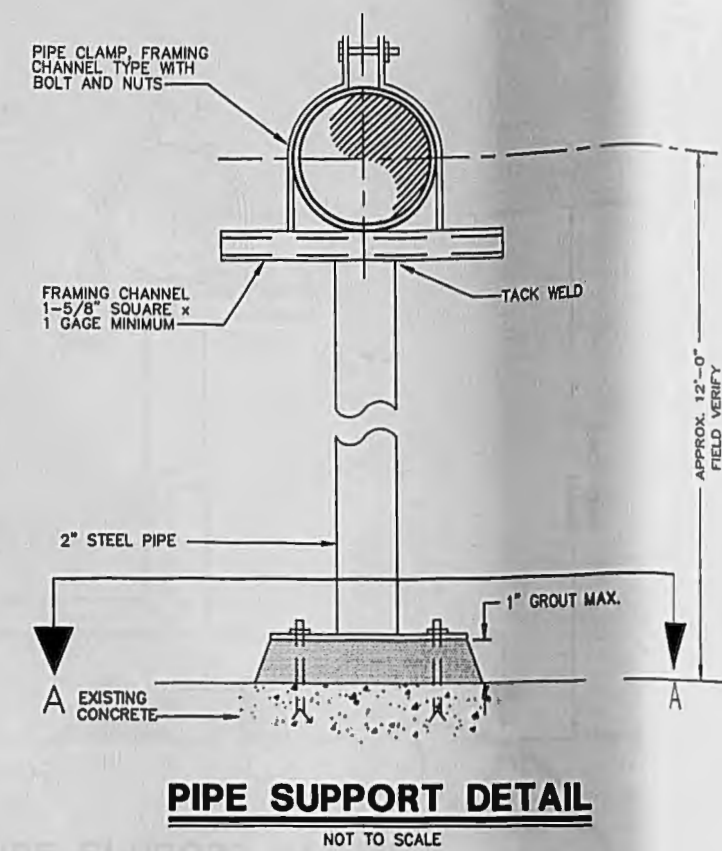




GENERAL SERVICES ADMINISTRATION
SHOP 3
201 NW 56TH STREET
MIAMI, FLORIDA 33166
CONSTRUCTION DRAWINGS
TANK "B" DETAILS

File Number: 656.12.010F
Date: SEPTEMBER 1999
BBL Environmental Services, Inc.
7975 NW 184th St.
Miami Lakes, FL 33016
305-828-3353

M-7

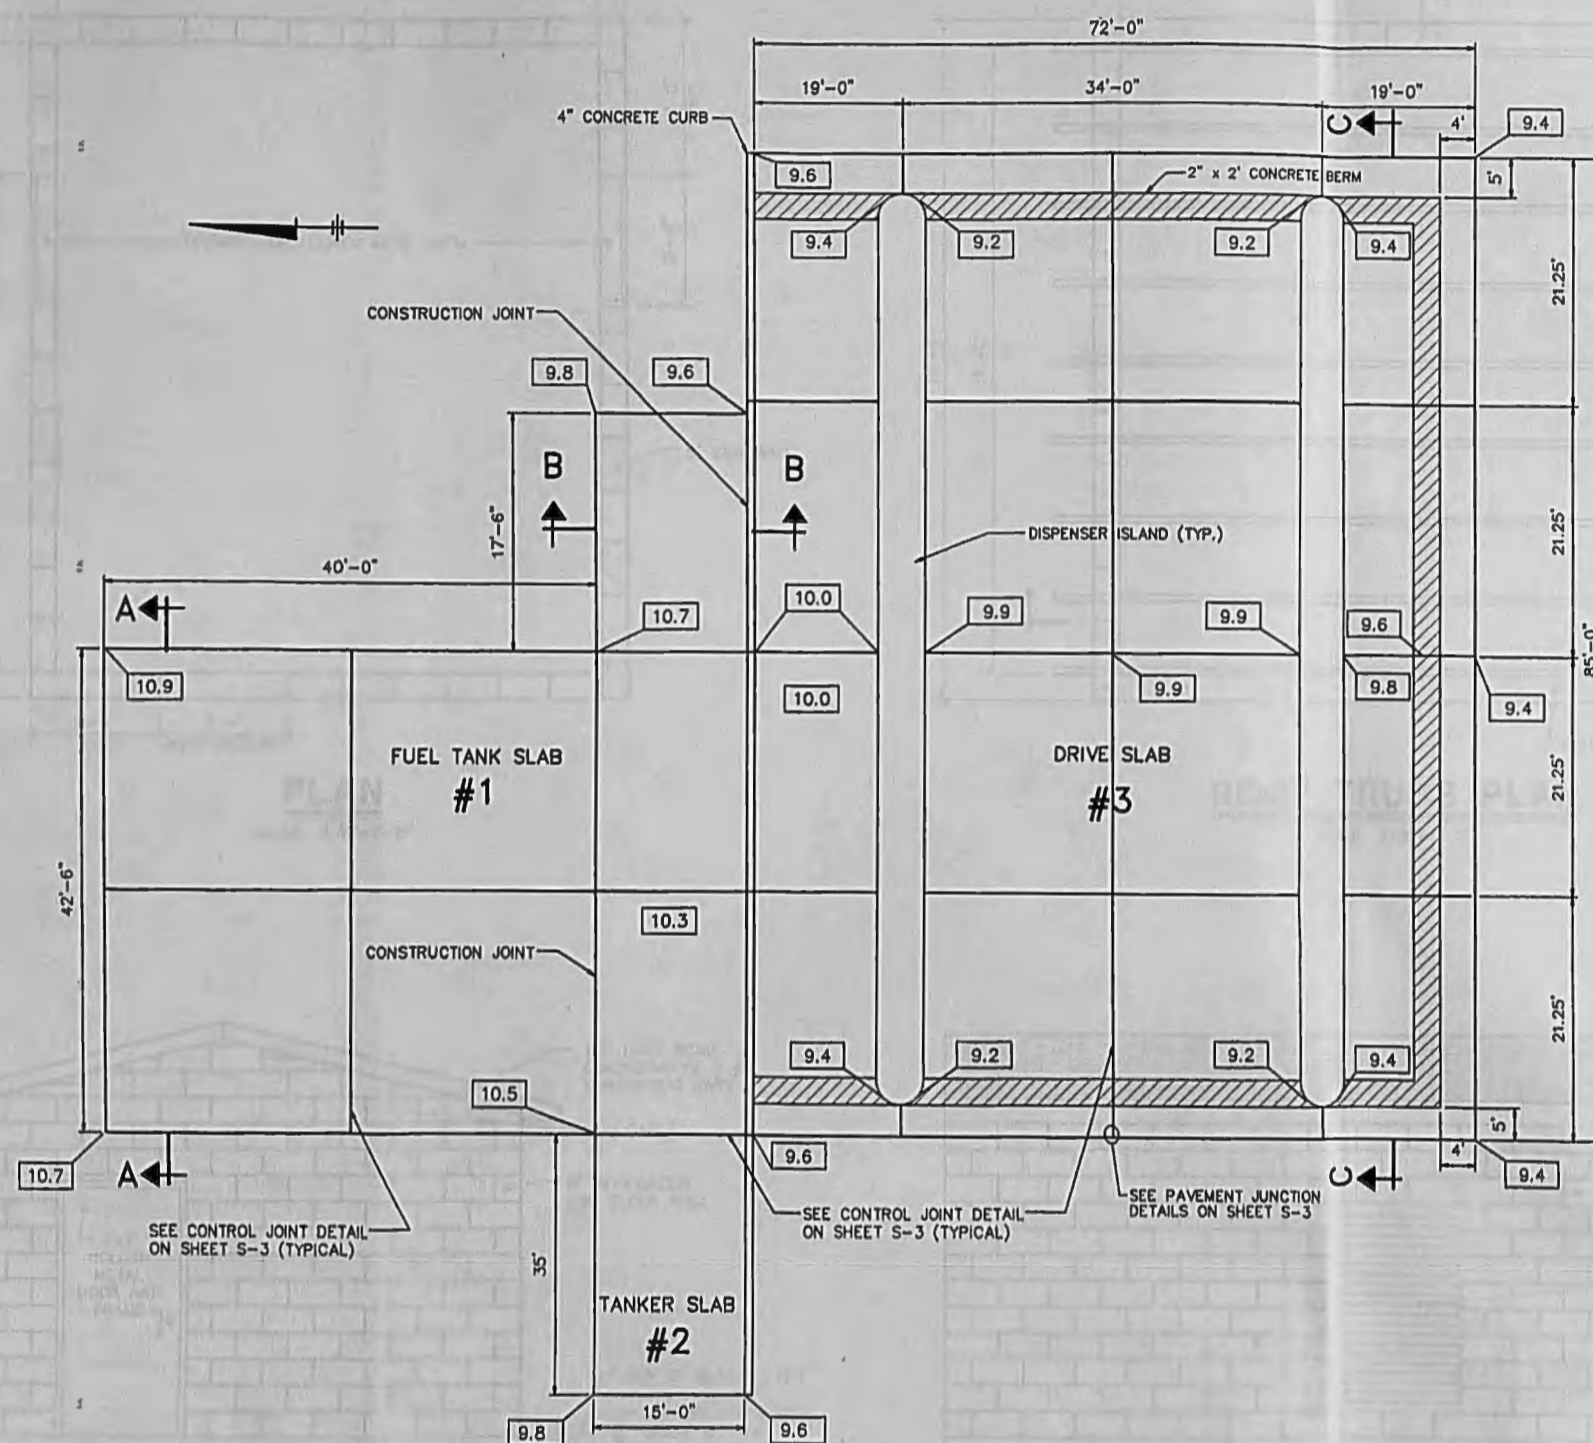

PARTIAL SITE PLAN STRUCTURAL LAYOUT
NOT TO SCALE

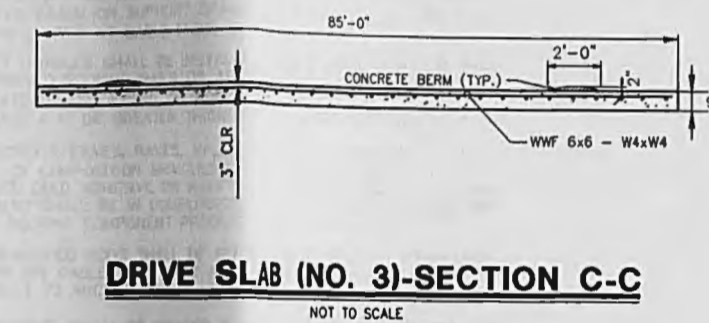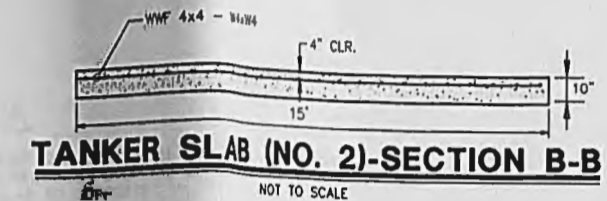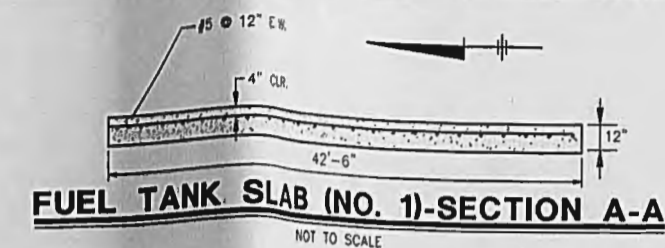

STRUCTURAL NOTES:

- ALL CONCRETE SLABS TO HAVE 28 DAY COMPRESSIVE STRENGTH:
 $f'_c = 4,000$ psi
- REINFORCEMENT TO COMPLY WITH ASTM A-615 WITH A MINIMUM YIELD POINT:
 $f_y = 60$ ksi
- ALL WORK SHALL COMPLY WITH THE SOUTH FLORIDA BUILDING CODE, LATEST DADE COUNTY EDITION
- THE FOLLOWING MINIMUM CONCRETE COVER SHALL BE PROVIDED FOR REINFORCEMENT:
 - CONCRETE CAST AGAINST AND PERMANENTLY EXPOSED TO EARTH - 1 in.
 - CONCRETE EXPOSED TO WEATHER - 2 in. (MIN.)
- ALL EXPOSED CONCRETE CORNERS TO HAVE 3/4" CHAMFER.
- CONSTRUCTION OF SLABS SHALL BE MADE IN ACCORDANCE WITH ACI REQUIREMENTS.
- INSPECTION OF REINFORCED CONCRETE WILL BE MADE IN ACCORDANCE WITH ACI 311.
- SAMPLES FOR STRENGTH OF CONCRETE PLACED EACH DAY SHALL BE TAKEN NOT LESS THAN ONCE A DAY NOR LESS THAN ONCE FOR EACH 50 CUBIC YARDS OF CONCRETE NOR LESS THAN ONCE FOR EACH 5000 SQUARE FEET OF SURFACE AREA FOR SLABS.
- STRENGTH LEVEL FOR AN AVERAGE CLASS OF CONCRETE SHALL BE CONSIDERED SATISFACTORY IF BOTH OF THE FOLLOWING REQUIREMENTS ARE MET:
 - AVERAGE OF ALL SETS OF THREE CONSECUTIVE STRENGTH TESTS EQUAL OR EXCEED f'_c
 - NO INDIVIDUAL STRENGTH TEST (AVERAGE OF TWO CYLINDERS) FALLS BELOW f'_c BY MORE THAN 500 psi
- FINISH FOR CONCRETE SLABS SHALL BE BROOM FINISH.
- THE FUEL TANK MUST BE SELEVEL AS PER MANUFACTURER'S INSTRUCTIONS, SO THAT THE PRODUCT IN THE TANK REMAINS LEVEL.
- CONTRACTOR TO VERIFY FIEL ELEVATIONS PRIOR TO POURING OF CONCRETE SLABS AND PLACEMENT OF ASPHALT AND ENSURE PROPER DRAINAGE IN SURROUNDING AREAS.

Pl. STD-PC2/DL
7/8/90 TAM-84-JAR, MJS
65612/05612801.DWG

Graphic Scale
NOT TO SCALE

THIS DRAWING IS THE PROPERTY OF DBL ENVIRONMENTAL SERVICES, INC. AND MAY NOT BE REPRODUCED OR ALTERED IN WHOLE OR IN PART WITHOUT THE EXPRESS WRITTEN PERMISSION OF DBL ENVIRONMENTAL SERVICES, INC.

No.	Date	Revisions	Init.

Project Mgr. --- ALEX BANCHEZ
Designed by --- ALEX BANCHEZ
Drawn by --- MICHAEL SCHODDINGER
Checked by --- WILLIAM HOPKINS
Prof. Eng. --- GABINO GUEVARA, P.E.
PE License --- #42830


Signature
7/19/99
#42830

BBL
ENVIRONMENTAL SERVICES, INC.
Remedial Action Management and Construction

GENERAL SERVICES ADMINISTRATION
SHOP 3
8801 NW 58TH STREET
MIAMI, FLORIDA 33166
CONSTRUCTION DRAWINGS
STRUCTURAL LAYOUT

File Number
656.12.011F
Date
JUNE 1999
DBL Environmental Services, Inc.
7975 NW 154th St.
Suite 310
Miami Lakes, FL 33010
305-828-3353


S-1

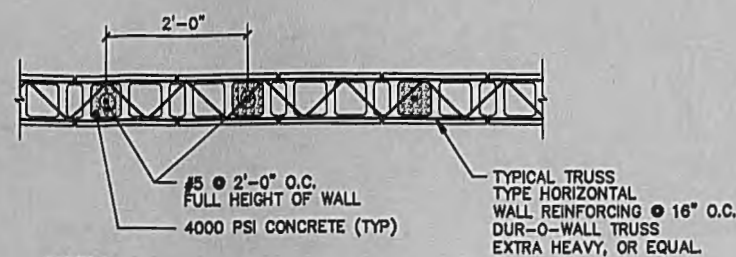

- NOTES:**
1. HORIZONTAL CMU WALL REINFORCEMENT SHALL BE HOT DIPPED GALVANIZED.
 2. OPENINGS BETWEEN 3 AND 8 FEET IN WIDTH SHALL HAVE ONE #5 VERTICAL REINFORCING BAR AT EACH SIDE. THE VERTICAL BARS SHALL BE PLACED IN CONCRETE FILLED CELLS AND SHALL EXTEND INTO FOOTINGS AND INTO TIE BEAM WITH A MINIMUM SPLICE OF 30".
 3. ALL CONCRETE MASONRY UNITS USED IN EXTERIOR WALLS SHALL CONTAIN THE MANUFACTURER'S RECOMMENDED AMOUNT OF INTEGRAL WATER REPELLENT, DRY BLOCK BY W.R. GRACE, OR EQUAL.


CMU WALL DETAIL

SCALE: 3/4"=1'-0"

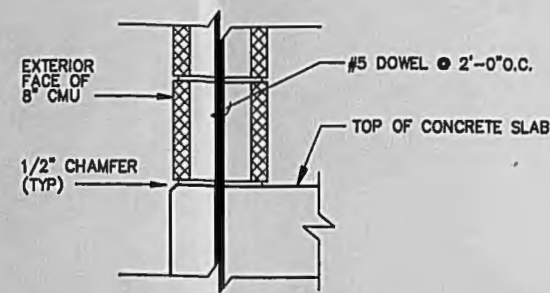


CHAMFER DETAIL

SCALE: 1-1/2"=1'-0"

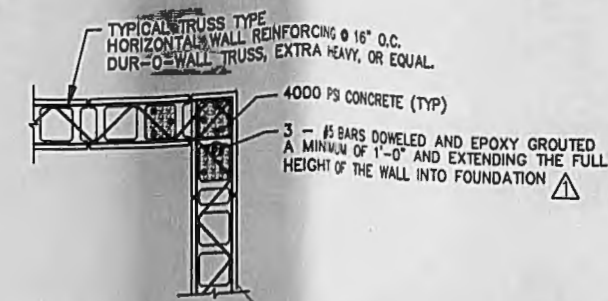


CMU CORNER & TIE COLUMN DETAIL

SCALE: 3/4"=1'-0"

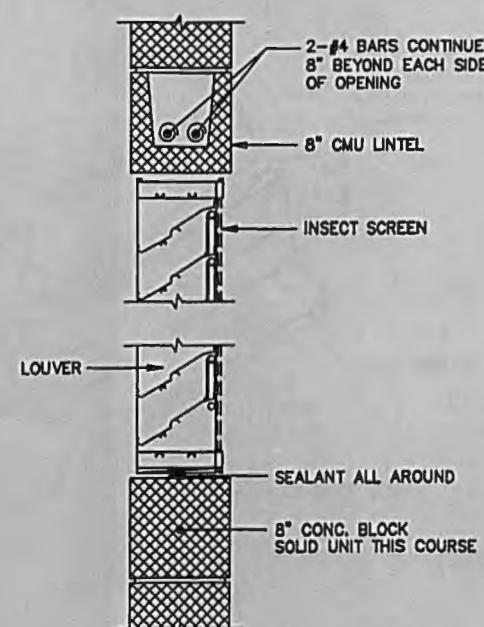


LOUVER DETAIL

SCALE: 1-1/2"=1'-0"

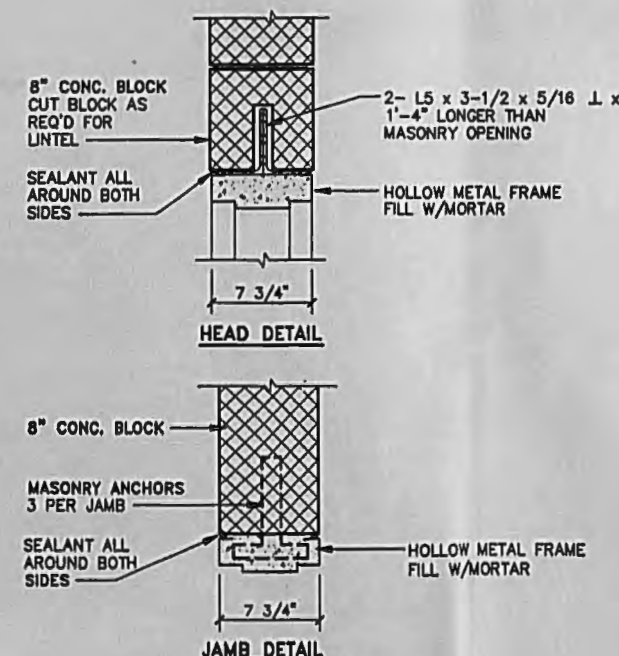

DOOR DETAILS

SCALE: 1-1/2"=1'-0"

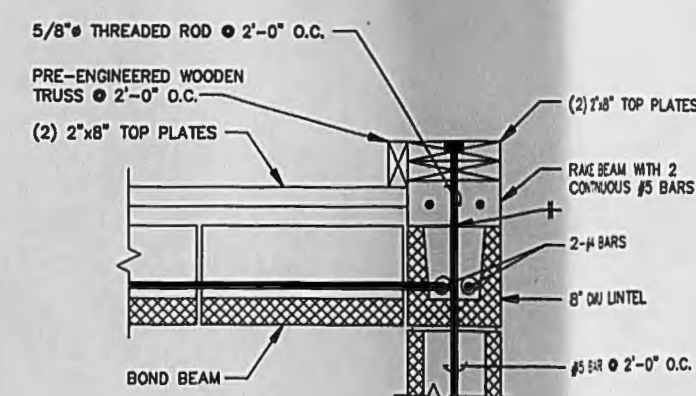

RAKE BEAM DETAIL

SCALE: 1-1/2"=1'-0"

L: CH-1 OFF-BEF
P: CONT-DWG/CONT-MVB
8/31/99 BYR-54-048 DCO GMS
88612100/88612803.DWG

Graphic Scale
3/4"=1'-0"
1/2"=1'-0"
THIS DRAWING IS THE PROPERTY OF BLANLAND, BOUCK & LEE, INC. AND MAY NOT BE REPRODUCED OR ALTERED IN WHOLE OR IN PART WITHOUT THE EXPRESS WRITTEN PERMISSION OF BLANLAND, BOUCK & LEE, INC.

No.	Date	Revisions	Init.
1	8/30/99	GENERAL REVISIONS	
2			
3			
4			
5			
6			
7			
8			
9			
10			

Project Mgr. --- AES
Designed by --- WRH/IDS
Drawn by --- GMS
Checked by --- WRH/IDS
Prof. Eng. --- GABINO COVEAS, P.E.
PE License --- 42830 5/6/97


APR 9 1999
7/1/99

BBL
ENVIRONMENTAL SERVICES, INC.
Remedial Action Management and Construction


GENERAL SERVICES ADMINISTRATION
SHOP 3
8801 NW 88TH STREET
MIAMI, FLORIDA 33158
CONSTRUCTION DRAWINGS
STRUCTURAL DETAILS

File Number:
658.12.013F
Date:
AUGUST 1999
BBL Environmental Services, Inc.
Suite 310
7975 N.W. 154th Street
Miami Lakes, FL 33015-8549
305-828-3353


S-3

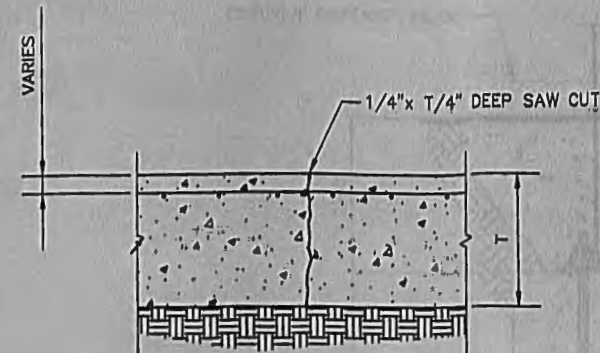


CONTROL JOINT DETAIL
NOT TO SCALE

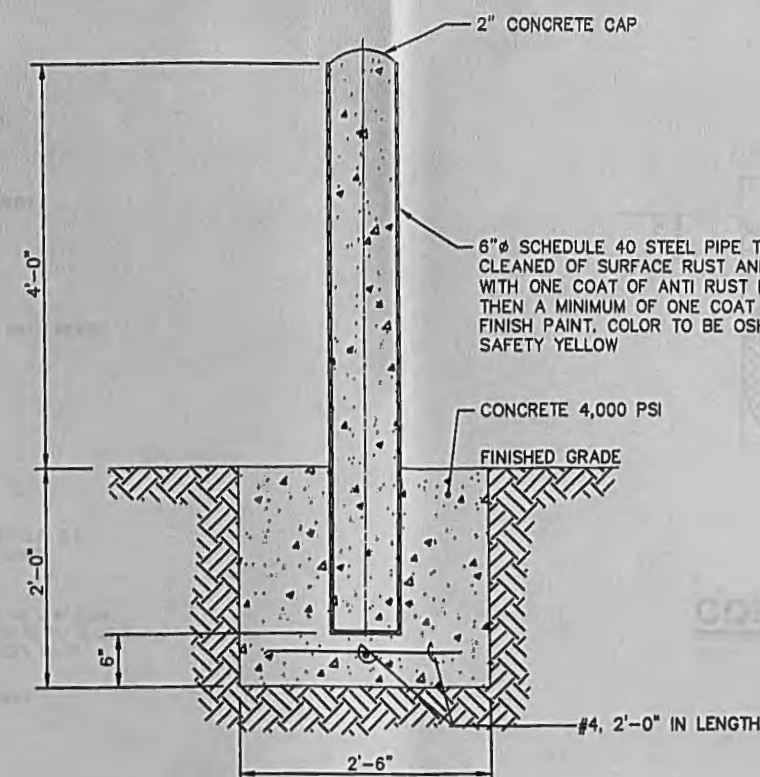


TYPICAL BOLLARD DETAIL
NOT TO SCALE

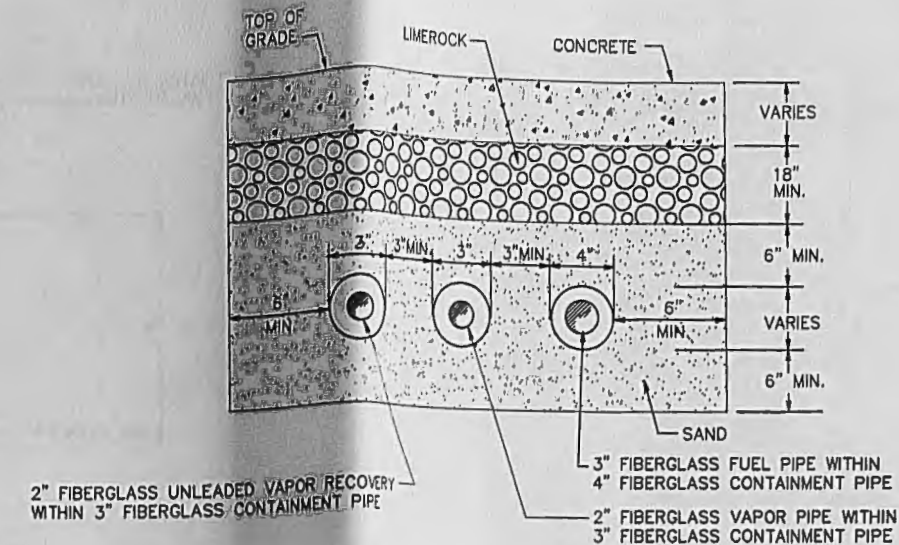


PIPE BEDDING DETAIL
NOT TO SCALE

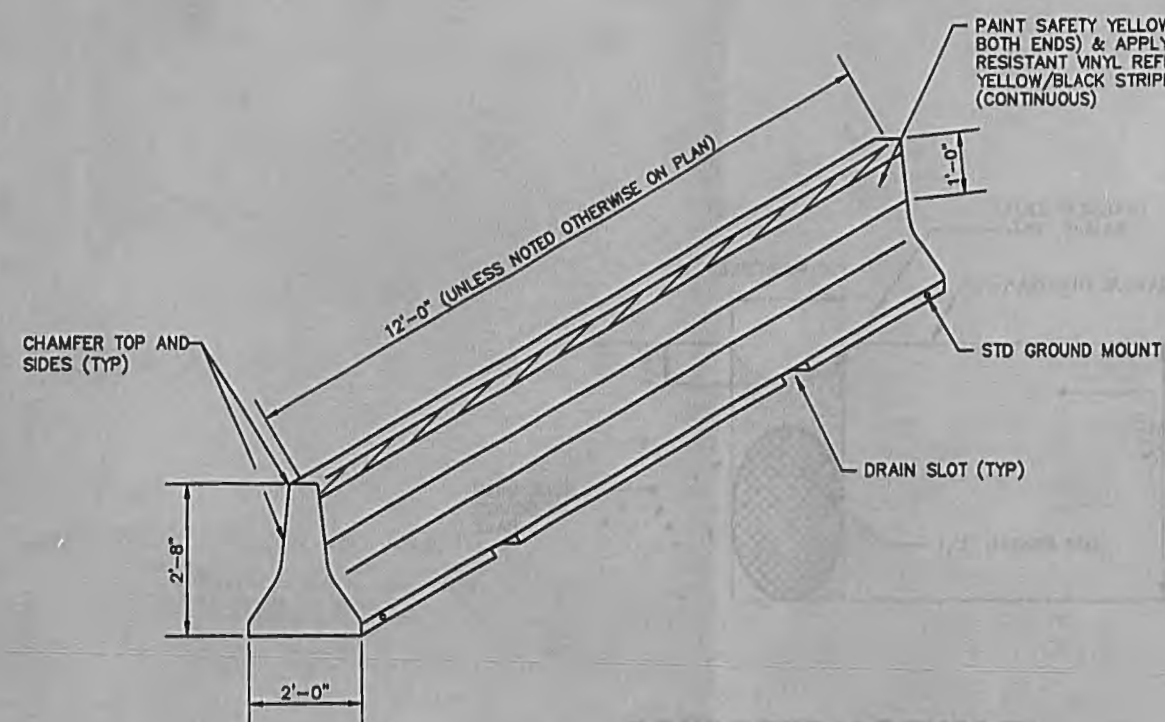


PERMANENT PRECAST CONCRETE BARRIER
NOT TO SCALE

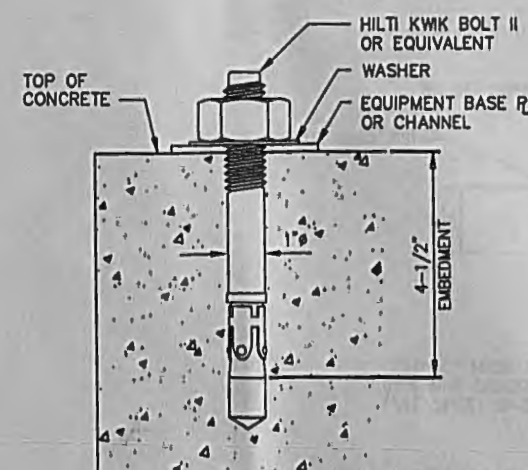

ABOVEGROUND TANK EXPANSION ANCHOR DETAIL
NOT TO SCALE

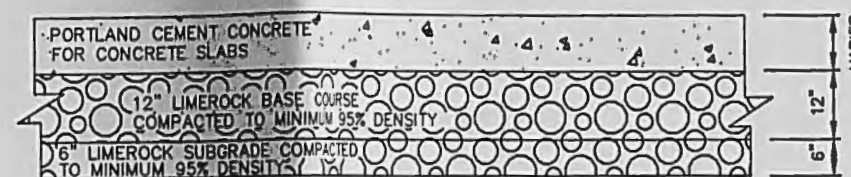

**SUBGRADE DETAIL FOR
REINFORCED CONCRETE PAVEMENT**
NOT TO SCALE

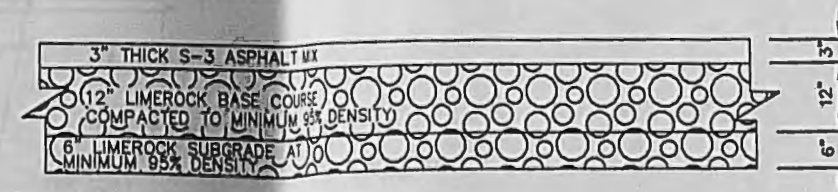

**SUBGRADE DETAIL FOR
ASPHALT PAVEMENT**
NOT TO SCALE

9/7/99 MIA-54 MJS
C:\DATA\YR-1999\65612\656123-3.DWG

Graphic Scale	No.	Date	Revisions	Init.	Project Mgr.
NOT TO SCALE					ALEX. BANCHEZ
					Designed by ALEX. BANCHEZ
					Drawn by MICHAEL SCHROEDER
					Checked by WILLIAM HOPKINS
					Prof. Eng. ALEX. BANCHEZ, P.E.
					P.E. License #95932


THIS DRAWING IS THE PROPERTY OF BBL ENVIRONMENTAL SERVICES, INC. AND MAY NOT BE REPRODUCED, IN WHOLE OR PART WITHOUT THE EXPRESS WRITTEN PERMISSION OF BBL ENVIRONMENTAL SERVICES, INC.

BBL
ENVIRONMENTAL SERVICES, INC.
Remedial Action Management and Construction


GENERAL SERVICES ADMINISTRATION
SHOP 3
8801 NW 58th STREET
MIAMI, FLORIDA 33166
CONSTRUCTION DRAWINGS
STRUCTURAL DETAILS

File Number
65612.013F
Date
SEPTEMBER 1999
BBL Environmental Services, Inc.
7975 NW 154th STREET
SUITE 310
Miami Lakes, FL 33016
(305) 528-3363


S-4

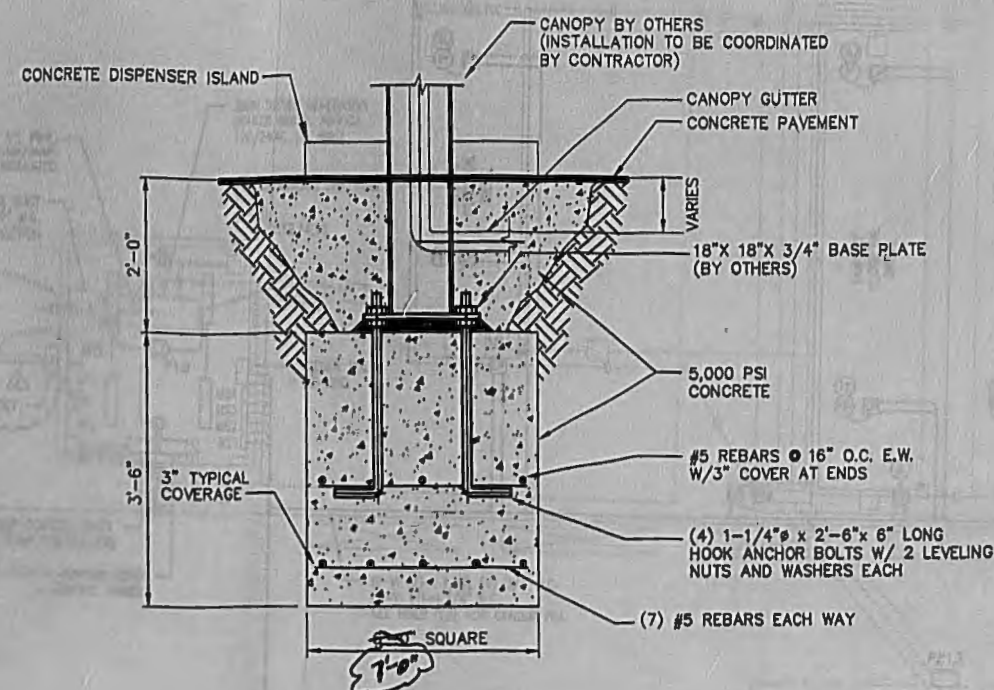


TYPICAL FOOTING DETAIL
NOT TO SCALE

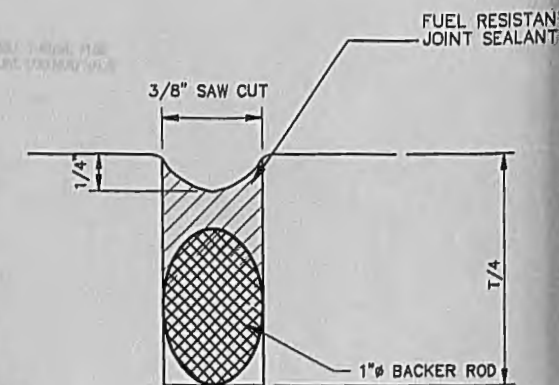

**CONCRETE/CONCRETE
JOINT DETAIL**
NOT TO SCALE

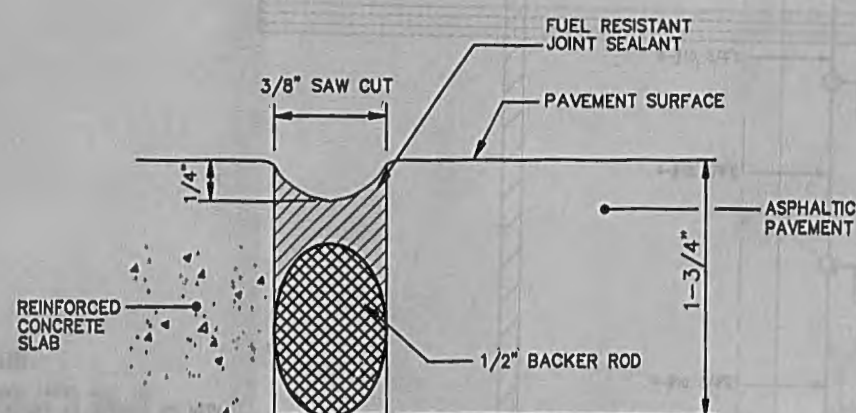

**CONCRETE/ASPHALT
JOINT DETAIL**
NOT TO SCALE

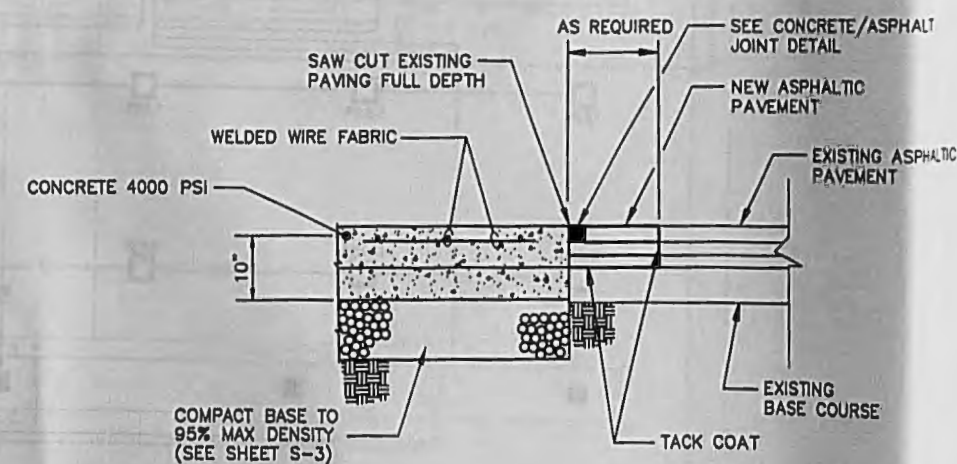

**PAVEMENT JUNCTION OF NEW CONCRETE
AND EXISTING ASPHALT PAVEMENT**
NOT TO SCALE

9/07/99 MIA-54 MJB
C:\DATA\YR-1999\65612\65612S-4.DWG

Graphic Scale	No.	Date	Revisions	Init.
NOT TO SCALE				
THIS DRAWING IS THE PROPERTY OF BBL ENVIRONMENTAL SERVICES, INC. AND MAY NOT BE REPRODUCED, IN WHOLE OR PART WITHOUT THE EXPRESS WRITTEN PERMISSION OF BBL ENVIRONMENTAL SERVICES, INC.				



Project Mgr. — ALEX SANCHEZ	
Designed by — ALEX SANCHEZ	
Drawn by MICHAEL SCHROEDINGER	
Checked by GABINO SUFVAS, P.E.	
Prof. Eng. ALEX SANCHEZ, P.E.	
PE License — — — — — 84832	

BBL
ENVIRONMENTAL SERVICES, INC.
Remedial Action Management and Construction

GENERAL SERVICES ADMINISTRATION
SHOP 3
8801 NW 58TH STREET
MIAMI, FLORIDA 33186
CONSTRUCTION DRAWINGS
CONCRETE SECTIONS AND DETAILS

File Number
65612.014F
Date
SEPTEMBER 1999
BBL Environmental Services, Inc.
7070 NW 154th STREET
SUITE 310
Miami Lakes, FL 33016
(305) 828-3353

S-5

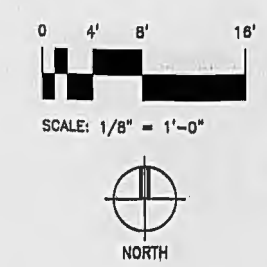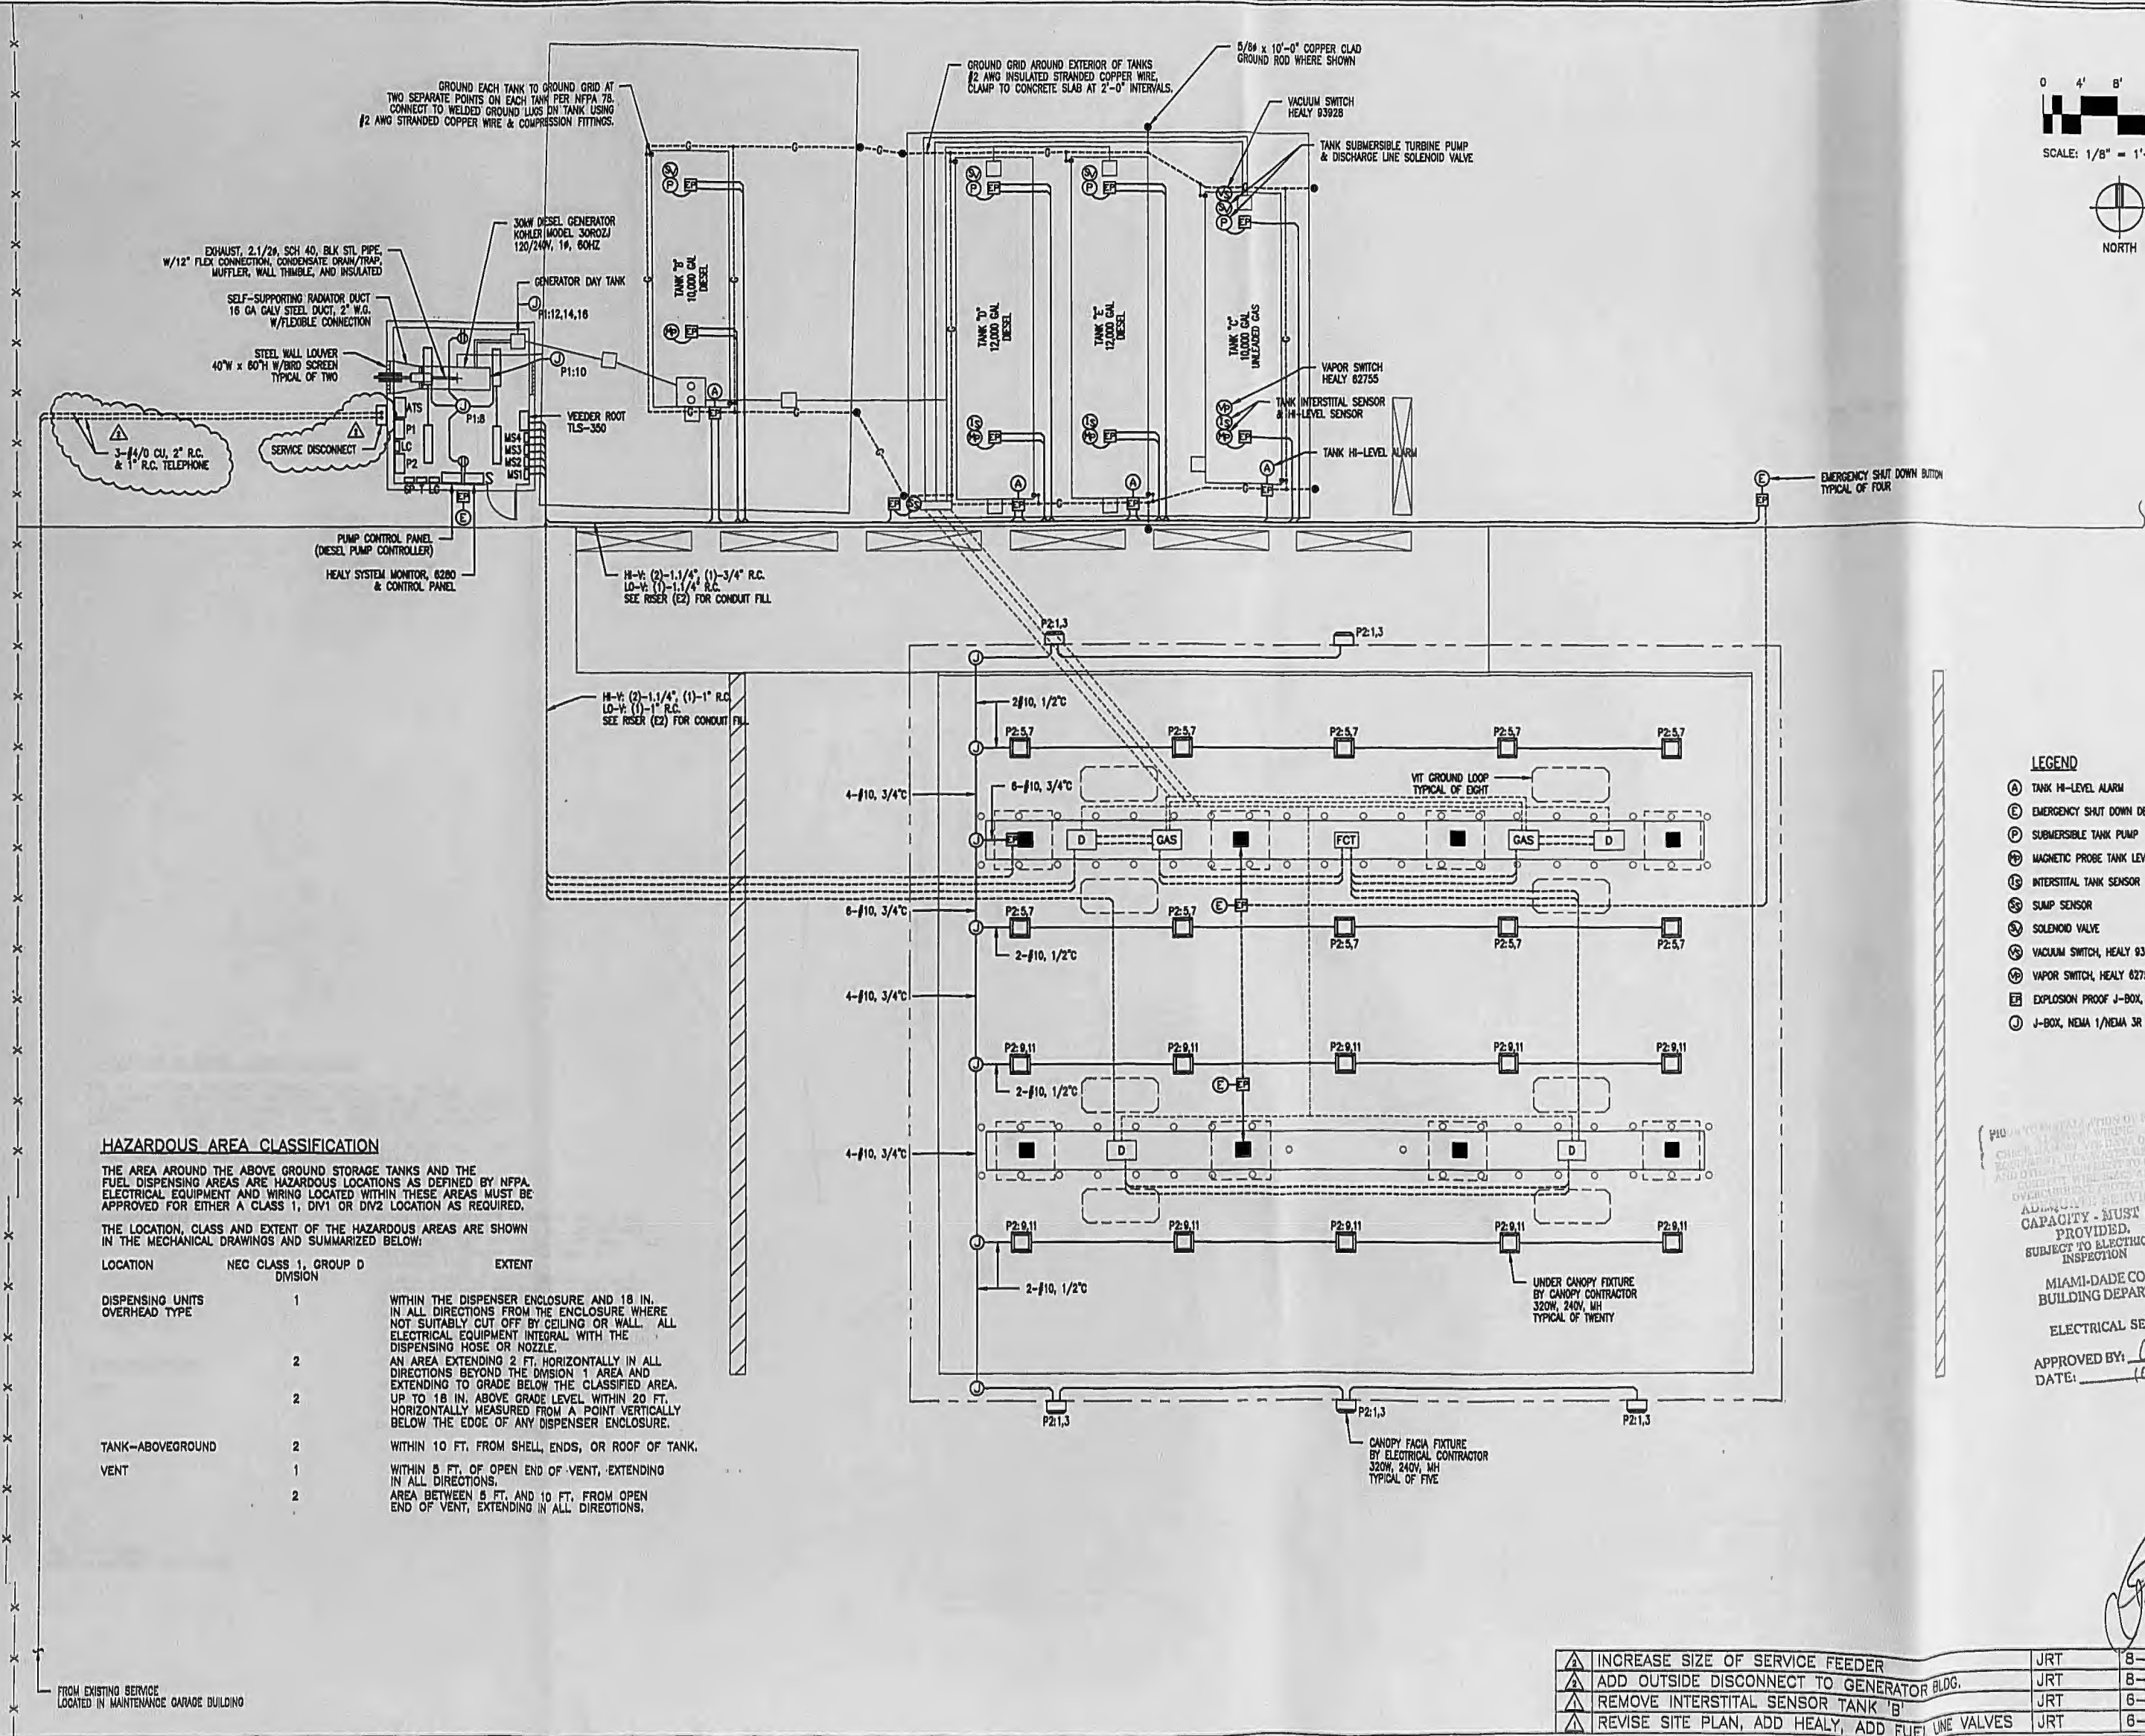

HAZARDOUS AREA CLASSIFICATION

THE AREA AROUND THE ABOVE GROUND STORAGE TANKS AND THE FUEL DISPENSING AREAS ARE HAZARDOUS LOCATIONS AS DEFINED BY NFPA. ELECTRICAL EQUIPMENT AND WIRING LOCATED WITHIN THESE AREAS MUST BE APPROVED FOR EITHER A CLASS 1, DIV 1 OR DIV 2 LOCATION AS REQUIRED.

THE LOCATION, CLASS AND EXTENT OF THE HAZARDOUS AREAS ARE SHOWN IN THE MECHANICAL DRAWINGS AND SUMMARIZED BELOW:

LOCATION	NEC CLASS 1, GROUP D DIVISION	EXTENT
DISPENSING UNITS OVERHEAD TYPE	1	WITHIN THE DISPENSER ENCLOSURE AND 18 IN. IN ALL DIRECTIONS FROM THE ENCLOSURE WHERE NOT SUITABLY CUT OFF BY CEILING OR WALL. ALL ELECTRICAL EQUIPMENT INSTALLED WITHIN THE DISPENSING HOSE OR NOZZLE.
	2	AN AREA EXTENDING 2 FT. HORIZONTALLY IN ALL DIRECTIONS BEYOND THE DIVISION 1 AREA AND EXTENDING TO GRADE BELOW THE CLASSIFIED AREA.
	2	UP TO 18 IN. ABOVE GRADE LEVEL WITHIN 20 FT. HORIZONTALLY MEASURED FROM A POINT VERTICALLY BELOW THE EDGE OF ANY DISPENSER ENCLOSURE.
TANK-ABOVEGROUND	2	WITHIN 10 FT. FROM SHELL, ENDS, OR ROOF OF TANK.
VENT	1	WITHIN 5 FT. OF OPEN END OF VENT, EXTENDING IN ALL DIRECTIONS.
	2	AREA BETWEEN 5 FT. AND 10 FT. FROM OPEN END OF VENT, EXTENDING IN ALL DIRECTIONS.

- LEGEND**
- Ⓐ TANK HI-LEVEL ALARM
 - Ⓑ EMERGENCY SHUT DOWN DEVICE
 - Ⓒ SUBMERSIBLE TANK PUMP
 - Ⓓ MAGNETIC PROBE TANK LEVEL SENSOR
 - Ⓔ INTERSTITIAL TANK SENSOR
 - Ⓕ SUMP SENSOR
 - Ⓖ SOLENOID VALVE
 - Ⓗ VACUUM SWITCH, HEALY 93928
 - Ⓘ VAPOR SWITCH, HEALY 82755
 - Ⓢ EXPLOSION PROOF J-BOX, NEMA 7
 - Ⓣ J-BOX, NEMA 1/NEMA 3R

FIGURE 10 INSTALLATION OF BUDGET CRACK DETECTOR SYSTEM WHICH MONITORS FOR LEAKS OF L.C. FUEL OIL, DIESEL OIL, KEROSENE AND OTHER FLAMMABLE LIQUIDS. THE SYSTEM IS DESIGNED TO DETECT LEAKS AND SHUT DOWN THE SYSTEM IMMEDIATELY.

ADDITIONAL NOTES:
CAPACITY - MUST BE PROVIDED.
SUBJECT TO ELECTRICAL INSPECTION.
MIAMI-DADE COUNTY BUILDING DEPARTMENT
ELECTRICAL SECTION
APPROVED BY: *CLD*
DATE: 10/8/99

INCREASE SIZE OF SERVICE FEEDER	JRT	8-23-99
ADD OUTSIDE DISCONNECT TO GENERATOR BLDG.	JRT	8-23-99
REMOVE INTERSTITIAL SENSOR TANK 'B'	JRT	6-21-99
REVISE SITE PLAN, ADD HEALY, ADD FUEL LINE VALVES	JRT	6-21-99

JOHN R. TOSCANO, INC.
CONSULTING ENGINEERS

2751 NE 9th Street/Tampabay Beach, FL 33602/954 946-0032
25055 Lalande Drive/Los Altos Hills, CA 94022/650 917-0873

Office: (954) 622-2920
Fax: (954) 622-2921

ATTAWAY SERVICES, INC.
Electrical/Mechanical Contractors
P.O. Box 460103
FL Lauderdale, FL 33346-0130

JOHN R. TOSCANO, P.E.
Florida License Number: 33758
California License Number: M028749
Mechanical Engineer
Member of Broward County Board of Rules and Appeals:
Electrical Committee: 1994, 1995
Fire Code Committee: 1994, 1995, 1996
Professional Society Memberships:
American Society of Heating, Refrigeration and Air Conditioning Engineers, ASHRAE
National Fire Protection Association, NFPA
American Concrete Institute, A.C.I.

6	
5	
4	
3	
2	
1	MAY 7, 1999
	DATE ISSUED

GENERAL SERVICES ADMINISTRATION
GAS TANK FARM REDESIGN
SHOP 3
8801 NW 58TH STREET
MIAMI, FLORIDA 33166


SHEET TITLE
ELECTRICAL PLAN

PROJECT No.
90301

SCALE: 1/8"=1'-0"
DRAWN: JRT
CHECK: JRT

SHEET No.
E1

PAGE No.

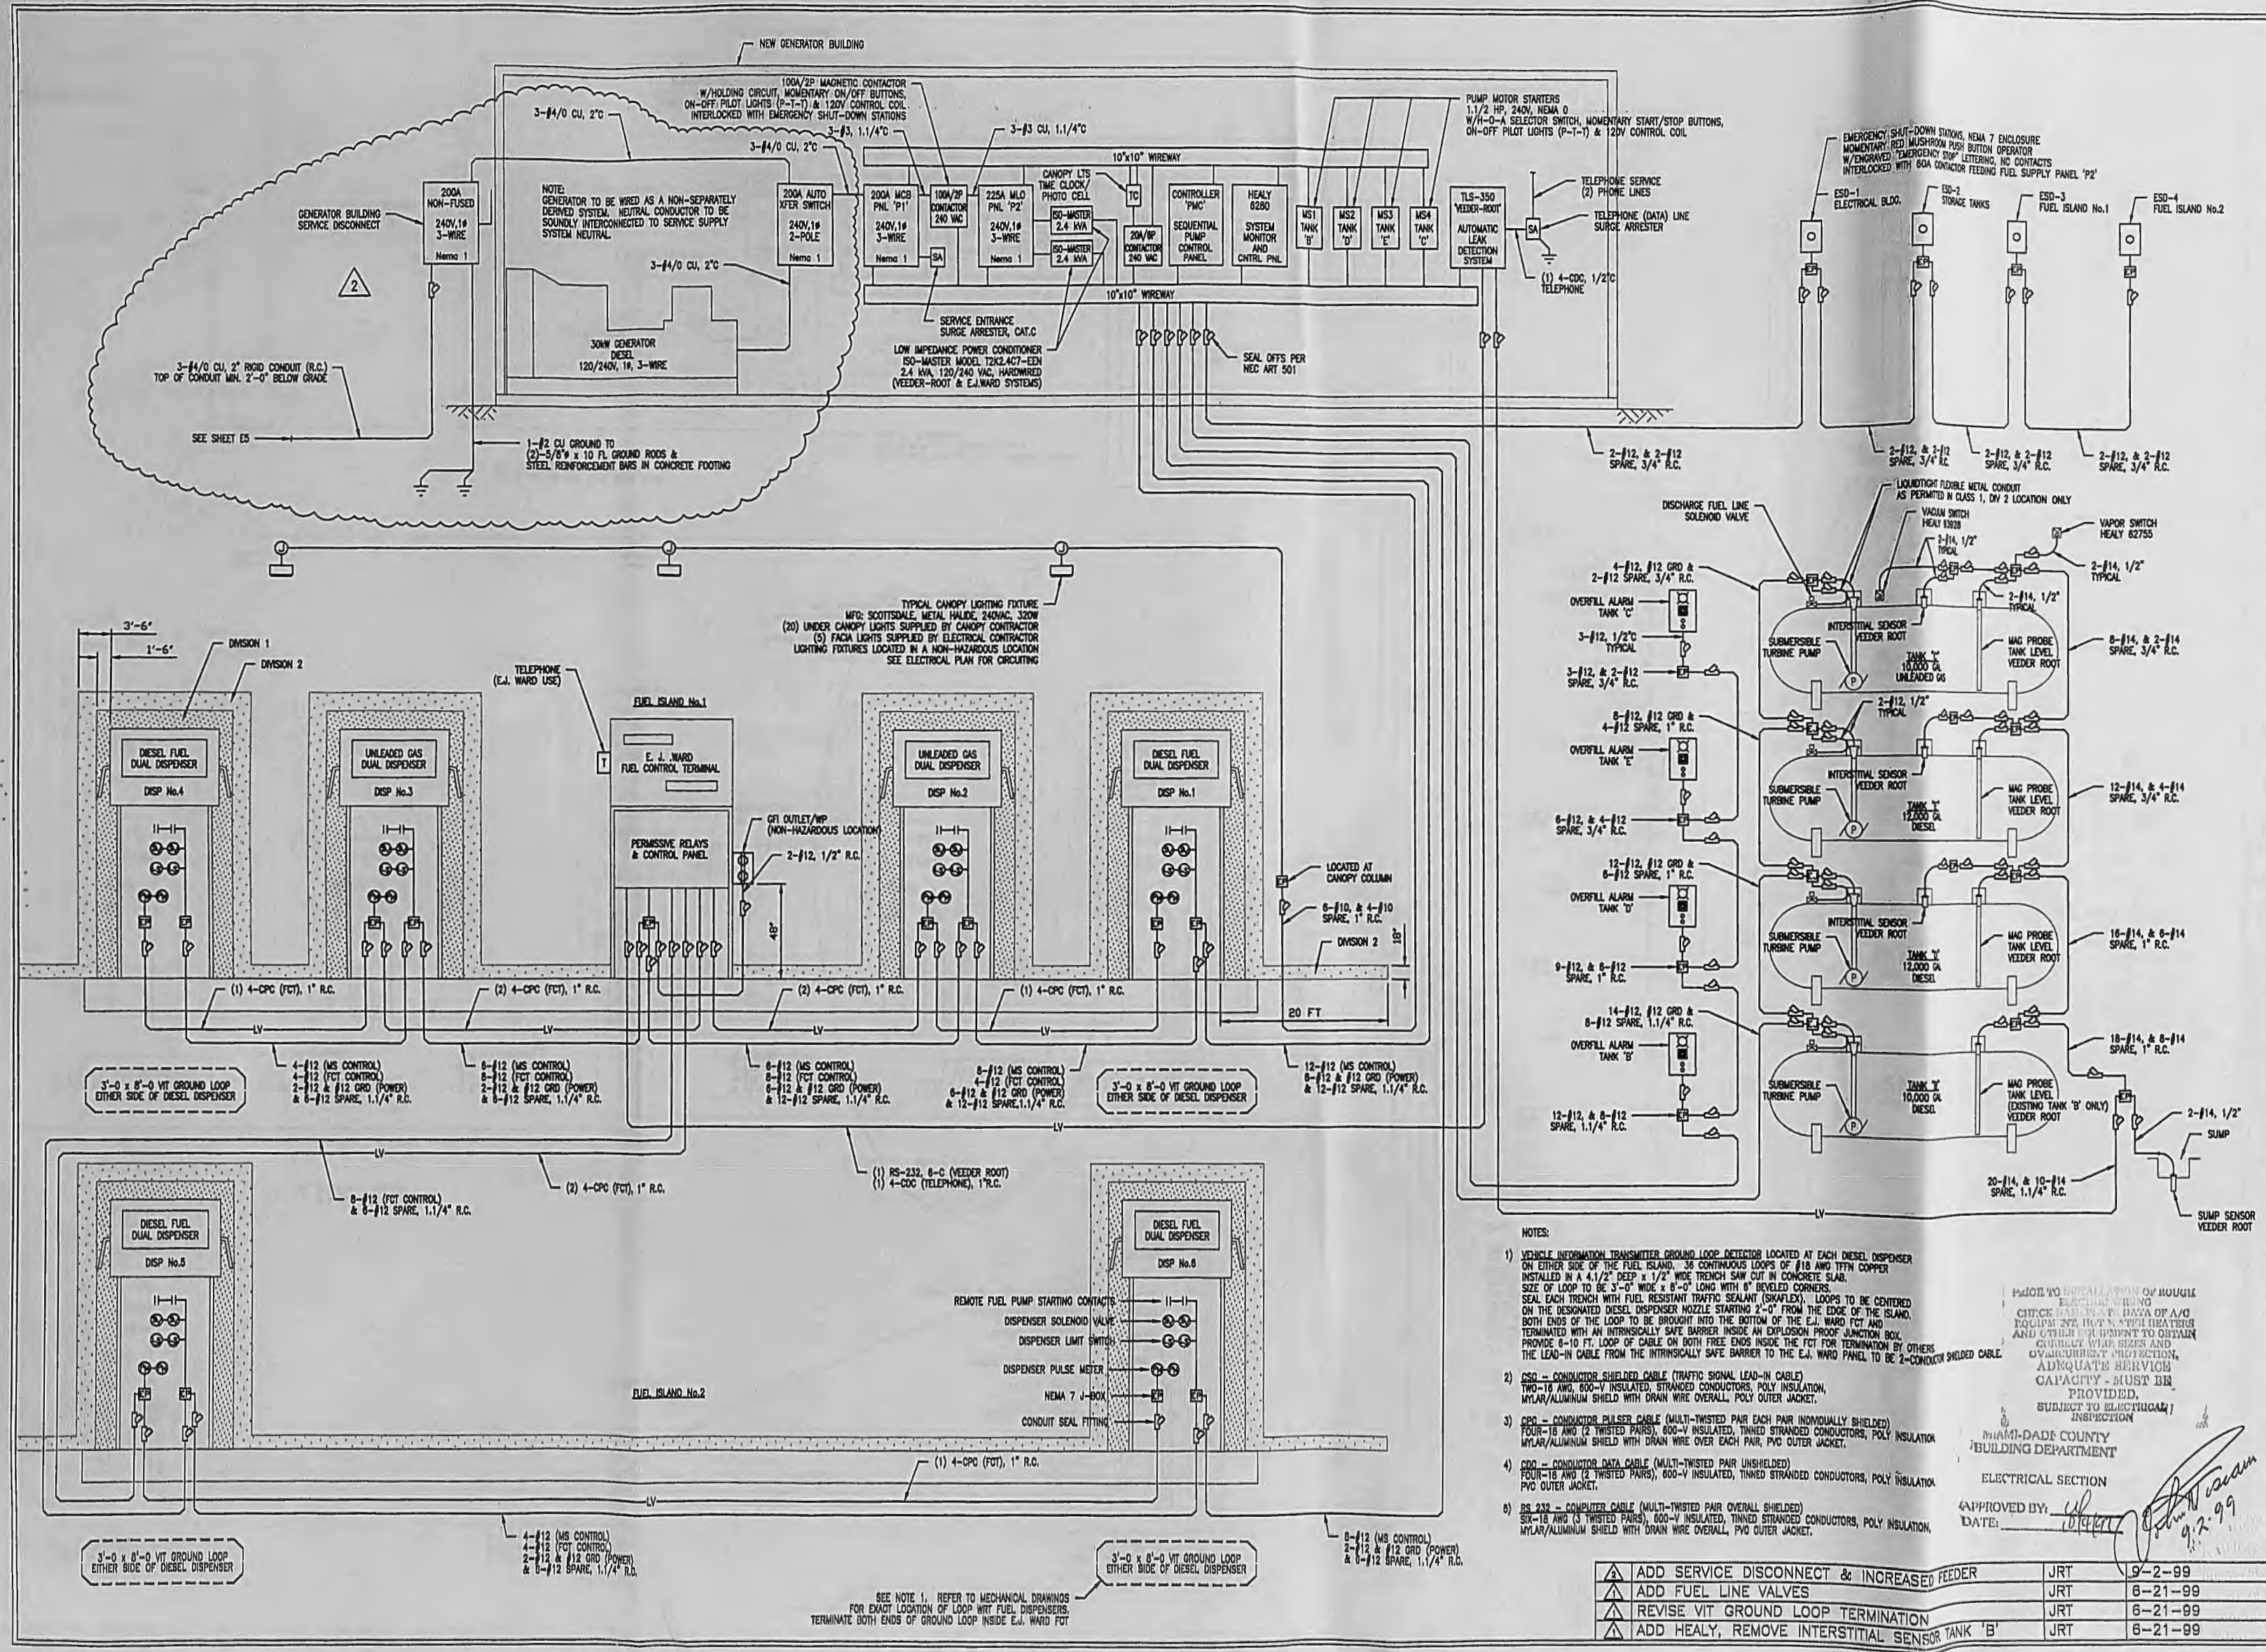

JOHN R. TOSCANO, INC.
CONSULTING ENGINEERS
2751 NE 9th Street/Pompano Beach, FL 33062/(954) 946-0082
29055 Lelona Drive/Las Altas Hills, CA 94022/(650) 971-0873


ATTAWAY SERVICES, INC.
Electrical/Mechanical Contractors
Office: (854) 462-2920
Fax: (854) 462-2921
P.O. Box 460103
FL, Lauderdale, FL 33346-0130

JOHN R. TOSCANO, P.E.
Florida License Number: 33756
California License Number: M028749
Mechanical Engineer
Member of Broward County Board of Rules and Appeals:
Electrical Committee: 1994, 1995, 1996
Fire Code Committee: 1994, 1995, 1996
Professional Society Memberships:
American Society of Heating, Refrigeration, and Air-Conditioning Engineers, ASHRAE
National Fire Protection Association, NFPA
American Concrete Institute, ACI


6	
5	
4	
3	
2	
1	MAY 7, 1999
DATE ISSUED	

GENERAL SERVICES ADMINISTRATION
GAS TANK FARM REDESIGN
SHOP 3
8801 NW 58TH STREET
MIAMI, FLORIDA 33166


SHEET TITLE	
ELECTRICAL RISER	
PROJECT No.	SHEET No.
90301	E2
SCALE: 1/8"=1'-0"	
DRAWN: JRT	
CHECK: JRT	PAGE No.

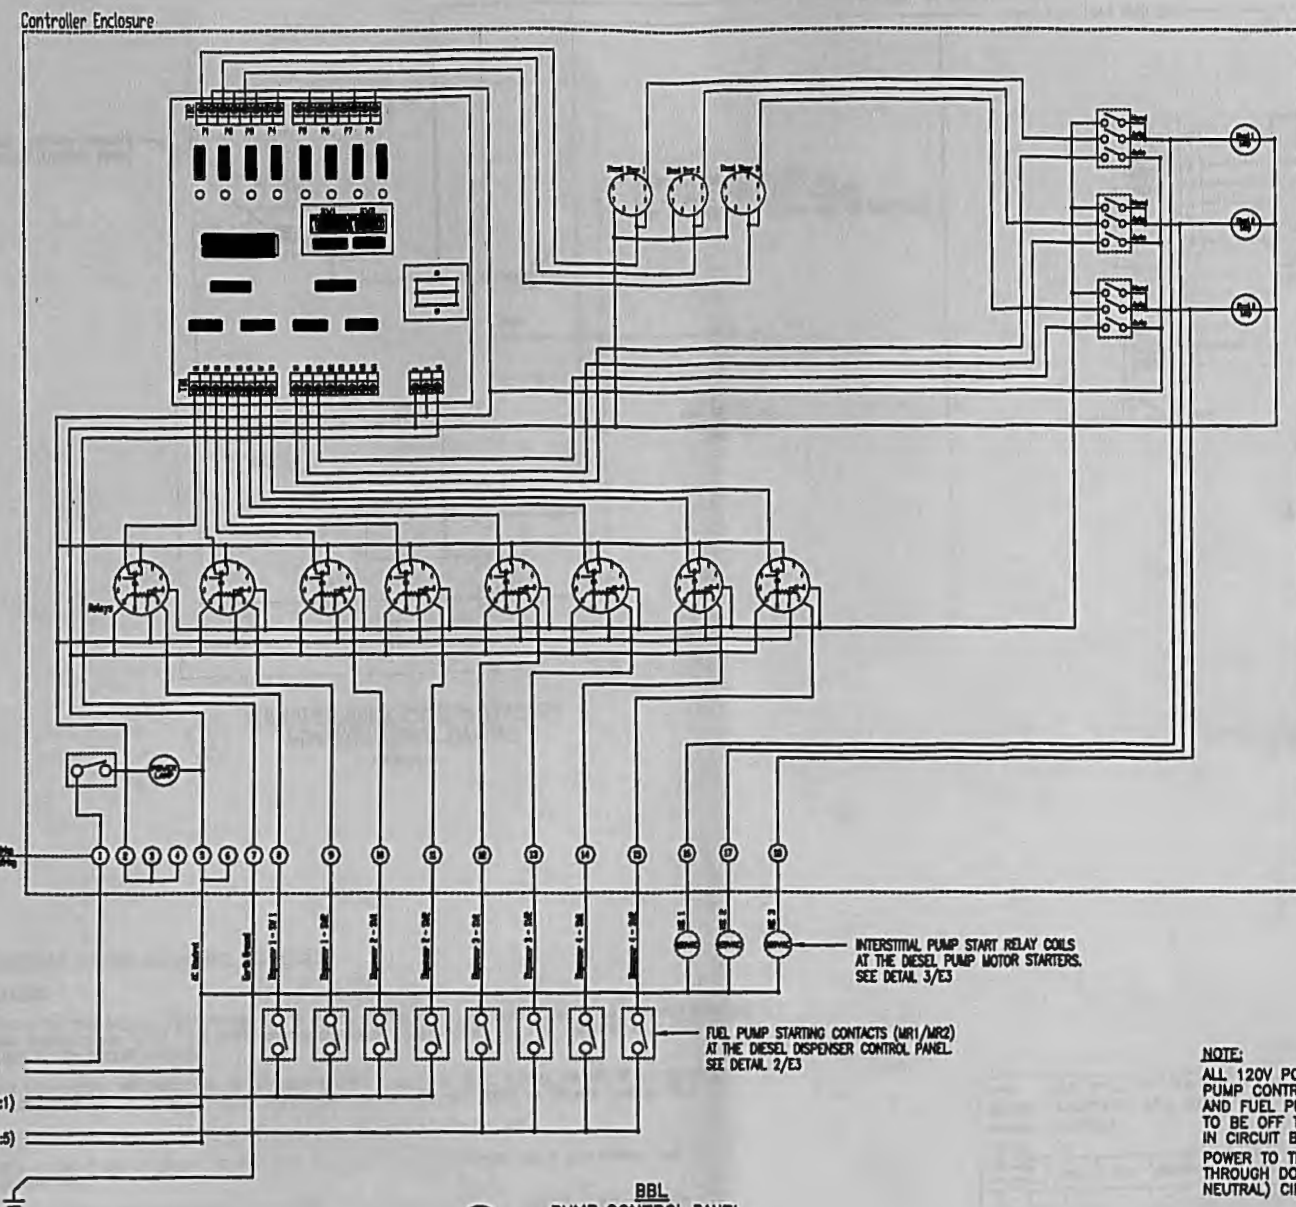


BBL PUMP CONTROL PANEL WIRING DIAGRAM
SCALE: NONE

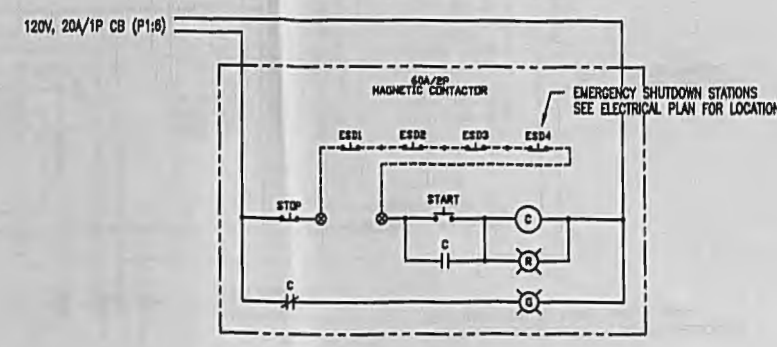


EMERGENCY SHUTDOWN CIRCUIT CONTROL WIRING DIAGRAM
SCALE: NONE

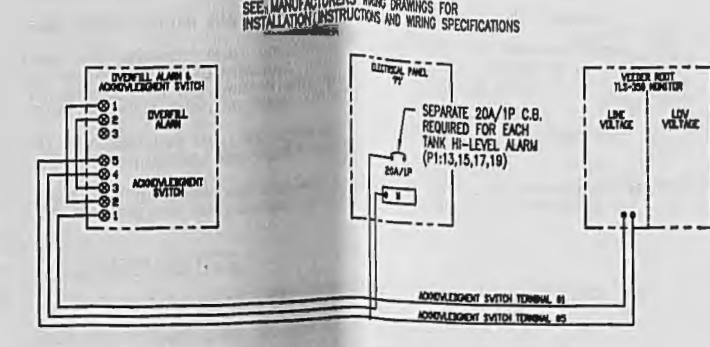

TYPICAL STANK OVERFILL ALARM WIRING DIAGRAM
SCALE: NONE

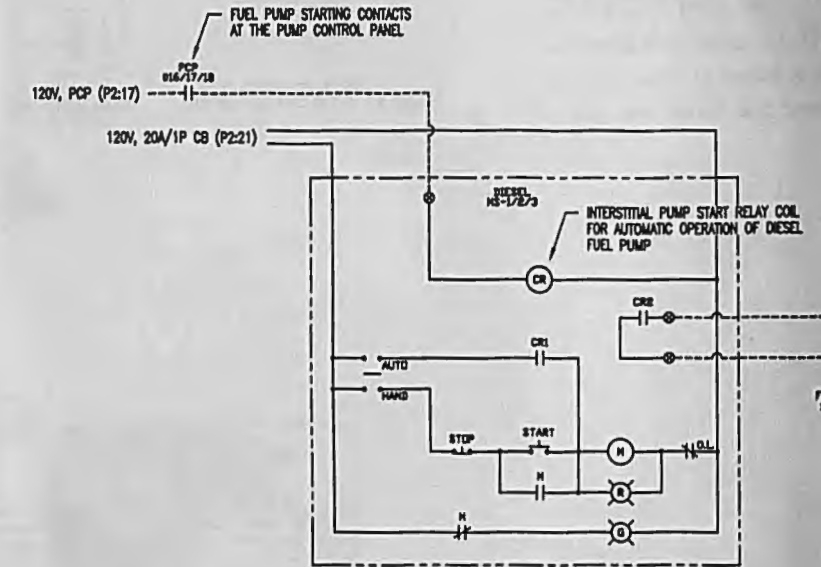

TYPICAL DIESEL PUMP MTR STARTER CONTROL WIRING DIAGRAM
SCALE: NONE

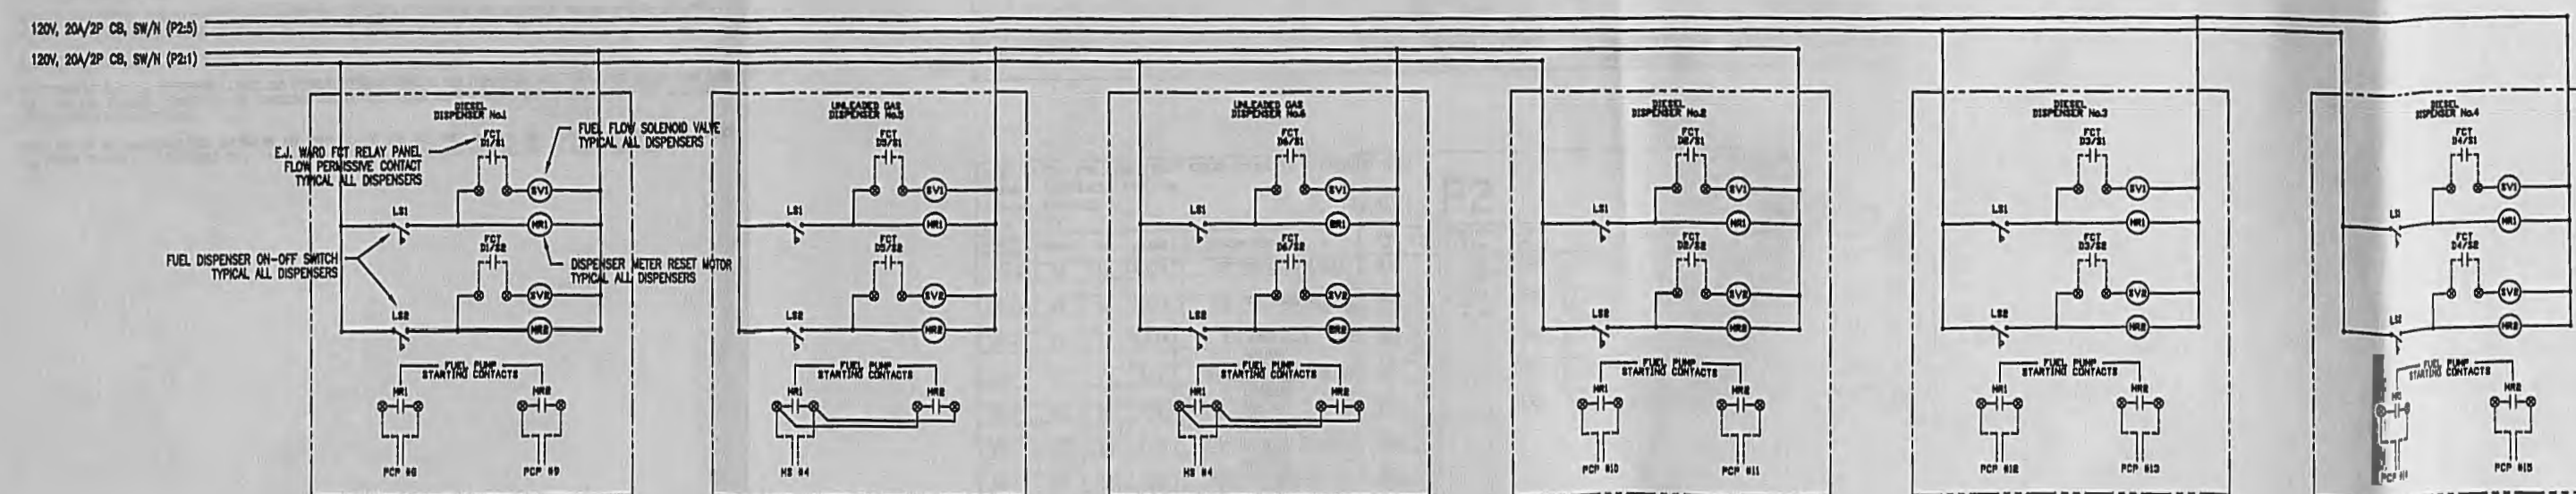

FUEL DISPENSER CONTROL PANELS CONTROL WIRING DIAGRAM
SCALE: NONE

ADD FUEL LINE VALVES

6-24-99
6-24-99

JOHN R. TOSCANO, INC.
CONSULTING ENGINEERS
2751 NE 9th Street/Propano Beach, FL 33062/954/ 946-0032
23055 LaLoma Drive/Los Altos Hills, CA 94022/650/ 917-0873


Office: (954) 482-2920
Fax: (954) 482-2921
ATTAWAY SERVICES, INC.
Electrical/Mechanical Contractors
P.O. Box 480103
Ft. Lauderdale, FL 33346-0130

JOHN R. TOSCANO, P.E.
Florida License Number: 33756
California License Number: M02849
Member of Broward County Board of Rules and Appeals
Electrical Committee: 1984, 1985, 1986
Fire Code Committee: 1984, 1985, 1986
Professional Society Memberships:
American Society of Heating, Refrigerating, and Air-Conditioning Engineers, ASHRAE
National Fire Protection Association, NFPA
American Concrete Institute, ACI

APPROVED BY: *[Signature]*
DATE: 6-24-99
DATE ISSUED: MAY 7, 1999

GENERAL SERVICES ADMINISTRATION
GAS TANK FARM REDESIGN
SHOP 3
8801 NW 58TH STREET
MIAMI, FLORIDA 33166

SHEET TITLE
ELEMENTARY CONTROL DIAGRAMS
PROJECT No.
90301
SHEET No.
E3
SCALE: 1/8"=1'-0"
DRAWN: J. J. J.
CHECK: J. J. J.
PAGE No.

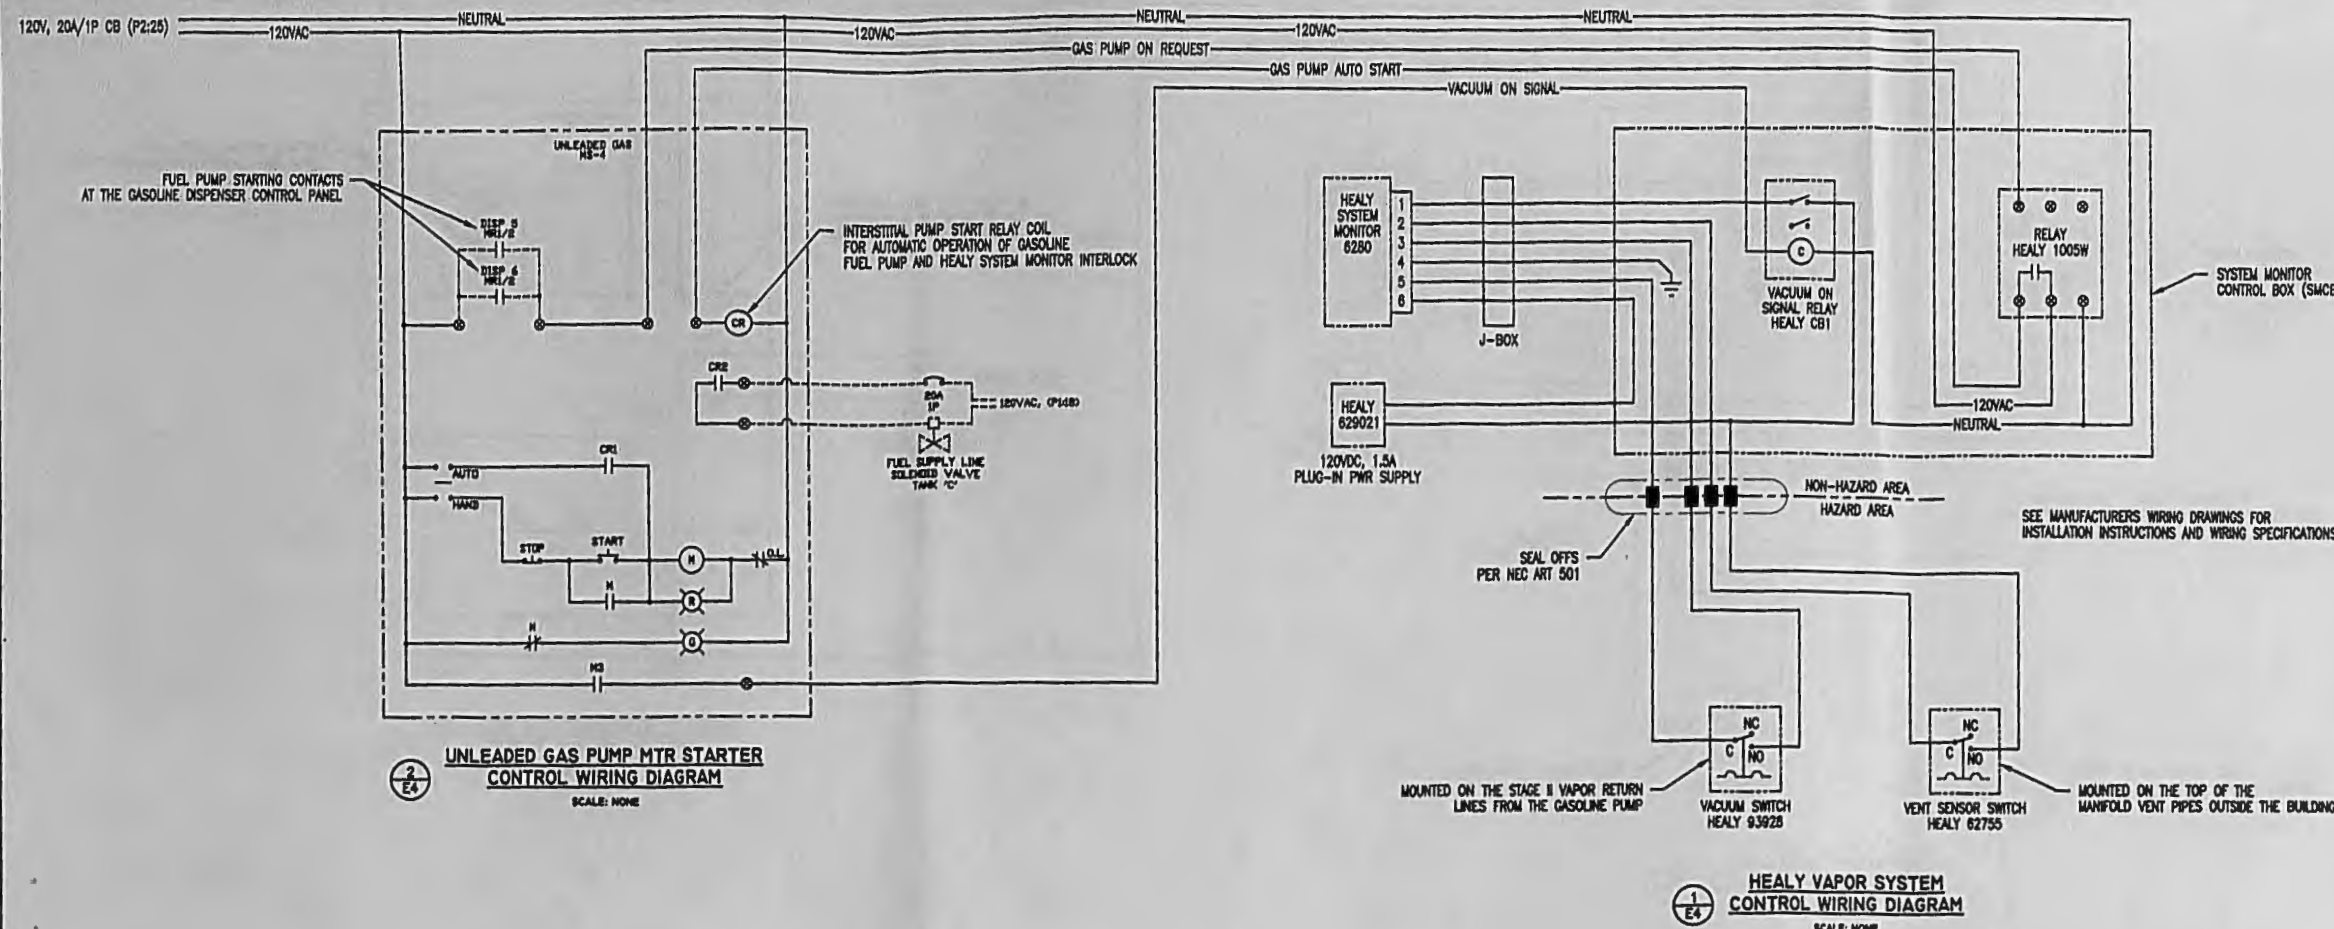

AUTOMATIC DISPENSER CONTROL OPERATIONAL SEQUENCES

GASOLINE DISPENSERS

TURNING ANY ONE OF THE FOUR GASOLINE DISPENSER SWITCHES TO THE ON POSITION WILL: 1) AUTOMATICALLY RESET THE DISPENSER METER, AND 2) SEND A 120VAC CONTROL SIGNAL TO THE HEALY SYSTEM MONITOR CONTROL BOX (SMCB) VIA THE N.O. FUEL DISPENSER RELAY CONTACTS 'M1/M2' LOCATED IN EACH GASOLINE DISPENSER.

THE HEALY 100SW RELAY ACCEPTS THE SIGNAL FROM THE DISPENSER AND IN TURN SENDS A 120VAC CONTROL VOLTAGE TO THE INTERSTITIAL GASOLINE PUMP START RELAY COIL 'CR' LOCATED IN MOTOR STARTER MSA. THE GASOLINE PUMP STARTS VIA THE N.O. CONTACTS 'CR1'.

A 120VAC VACUUM-ON CONTROL SIGNAL IS SENT TO THE HEALY C81 RELAY VIA MSA COIL CONTACTS 'M3'.

A 120VAC CONTROL VOLTAGE IS SENT TO THE N.O. SOLENOID VALVE LOCATED ON THE FUEL DISCHARGE LINE AT EACH STORAGE TANK VIA THE N.O. CONTACTS 'CR2'.

THE E.J. WARD SYSTEM CONTROLS THE DELIVERY OF PRODUCT VIA THE N.O. FUEL FLOW SOLENOID VALVE LOCATED IN EACH DISPENSER. POWER TO THE SOLENOID VALVES IS CONTROLLED BY PERMISSIVE RELAYS LOCATED IN THE E.J. WARD FUEL CONTROL TERMINAL (FCT).

DIESEL DISPENSERS

TURNING ANY ONE OF THE EIGHT DIESEL DISPENSER SWITCHES TO THE ON POSITION WILL: 1) AUTOMATICALLY RESET THE DISPENSER METER, AND 2) SEND A 120VAC CONTROL SIGNAL TO THE PUMP CONTROL PANEL (PCP) VIA THE N.O. FUEL DISPENSER RELAY CONTACTS 'M1/M2' LOCATED IN EACH DIESEL DISPENSER.

THE PCP ACCEPTS THE SIGNAL FROM THE DIESEL DISPENSERS AND IN TURN SENDS A 120VAC CONTROL VOLTAGE TO ONE OR MORE INTERSTITIAL DIESEL PUMP START RELAY COILS 'CR' LOCATED IN MOTOR STARTERS MS1, MS2, OR MS3. THE DIESEL PUMP STARTS VIA THE N.O. CONTACTS 'CR1'.

A 120VAC CONTROL VOLTAGE IS SENT TO THE N.O. SOLENOID VALVE LOCATED ON THE FUEL DISCHARGE LINE AT EACH STORAGE TANK VIA THE N.O. CONTACTS 'CR2'.

THE E.J. WARD SYSTEM CONTROLS THE DELIVERY OF PRODUCT VIA THE N.O. FUEL FLOW SOLENOID VALVE LOCATED IN EACH DISPENSER. POWER TO THE SOLENOID VALVES IS CONTROLLED BY PERMISSIVE RELAYS LOCATED IN THE E.J. WARD FUEL CONTROL TERMINAL (FCT).

EMERGENCY SHUTDOWN DEVICES (ESD)

ALL POWER TO THE FUEL DISPENSING ISLANDS AND PRODUCT STORAGE TANKS IS FED FROM PANEL 'P2'. PANEL 'P2' IS FED FROM PANEL 'P1' VIA A 100 AMP MAGNETIC CONTACTOR. THE CONTACTOR COIL IS HELD CLOSED USING A THREE WIRE HOLDING CIRCUIT WITH MOMENTARY CONTACT PUSH BUTTON STATIONS.

WHEN ANY OF THE EMERGENCY STOP OPERATORS ARE PRESSED, THE COIL WILL DROP OUT AND WILL OPEN THE HOLDING CIRCUIT CONTACT. ALL POWER TO PANEL 'P2' IS TURNED OFF. THE START BUTTON MUST BE OPERATED AGAIN BEFORE THE CIRCUIT WILL RESET.

TYPE: C.B. PNL. BD. (SQ.D. NODD, NEMA 1, SERVICE ENTRANCE)									
SERVICE: 120/240V, 1PH, 3W									
MOUNTING: SURFACE									
PANEL P1									
LOCATION: INSIDE GEN BLDG									
BREAKER TRIP/POLE	WIRE	GRD	CONDUIT	LOAD DESCRIPTION	LOAD VA	QTY	PHASE	QTY	LOAD VA
20-2	10	-	1"	CANOPY LIGHTS	1800	1	1	2	11880
20-2	10	-	1"	CANOPY LIGHTS	3200	5	1	6	200
20-2	10	-	1"	CANOPY LIGHTS	3200	9	1	10	500
20-1	12	-	1 1/4"	TANK 'B' H-LEVEL ALARM	500	13	1	14	900
20-1	12	-	1 1/4"	TANK 'D' H-LEVEL ALARM	500	15	1	16	200
20-1	12	-	1 1/4"	TANK 'C' H-LEVEL ALARM	500	17	1	18	800
20-1	12	-	1 1/4"	TANK 'E' H-LEVEL ALARM	500	19	1	20	600
					21	22			600
					23	24			600
					25	26			
					27	28			
					29	30			
TOTAL CONNECTED LOAD					10000	CONNECTED	17780		27,780 VA (118 Amps)
TOTAL DEMAND LOAD						DEMAND			

TYPE: C.B. PNL. BD. (SQ.D. NODD, NEMA 1, W/GROUND BUS)									
SERVICE: 120/240V, 1PH, 3W									
MOUNTING: SURFACE									
PANEL P2									
LOCATION: INSIDE GEN BLDG									
BREAKER TRIP/POLE	WIRE	GRD	CONDUIT	LOAD DESCRIPTION	LOAD VA	QTY	PHASE	QTY	LOAD VA
20-2	12	12	1 1/4"	DISP PWR ISLAND #1 COIL	800	1	1	2	2400
20-2	12	12	1 1/4"	DISP PWR ISLAND #2 COIL	400	5	1	6	2400
20-1	12	12	1 1/4"	E.J. WARD (FCT)	500	9	1	10	2400
20-1	12	12	1 1/4"	VEEDER-ROOT (TLS-350) COIL	500	13	1	14	1660
20-1	12	12	1 1/4"	BEL POP	200	17	1	18	200
20-1	12	12	1 1/4"	CHTRL QTY-DIESEL PUMPS	200	21	1	22	
20-1	12	12	1 1/4"	CHTRL QTY-GAS PUMP	200	23	1	24	
					25	26			
					27	28			
					29	30			
TOTAL CONNECTED LOAD					2800	CONNECTED	9060		11,860 VA (49 Amps)
TOTAL DEMAND LOAD						DEMAND			

GENERAL NOTES:

DRAWINGS ARE DIAGRAMMATIC. DO NOT SCALE DRAWING FOR EXACT LOCATIONS OF EQUIPMENT, CONDUITS, ETC. THESE DRAWINGS ARE NOT INTENDED TO SHOW EVERY MINOR DETAIL, BUT THE CONTRACTOR SHALL FURNISH AND INSTALL ALL ITEMS REQUIRED FOR A COMPLETE AND ACCEPTABLE WORKING INSTALLATION.

ALL WORKMANSHIP AND MATERIALS SHALL BE IN STRICT ACCORDANCE WITH APPLICABLE NATIONAL, STATE, AND LOCAL CODES, RULES, AND REGULATIONS.

ALL MATERIAL SHALL BE NEW AND BEAR THE UL LABEL WHERE APPLICABLE.

EACH SUBCONTRACTOR SHALL COORDINATE HIS WORK WITH THE OTHER TRADES.

EACH SUBCONTRACTOR SHALL VISIT THE SITE AND DETERMINE THE SCOPE OF WORK. ALL WORK REQUIRED TO ASSEMBLE, INSTALL, AND STARTUP THE EQUIPMENT IN ACCORDANCE WITH THE OWNER'S AND MANUFACTURER'S REQUIREMENTS, SHALL BE INCLUDED IN THE SCOPE OF WORK.

ALL NEW EQUIPMENT SHALL BE INSTALLED IN ACCORDANCE WITH MANUFACTURER'S RECOMMENDED INSTALLATION INSTRUCTIONS.

CONTRACTOR TO INSURE THAT PROPER CLEARANCE IS PROVIDED ALL AROUND NEW EQUIPMENT FOR SERVICING AND REPLACEMENT AS PER MANUFACTURER'S RECOMMENDATIONS.

ELECTRICAL NOTES:

INSTALLATIONS SHALL BE IN STRICT ACCORDANCE WITH THE NATIONAL ELECTRICAL CODE.

EQUIPMENT VOLTAGES SHALL BE VERIFIED PRIOR TO ANY INSTALLATION.

ALL WIRE TO BE COPPER THHN/THWN OR EQUIV. ALUMINUM NOT ACCEPTABLE.

ALL CONDUITS LOCATED OUTSIDE SHALL BE IN RIGID METAL CONDUIT.

PROVIDE EXPLOSION-PROOF CONDUIT SEAL-OFFS ON ALL CONDUITS ENTERING AND LEAVING CLASSIFIED HAZARDOUS LOCATIONS.

THE ELECTRICAL SYSTEM SHALL BE COMPLETELY AND EFFECTIVELY GROUNDED IN ACCORDANCE WITH THE N.E.C. ARTICLE 250.

ALL SWITCH GEAR, PANELS, ETC. TO BE MARKED WITH PERMANENT ENGRAVED TAGS.

ALL WIRING SHALL BE LABELED AT EACH END AND AT EACH JUNCTION BOX.

PROVIDE TYPE WRITTEN PANEL SCHEDULES IDENTIFYING EACH BRANCH CIRCUIT BREAKER.

JOHN R. TOSCANO, INC.
CONSULTING ENGINEERS
2751 NE 9th Street/Oppama Beach, FL 33062/954-946-0022
23055 La Jolla Drive/Los Altos Hills, CA 94022/650-917-0873

Office: (854) 462-2020
Fax: (854) 462-2921
ATTAWAY SERVICES, INC.
Electrical/Mechanical Contractors
P.O. Box 460103
FL, Lauderdale, FL 33346-0130

JOHN R. TOSCANO, P.E.
Florida License Number: 33706
California License Number: 0226749


Member of Broward County Board of Rules and Appeals
Fire Code Committee: 1984, 1985, 1986
Professional Society Memberships:
National Fire Protection Association, NFPA
American Concrete Institute, A.C.I.

6
5
4
3
2
1
JUNE 21, 1999
DATE ISSUED


GENERAL SERVICES ADMINISTRATION
GAS TANK FARM REDESIGN
SHOP 3
8801 NW 58TH STREET
MIAMI, FLORIDA 33166

SHEET TITLE
ELECTRICAL CONTROL DIAGRAMS
ELECTRICAL PANELS & NOTES
PROJECT No. 90301
SHEET No. E4
SCALE: 1/8"=1'-0"
DRAWN: JRT
CHECKED: JRT
PAGE No.


INCREASED SIZE OF M.C.B.
ADD HEALY, ADD FUEL LINE VALVES
JRT 9-2-99
JRT 8-21-99

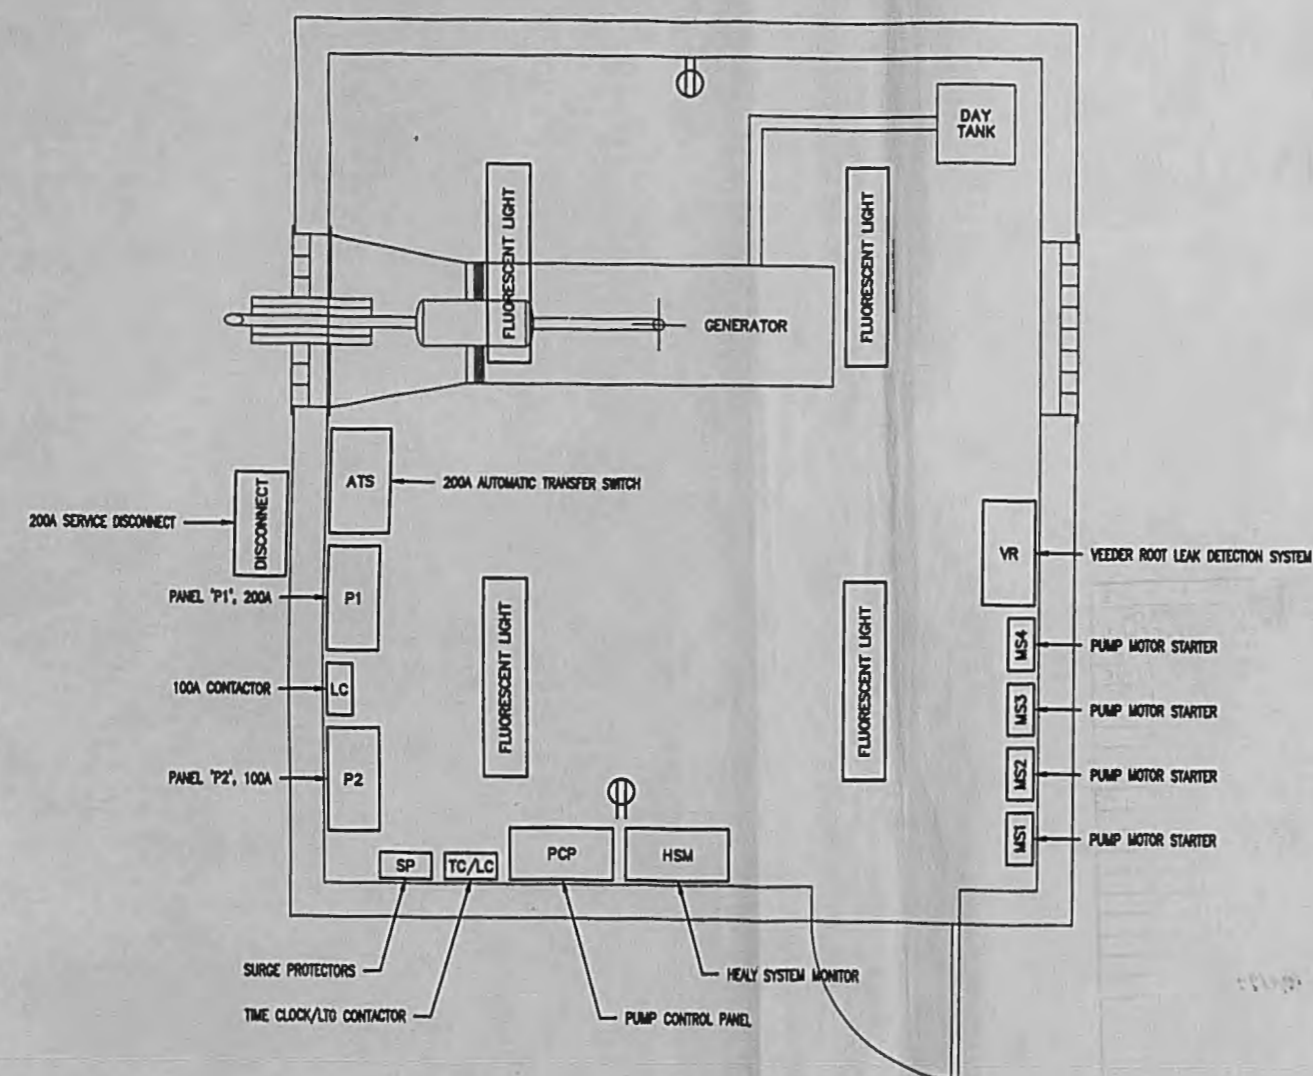

2 Generator Bldg. Elect. Plan
1/8" = 1'-0"

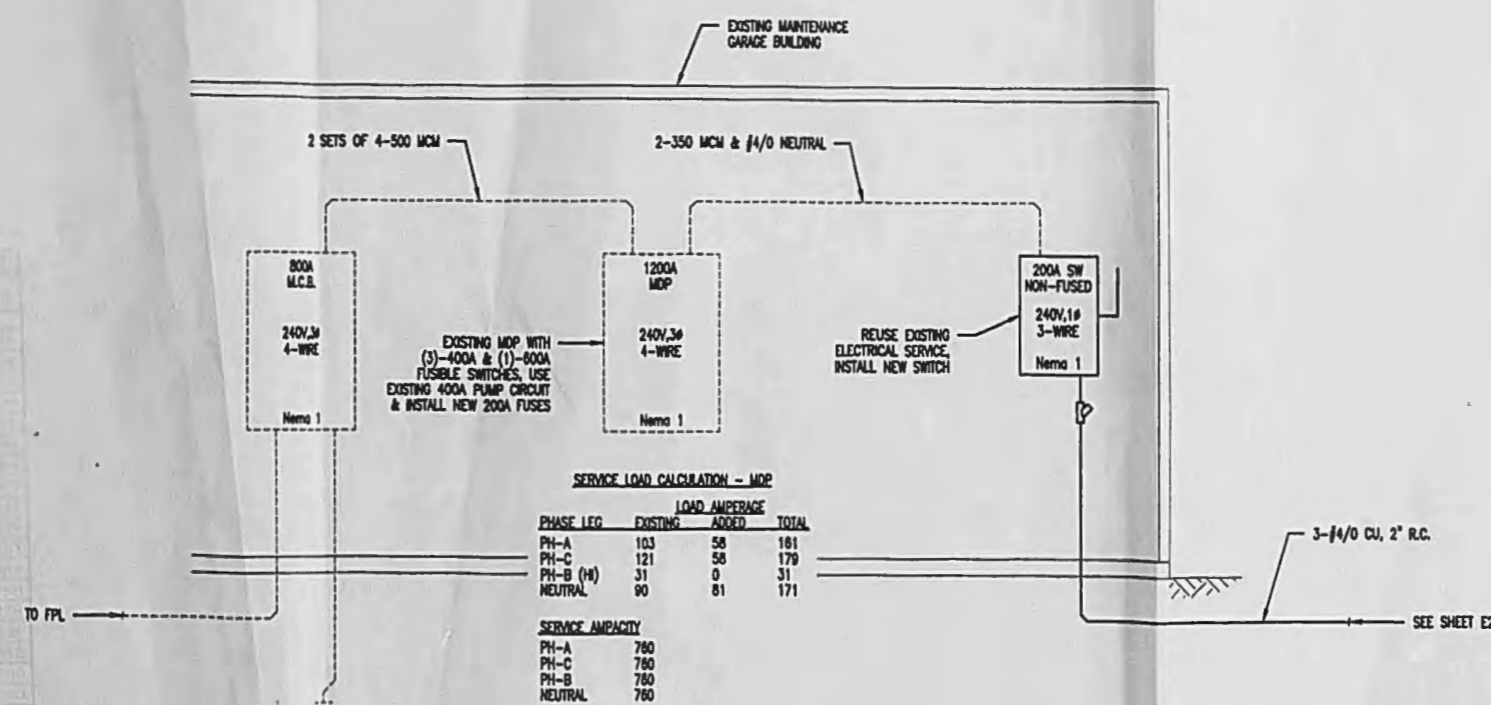

1 Maintenance Bldg. Elect. Riser
Scale: None

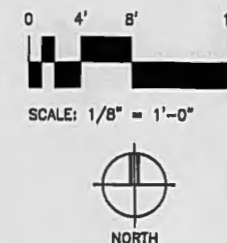

BEFORE INSTALLATION OF ANY ELECTRICAL WIRING EQUIPMENT, HOT WATER HEATERS AND OTHER EQUIPMENT TO OBTAIN CORRECT WIRE SIZES AND OVERCURRENT PROTECTION, ADEQUATE SERVICE CAPACITY - MUST BE PROVIDED, SUBJECT TO ELECTRICAL INSPECTION

MIAMI-DADE COUNTY
BUILDING DEPARTMENT
ELECTRICAL SECTION
APPROVED BY: *[Signature]*
DATE: *9-2-99*

JOHN R. TOSCANO, INC. CONSULTING ENGINEERS 2751 NE 9th Street/Pompano Beach, FL 33062/954 946-0032 25055 Lido Dr. W/ Los Altos Hills, CA 94022/415 917-0873	
ATTAWAY SERVICES, INC. Electrical/Mechanical Contractors P.O. Box 480103 Ft. Lauderdale, FL 33346-0130	JOHN R. TOSCANO, P.E. Florida License Number: 33756 California License Number: M028749 Mechanical Engineer Member of Broward County Board of Rules and Appeals: Electrical Committee: 1994, 1995, 1996 Fire Code Committee: 1994, 1995, 1996 Professional Society Memberships: American Society of Heating, Refrigeration and Air-Conditioning Engineers, ASHRAE National Fire Protection Association, N.F.P.A. American Concrete Institute, A.C.I.
GENERAL SERVICES ADMINISTRATION GAS TANK FARM REDESIGN SHOP 3 8801 NW 58TH STREET MIAMI, FLORIDA 33166	
SHEET TITLE ELECTRICAL DETAILS	
PROJECT No. 90301	SHEET No. E5
SCALE: 1/8" = 1'-0" DRAWN: <i>[Signature]</i> CHECK: <i>[Signature]</i>	PAGE No.

From: saide@scrmechanical.com
To: [Muñoz, Alfredo \(PIOD\)](#)
Cc: [Perez Texidor, Frances \(PIOD\)](#); ["Rafael SCRMechanical"](#)
Subject: RE: RPQ No. ID-0000000785-Diesel Exhaust Fuel -DEF- System Installation
Date: Thursday, June 5, 2025 12:33:17 PM
Attachments: [image002.png](#)

EMAIL RECEIVED FROM EXTERNAL
SOURCE

Mr. Munoz,

Following up to the mandatory pre-bid meeting and site visit of earlier this morning, please see below some of the RFI's to be addressed:

- Please provide Technical Specifications for the DEF piping to be installed
- Please provide detailed piping route for the proposed new system
- Please provide technical Specifications for the DEF Tank.
- Please provide detailed instrumentation required for the DEF piping and storage system.

Thank you,

Saide Rangel



E: saide@scrmechanical.com

1600 Ponce De Leon Blvd, Ste 1016

Coral Gables, Florida 33134

Phone: (786) 369-0465

Mobile: (954) 214-3759

From: saide@scrmechanical.com
To: [Muñoz, Alfredo \(PIOD\)](#)
Cc: [Perez Texidor, Frances \(PIOD\)](#); ["Rafael SCRMechanical"; Clerk of the Board \(COC\)](#)
Subject: RE: RPQ No. ID-0000000785-Diesel Exhaust Fuel -DEF- System Installation
Date: Friday, June 6, 2025 1:06:10 PM
Attachments: [image002.png](#)

EMAIL RECEIVED FROM EXTERNAL
SOURCE

Mr. Munoz,

Please see below another RFI:

- Please provide detailed plans for this project.
- Do Prevailing Wages apply for this project? If yes, does Building or Heavy wages apply?

Have a great weekend!

Saide Rangel



E: saide@scrmechanical.com

1600 Ponce De Leon Blvd, Ste 1016

Coral Gables, Florida 33134

Phone: (786) 369-0465

Mobile: (954) 214-3759

From: [Ricardo Montijo](#)
To: [Perez Texidor, Frances \(PIOD\)](#)
Cc: [Muñoz, Alfredo \(PIOD\)](#); [Clerk of the Board \(COC\)](#)
Subject: RFI for RPQ No. ID-0000000785-Diesel Exhaust Fuel -DEF- System Installation
Date: Monday, June 9, 2025 12:50:00 PM

EMAIL RECEIVED FROM EXTERNAL
SOURCE

Hi

The following is a list of RFI for the mentioned project.

1. Please provide the existing electrical system as-built and panel schedule for the fuel pump system, fuel System as-built, site plan as-built for the gas station.
2. Does this project have working hours restrictions?
3. Please indicate the amount of dispenser/ hoses required.
4. Does the County have any equipment preference?
5. Please provide the tank capacity that County would like to have.
6. Will EJ Wall pedestal have control relays for the activation of the DEF pump?
7. We would like to know the amount of tank required and their capacity.
8. Are new bollards are going required or new ones are required ? Which size?
9. Can you extend the bid due date?
10. Where's required to deliver the bid package?

Number of dispensers/hoses

- Tank capacity
- Hose lengths- are hose retractors required?
- Will the EJ Ward pedestal have control relays for the activation of the DEF pumps?
- number of tanks?
- bollard size?

Sincerely;

Ricardo Montijo
RicMon Group LLC
General & Engineering Contractor
BSCE, CGC, CUC, HI

Phone: 786-443-7342

Attention: The information contained in this e-mail message is confidential information and privileged. The information contained herein is intended solely for the use of the individual(s) named above. If the recipient of this message is not the intended recipient, you are hereby notified that any distribution or dissemination of this communication is strictly prohibited. In the event that you have received this communication in error, please contact the sender by reply e-mail and destroy any and all copies of the original message.

Thank you.