

MIAMI-DADE COUNTY PRODUCT CONTROL SECTION

11805 SW 26 Street, Room 208 Miami, Florida 33175-2474 T (786) 315-2590 F (786) 315-2599 www.miamidade.gov/economy

DEPARTMENT OF REGULATORY AND ECONOMIC RESOURCES (RER) BOARD AND CODE ADMINISTRATION DIVISION

NOTICE OF ACCEPTANCE (NOA)

Alumina Distribution Center, LLC 14475 NW 26th Ave Opa Locka, FL 33054

SCOPE:

This NOA is being issued under the applicable rules and regulations governing the use of construction materials. The documentation submitted has been reviewed and accepted by Miami-Dade County RER -Product Control Section to be used in Miami Dade County and other areas where allowed by the Authority Having Jurisdiction (AHJ).

This NOA shall not be valid after the expiration date stated below. The Miami-Dade County Product Control Section (In Miami Dade County) and/or the AHJ (in areas other than Miami Dade County) reserve the right to have this product or material tested for quality assurance purposes. If this product or material fails to perform in the accepted manner, the manufacturer will incur the expense of such testing and the AHJ may immediately revoke, modify, or suspend the use of such product or material within their jurisdiction. RER reserves the right to revoke this acceptance, if it is determined by Miami-Dade County Product Control Section that this product or material fails to meet the requirements of the applicable building code.

This product is approved as described herein, and has been designed to comply with the Florida Building Code, including the High Velocity Hurricane Zone.

DESCRIPTION: Series ADC-112556 Aluminum Outswing Doors w/wo Transom or Sidelites-L.M.I.

APPROVAL DOCUMENT: Drawing No. **17-151**, titled "Series ADC-112556 Aluminum Outswing French Door w/wo Transom or Sidelites", sheets 1 through 24 of 24, dated 08/08/17, with revision 1 dated 08/08/17, prepared by Tilteco, Inc., signed and sealed by Walter A. Tillit, Jr., P.E., bearing the Miami-Dade County Product Control Renewal stamp with the Notice of Acceptance number and Expiration date by the Miami-Dade County Product Control Section.

MISSILE IMPACT RATING: Large and Small Missile Impact Resistant Limitations:

- 1. See Design Pressure ratings (**DP**) in sheet <u>21</u> for single & double doors. See Doors w/ Transom <u>or</u> w/ sidelites VS max frame Height and max frame width in sheet <u>21</u>. Lower Design Pressure shall control.
- 2. The total frame area of alternate sizes must not exceed 122.22 ft² for doors w/ sidelites and 82.22 ft² for double door w/Transom. Frame height for sidelites is 100" max.
- 3. Transom and vertical mullions have been analyzed at 49 PSF(ASD). See Sheet 22 for anchor schedule.

LABELING: Each unit shall bear a permanent label with the manufacturer's name or logo, Cali, Colombia and series and following statement: "Miami-Dade County Product Control Approved", noted herein.

RENEWAL of this NOA shall be considered after a renewal application has been filed and there has been no change in the applicable building code negatively affecting the performance of this product.

TERMINATION of this NOA will occur after the expiration date or if there has been a revision or change in the materials, use, and/or manufacture of the product or process. Misuse of this NOA as an endorsement of any product, for sales, advertising or any other purposes shall automatically terminate this NOA. Failure to comply with any section of this NOA shall be cause for termination and removal of NOA.

ADVERTISEMENT: The NOA number preceded by the words Miami-Dade County, Florida, and followed by the expiration date may be displayed in advertising literature. If any portion of the NOA is displayed, then it shall be done in its entirety.

INSPECTION: A copy of this entire NOA shall be provided to the user by the manufacturer or its distributors and shall be available for inspection at the job site at the request of the Building Official.

This NOA **renews NOA #17-1102.10** and consists of this page 1 and evidence pages E-1 and E-2, as well as approval document mentioned above.

The submitted documentation was reviewed by Sifang Zhao, P.E.



5, 2. 10/08/2020

NOA No. 20-0124.01 Expiration Date: October 08, 2025 Approval Date: October 08, 2020

Page 1

NOTICE OF ACCEPTANCE: EVIDENCE SUBMITTED

1. EVIDENCE SUBMITTED UNDER PREVIOUS NOA'S

A. DRAWINGS

- 1. Manufacturer's die drawings and sections
- 2. Drawing No. 17-151, titled "Series ADC-112556 Aluminum Outswing French Door w/wo Transom or Sidelites", sheets 1 through 24 of 24, dated 08/08/17, with revision 1 dated 08/08/17, prepared by Tilteco, Inc., signed and sealed by Walter A. Tillit, Jr., P.E.

B. TESTS

- 1. Test reports on: 1) Air Infiltration Test, per FBC, TAS 202-94
 - 2) Uniform Static Air Pressure Test, Loading per FBC TAS 202-94
 - 3) Water Resistance Test, per FBC, TAS 202-94
 - 4) Large Missile Impact Test per FBC, TAS 201-94
 - 5) Cyclic Wind Pressure Loading per FBC, TAS 203-94
 - 6) Forced Entry Test, per FBC 2411 3.2.1, TAS 202-94

along with marked-up drawings and installation diagram of aluminum outswing w/transom and doors w/Sidelites, prepared by Fenestration Testing lab, Inc., Test Report No. **FTL-8131**, dated 01/21/15, signed and sealed by Idalmis Ortega, P. E.

Note: This report has an addendum letter dated AUG 07, 2015, issued by Fenestration Testing

C. CALCULATIONS

- 1. Anchor verification calculations and structural analysis complying with FBC-2014 (5th **Edition**), dated 03/06/15 and 08/25/15, prepared by Tilteco, Inc., signed and sealed by Walter A. Tillit, Jr., P.E.
- 2. Glazing complies w/ ASTME-1300-02, -04 and -09.

D. QUALITY ASSURANCE

1. Miami Dade Department of Regulatory and Economic Resources (RER).

E. MATERIAL CERTIFICATIONS

1. Notice of Acceptance No. **14-0916.11** issued to **Kuraray America, Inc.** (Former E.I. DuPont DeNemours & Co., Inc. for the "**Sentry Glass** ® (**Clear and White**) **Glass Interlayers**", expiring on 07/04/18.

F. STATEMENTS

- 1. Statement letter of conformance to FBC 6th Edition (2017) dated 08/08/17, prepared by Tilteco, Inc., signed and sealed by Walter A. Tillit, Jr., P.E.
- 2. Lab compliance as part of the above referenced test report.

G. OTHER

- 1. Test proposal # 11-1141(revised 07/23/14) approved by Jaime D. Gascon, P.E.
- 2. Distribution agreement dated 08/14/15 between Groupo Alumina, Colombia (manufacturer) and Aluminum Distribution Center, Opalocka (distributor), signed by Michael Gil, CFO and Mario Callejas, president, respectively on behalf of their companies.

Sifang Zhao, P.E. Product Control Examiner NOA No. 20-0124.01 Expiration Date: October 08, 2025 Approval Date: October 08, 2020

Alumina Distribution Center, LLC

NOTICE OF ACCEPTANCE: EVIDENCE SUBMITTED

- 2. NEW EVIDENCE SUBMITTED
- A. DRAWINGS
 - 1. None.
- B. TESTS
 - 1. None.
- C. CALCULATIONS
 - 1. None.
- D. QUALITY ASSURANCE
 - 1. Miami Dade Department of Regulatory and Economic Resources (RER).
- E. MATERIAL CERTIFICATIONS
 - Notice of Acceptance No. **19-0305.02** issued to **Kuraray America**, **Inc.** for their "**Trosifol** ® **Ultraclear**, **Clear and Color Glass Interlayers**", expiring on 07/08/24.
- F. STATEMENTS
 - 1. None.
- G. OTHER
 - 1. This NOA **renews #17-1102.10**, expiring on 10/08/20.

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GENERAL NOTES:

1. SERIES ADC-112556 ALUMINUM OUTSWING FRENCH DOOR, SHOWN ON THIS PRODUCT APPROVAL DOCUMENT (P.A.D.) HAS BEEN VERIFIED FOR COMPLIANCE IN ACCORDANCE WITH THE 2017 (6th EDITION) OF THE FLORIDA BUILDING CODE. SERIES ADC-112556 ALUMINUM OUTSWING FRENCH DOOR MAY BE INSTALLED AT HIGH VELOCITY HURRICANE ZONES.

DESIGN WIND LOADS SHALL BE DETERMINED AS PER SECTIONS 1620 OF THE ABOVE MENTIONED CODE, USING ASCE 7-10 AND SHALL NOT EXCEED THE MAXIMUM (A.S.D.) DESIGN PRESSURE RATINGS INDICATED ON NOTE 3 BELOW.

IN ORDER TO VERIFY THE ABOVE CONDITION, ULTIMATE DESIGN WIND LOADS DETERMINED PER ASCE 7-10 SHALL BE FIRST REDUCED TO A.S.D. DESIGN WIND LOADS BY MULTIPLYING THEM BY 0.6 IN ORDER TO COMPARE THESE W/ MAX. (A.S.D.) DESIGN PRESSURE RATINGS INDICATED ON NOTE 3 BELOW.

IN ORDER TO VERIFY THAT ANCHORS ON THIS P.A.D., AS TESTED, WERE NOT OVERSTRESSED, A 33% INCREASE IN ALLOWABLE STRESS FOR WIND LOADS WAS NOT USED IN THEIR ANALYSIS. A DURATION FACTOR CD=1.60 WAS USED TO VERIFY FASTENERS IN WOOD.

THIS DOOR'S ADEQUACY FOR IMPACT AND WIND RESISTANCE HAS BEEN VERIFIED IN ACCORDANCE WITH SECTION 1626 OF THE ABOVE MENTIONED CODE AS PER PROTOCOLS TAS-201, TAS-202, TAS-203, PER FENESTRATION TESTING LABORATORY, INC. LAB REPORT #8131 AND AS PER SUBMITTED STRUCTURAL CALCULATIONS, PERFORMED AS PER SECTION 1616 OF THE FLORIDA BUILDING CODE.

- 2. REMAINING COMPONENTS FOR THIS FRENCH DOOR SYSTEM SHALL BE AS INDICATED ON BILL OF MATERIALS AND COMPONENT SHEETS 2, 3 AND 4 OF THIS DRAWING.
- 3. MAXIMUM A.S.D. DESIGN PRESSURE RATINGS FOR THIS PRODUCT SHALL BE AS SHOWN ON SHEET 21. SEE DOOR ELEVATIONS ON SHEETS 5 THRU 10 FOR QUALIFIED CONFIGURATIONS.
- 4. THIS SERIES ADC-112556 ALUMINUM OUTSWING FRENCH DOOR WILL NOT REQUIRE A HURRICANE PROTECTION DEVICE.
- 5. THIS SERIES ADC-112556 ALUMINUM OUTSWING FRENCH DOOR IS APPROVED FOR AIR AND WATER INFILTRATION.
- 6. ALL ALUMINUM EXTRUSIONS SHALL BE ALUMINUM ASSOCIATION 6063-T6 ALLOY AND TEMPER, WITH Fy=25.0 ksi MINIMUM. THE THICKNESS OF ALL EXTRUSIONS SHALL BE AS SHOWN ON THIS DRAWING.
- 7 ALL SCREWS USED FOR ASSEMBLY CONNECTIONS (METAL TO METAL) TO BE STAINLESS STEEL 304 OR 316 AISI SERIES OR CORROSION RESISTANT COATED CARBON STEEL AS PER DIN 50018 WITH 50 ksi YIELD STRENGTH AND 90 ksi TENSILE STRENGTH & SHALL COMPLY W/ FLORIDA BUILDING CODE SECTION 2411.3.3.4.
- 8. WOOD BUCKS, BY OTHERS, MUST BE ANCHORED PROPERLY TO TRANSFER LOADS TO THE BUILDING STRUCTURE. WOOD BUCKS MUST BE SOUTHERN PINE, G=0.55, AND SHALL COMPLY WITH SECTIONS 2411.3.3.3 & 2326 OF THE FLORIDA BUILDING CODE.
- ANCHOR NOTES: EMBEDMENT AND EDGE DISTANCE ARE BEYOND ANY FINISH.
- (A) TO EXISTING POURED CONCRETE: (MIN. f'c = 2000 psi), MIN. EDGE DISTANCE (E.D.) = 3". - 1/4" Ø TAPCON_ANCHOR W/ 1 1/4" MIN. EMBEDMENT, AS MANUFACTURED BY ITW/BUILDEX, INC. (COMPONENT (22)), THRU 1" P.T. WOOD BUCK.
- (B) TO EXISTING A.S.T.M. C-90 CONCRETE BLOCK WALL. MIN. EDGE DISTANCE (E.D.) = 3". - 1/4" TAPCON ANCHOR W/ 1 1/4" MIN. EMBEDMENT, AS MANUFACTURED BY ITW/BUILDEX, INC. (COMPONENT (22)), THRU 1" P.T. WOOD BUCK.


- (C) TO EXISTING 2xP.T. WOOD BUCK. MIN. EDGE DISTANCE (E.D.) = 1".
- 1/4" TAPCON_ANCHOR W/ 1 1/2" MIN. EMBEDMENT, AS MANUFACTURED BY ITW/BUILDEX, INC. (COMPONENT (22)).
- (D) TO EXISTING MIN. 1/8" THICK ALUMINUM TUBE (6063-T5 ALLOY) MIN. EDGE DISTANCE (E.D.) = 1/2".
- 1/4"ø-14 TEK SCREW, AS MANUFACTURED BY ITW/BUILDEX, INC. (COMPONENT (22)), FULLY ENGAGED.
- (E) TO EXISTING MIN. 12 GAGE STEEL MEMBER (MIN A-653 GRADE 33 OR A-36) MIN. EDGE DISTANCE (E.D.) = 1/2".
- 1/4"ø-14 TEK SCREW, AS MANUFACTURED BY ITW/BUILDEX, INC. (COMPONENT (22)), FULLY ENGAGED.
- 10. PROVIDE 1/4" MAX. LOAD BEARING SHIM, WHEN ALLOWED BY THIS DRAWING.
- 11. DOORS INSTALLATION SHALL COMPLY WITH SPECS INDICATED IN THIS DRAWING PLUS ANY BUILDING AND ZONING REGULATIONS PROVIDED BY THE JURISDICTION WHERE PERMIT IS APPLIED TO.
- 12. ALL DOORS COMPONENT EDGES WHICH REMAIN IN CONTINUOUS CONTACT WITH THE BUILDING SHALL BE SEAL/CAULK TO PREVENT WIND/RAIN INTRUSION. CAULK AND SEAL ALL AROUND FULL LENGTH.
- PRODUCT MANUFACTURER'S LABEL SHALL BE LOCATED ON A READILY VISIBLE LOCATION AT PRODUCT IN ACCORDANCE WITH SECTION 1709.5 OF THE FLORIDA BUILDING CODE. ONE LABEL SHALL BE PLACED FOR EVERY OPENING.
- 14. (a) THIS P.A.D. PREPARED BY THIS ENGINEER IS GENERIC AND DOES NOT PROVIDE INFORMATION FOR A SITE SPECIFIC PROJECT; i.e. WHERE THE SITE CONDITIONS DEVIATE FROM THE P.A.D.
 - (a) CONTRACTOR TO BE RESPONSIBLE FOR THE SELECTION, PURCHASE AND INSTALLATION INCLUDING LIFE SAFETY OF THIS PRODUCT, BASED ON THIS P.A.D., PROVIDED HE/SHE DOES NOT DEVIATE FROM THE CONDITIONS DETAILED ON THIS DOCUMENT. CONSTRUCTION SAFETY AT SITE IS THE CONTRACTOR'S RESPONSIBILITY.
 - (b) THIS P.A.D. WILL BE CONSIDERED INVALID IF ALTERED BY ANY MEANS.

EB-0006719

WALTER A. TILLIT Jr. P.E. FLORIDA Lic. # 44167

P.E. SEAL/SIGNATURE/DATE

(c) ORIGINAL P.A.D. SHALL BEAR THE DATE AND ORIGINAL SEAL AND SIGNATURE OF THE PROFESSIONAL ENGINEER OF RECORD THAT PREPARED IT.

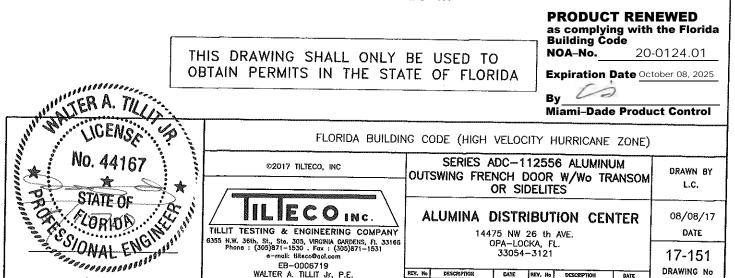

REY. No

DESCRIPTION


DATE REV. No

08/08/17


17-151

DRAWING No


SHEET 1 OF 24

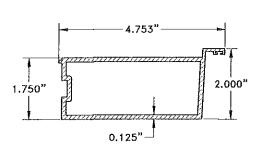


1) INACTIVE LOCK STILE

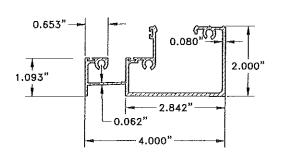


SILL & HEAD FRAME **O** DOOR & SIDELITE 6063-T6 ALLOY

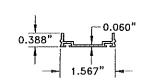


WEATHER STRIP ADAPTER

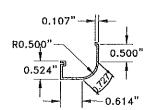


SCREW COVER FOR TRANSOM

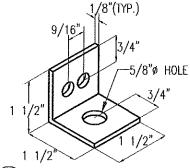


SHOOT BOLT GUIDE 6063-T6 ALUMINUM ANGLE

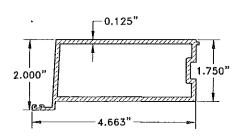


ACTIVE LOCK STILE 6063-T6 ALLOY

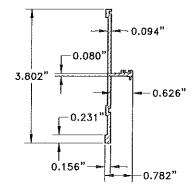

SIDELITE JAMB & TRANSOM INSERT 6063-T6 ALLOY

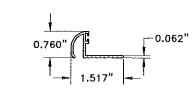


GLAZING BEAD 11 LAMINATED-INSULATED -13/6"

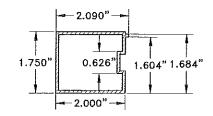


STILE FOR SIDELITE PANEL 6063-T6 ALLOY

COMPONENTS

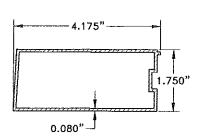


HINGE & LOCK STILE

0.875"

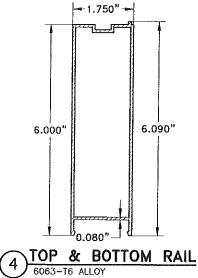




一0.062"

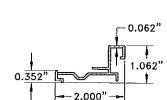


6063-T6 ALLOY


GLAZING ADAPTER FOR LAMINATED 8 LAMINATED-INSULATED GLASS 6063-T6 ALLOY

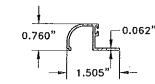

GLAZING BEAD FOR (12) LAMINATED GLASS- 7/16" 6063-T6 ALLOY

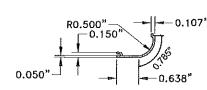

SCREW COVER FOR DOOR JAMB, (16) DOOR HEAD & SIDELITE JAMB 6063-T6 ALLOY

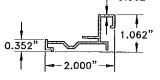

GLAZING ADAPTER SIDELITE & TRANSOM FOR LAMINATED & LAMINATED-INSULATED GLASS 9 LAWIT ... 6063-T6 ALLOY

4.000"


0.626"

-0.093"

0.094"

FRAME HEAD & JAMB @ SIDELITE & HEAD O DOOR


1.500"

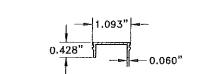


2.126"




HEAD & SILL COVER PLATE
6063-T6 ALLOY Miami-Dade Product Control

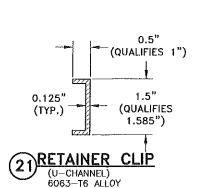

5" LONG

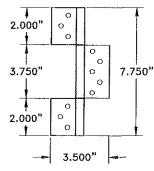

EXTRUDED HINGES
6063-T6 ALLOY

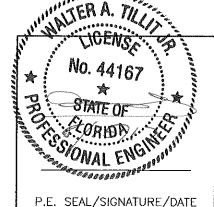

FLORIDA BUILDIN	IG CO	DDE (HIGH	VELOC	ITY H	IURRICANE	ZONE)	
©2017 TILTECO, INC	OUT	SWING FREI		OOR			DRAWN BY L.C.
TILLECOINC. TILLIT TESTING & ENGINEERING COMPANY	A	LUMINA [DISTR			NTER	08/08/17 DATE
8355 N.W. 36th. St., Ste. 305, VRGINA CARDENS, FI, 33166 Phone: (305)871-1530 Fev: (305)871-1531 e-mail: titleco@aol.com EB-0006719 WALTER A. TILLIT Jr. P.E.	REV. No	DESCRIPTION (33054-		DESCRIPTION	DATE	17-151 drawing no
FLORIDA Lic. # 44167	1 2	OLD 15-250	08/08/17	3			SHEET 2 OF 24

COMPONENT #	BILL OF MATERIALS		
1	DESCRIPTION INACTIVE LOCK STILE	DIMENSIONS/REMARKS	MATERIA
2	ACTIVE LOCK STILE	SEE SHEET 2	6063-T6
3	HINGE & LOCK STILE (SINGLE DOOR) & HINGE STILE (DOUBLE DOOR)	SEE SHEET 2	6063-T6
4	TOP & BOTTOM RAIL	SEE SHEET 2	6063-T6
5	FRAME HEAD & JAMB @ SIDELITE & HEAD @ DOOR	SEE SHEET 2	6063-T6
6	SILL & HEAD FRAME @ DOOR & SIDELITE	SEE SHEET 2	6063-T6
7	SIDELITE JAMB & TRANSOM INSERT	SEE SHEET 2 SEE SHEET 2	6063-T6
8	GLAZING ADAPTER DOOR FOR LAMINATED & LAMINATED-INSULATED GLASS	SEE SHEET 2	6063-T6
9	GLAZING ADAPTER SIDELITE & TRANSOM FOR LAMINATED & LAMINATED-INSULATED GLASS	SEE SHEET 2	6063-T6
10	WHEATHER STRIP ADAPTER	SEE SHEET 2	
11	GLAZING BEAD FOR LAMINATED-INSULATED GLASS-13/16"	SEE SHEET 2	6063-T6
12	GLAZING BEAD FOR LAMINATED GLASS-7/16"	SEE SHEET 2	6063-T6
13	HEAD AND SILL COVER PLATE	SEE SHEET 2	6063-T6
14	SCREW COVER FOR TRANSOM	SEE SHEET 2	6063-T6
15	STILE FOR SIDELITE PANEL	SEE SHEET 2	6063-T6 6063-T6
16	SCREW COVER FOR DOOR JAMB, DOOR HEAD & SIDELITE JAMB	SEE SHEET 2	6063-T6
17	#14 x 1 1/2" S.S. TEK SCREW 5" FROM JAMBS, BALANCE @ 12" O.C.	SIDELITE JAMB INSERT-TRANSOM INSERT & RETAINER CLIP SCREW	
18	#12 x 1" PAN HEAD S.S. TEK SCREW 6" FROM ENDS, BALANCE @ 7" O.C.	SIDELITE JAMB STILE (PANEL CONNECTION)	STEEL
	#14 x 2 1/2" H.H SCREW, 5" FROM JAMBS, BALANCE @ 12" O.C.	DOOR-SIDELITE-TRANSOM (FRAME ASSEMBLY) -180 Ksi TENSILE STRENGTH	STEEL
	#10 x 1" F.H. S.S. TEK SCREW @ 8" O.C.	GLAZING ADAPTER & FRAME HEAD/JAMB ASSEMBLY & HINGE/LOCK STILE	STEEL
	RETAINER CLIP		STEEL
22	TAPCON (ITW/BUILDEX) CONCRETE ANCHOR	AT DOOR PANEL, W/ (2) #14x3/4 TEK SCREWS TO STILES, JOINS RAILS W/ STILES +(35)	6063-T6
22A	TEK SCREW (ITW/BUILDEX)	1/4" Ø - SEE GENERAL NOTE 9 ON SHEET 1 1/4" Ø - SEE GENERAL NOTE 9 ON SHEET 1	STEEL
23	EXTRUDED HINGES	3 1/2" X 7 3/4" POWDER COATED W/ (6) #10-20x7/16" F.H. S.S. MS TO FRAME & W/ (5) #10-24x7/16" F.H. S.S. MS TO DOOR PANEL	STEEL 6063-T6
24	GLAZING BULB	0.250"x0.345" (ULTRAFAB)	
25	FIN SEAL PILE W/ PLASTIC	ULTRAFAB	VINYL
26		PRO-LON	ļ
	SHOOT BOLT	TOP & BOTTOM 3/8Ø x2" (2) REQ'D @ ACTIVE +(2) REQ'D @ INACTIVE, PENETRATE 2" MIN. INTO HD/SILL	FOAM
27A	SHOOT BOLT GUIDE	TOP & POTTOM SEE DETAIL OUTST OA 4.40% A 4.40%	STEEL
	1/4" DRIVE ROD TOP & BOTTOM	TOP & BOTTOM SEE DETAIL SHEET 24. 1 1/2" x 1 1/2" x 1/8" x 0'-1 1/2", 6063-T6 ALUMINUM ANGLE	ALUMINUM
		DEAD BOLT OTDIVE LEVEL COMPANY	ALUMINUM
29A i	2 POINT LOCK ACTIVE HANDLE W/ MECHANISM & RODS W/ INSTALLATION AT (2) MANUFACTURED BY ASSA ABLOY	DEAD BOLT STRIKE, LEVER COMPRESSION LOCK MANUFACTURED BY ASSA ABLOY) #8-32 x 7/16" SCREWS PER PANEL & TWIN BOLT LOCK W/ (1) #8-32 x 7/16" SCREW PER PANEL	
	STRUCTURAL SILICONE DOW CORNING 995	ALL AROUND GLASS	
31	NON STRUCTURAL SILICONE DOW CORNING CONTRACTORS CONCRETE SEALANT (CCS)	AS SHOWN	SILICONE SILICONE
	BUMPER SPHEAR		OII IOONE
33	FLUSH BOLT	HARDWARE ASSA ABLOY, 7 mm ROD W/ (2) # 8 x 1/2" SMS TO STILE	SILICONE PLATED STE
33A	TWO POINT LOCK SYSTEM WITH ACTIVATING LEVER TYPE HANDLE, KEY OPERATOR ON THE EXTERIOR, THUMB TURN ON THE INTERIOR WITH NO VISIBLE PRODUCT MARKINGS	38" FROM BOTTOM, ONLY USED AT ACTIVE DOOR IN DOUBLE DOORS OR AT SINGLE DOORS	PLATED STE
	SETTING BLOCK		F B B 11
		3/8"Ø, WI (4) S.S. SECURITM NUTS WILNYLON INSERT EACH DOOR PANEL (2 PER DOOR) 1/16" HIGH x 1 15/16" LONG THRESHOLD (2 PER DOOR)	E.P.D.M. STEEL
35	TOTAL TOTAL TIME TO THE TOTAL		

PRODUCT RENEWED
as complying with the Florida
Building Code
NOA-No. 20-0124.01

Expiration Date October 08, 2025

By Miami-Dade Product Control



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TILLIT TESTING & ENGINEERING COMPANY
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e-mail: tilleco@col.com
EB-0006719
WALTER A. TILLIT Jr. P.E.
FLORIDA Lic. # 44167

SERIES ADC-112556 ALUMINUM
OUTSWING FRENCH DOOR W/WO TRANSOM
OR SIDELITES

ALUMINA DISTRIBUTION CENTER
OPA-LOCKA, FL.
33054-3121

ALUMINA DISTRIBUTION CENTER
OPA-LOCKA, FL.
33054-3121


17-151
OPA-LOCKA, FL.
33054-3121


ARWING NO
DRAWN BY
L.C.

BEV. No DESCRIPTION DATE
OPA-LOCKA, FL.
33054-3121

TOLO 15-250
DRAWING NO
SHEET 3 0F 24

	BILL OF MATERIALS (CONT'D)							
COMPONENT #	DESCRIPTION	MATERIAL						
36)	7/16" NOMINAL LAMINATED GLASS W/ 3/16" H.S. GLASS +0.090" PVB INTERLAYER BY KURARAY AMERICA, INC. + 3/16" H.S. GLASS.	GLASS						
37)	13/16" INSULATED-LAMINATED GLASS W/ 3/16" TEMPERED GLASS OUT BOARD -1/4 ARGON SPACER + 3/16 H.S. + 0.090" PVB INTERLAYER BY KURARAY AMERICA, INC. + 3/16" H.S. INBOARD	GLASS						

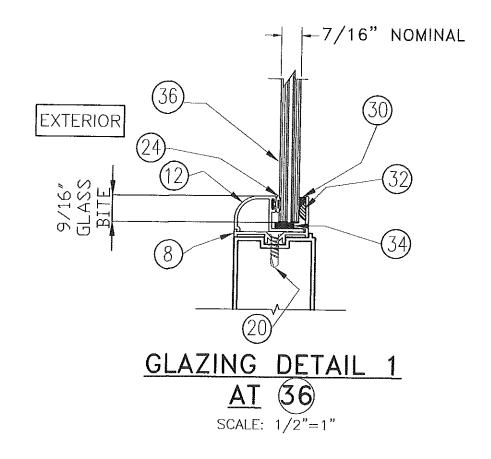


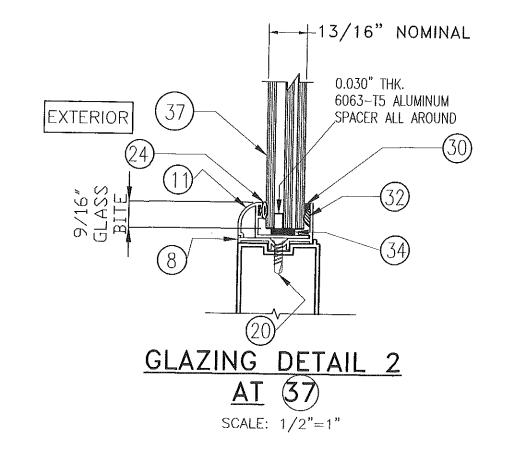


HARDWARE SCHEDULE REQ'D HARDWARE AT DOUBLE DOORS REQ'D HARDWARE OPTION #1 AT SINGLE DOORS AT ACTIVE DOOR AT INACTIVE DOOR TOP TOP / (33) (33) (33) воттом воттом: воттом : AT 38" FROM (33A) AT 38" FROM AT 38" FROM (33A) воттом : BOTTOM: воттом: TOP 29 TOP / (29A) 29 воттом : BOTTOM: воттом : 2 AT 38" FROM 29 AT 38" FROM AT 38" FROM 29 воттом : BOTTOM: BOTTOM:




PRODUCT RENEWED

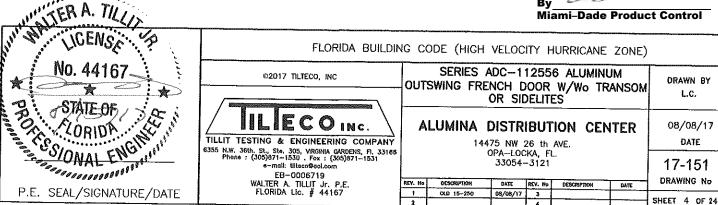


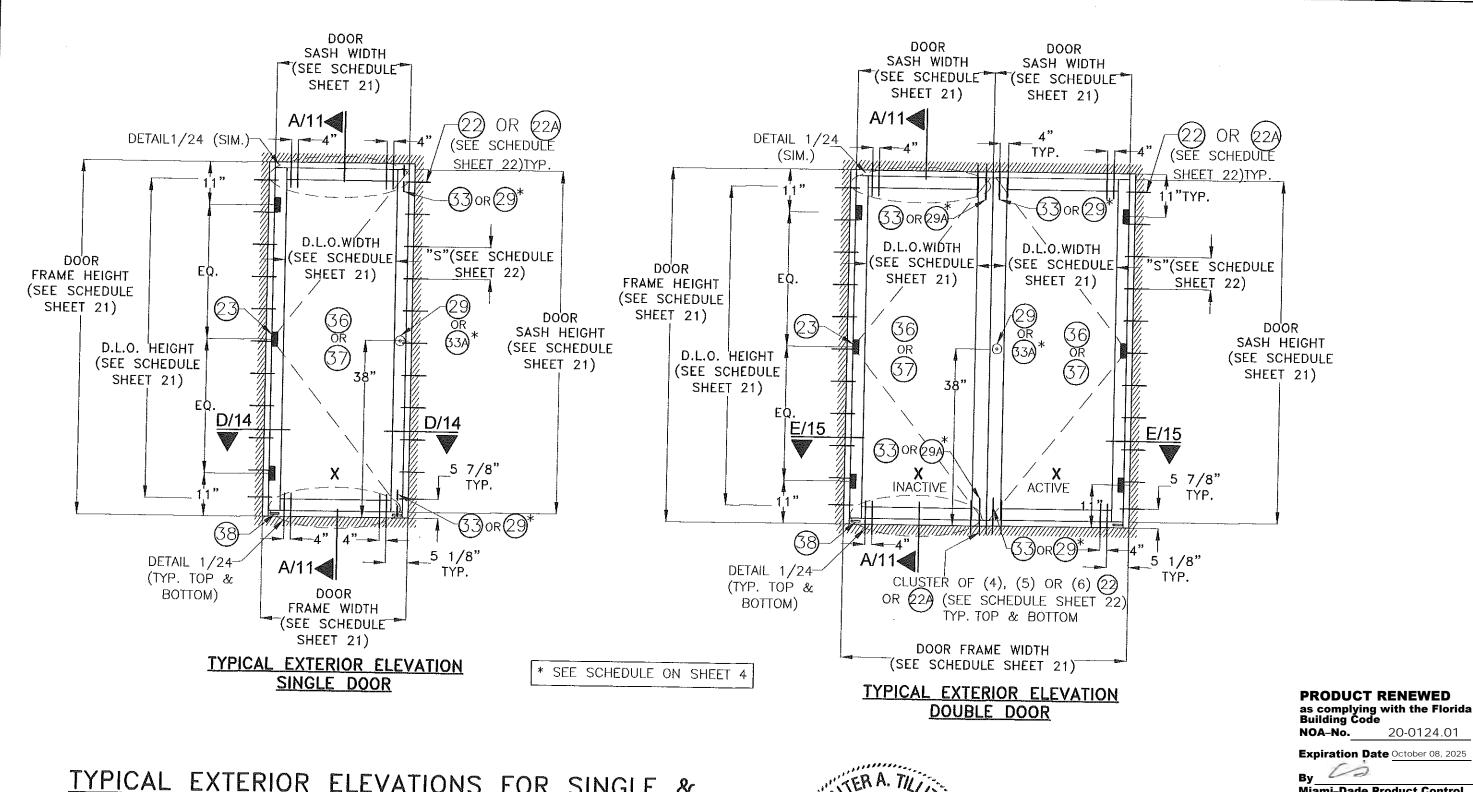


TYPICAL EXTERIOR ELEVATIONS FOR SINGLE & DOUBLE DOOR W/O TRANSOM NOR SIDELITES 3/8"=1'-0"

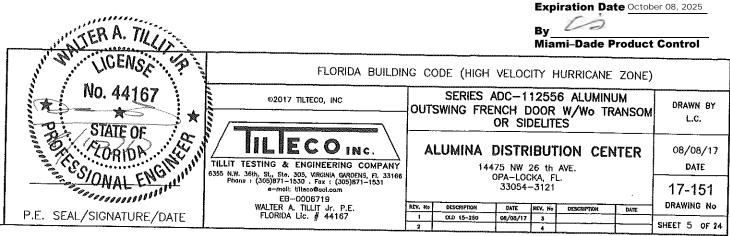

20-0124.01

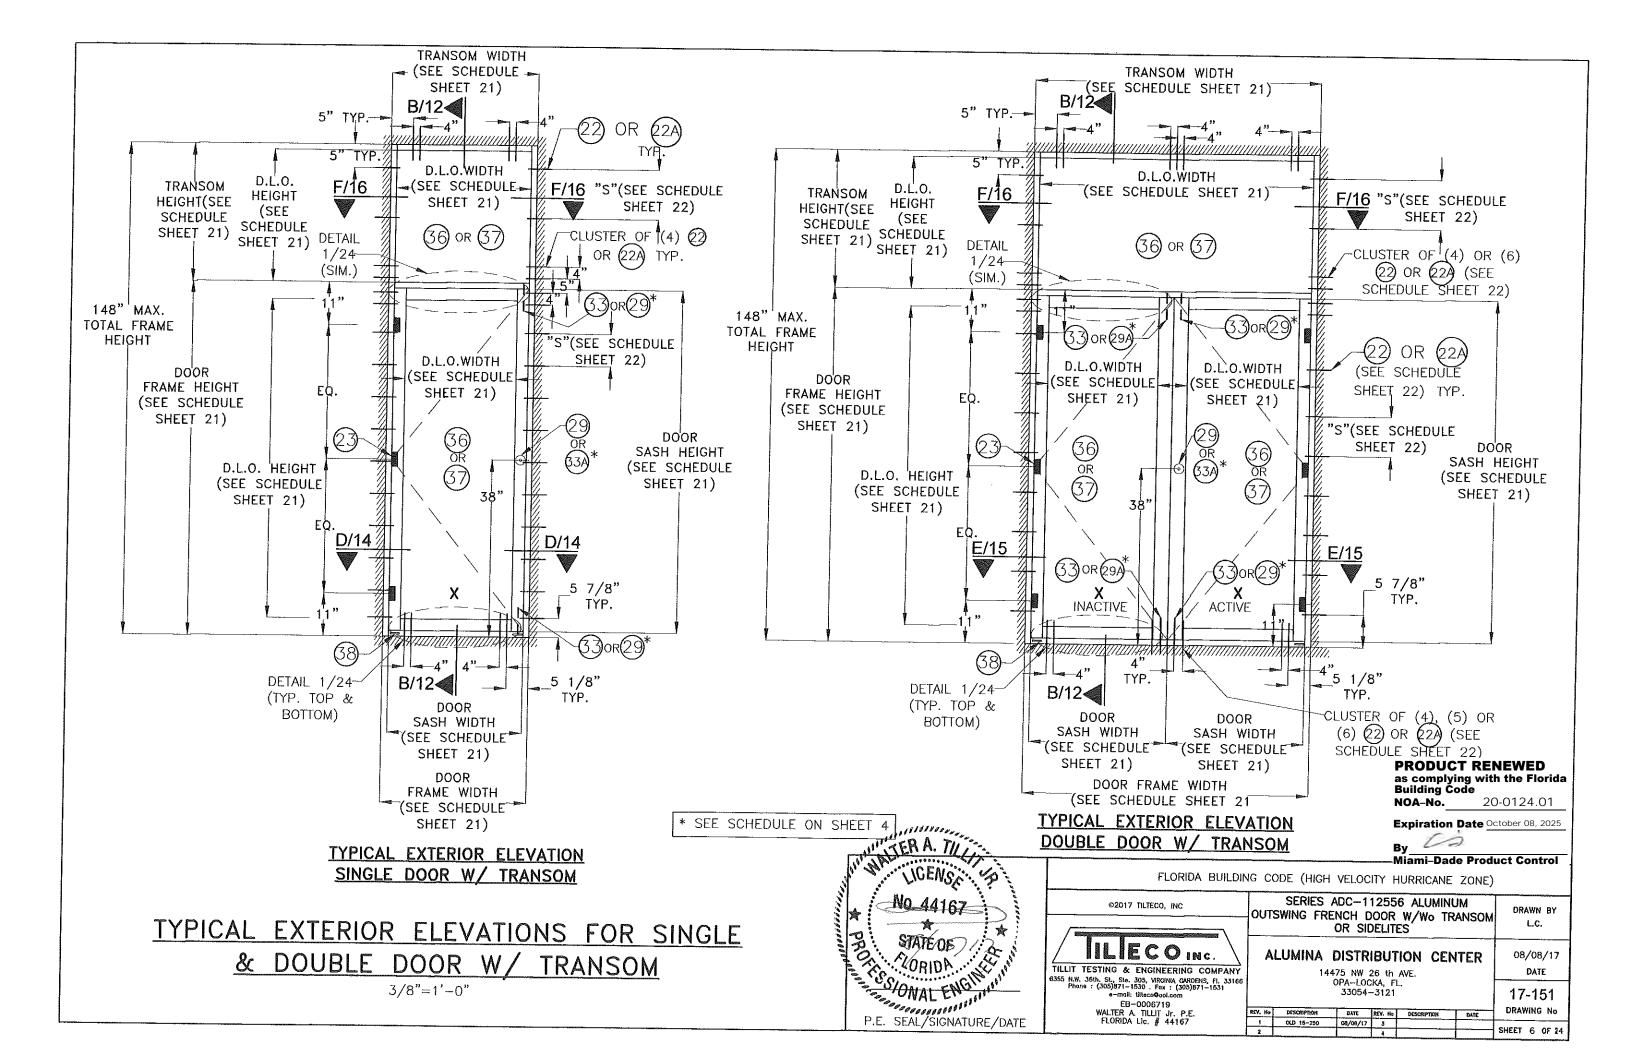

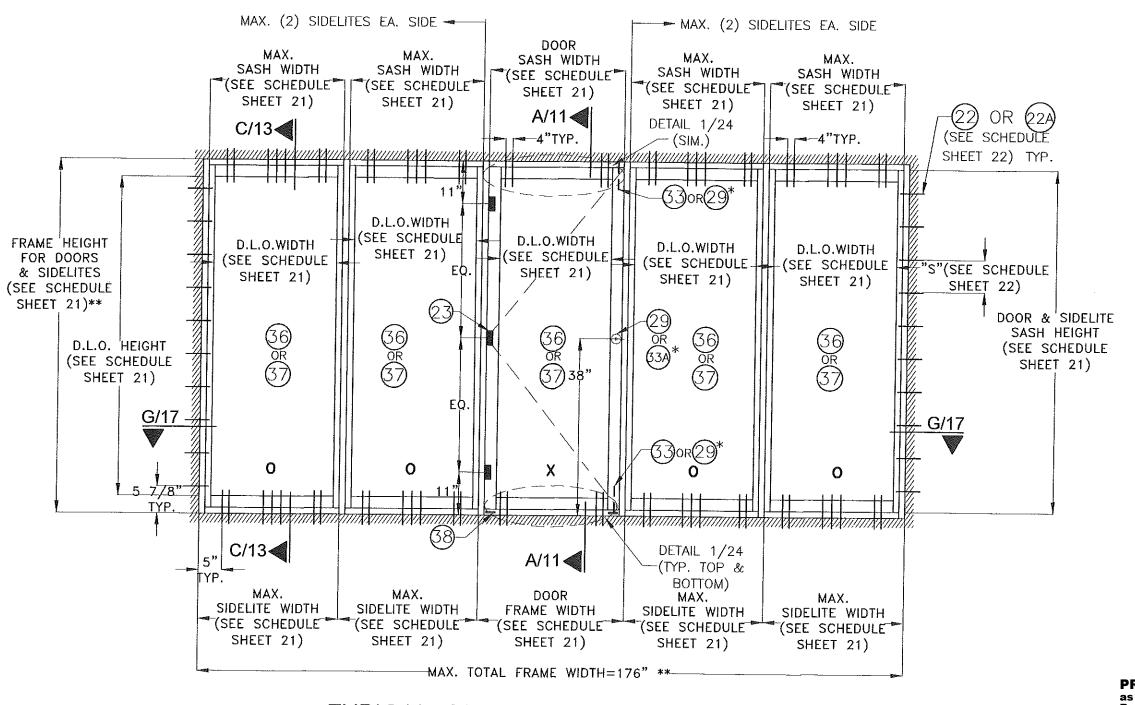

TYPICAL EXTERIOR ELEVATION OF SINGLE DOOR W/ SIDELITES

3/8"=1'-0"

PRODUCT RENEWED as complying with the Florida Building Code **NOA-No.** 20-0124.01

Expiration Date October 08, 2025

DRAWN BY

L.C.

08/08/17


DATE 17-151 DRAWING No

SHEET 7 OF 24

mi-Dade Product Control

- * SEE SCHEDULE ON SHEET 4
- ** MAX. TOTAL FRAME AREA SHALL NOT EXCEED 122.2 FT

-2	TER A. TILL						ami-Dade I		ŧ
	IN MARINICICENS	FLORIDA BUILDIN	IG C	DDE (HIGH	VELOC	ITY F	HURRICANE	ZONE))
	No. 44167 STATE OF ORIDA ONAL ENGINE P.E. SEAL /SIGNATURE (DATE	### 1520 PRC. TILLIT TESTING & ENGINEERING COMPANY ### 8355 N.W. 36th, St., Ste. 305, VIRGINIA GARDENS, Fl. 33166 Phone: (305)871-1530 . Fox: (305)871-1531 mail: Witecocol.com EB-0006719		SWING FREI (LUMINA [NCH D DR SIE	OOR DELIT 1BUT 26 th CKA, F	ES" FION CEN AVE. L.	ANSOM	
	P.E. SEAL/SIGNATURE/DATE	WALTER A. TILLIT Jr. P.E. FLORIDA LIC. # 44167	REV. Ha	DESCRIPTION OLD 15-250	DATE 08/08/17	REY. Ha	DESCRIPTION	DATE	
_,			2			4	F	!	

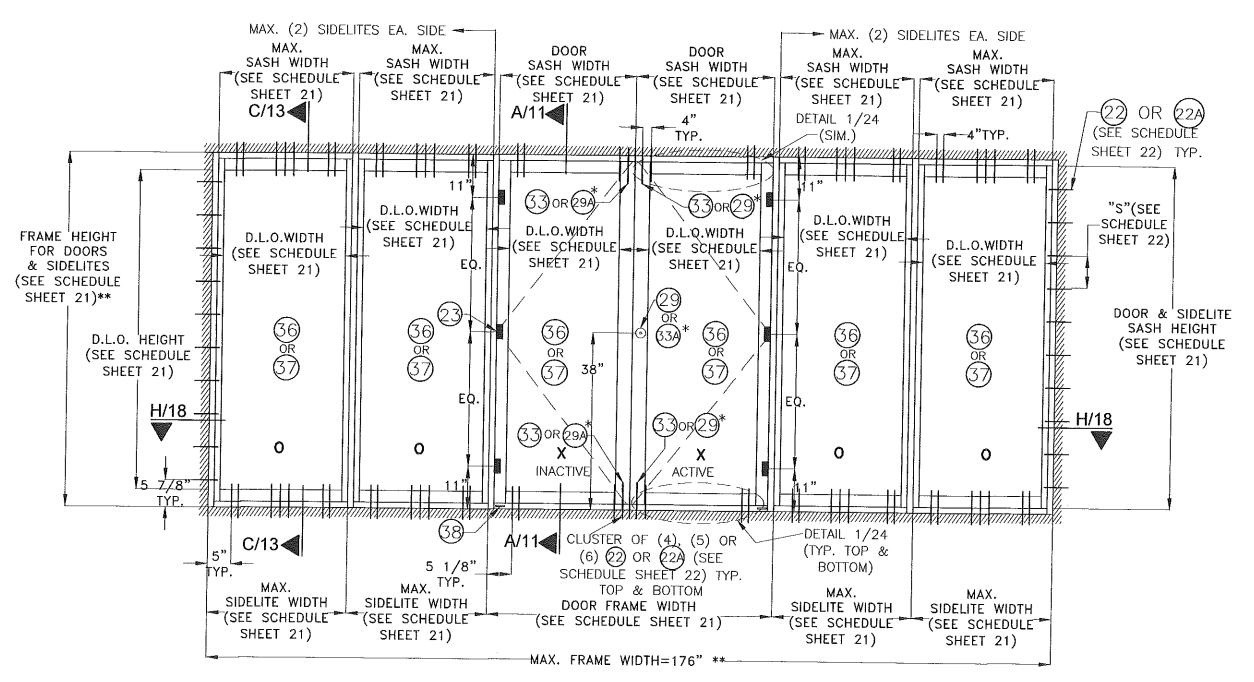

TYPICAL EXTERIOR ELEVATION OF DOUBLE DOOR W/ SIDELITES

3/8"=1'-0"

PRODUCT RENEWED as complying with the Florida Building Code

20-0124.01 NOA-No.

Expiration Date October 08, 2025

Miami-Dade Product Control


DRAWN BY

L.C.

08/08/17

* SEE SCHEDULE ON SHEET 4

** MAX. TOTAL FRAME AREA SHALL NOT EXCEED 122.2 FT

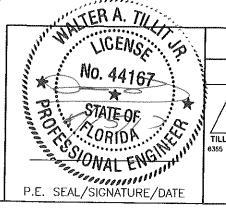


FLORIDA BUILDING CODE (HIGH VELOCITY HURRICANE ZONE) SERIES ADC-112556 ALUMINUM ©2017 TILTECO, INC OUTSWING FRENCH DOOR W/Wo TRANSOM IILIECO INC. TILLIT TESTING & ENGINEERING COMPANY 3355 N.W. 36th. St., Ste. 305, VIRGINIA GARDENS, Fl. 33166 Phone : (305)871--1530 . Fox : (305)871--1531

EB-0006719
WALTER A. TILLIT Jr. P.E.
FLORIDA Lic. # 44167

OR SIDELITES **ALUMINA DISTRIBUTION CENTER** 14475 NW 26 th AVE.

DATE OPA-LOCKA, FL. 33054-3121 17-151 DRAWING No DATE REV. No DESCRIPTA 08/08/17 3 SHEET 8 OF 24

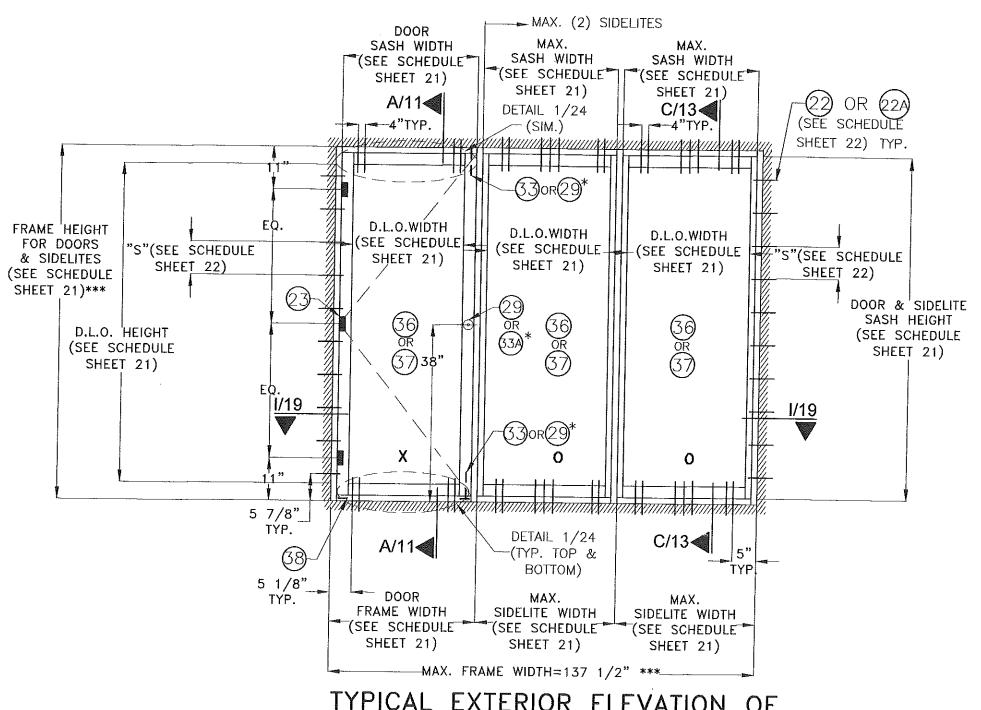

TYPICAL EXTERIOR ELEVATION OF SINGLE DOOR W/ SIDELITES **

3/8"=1'-0"

No. 44167 STATE OF ONAL ENGINE P.E. SEAL/SIGNATURE/DATE

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TILLIT TESTING & ENGINEERING COMPANY 6355 N.W. 36th. St., Ste. 305, VIRGINIA GARDENS, Fl. 33168 Phone: (305)871-1530 . Fax: (305)871-1531 e-mail: tilteco@aol.com

EB-0006719 WALTER A. TILLIT Jr. P.E. FLORIDA Lic. # 44167

FLORIDA BUILDING CODE (HIGH VELOCITY HURRICANE ZONE) SERIES ADC-112556 ALUMINUM DRAWN BY OUTSWING FRENCH DOOR W/Wo TRANSOM L.C. OR SIDELITES **ALUMINA DISTRIBUTION CENTER** 08/08/17 14475 NW 26 th AVE. OPA-LOCKA, FL. 33054-3121 DATE 17-151

08/08/17


DRAWING No

SHEET 9 OF 24

as complying with the Florida Building Code NOA-No. 20-0124.01 Expiration Date October 08, 2025 00

PRODUCT RENEWED


Miami-Dade Product Control

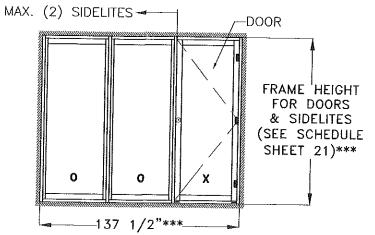



** QUALIFIES MIRROR CONFIGURATION TOO.

* SEE SCHEDULE ON SHEET 4


*** MAX. TOTAL FRAME AREA SHALL NOT EXCEED 95.5 FT2

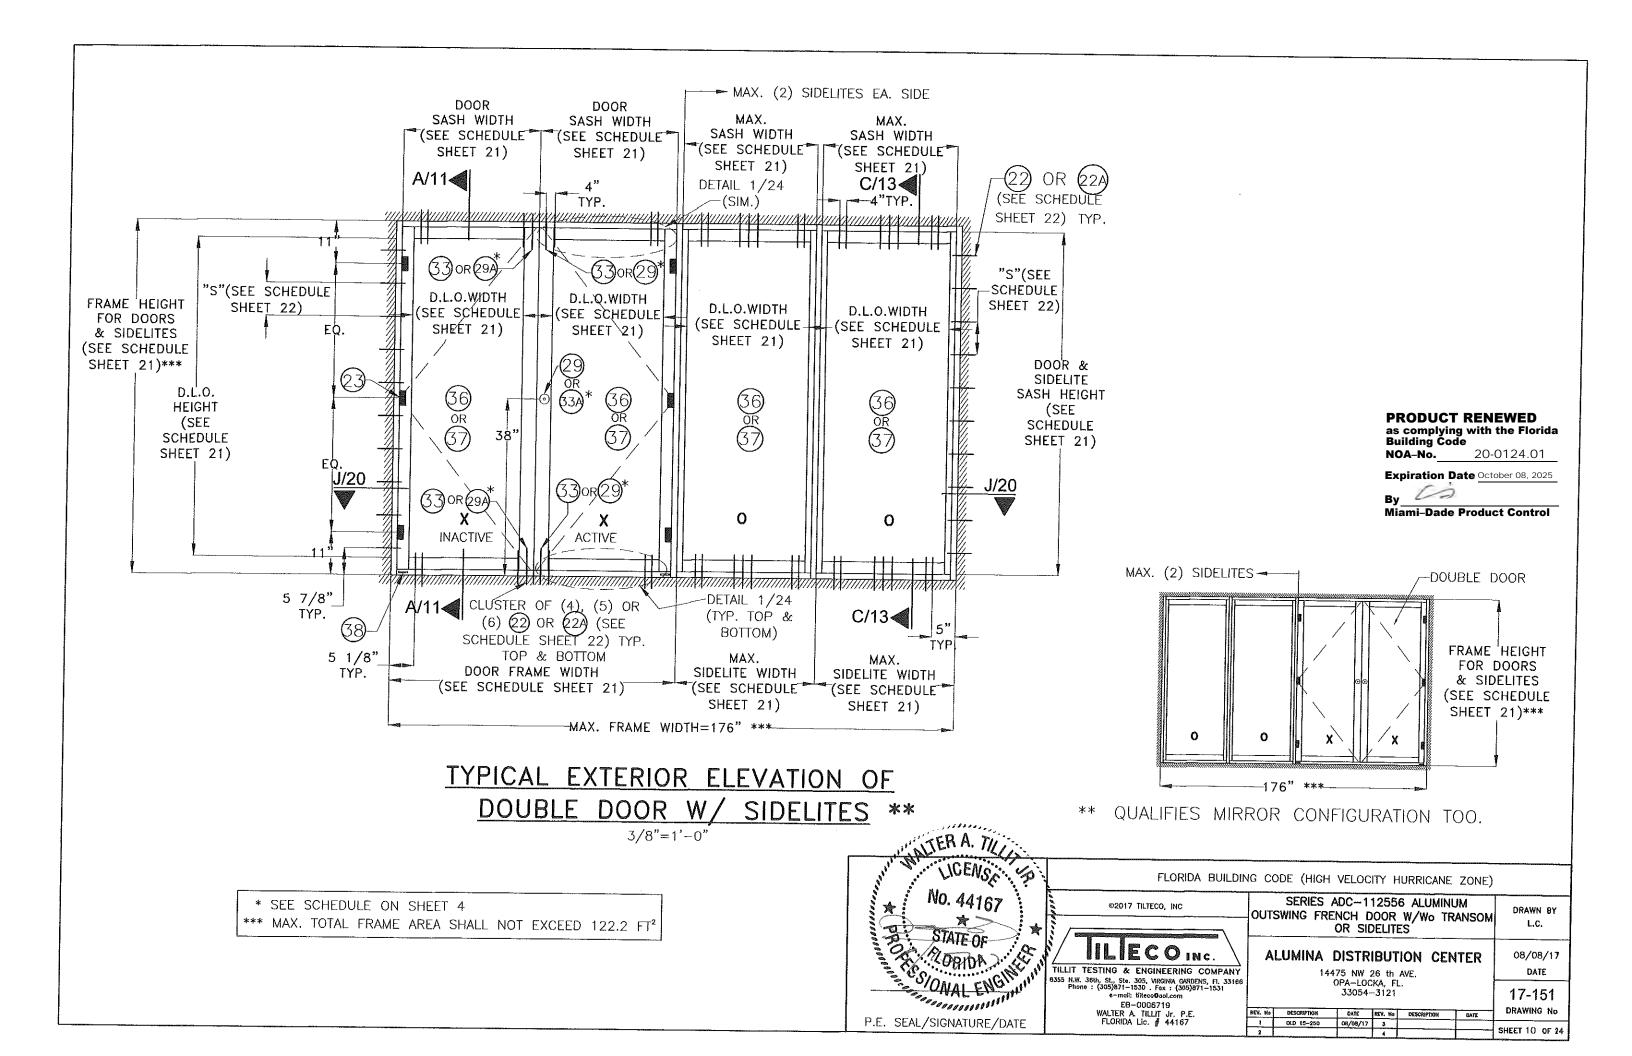

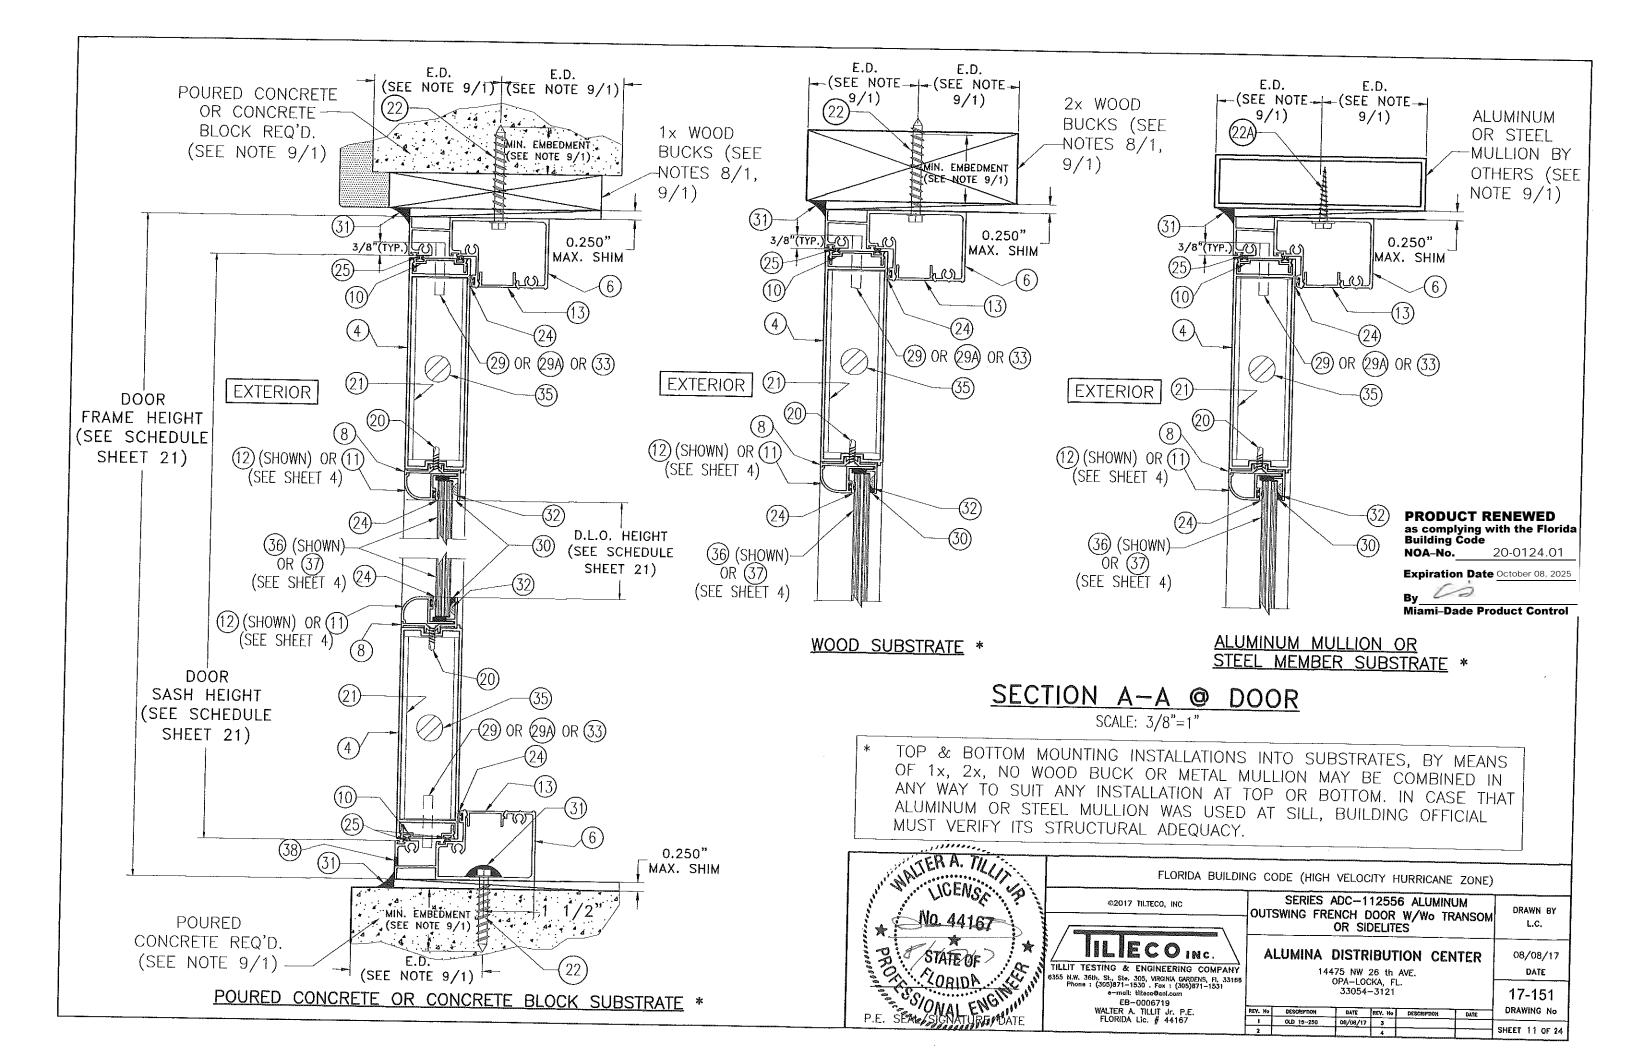

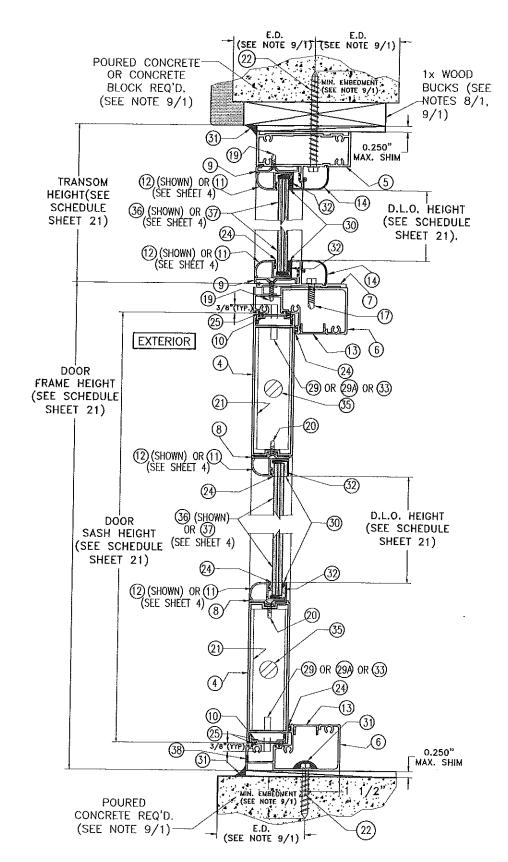

POURED CONCRETE OR **CONCRETE BLOCK SUBSTRATE ***

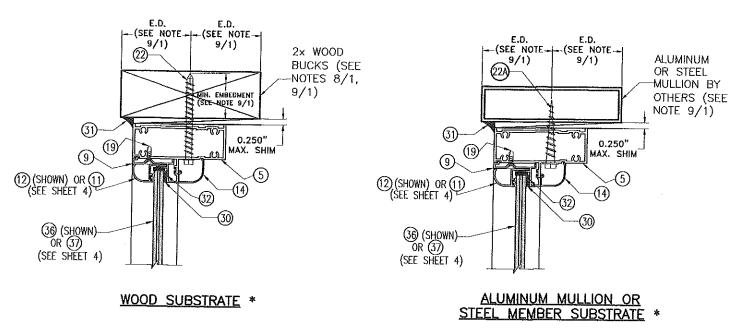


TOP & BOTTOM MOUNTING INSTALLATIONS INTO SUBSTRATES, BY MEANS OF $1\times$, $2\times$, NO WOOD BUCK OR METAL MULLION MAY BE COMBINED IN ANY WAY TO SUIT ANY INSTALLATION AT TOP OR BOTTOM. IN CASE THAT ALUMINUM OR STEEL MULLION WAS USED AT SILL, BUILDING OFFICIAL MUST VERIFY ITS STRUCTURAL ADEQUACY.

SECTION B-B @ DOOR W/ TRANSOM SCALE: 1/4"=1"

PRODUCT RENEWED as complying with the Florida Building Code NOA-No. 20-0124.01

Expiration Date October 08, 2025


Miami-Dade Product Control

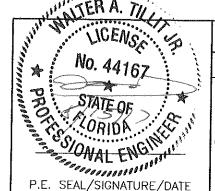



©2017 TILTECO, INC IILIECO INC. TILLIT TESTING & ENGINEERING COMPANY 6355 N.W. 36th. St., Ste. 305, VRGNIA GARDENS, Fl. 33161 Phone : (305)871-1530 . Fax : (305)871-1531 e-mail: titleco@col.com E8-0006719 WALTER A. TILLIT Jr. P.E. FLORIDA Lic. # 44167

FLORIDA BUILDIN	IG CODE (HIGH VELOCITY HURRICANE ZONE)	
ECO, INC	SERIES ADC-112556 ALUMINUM OUTSWING FRENCH DOOR W/Wo TRANSOM	DRAWN BY
	OR SIDELITES	L,C.
COINC.	ALUMINA DISTRIBUTION CENTER	08/08/17
INEERING COMPANY	14475 NW 26 th AVE.	DATE
VIRGINIA GARDENS, FI. 33166 Fax : (305)871—1531 p@gol.com	OPA-LOCKA, FL. 33054-3121	17-151

DRAWING No SHEET 12 OF 24

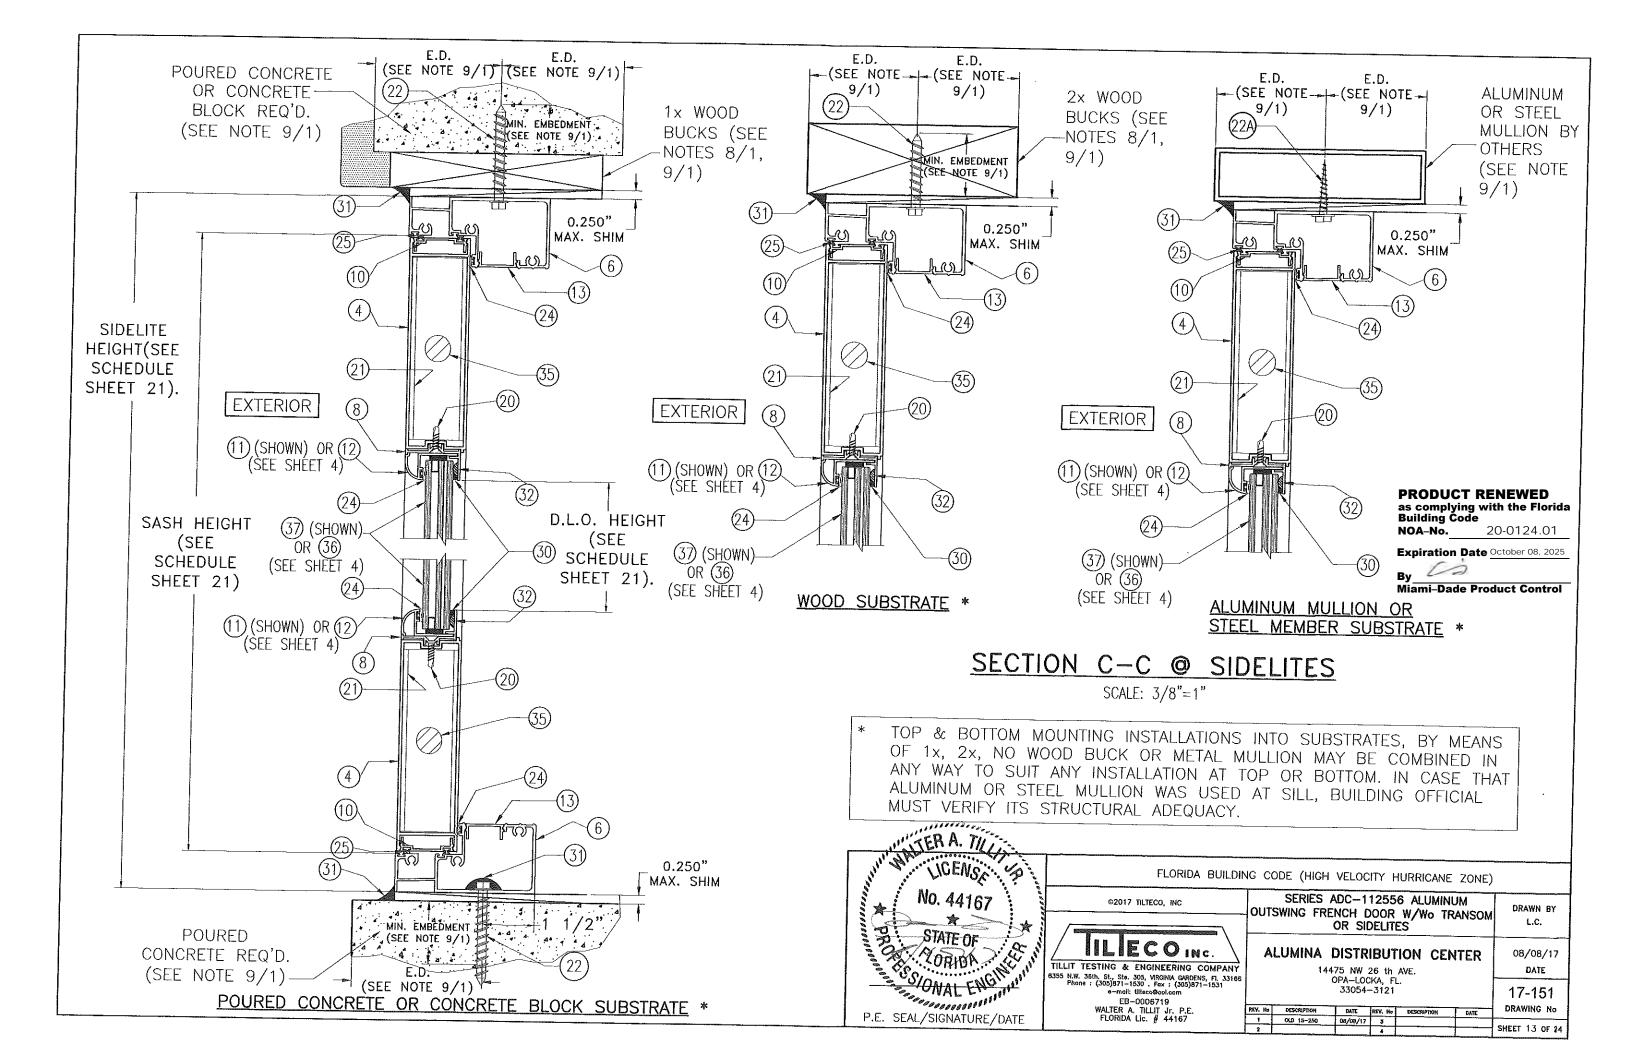

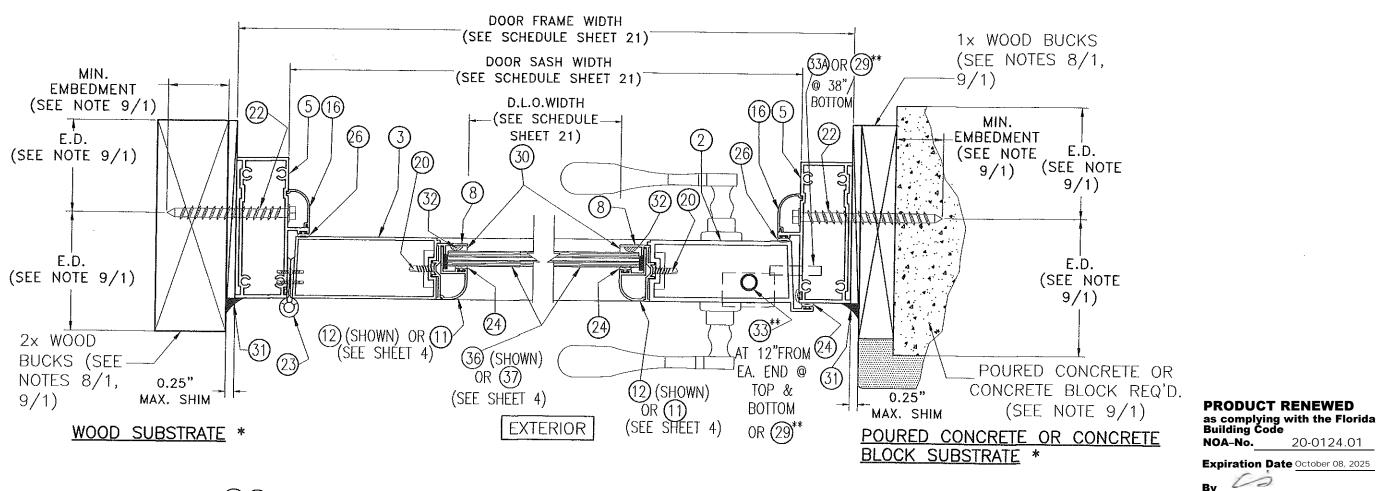

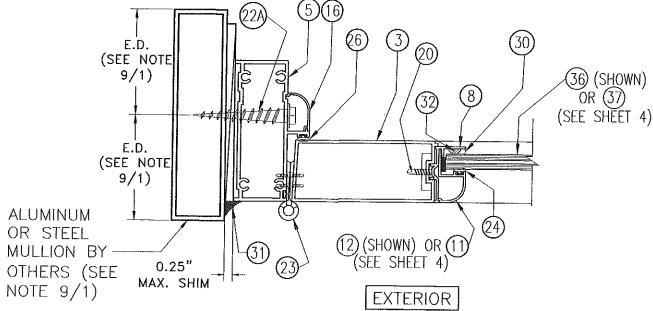


JAMB MOUNTING INSTALLATIONS INTO SUBSTRATES, BY MEANS OF 1x. 2x WOOD BUCK OR METAL MULLION MAY BE COMBINED IN ANY WAY TO SUIT ANY INSTALLATION AT JAMBS.

SEE SCHEDULE ON SHEET 4.

ALUMINUM MULLION OR STEEL MEMBER SUBSTRATE *

SECTION D-D @ SINGLE DOOR

SCALE: 3/8"=1"

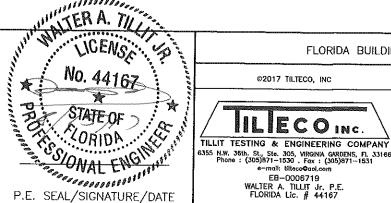

FLORIDA BUILDING CODE (HIGH VELOCITY HURRICANE ZONE)

SERIES ADC-112556 ALUMINUM OUTSWING FRENCH DOOR W/Wo TRANSOM OR SIDELITES

ALUMINA DISTRIBUTION CENTER

14475 NW 26 th AVE. OPA-LOCKA, FL. 33054-3121

17-151 DRAWING No SHEET 14 OF 24

DRAWN BY

L.C.


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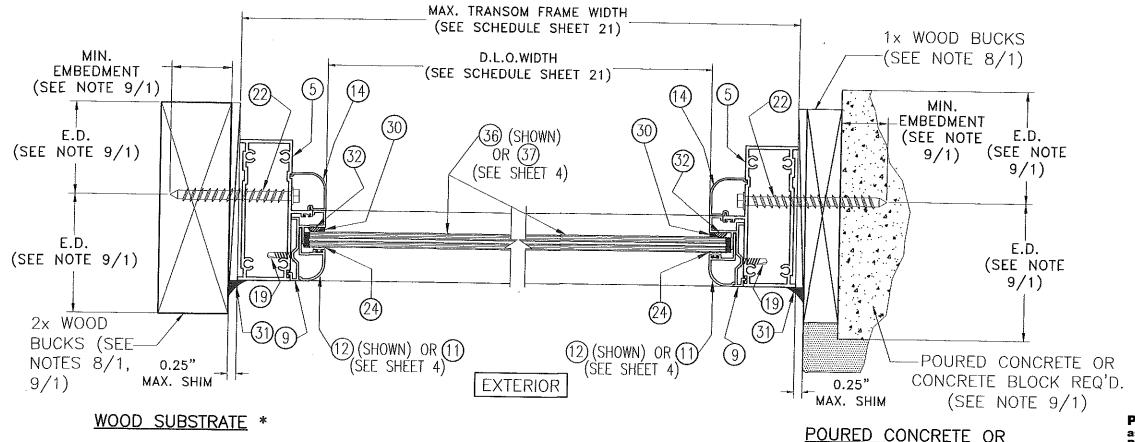
DATE

20-0124.01

Miami-Dade Product Control

DESCRIPTION



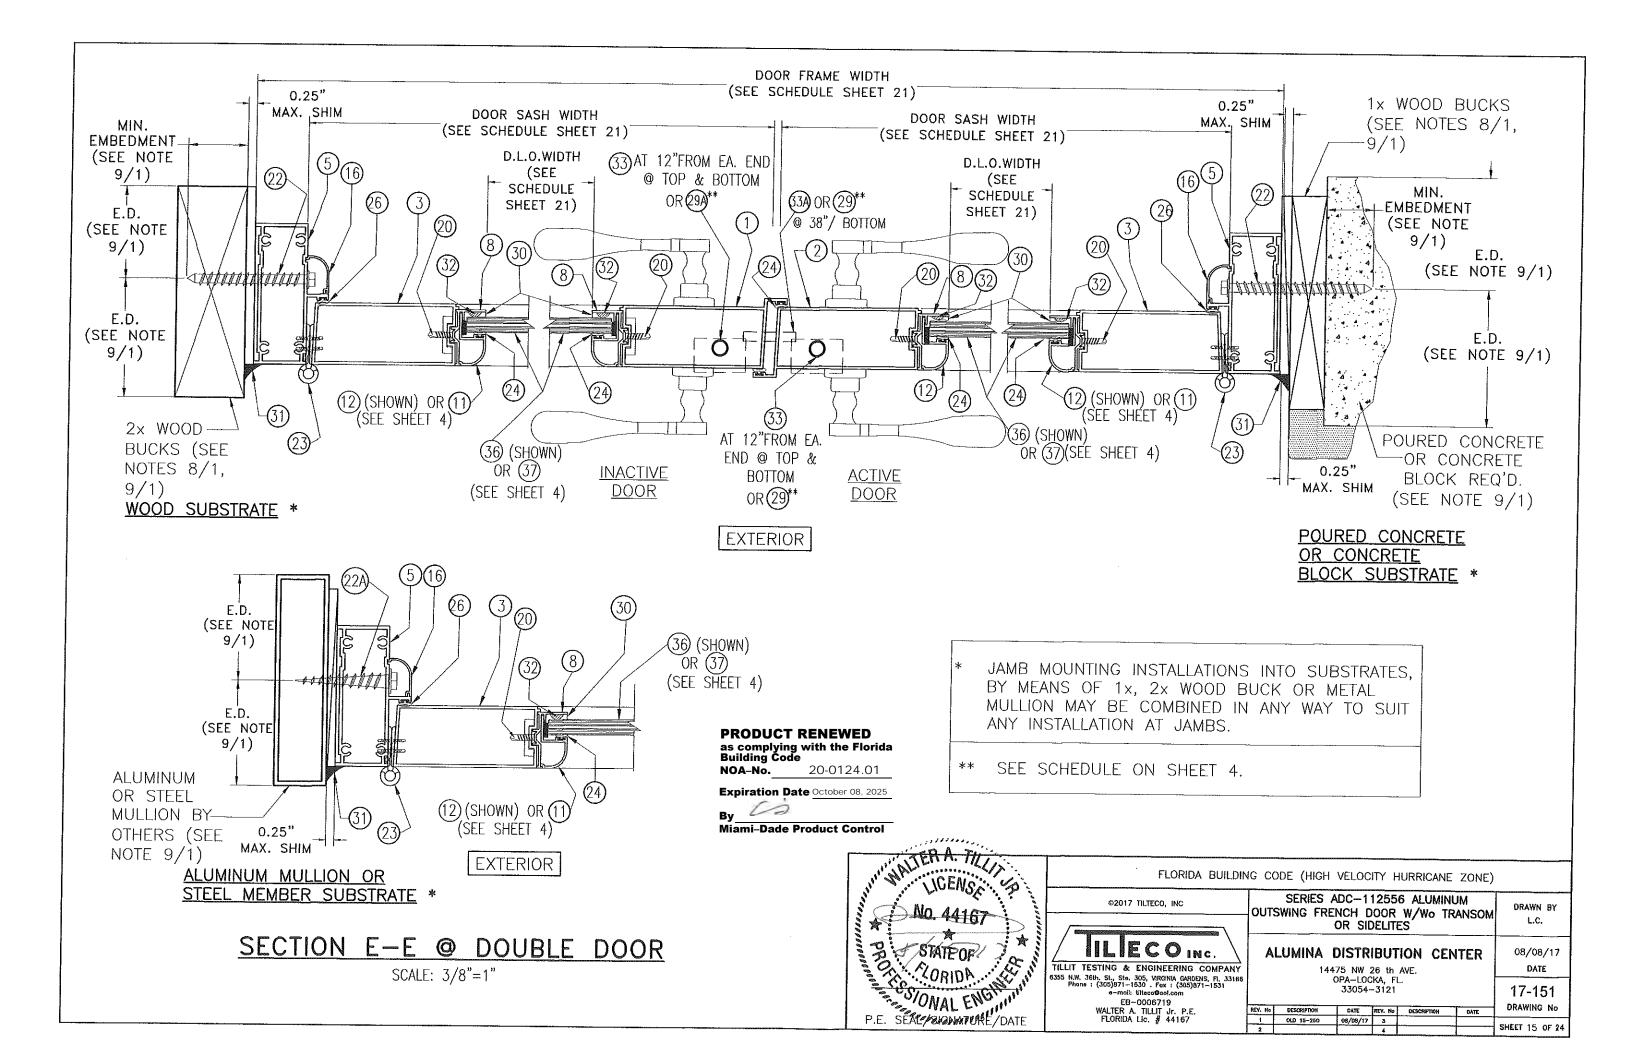

CONCRETE BLOCK SUBSTRATE *

PRODUCT RENEWED as complying with the Florida Building Code NOA-No.

20-0124.01

Expiration Date October 08, 2025

DRAWN BY

L.C.

08/08/17

DATE

17-151

DRAWING No


SHEET 16 OF 24


Miami-Dade Product Control

JAMB MOUNTING INSTALLATIONS INTO SUBSTRATES, BY MEANS OF 1x, 2x WOOD BUCK OR METAL MULLION MAY BE COMBINED IN ANY WAY TO SUIT ANY INSTALLATION AT JAMBS.


SECTION F-F @ TRANSOM


SCALE: 3/8"=1"

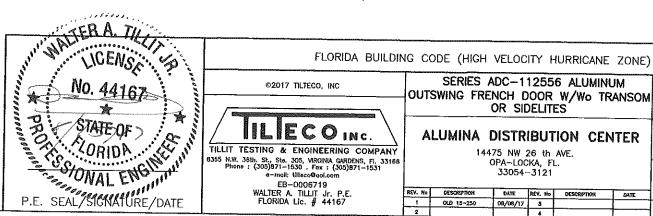

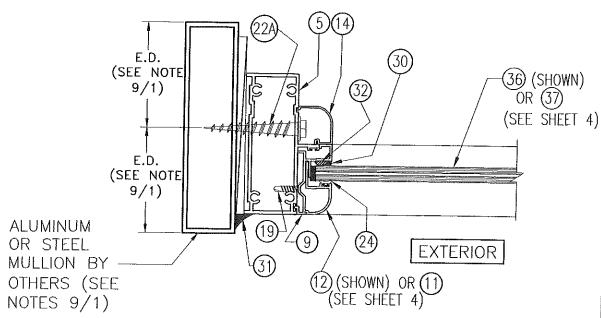

ALUMINUM MULLION OR STEEL MEMBER SUBSTRATE *

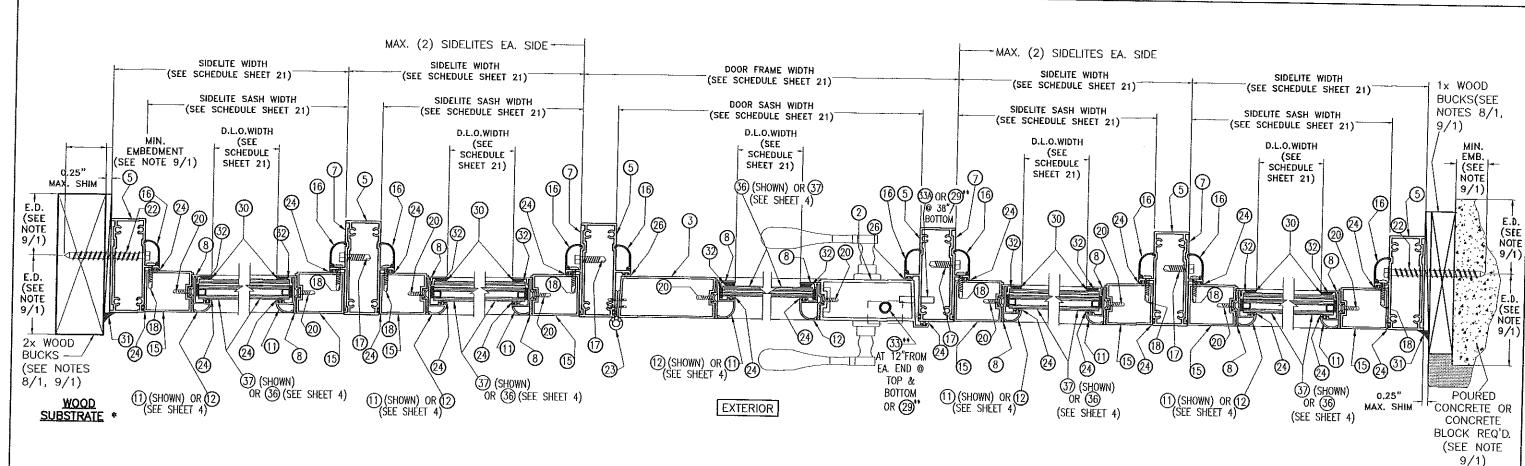

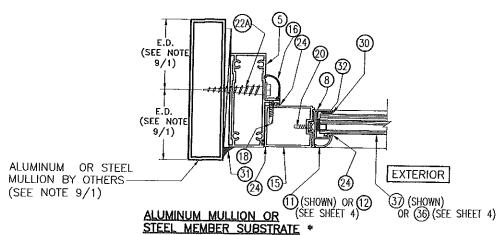

JAMB MOUNTING INSTALLATIONS INTO SUBSTRATES, BY MEANS OF 1x, 2x WOOD BUCK OR METAL MULLION MAY BE COMBINED IN ANY WAY TO SUIT ANY INSTALLATION AT JAMBS.

SEE SCHEDULE ON SHEET 4.


PRODUCT RENEWED as complying with the Florida Building Code NOA-No. 20-0124.01

POURED CONCRETE OR CONCRETE BLOCK SUBSTRATE *


Expiration Date October 08, 2025


Miami-Dade Product Control


SECTION G-G SINGLE DOOR SIDELITES SCALE: 1/4"=1"

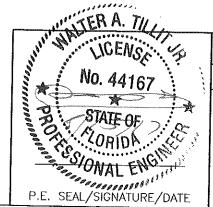

				W. 1				
	FLORIDA BUILDIN	NG C	ODE (HIGH	VELOC	ITY I	HURRICANE	ZONE)	
``. } }*	©2017 TILTECO, INC	оит	SWING FRE	ADC-1 NCH E OR SII	000R		UM KANSOM	DRAWN BY
, t	TILLIT TESTING & ENGINEERING COMPANY 0335 NW. 36th St. 205 MEDING CHERRY OF THE			75 NW	26 th	AVE.	ITER	08/08/17 Date
	6355 N.W. 36th, St., Ste. 305, VARGINIA CARDENS, FI. 33166 Phone: (306)871-1630 - Fox: (305)871-1631 e-mail: Ulleco G aol.com EB-0006719 WALTER A. TILLIT Jr. P.E.	REV. No	DESCRIPTION	33054- 0ATE		DESCRIPTION	DATE	17-151 DRAWING No
	FLORIDA Lic. # 44167	1 2	OLD 15-250	08/08/17	3			SHEET 17 OF 2

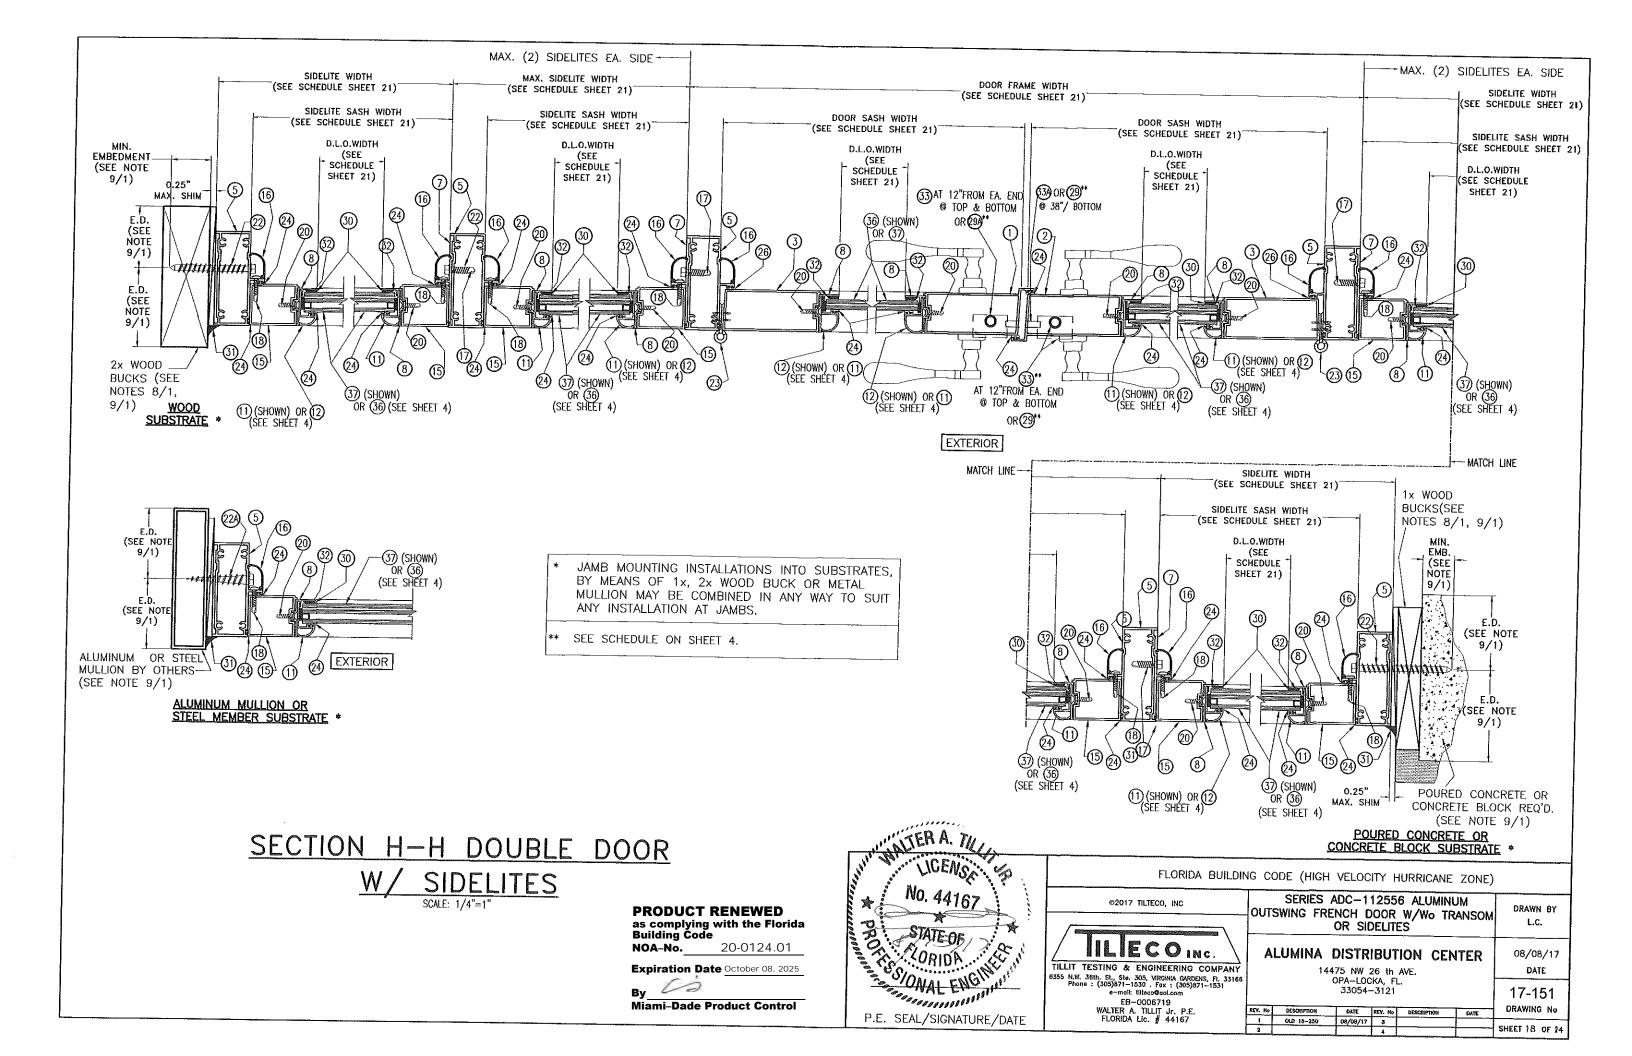

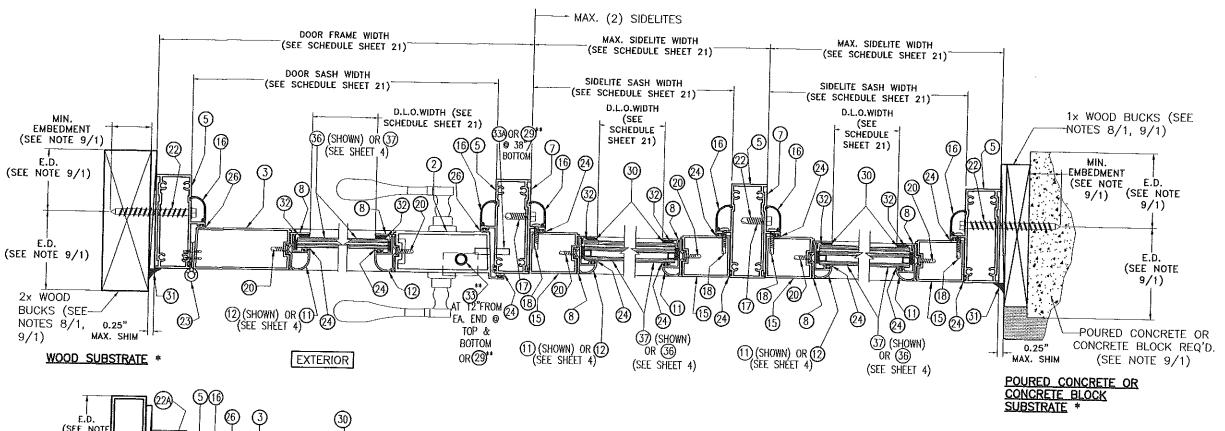

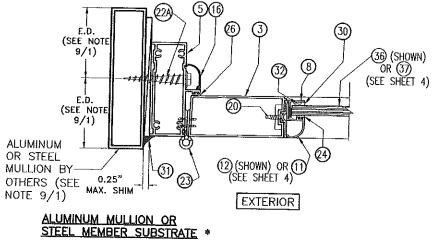

JAMB MOUNTING INSTALLATIONS INTO SUBSTRATES, BY MEANS OF 1x, 2x WOOD BUCK OR METAL MULLION MAY BE COMBINED IN ANY WAY TO SUIT ANY INSTALLATION AT JAMBS.

** SEE SCHEDULE ON SHEET 4.

SECTION I-I SINGLE DOOR SIDELITES SCALE: 1/4"=1"


PRODUCT RENEWED as complying with the Florida Building Code NOA-No. 20-0124.01

L.C.

DATE

Expiration Date October 08, 2025


00 Miami-Dade Product Control

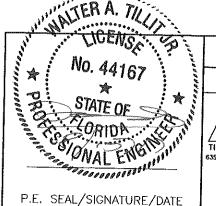


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FLORIDA BUILDING CODE (HIGH VELOCITY HURRICANE ZONE) SERIES ADC-112556 ALUMINUM DRAWN BY OUTSWING FRENCH DOOR W/Wo TRANSOM OR SIDELITES **ALUMINA DISTRIBUTION CENTER** 08/08/17 14475 NW 26 th AVE. OPA~LOCKA, FL. 33054-3121

17-151 DRAWING No DATE REV. Ho 08/08/17 3 SHEET 19 OF 24



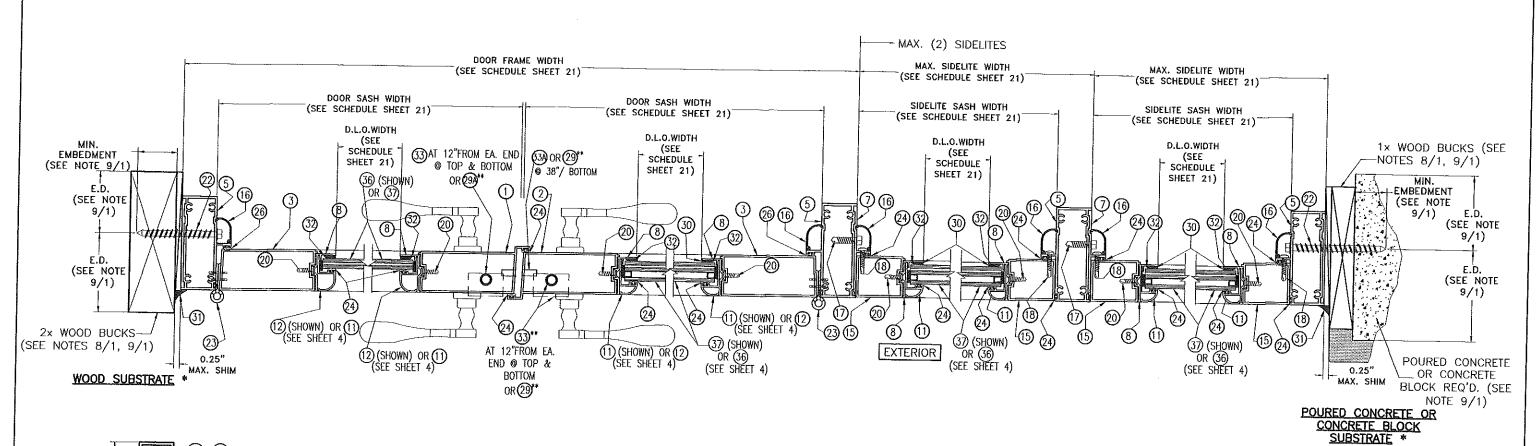

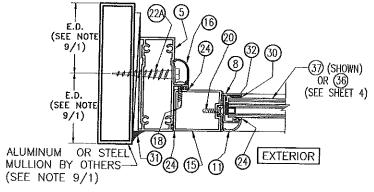ALUMINUM MULLION OR STEEL MEMBER SUBSTRATE *

- JAMB MOUNTING INSTALLATIONS INTO SUBSTRATES, BY MEANS OF 1x, 2x WOOD BUCK OR METAL MULLION MAY BE COMBINED IN ANY WAY TO SUIT ANY INSTALLATION AT JAMBS.
- SEE SCHEDULE ON SHEET 4.

PRODUCT RENEWED as complying with the Florida Building Code

NOA-No. 20-0124.01


Expiration Date October 08, 2025

DRAWING No

SHEET 20 OF 24

Miami-Dade Product Control

SECTION J-J DOUBLE DOOR SIDELITES SCALE: 1/4"=1"

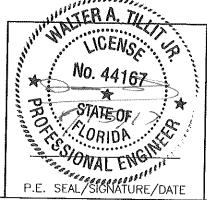

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SERIES ADC-112556 ALUMINUM DRAWN BY OUTSWING FRENCH DOOR W/Wo TRANSOM L.C. OR SIDELITES **ALUMINA DISTRIBUTION CENTER** 08/08/17 DATE 14475 NW 26 th AVE. OPA-LOCKA, FL. 33054-3121 17-151

> DESCRIPTION DATE REV. Ho OLD 15-250 08/08/17 3

SINGLE & DOUBLE DOOR SCHEDULE ONLY VALID FOR DOORS W/O TRANSOM AND W/O SIDELITE

MAX. ASD DESIGN PRESSURE	MAX. FRAME	DOOR WIDTH	MAX. DOOR FRAME	MAX. DOOR SASH	MAX. DOOR	MAX. D.L.O.	MAX. D.L.O.	
RATING	AT SINGLE DOOR	AT DOUBLE DOOR	HEIGHT	WIDTH *	SASH HEIGHT	WIDTH	HEIGHT	
+45, -45 psf	3'-5 1/2"	6'-8"	10'-0"	3'-2 1/2"	9'-9 1/2"	2'-4"	8'-8"	
+49, -49 psf	3'-5 1/2"	6'-8"	9'-8"	3'-2 1/2"	9'-5 1/2"	2'-4"	8'-4"	
+54, -54 psf	3'-5 1/2"	6'-8"	9'-4"	3'-2 1/2"	9'-1 1/2"	2'-4"	8'-0"	
+57, -57 psf	3'-5 1/2"	6'-8"	9'-0"	3'-2 1/2"	8'-9 1/2"	2'-4"	7'-8"	
+60, -60 psf	3'-5 1/2"	6'~8"	8'-8"	3'-2 1/2"	8'-5 1/2"	2'-4"	7'-4"	
+70, -70 psf	3'-5 1/2"	6'-8"	8'-4"	3'-2 1/2"	7'-7 5/8"	2'-4"	7'-0"	

^{*} DOOR SASH WIDTHS MAY BE DIFFERENT FROM EACH OTHER WHEN DOUBLE DOORS ARE USED.


SINGLE & DOUBLE DOOR SCHEDULE VALID FOR DOORS W/ TRANSOM OR W/ SIDELITE

	TO THE TOTAL PROPERTY OF THE P								
MAX. ASD DESIGN PRESSURE RATING +70, -70 psf	MAX. FRAME WIDTH	MAX. FRAME HEIGHT	MAX. SASH WIDTH	MAX. SASH HEIGHT	MAX. D.L.O. WIDTH	MAX. D.L.O. HEIGHT			
AT SINGLE DOOR	3'-5 1/2"	8'-4"	3'-2 1/2"	7'-7 5/8"	2'-4"	7'-0"			
AT DOUBLE DOOR	6'-8"	8'-4"	3'-2 1/2"	7'-7 5/8"	2'-4"	7'-0"			
AT SIDELITE	4'-0"	8'-4"	3'-10 1/2"	7'-7 5/8"	3'-4"	7'-0"			
AT SINGLE DOOR TRANSOM	3'-5 1/2"	4'-0"		_	3'-0 1/2"	3'-7"			
AT DOUBLE DOOR TRANSOM	6'-8"	4'-0"		_	6'-3"	3'-7"			

PRODUCT RENEWED as complying with the Florida Building Code **NOA-No.** 20-0124.01

Expiration Date October 08, 2025

Miami-Dade Product Control

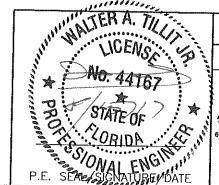

FLORIDA BUILDING CODE (HIGH VELOCITY HURRICANE ZONE) @2017 TILTECO, INC

TILLIT TESTING & ENGINEERING COMPANY 6355 NW. 36th. St., Ste. 305, VIRGINA GARDENS, FI. 33166
Phone: (305)871–1530 . Fax: (305)871–1531

-mail: titleco9aol.com

EB-0006719

WALTER A. TILLIT Jr. P.E.
FLORIDA Lic. # 44167

	SERIES ADC-112556 ALUMINUM OUTSWING FRENCH DOOR W/Wo TRANSOM OR SIDELITES	DRAWN BY L.C.
ļ.	ALUMINA DISTRIBUTION CENTER 14475 NW 26 th AVE.	08/08/17 DATE
6	OPA-LOCKA, FL.	4 - 4 - 4


33054-3121

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17-151 DRAWING No SHEET 21 OF 24


REQ'D NUMBER OF ANCHORS & CORRESPONDING ASD DESIGN PRESSURE RATING AT HEAD/SILL: CLUSTER OF ANCHORS AT DOUBLE DOOR, AT MEETING STILES *

THE THE STATE OF T					
ASD DESIGN PRESSURE RATING	MAX. DOOR FRAME WIDTH	MAX. DOOR FRAME HEIGHT	SUBSTRATE CONCRETE, BLOCK, WOOD, ALUM., STEEL		
+45, -45 psf	6'-8"	8'-4"	4 ANCHORS		
+45, -45 psf	6'-8"	10'-0"	5 ANCHORS		
+49, -49 psf	6'-8"	9'-8"	5 ANCHORS		
+54, -54 psf	6'-8"	9'-4"	6 ANCHORS		
+57, -57 psf	6'-8"	9'-0"	6 ANCHORS		
+60, -60 psf	6'-8"	8'-8"	6 ANCHORS		
+70, -70 psf	6'-8"	8'-4"	6 ANCHORS		

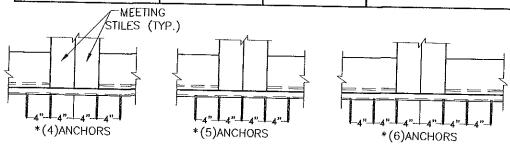

REQ'D NUMBER OF ANCHORS AT CLUSTER OF ANCHORS AT ENDS OF TRANSOM BAR WITH DOUBLE DOOR & CORRESPONDING ASD DESIGN PRESSURE RATING **

	T			SE SECTOR LIVE OF THE				
ASD DESIGN PRESSURE RATING	MAX. TRANSOM WIDTH	MAX. DOOR FRAME HEIGHT	TRANSOM HEIGHT	SUBSTRATE CONCRETE, BLOCK, WOOD, ALUM., STEEL				
			2'-0"	4 ANCHORS				
+45, -45 psf	6'-8"	8'-4"	3'-0"	4 ANCHORS				
		- '	4'-0"	4 ANCHORS				
			2'-0"	4 ANCHORS				
+55, -55 psf	6'-8"	8'-4"	8'-4"	3'-0"	4 ANCHORS			
		, l	4'-0"	6 ANCHORS				
			2'-0"					
+70, -70 psf	6'-8"	8'-4"	3'-0"	4 ANCHORS				
,		O 7	4'-0"	4 ANCHORS				
	<u> </u>		4 -U	6 ANCHORS				

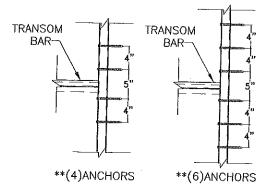

PRODUCT RENEWED as complying with the Florida Building Code

NOA-No. 20-0124.01

Expiration Date October 08, 2025


Miami-Dade Product Control


MAXIMUM ANCHOR SPACING "S" & CORRESPONDING ASD DESIGN PRESSURE RATING SCHEDULE AT JAMBS OF DOOR, SIDELITE & TRANSOM

		AL DAAL JIDEL	<u> </u>
SUBSTRATE	ANCHOR TYPE	A.S.D. DESIGN PRESSURE RATING (psf)	"S"
CONCRETE	CONCRETE 1/4"Ø ITW/BUILDEX TAPCON ANCHOR (22)		11" O.C.
BLOCK	1/4"ø ITW/BUILDEX TAPCON ANCHOR (22)	+70.0, -70.0	11" O.C.
WOOD	1/4"ø ITW/BUILDEX TAPCON ANCHOR (22)	+70.0, -70.0	11" O.C.
ALUMINUM TUBE OR STEEL MEMBER	1/4"ø-14 ITW/BUILDEX TEK SCREW (22)	+70.0, -70.0	11" O.C.

REQ'D NUMBER OF ANCHORS AT HEAD & SILL: CLUSTER OF ANCHORS AT SIDELITE & DOOR JAMB MULLIONS & CORRESPONDING ASD DESIGN PRESSURE RATING ***

ASD DESIGN	SUBSTRATE
PRESSURE RATING	CONCRETE, BLOCK, WOOD, ALUM., STEEL
UP TO +67.5, -67.5 psf	4 ANCHORS
> +67.5, -67.5 psf UP TO +70, -70 psf	6 ANCHORS

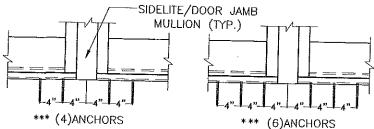

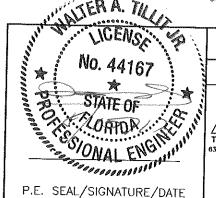

FLORIDA BUILDING CODE (HIGH VELOCITY HURRICANE ZONE)


©2017 TILTECO, INC OUTSWING FRENCH DOOR W/Wo TRANSOM ILIECO INC. TILLIT TESTING & ENGINEERING COMPANY 6355 N.W. 36th. St., Ste. 305, VIRGINIA GARDENS, Fl. 33166 Phone: (305)871-1530 . Fex: (305)871-1531 e-mail: Ulleco@aol.com EB-0006719 WALTER A. TILLIT Jr. P.E. FLORIDA Lic. # 44167


L.C. OR SIDELITES **ALUMINA DISTRIBUTION CENTER** 08/08/17 14475 NW 26 th AVE. DATE OPA-LOCKA, FL. 33054-3121 17-151


DRAWN BY

DRAWING No 08/08/17 3 SHEET 22 OF 14

SERIES ADC-112556 ALUMINUM

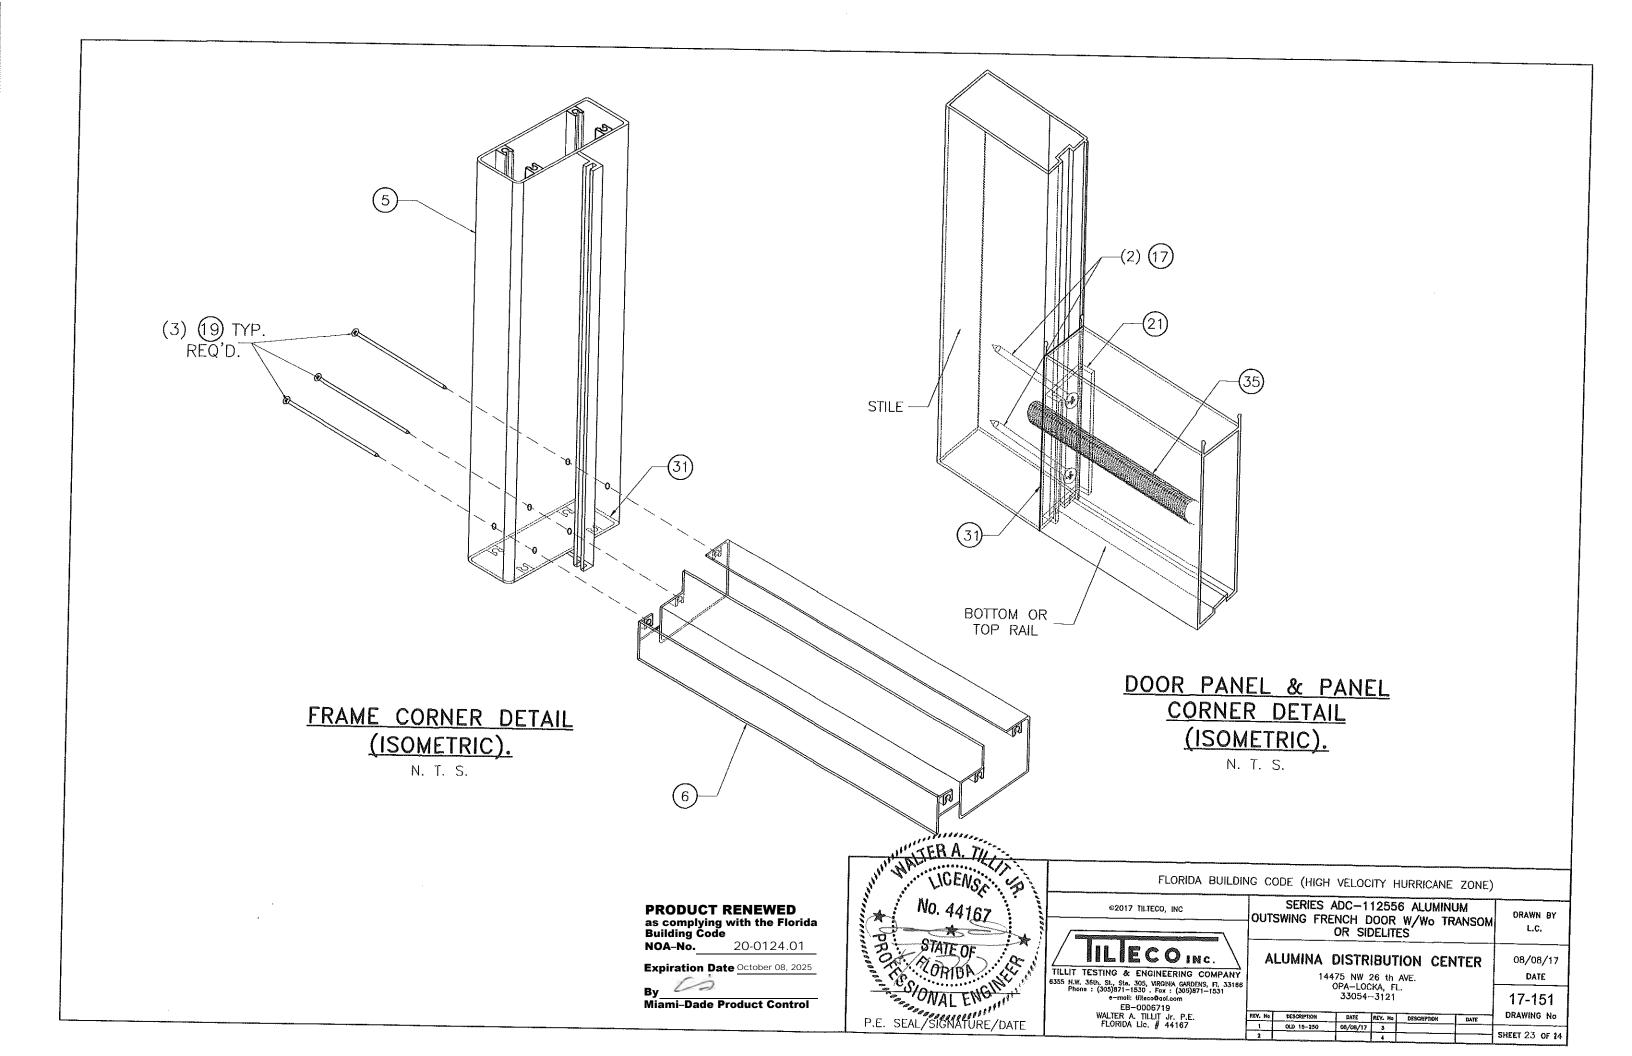

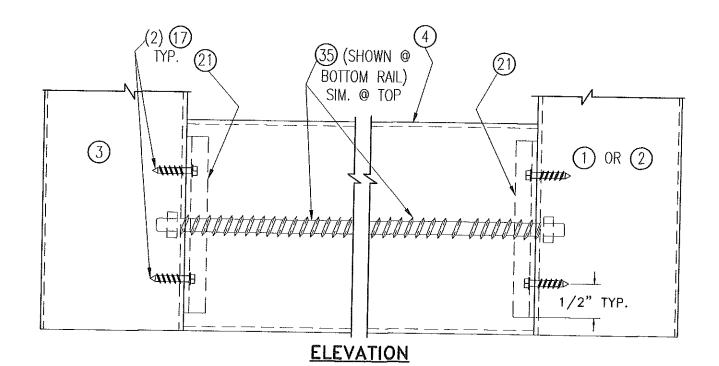


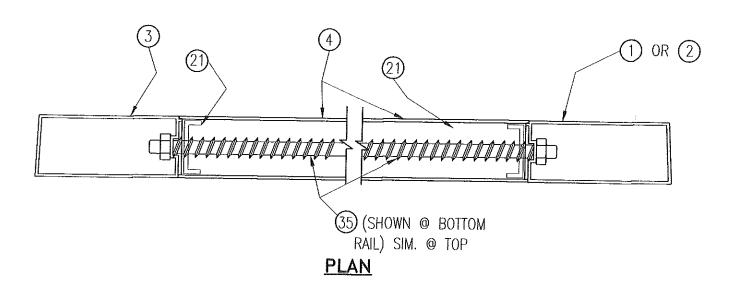


DETAIL 1: TOP/BOTTOM RAIL CONNECTION TO STILES

SCALE: 3/8"=1"



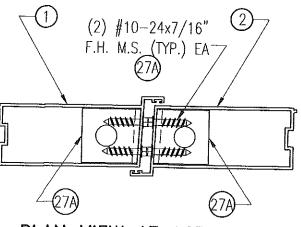

PLAN VIEW AT ACTIVE & INACTIVE LOCK STILE @ DOUBLE DOOR

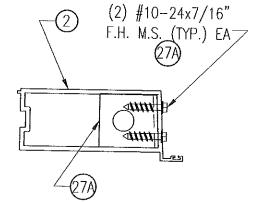

PLAN VIEW AT LOCK STILE

© SINGLE DOOR

SHOOT BOLT GUIDE DETAIL AT TOP & BOTTOM STILES

SCALE: 3/8"=1"

