

## DEPARTMENT OF REGULATORY AND ECONOMIC RESOURCES (RER) BOARD AND CODE ADMINISTRATION DIVISION

## **NOTICE OF ACCEPTANCE (NOA)**

11805 SW 26 Street, Room 208 Miami, Florida 33175-2474 T (786) 315-2590 F (786) 315-2599

PRODUCT CONTROL SECTION

www.miamidade.gov/economy

**MIAMI-DADE COUNTY** 

Mesker Door, a Division of DormaKaba, USA, Inc. 3440 Stanwood Blvd., Huntsville, AL 35811

#### SCOPE:

This NOA is being issued under the applicable rules and regulations governing the use of construction materials. The documentation submitted has been reviewed and accepted by Miami-Dade County RER -Product Control Section to be used in Miami Dade County and other areas where allowed by the Authority Having Jurisdiction (AHJ).

This NOA shall not be valid after the expiration date stated below. The Miami-Dade County Product Control Section (In Miami Dade County) and/or the AHJ (in areas other than Miami Dade County) reserve the right to have this product or material tested for quality assurance purposes. If this product or material fails to perform in the accepted manner, the manufacturer will incur the expense of such testing and the AHJ may immediately revoke, modify, or suspend the use of such product or material within their jurisdiction. RER reserves the right to revoke this acceptance, if it is determined by Miami-Dade County Product Control Section that this product or material fails to meet the requirements of the applicable building code.

This product is approved as described herein and has been designed to comply with the Florida Building Code, including the High Velocity Hurricane Zone.

**DESCRIPTION:** N-Series Outswing Glazed Steel Doors-LMI

**APPROVAL DOCUMENT:** Drawing No. **DOR010** Rev **A** (former **AD14-18**), titled "N-Series Outswing Glazed Steel Door (LMI/SMI)", sheets 1 through 12 of 12, dated 12/17/20, prepared by Building Drops, Inc., signed and sealed by Hermes Norero, P.E., bearing the Miami-Dade County Product Control revision stamp with the Notice of Acceptance number and expiration date by the Miami-Dade County Product Control Section.

## MISSILE IMPACT RATING: Large and Small Missile Impact Resistant

- 1. See sheet 1 thru 4 for Lock Hardware Options. See sheets 1 thru 5 for Anchor Bracket types and anchor types.
- 2. Min 13" wide Stiles and 16" min top/bottom Rails are required for installation of lite kits per sheet 4.
- 3. Private labelling is **not** part of this approval.

**LABELING:** Each unit shall bear a permanent label with the manufacturer's name or logo, city, state and series and following statement: "Miami-Dade County Product Control Approved", noted herein.

**RENEWAL** of this NOA shall be considered after a renewal application has been filed and there has been no change in the applicable building code negatively affecting the performance of this product.

**TERMINATION** of this NOA will occur after the expiration date or if there has been a revision or change in the materials, use, and/or manufacture of the product or process. Misuse of this NOA as an endorsement of any product, for sales, advertising or any other purposes shall automatically terminate this NOA. Failure to comply with any section of this NOA shall be cause for termination and removal of NOA.

**ADVERTISEMENT:** The NOA number preceded by the words Miami-Dade County, Florida, and followed by the expiration date may be displayed in advertising literature. If any portion of the NOA is displayed, then it shall be done in its entirety.

**INSPECTION:** A copy of this entire NOA shall be provided to the user by the manufacturer or its distributors and shall be available for inspection at the job site at the request of the Building Official.

This NOA revises & renews # 17-0920.08, consists of this page 1 and evidence pages E-1, E-2 & E-3, as well as approval document mentioned above.

The submitted documentation was reviewed by Ishaq I. Chanda, P.E.

MIAMI-DADE COUNTY
APPROVED

Ishaq 1. Chands

NOA No. 20-0708.04 Expiration Date: July 16, 2025 Approval Date: December 23, 2020

### NOTICE OF ACCEPTANCE: EVIDENCE SUBMITTED

## 1. Evidence submitted under previous approvals

#### A. DRAWINGS

- 1. Manufacturer's die drawings and sections (submitted under files below)
- 2. Drawing No. **AD14-18**, titled "N-Series Outswing Glazed Steel Door (LMI/SMI)", sheets 1 through 12 of 12, prepared by MYC Engineering Inc., dated 01/21/15 and last revised on JUL 01, 2015, signed and sealed by Yipping Wang, P.E.

### B. TESTS (submitted under files #14-1021.04)

- 1. Test reports on: 1) Air Infiltration Test, per FBC, TAS 202-94
  - 2) Uniform Static Air Pressure Test, Loading per FBC TAS 202-94
  - 3) Water Resistance Test, per FBC, TAS 202-94
  - 4) Large Missile Impact Test per FBC, TAS 201-94
  - 5) Cyclic Wind Pressure Loading per FBC, TAS 203-94
  - 6) Forced Entry Test, per FBC 2411 3.2.1, TAS 202-94

along with marked-up drawings and installation diagram of outswing Steel door w/ glazed steel lite kit assembly, prepared by Fenestration Testing Lab, Inc., Test Report No. FTL 7245, dated 08/22/14 and FTL 8120, dated 12/19/14, signed and sealed by Idalmis Ortega, P. E.

Note: Test report FTL**7245** has been revised by an addendum letter dated April 10, 2015, issued by Fenestration Testing lab, signed and sealed by Idalmis Ortega, P. E.

#### C. CALCULATIONS

1. Anchor Verification calculation dated 01/12/15, 07/01/15 and last revised on JUL 07, 2015, prepared by MYC Engineering Inc., signed and sealed by Yipping Wang, P.E.

### D. QUALITY ASSURANCE

1. Miami Dade Department of Regulatory and Economic Resources (RER).

#### E. MATERIAL CERTIFICATIONS

- 1. Notice of Acceptance No. 11-0624.02 issued to E.I. DuPont DeNemours & Co., Inc. for their "DuPont Sentry Glass ® Plus", expiring on 01/14/17.
- 2. Notice of Acceptance No. **13-0717.01** issued to Sabic Innovative Plastics, Inc. for their "Lexan Polycarbonate sheet Products", expiring on 07/17/18
- 3. Tensile strength test report **FTL 8319** for "Kit Steel frame" per ASTME-08, dated 04/07/15 issued by Fenestration Testing lab, signed and sealed by Idalmis Ortega, P. E.

### F. STATEMENTS

- 1. Statement letter of conformance FBC 2014 (5<sup>th</sup> Edition) and letter of no financial interest, dated 01/09/15, prepared by MYC Engineering Inc., signed and sealed by Yipping Wang, P.E.
- 2. Statement letter dated 07/08/15, issued by Mesker Holding, LLC stating Mesker Door, LLC is the subsidiary of Mesker Holding and requesting NOA to be issued under Mesker Door, LLC, signed by Aaron R Schwartz, Chief Financial Officer.
- 3. State of Alabama Business entity details and legal name listing dated 11-07-2013, signed by Secretary of State.
- 4. Lab compliance as part of the above referenced test report.

Ishaq I. Chands

Ishaq I. Chanda, P.E.
Product Control Unit Supervisor
NOA No. 20-0708.04
Expiration Date: July 16, 2025
Approval Date: December 23, 2020

#### Mesker Door, a Division of Dorma Kaba, USA, Inc.

## NOTICE OF ACCEPTANCE: EVIDENCE SUBMIT

#### G. **OTHER**

- 1. Test proposal #13-1401, dated 04/04/14 approved by RER.
- 2. Internet posting of Mesker Holding, LLC.

#### 2. Evidence submitted under previous approvals

#### A. **DRAWINGS**

1. Drawing No. AD14-18, titled "N-Series Outswing Glazed Steel Door (LMI/SMI)", sheets 1 through 12 of 12, prepared by MYC Engineering Inc., dated Sep 05, 2017., signed and sealed by Yipping Wang, P.E.

Note: Revision consist of FBC 2017 code update in sheet 1

#### В. **TEST**

1. None.

#### C. **CALCULATIONS**

1. None.

#### D. **QUALITY ASSURANCE**

1. Miami Dade Department of Regulatory and Economic Resources (RER).

#### Ε. MATERIAL CERTIFICATIONS

- 1. Notice of Acceptance No. 14-0916.11 issued to Kuraray America, Inc. (former E.I. DuPont DeNemours & Co., Inc.) for the "Sentry Glass ® Interlayer", expiring on 07/4/18.
- 2. Notice of Acceptance No. 13-0717.01 issued to Sabic Innovative Plastics, Inc. for their "Lexan Polycarbonate sheet Products", expiring on 07/17/18.

#### F. **STATEMENTS**

- 1. Statement letters of conformance to FBC 2017(6th Edition) and FBC 2014 (5th Edition), dated 11/29/17, prepared by MYC Engineering Inc., signed and sealed by Yipping Wang, P.E.
- 2. Statement letter dated 11/28/17 of code revision note update only and no other changes in approval drawings, prepared by MYC Engineering Inc., signed and sealed by Yipping Wang, P.E.

#### G. **OTHER**

1. This NOA revises NOA # 14-1021.04, expiring 07/16/20.

#### 1. New Evidence Submitted

#### Α. **DRAWINGS**

1. Drawing No. **DOR010** Rev A (former AD14-18), titled "N-Series Outswing Glazed Steel Door (LMI/SMI)", sheets 1 through 12 of 12, dated 12/17/20, prepared by Building Drops, Inc., signed and sealed by Hermes Norero, P.E. Ishaq I. Chands

(Note: Revision consist of FBC 2020 code updates)

Ishaq I. Chanda, P.E. **Product Control Unit Supervisor** NOA No. 20-0708.04 **Expiration Date: July 16, 2025** 

Approval Date: December 23, 2020

### Mesker Door, a Division of DormaKaba, USA, Inc.

## **NOTICE OF ACCEPTANCE: EVIDENCE SUBMITTED**

#### B. TEST

1. None.

#### C. CALCULATIONS

1. Anchor Verification calculation dated 07/30/20, prepared by Building Drops, Inc., signed and sealed by Hermes Norero, P.E.

#### D. QUALITY ASSURANCE

1. Miami Dade Department of Regulatory and Economic Resources (RER).

## E. MATERIAL CERTIFICATIONS

1. None.


#### F. STATEMENTS

- 1. Statement letters of conformance to FBC 2020 (7th Edition) and "No financial interest"), dated 06/30/20, prepared by Building Drops, Inc., signed and sealed by Hermes Norero, P.E.
- 2. Notification of Successor Engineer per the Florida Administrative Code Section 61G15-27.001, notifying original engineer that the successor engineer is assuming full professional and legal responsibility for all engineering documents pertaining to this NOA, dated 02/09/20, prepared by Building Drops, Inc., signed and sealed by Hermes Norero, P.E.
- 3. Merger Certificate issued dated DEC 01, 2017 by State of Delaware between Mesker Holding Inc., and "PRT Blocker", LLC, signed by Jeffery W, Bullock, Secretary of State.
- 4. Merger Certificate issued dated Jun 13, 2018 by State of Delaware between Mesker Door, Inc., Inc., with and into "PRT Blocker", LLC, signed by Jeffery W, Bullock, Secretary of State.
- 5. Merger Certificate issued dated Jun 27, 2018 by State of Delaware between "PRT Blocker", LLC with and into DormaKaba USA, Inc., signed by Jeffery W, Bullock, Secretary of State.
- 6. Statement letter dated 10/16/20 requesting Name change based on merger documents, signed by Ms. Nancy M. Lambert, V.P. & general counsel, DormaKaba, USA, Inc.

### G. OTHER

- 1. This NOA revises & renews # 17-0920.08, expiring 07/16/25.
- 2. Media Release by dormakaba dated Nov. 08, 2016 to acquire merger of US based Mesker Opening group.

Ishaq I. Chands

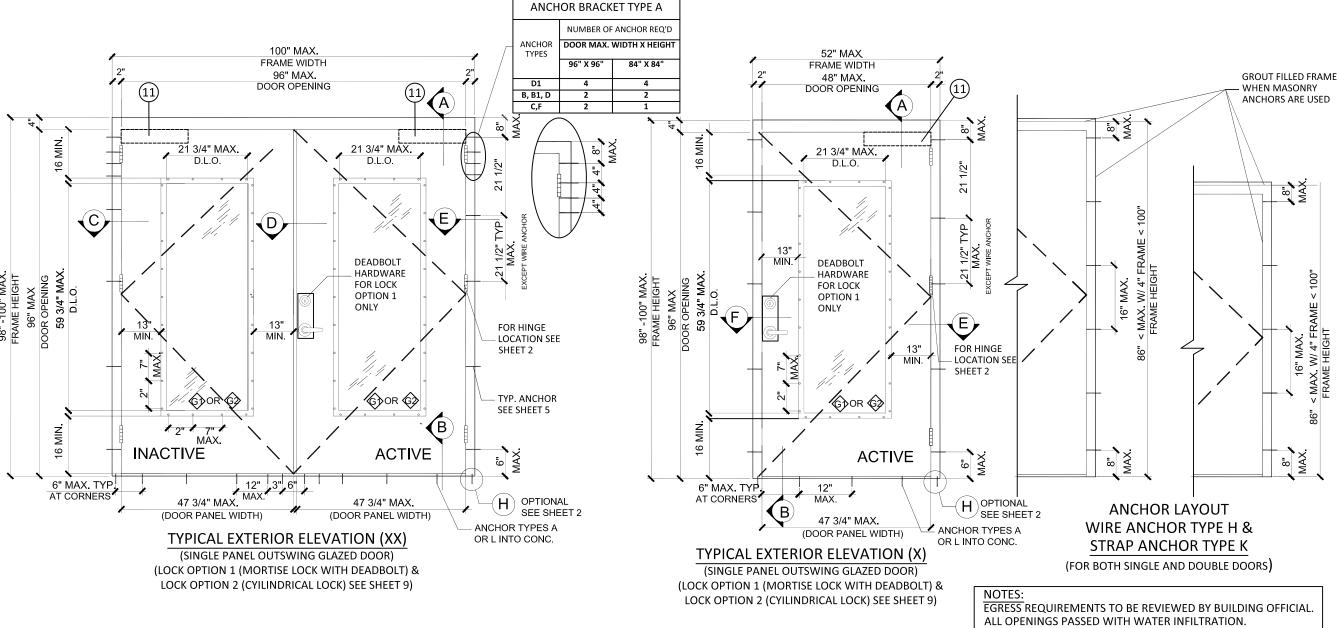

### "N" SERIES GLAZED OUTSWING STEEL DOOR (LMI)

- THIS PRODUCT HAS BEEN DESIGNED AND TESTED TO COMPLY WITH THE REQUIREMENTS OF THE 2020 FLORIDA BUILDING CODE INCLUDING HIGH VELOCITY HURRICANE ZONE (HVHZ).
- DOORS ARE RATED FOR LARGE MISSILE IMPACT AND DO NOT REQUIRE
- ANCHORS SHALL BE AS LISTED, SPACED AS SHOWN ON ELEVATIONS / DETAILS. ANCHOR EMBEDMENT TO BASE MATERIAL SHALL BE BEYOND WALL DRESSING
- ANCHORING OR LOADING CONDITIONS NOT SHOWN IN THESE DETAILS ARE NOT PART OF THIS APPROVAL.
- MATERIALS INCLUDING BUT NOT LIMITED TO STEEL/METAL SCREWS THAT COME INTO CONTACT WITH OTHER DISSIMILAR MATERIALS SHALL MEET THE REQUIREMENTS OF THE 2020 FLORIDA BUILDING CODE AS APPLICABLE.

- METAL STRUCTURES NOT BY MESKER DOOR INC. MUST SUPPORT LOADS IMPOSED BY DOOR SYSTEM AND TRANSFER THEM TO THE BUILDING
- 1X OR 2X WOOD BUCKS OR OTHERS MUST BE ANCHORED PROPERLY TO TRANSFER LOADS TO THE STRUCTURE.
- A LOAD DURATION FACTOR IN ALLOWABLE STRESS IS USED IN DESIGN OF WOOD ANCHORS ONLY.
- DOOR PANEL: MIN. 18 GA. (0.042" THK) STEEL MIN. Fy = 42 KSI, Fu= 51.5 KSI
- DOOR FRAME: MIN. 16 GA. (0.053" THK) STEEL MIN. Fy = 42 KSI, Fu= 51.5 KSI
- ULTIMATE DESIGN LOAD OBTAINED FROM ASCE 7-16 MULTIPLIED BY 0.6 SHALL BE LESS THAN OR EQUAL TO MAX. DESIGN LOAD IN THIS DOCUMENT.

BUILDING DROPS, INC. 398 E. DANIA BEACH BLVD. #338 DANIA BEACH, FL 33004 PREPARED BY 12/15/20 DATE SM В **NOISIN** 2020 FBC UPDATE DESCRIPTION  $\overline{\mathbf{C}}$ 9 ⋖ HERE \* PROFE DWN BY ER CHK BY HFN DWG #: **DOR010** 

of 12

MESKER\*

MESKER DOOR a division of dormakaba USA Inc. 3440 Stanwood Blvd. Huntsville, AL 35811

PH: (256) 851-6670 FX: (800) 503-1410

TITLE: N SERIES OUTSWING STEEL GLAZED DOOR

**DESIGN LOADS** (FOR SIZES SHOWN ABOVE OR SMALLER) AS PERMITTED BY FBC


+65.0 PSF -65.0 PSF


**PRODUCT REVISED** as complying with the Florida Building Code **NOA-No.** 20-0708.04

Expiration Date 07/16/2025

Ishaq 1. Chands

Miami-Dade Product Control

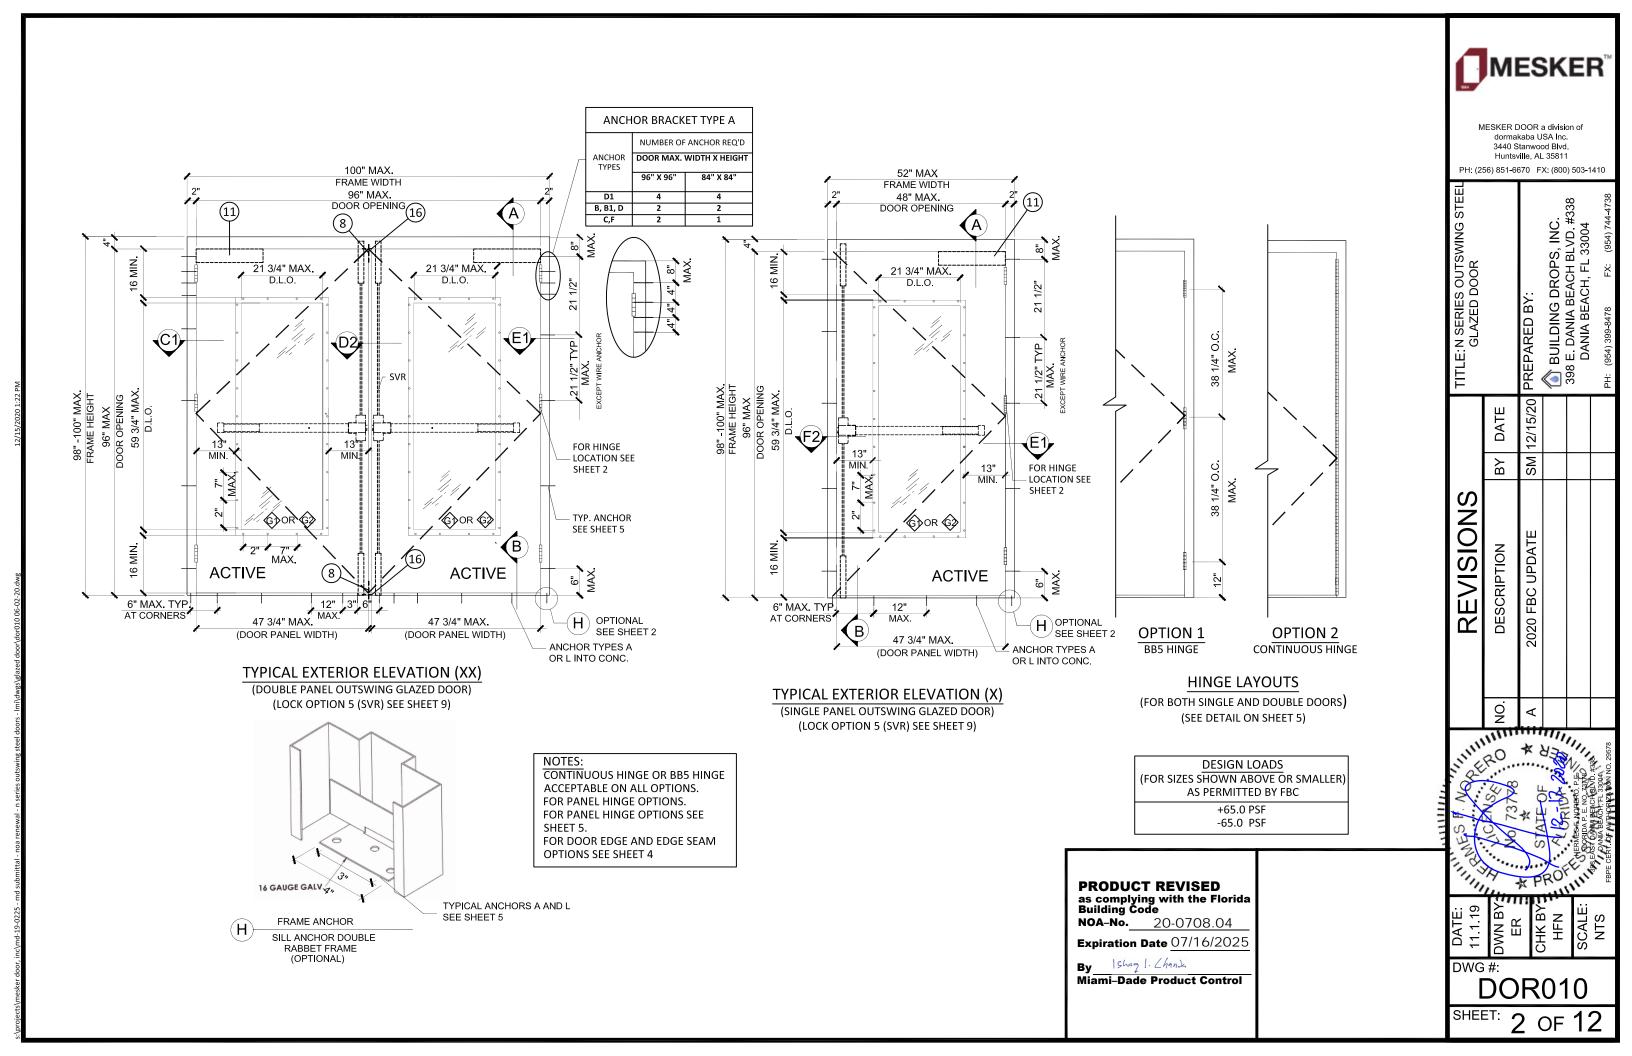

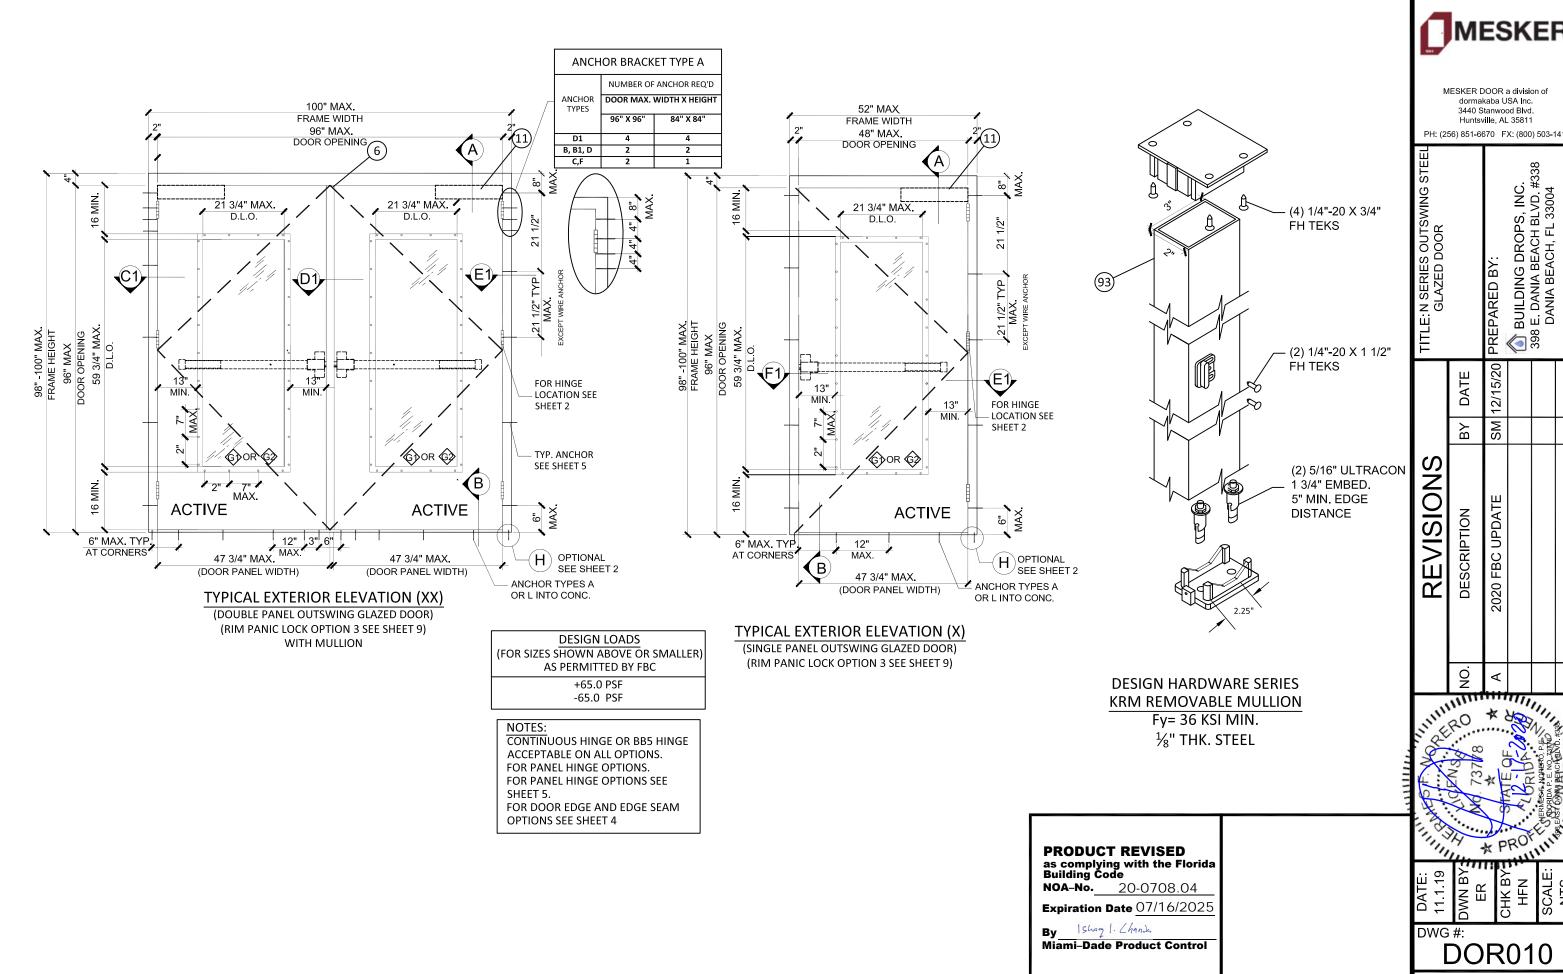


MESKER

MESKER DOOR a division of dormakaba USA Inc. 3440 Stanwood Blvd.


PH: (256) 851-6670 FX: (800) 503-1410


**DOR010** 


of 12

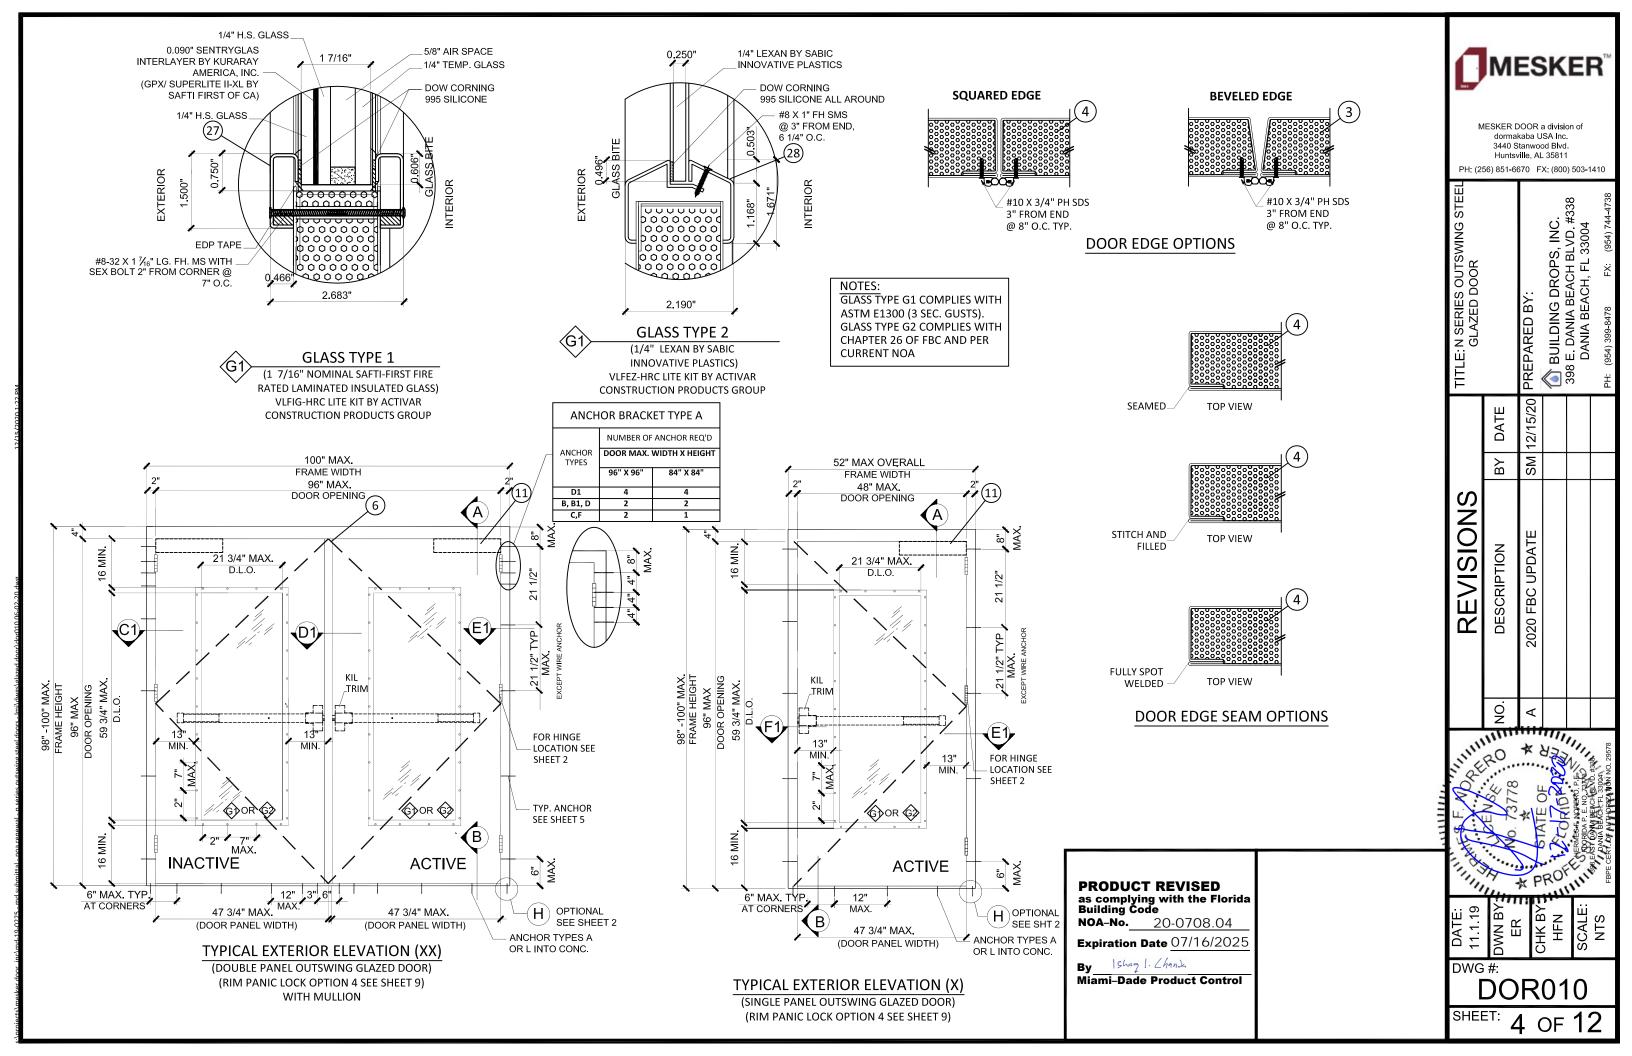

#### SILL ANCHORS: (REFER TO ELEVATION FOR SPACING) TYPICAL ANCHORS @ HEAD/JAMB: (REFER TO ELEVATION FOR SPACING) MESKER" **ANCHOR BRACKETS** 1/4" DIA. ULTRACONS BY "ELCO" (Fy=155 KSI Fu= 177 KSI) TYPE B 3/8" DIA. HLC SLEEVE ANCHOR BY "HILTI" TYPE L DIRECTLY INTO fc'=3000 PSI CONCRETE (SEE DETAILS ON SHEET 10) DIRECTLY INTO fc'=3000 PSI CONCRETE 1-3/8" MIN. EMBED, 3 1/4" MIN. EDGE DISTANCE 1-1/2" EMBED INTO CONCRETE, 2 1/2" MIN. EDGE DISTANCE MESKER DOOR a division of 3/8" DIA. HLC SLEEVE ANCHOR BY "HILTI" TYPE B1 TUBE ANCHOR (PF-10) dormakaba USA Inc. 5/16" DIA. ULTRACONS BY "ELCO" (Fy=155 KSI Fu= 177 KSI) TYPE A DIRECTLY INTO fc'=3000 PSI INTO GROUT FILLED CONCRETE BLOCK 3440 Stanwood Blvd. Huntsville, AL 35811 (SEE ELEVATIONS ON SHEETS 1 THRU 4 DIRECTLY INTO fc'=3000 PSI CONCRETE 1-3/8" MIN. EMBED, 3 1/2" MIN. EDGE DISTANCE FOR ANCHOR BRACKET LOCATIONS) 1-3/4" EMBED INTO CONCRETE, 2 3/16" MIN. EDGE DISTANCE PH: (256) 851-6670 FX: (800) 503-1410 3/8" DIA. LOK-BOLT AS BY "DEWALT" TYPE C #8 X 5/8" PH SMS DIRECTLY INTO CONCRETE fc'=3000 PSI MIN 4" FROM END BUILDING DROPS, INC. 8 E. DANIA BEACH BLVD. #3 DANIA BEACH, FL 33004 2 1/2" MIN. EMBED, 3 1/8" MIN. EDGE DISTANCE @ 8" O.C. TYP. Z ANCHOR (PF-9) 3" X 12" X 16 GA 3/8" DIA. SCREW- BOLT + AS BY "DEWALT" TYPE D (SEE ELEVATIONS BELOW FOR ANCHOR S OUTSV STEEL PLATE DIRECTLY INTO CONCRETE fc'=3000 PSI MIN **BRACKET LOCATIONS)** 5.517" X 19" LG. X 16 GA 1 1/2" MIN. EMBED, 3 1/4" MIN. EDGE DISTANCE STEEL PLATE 3/8" DIA. SCREW- BOLT + AS BY "DEWALT" TYPE D1 (4) 12-24 X 1/2" 22 GA 4 1/2" LG. DIRECTLY INTO fc'=3000 PSI INTO GROUT FILLED CONCRETE BLOCK WOOD STUD ANCHOR (F-24) FH MS STEEL PLATE 1 1/2" MIN. EMBED, 3 3/4" MIN. EDGE DISTANCE (SEE ELEVATIONS BELOW FOR ANCHOR **BRACKET LOCATIONS)** 5/16" DIA. SMS OR MACHINE BOLTS (MIN. GRADE 2 CRS) OR ST/ST 398 TYPE F EXT. INTO METAL STRUCTURES STEEL: Fy=36 KSI MIN. 1/4" MIN. THK. 12/15/20 ALUMINUM: 6063-T5, 1/4" MIN. THK. DATE HINGE OPTION 1 **BB5 BALL BEARING HINGE** NOTE: EACH TYPE OF ANCHOR SHALL BE USED WITH ANCHOR #8 X 5/8" PH SMS SM ВҰ ALL FRAME JOINTS AND CORNERS TO BE SEALED WITH SILICONE BRACKET TYPE A. 4" FROM END AT PERIMETER @ 8" O.C. TYP. 1.385 BY FULL LENGTH SION 14 X 1 1/2" FH SDS BY 0.067" THICK STEEL NOTE: 9 1/2" O.C. WIRE ANCHOR: (REFER TO ELEVATION FOR SPACING) 9½"M<sub>IN.</sub> PLATE SPOT WELDED 2020 FBC UPDATE JAMB SUBSTRATE CAN BE GROUT FILLED CONCRETE, 2X DESCRIPTION (SEE DETAIL ON SHEET 10) AT EACH END WOOD BUCKS, WOOD STRUCTURAL MEMBER(S), FILLED 1.75" BY FULL LENGTH BY CONCRETE BLOCK WALL AND METAL STRUCTURE (STEEL 0.067" THICK STEEL PLATE OR ALUMINUM). ANCHOR TYPE SHOWN ABOVE SHOULD 11.95" LG. X 0.067" THK. TYPE H SPOT WELDED 7" FROM WIRE ANCHOR (PF-2) (Fy=60 KSI) MIN. BE CHOSEN BASED ON SUBSTRATE TYPE IN THE PROJECT STEEL GOVT. NO. 86 TOP & 8" O.C. 0.182 DIAM. STEEL WIRE ANCHORS EMBED INTO ANY TYPE OF ANCHOR NOT SPECIFIED HERE IS NOT PART MORTISE LOCK BLANK GROUT FILLED CONCRETE BLOCK fm'=1500 PSI MIN. OF THIS APPROVAL FACE REINF. TO BE USED (10) WITH LOCK OPTIONS 3,4, & 5 **HINGE OPTION 2 CONTINUOUS GEARED HINGE** STRAP ANCHOR: (REFER TO ELEVATION FOR SPACING) (SEE DETAIL ON SHEET 10) ΜŽ, TYPE H STRAP ANCHOR (PF-2) (PS-241) (Fy=60 KSI) MIN. INTO GROUT FILLED CONCRETE BLOCK fm'=3000 PSI MIN. **PRODUCT REVISED** TYP. ANCHOR SEE SHEET 5 as complying with the Florida Building Code TYPE J INACTIVE **NOA-No.** 20-0708.04 ACTIVE 6" MAX. TYP Expiration Date 07/16/2025 6" MAX. TYP AT CORNERS AT CORNERS WOOD OR STEEL STRUCTURAL MEMBERS OF WOOD AND STEEL-STUD WALLS MUST BE DESIGNED TO CARRY AT LEAST 271 **Miami-Dade Product Control** ANCHOR BRACKET TYPE B & C LAYOUT **DOR010** LB/FT FOR DOORS RATED @ 65 PSF OF

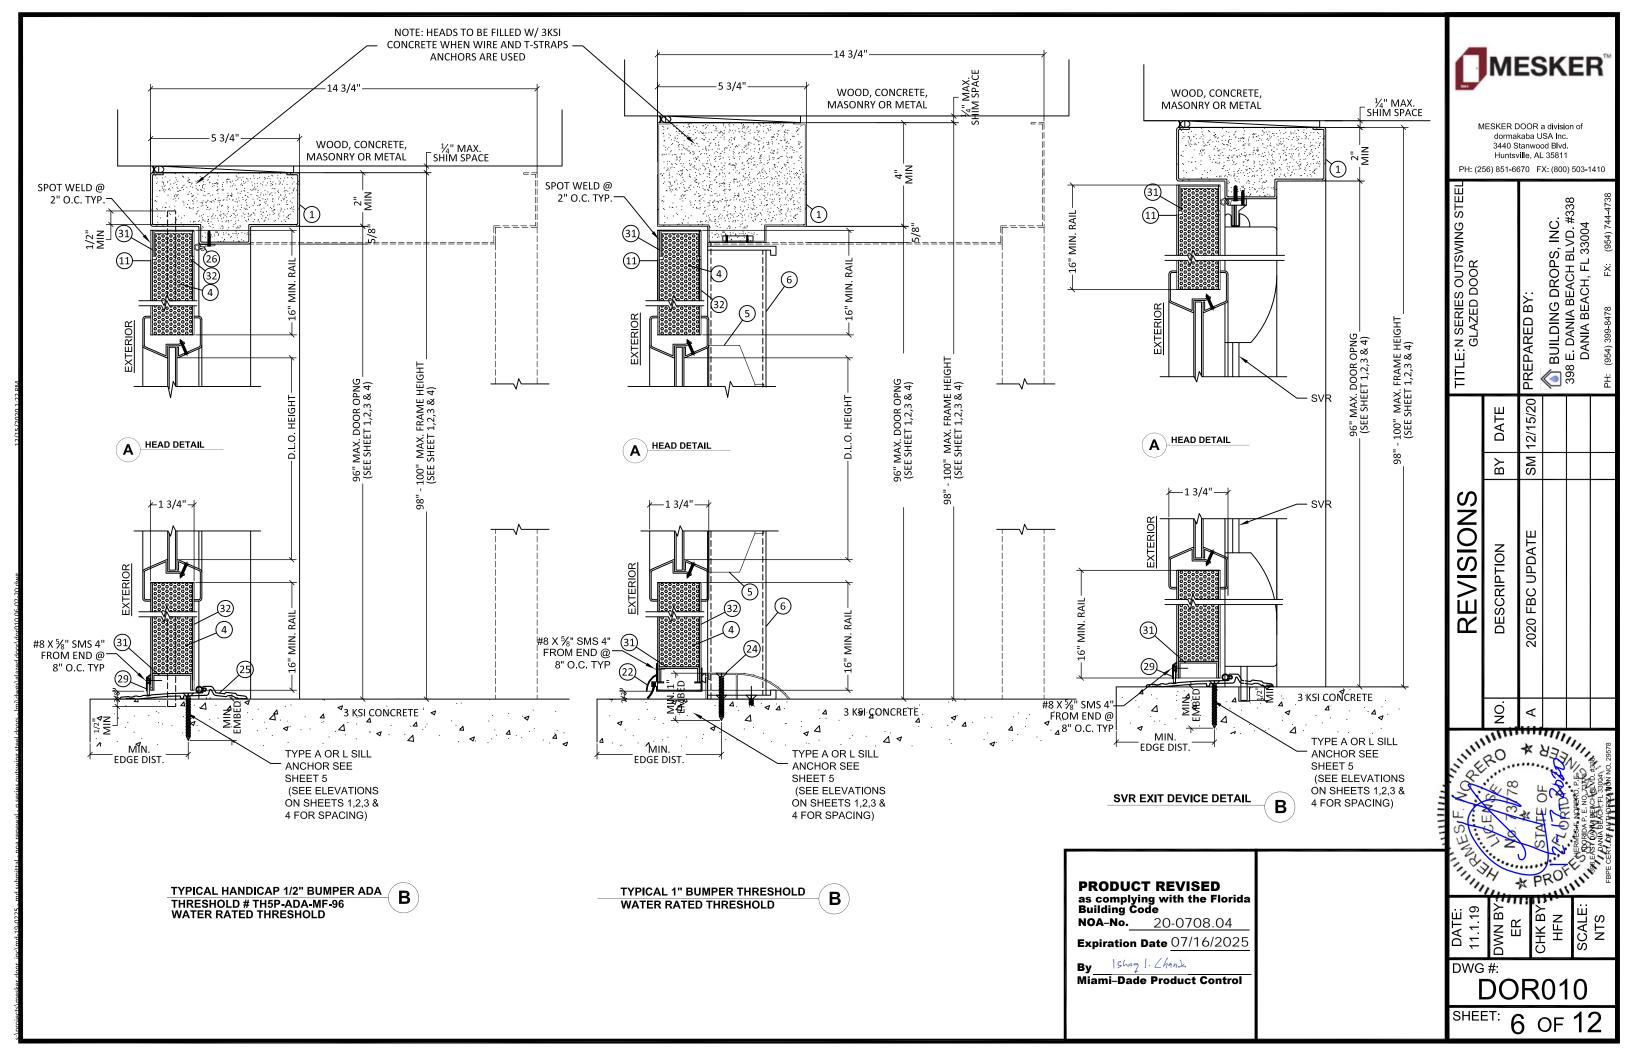


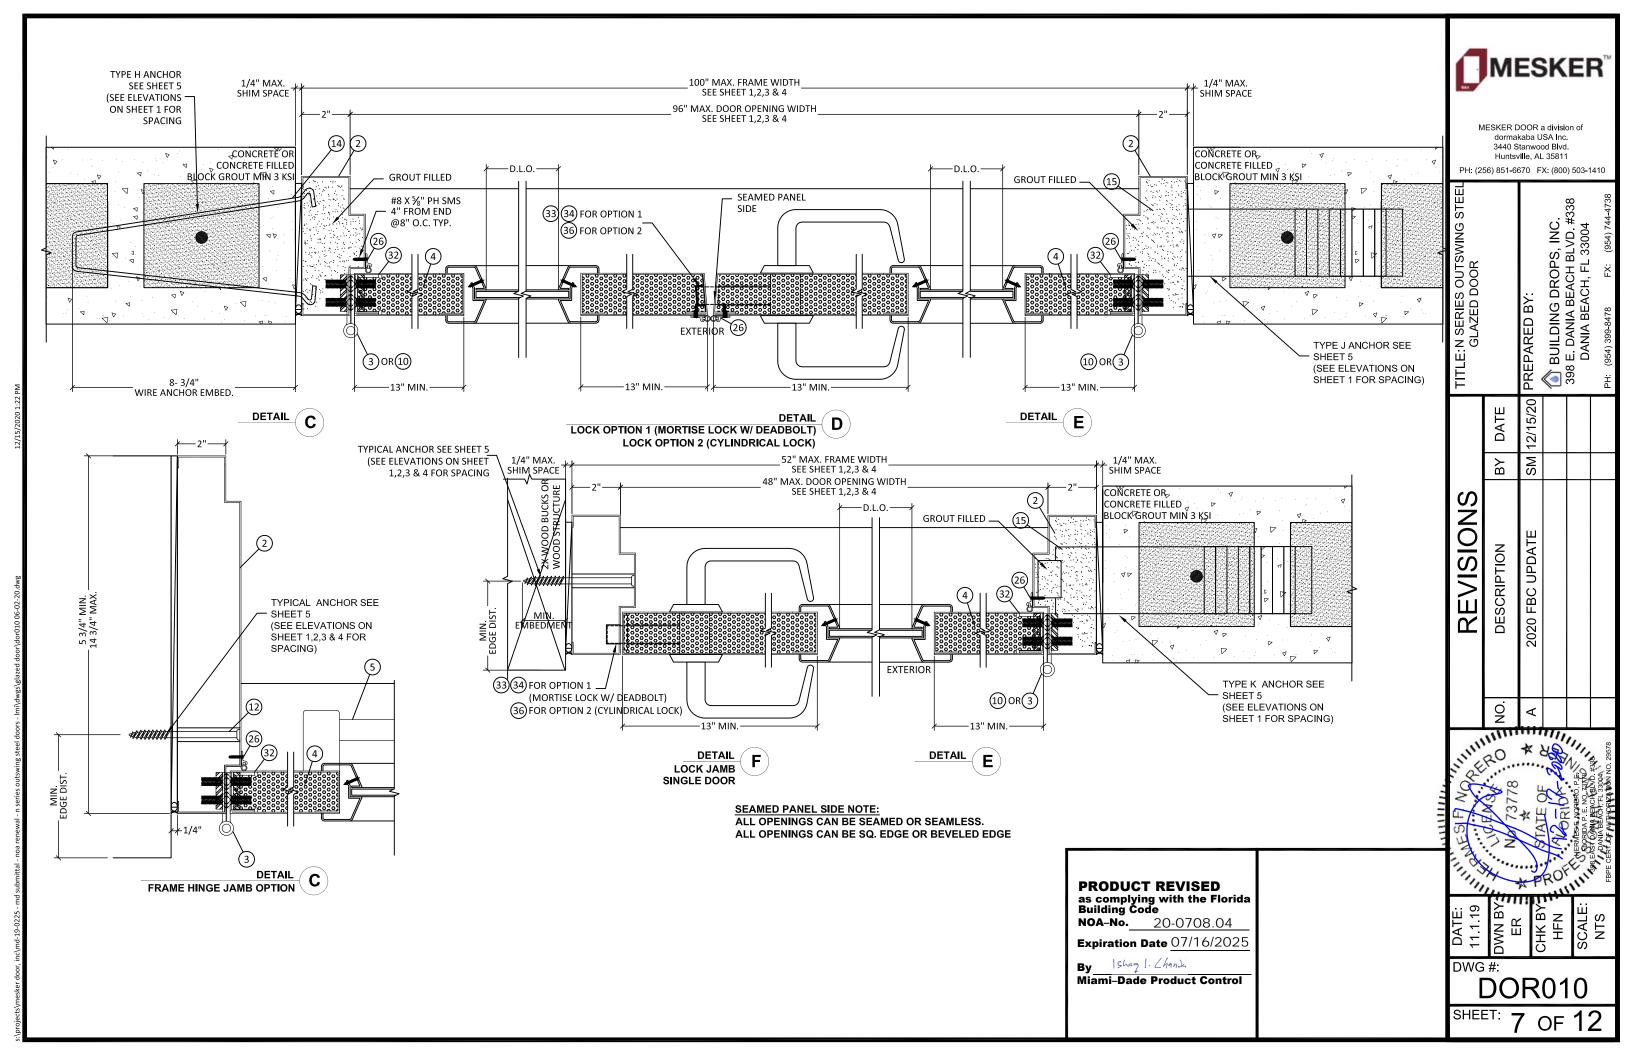

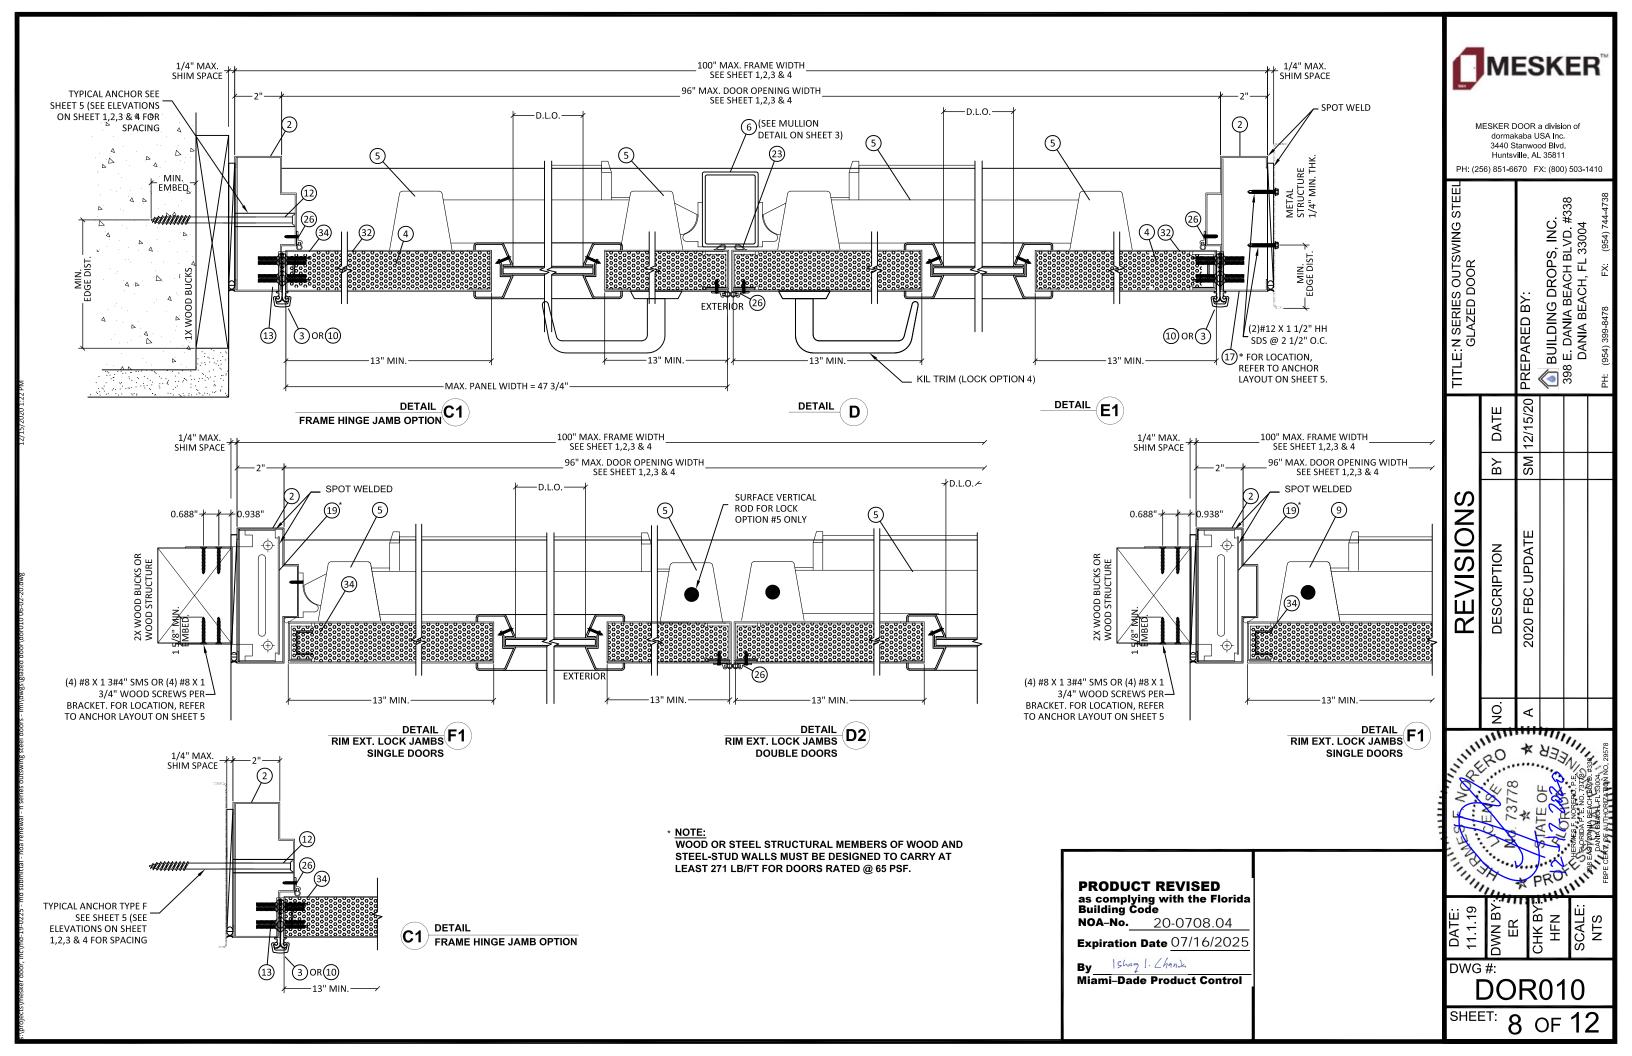

## **HARDWARE/LOCK OPTIONS**

ACTIVE DOOR HARDWARE CAN APPLY TO SINGLE DOORS (EXTERIOR ELEVATIONS - OUTSWING DOORS)

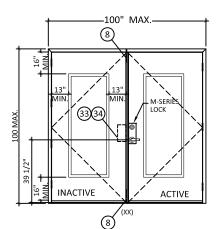


## **OPTION 1**

#### ACTIVE LEAF:

DESIGN HARDWARE M SERIES EXTRA HEAVY DUTY (GRADE 1) MORTISE LOCK WITH (2) 8-32 X 1 1/8" FH MS, LATCH = SS 3/4" THROW, DEADBOLT = SS 1" THROW

#### **INACTIVE LEAF:**

DESIGN HARDWARE UL-MFB-M FLUSH BOLTS WITH (4) 8 X 3/4" FH MULTI THREAD SCREWS, TOP AND BOTTOM, FLUSH MOUNT METALLIC FLUSH BOLT GUIDE WITH (2) #8 X 3/4" FH THREAD SCREWS, FLUSH MOUNT METALLIC STRIKE PLATE, WITH (2) 1/4" X 3/8" FH MS

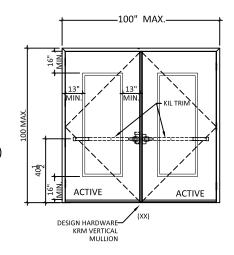

## **OPTION 4**

#### **OPTION 4.A**


#### **ACTIVE LEAF/INACTIVE LEAF:**

DESIGN HARDWARE 2000 SERIES STANDARD DUTY SURFACE MOUNT METALLIC PANIC DEVICE WITH DESIGN KIL TRIM, WITH (4) 14 X 1 1/2" FH SDS, HANDLE WITH (2) #8-36 X 1 1/2" PH MS. WITH 2" X 3" X 1/8" THICK STEEL VERTICAL TUBE MULLION, FY = 36 KSI MIN.

#### OPTION 4.B

#### **ACTIVE LEAF/INACTIVE LEAF:**

DESIGN HARDWARE 1000 SERIES HEAVY DUTY SURFACE MOUNT METALLIC PANIC DEVICE WITH DESIGN KIL TRIM WITH (5) 14 X 1 1/2" FH SDS, HANDLE WITH (2) #8-36 X 1 1/2" PH MS. WITH 2" X 3" X 1/8" THICK STEEL VERTICAL TUBE MULLION, FY = 36 KSI MIN.

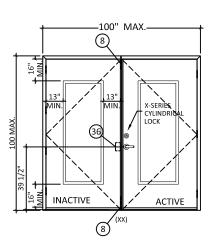


## **OPTION 2**

#### **ACTIVE LEAF**

DESIGN HARDWARE X SERIES (GRADE 1) CYLINDRICAL LOCK, WITH (2) #8 X 3/4" FH THREAD SCREWS AND (2) #10 X 1 9/16" FH MS. LATCH = SS 1/2" THROW

#### **INACTIVE LEAF:**

DESIGN HARDWARE UL-MFB-M FLUSH BOLTS, FLUSH MOUNT METALLIC FLUSH BOLT GUIDE, SURFACE MOUNT METALLIC STRIKE PLATE, WITH (4) 8 X 3/4" FH MULTI THREAD SCREWS, TOP AND BOTTOM

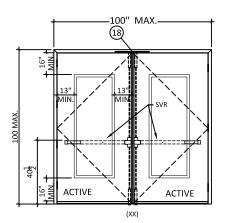

## **OPTION 5**

#### OPTION 5.A


#### **ACTIVE LEAF/INACTIVE LEAF:**

DESIGN HARDWARE 2000 SERIES STANDARD DUTY (GRADE 1) SVR SURFACE MOUNT METALLIC 2 POINT LOCK SYSTEM WITH PANIC DEVICE AND VERTICAL RODS ON EXTERIOR WITH (6) 14"-20 X 3/4 PH SMS AND (6) 14-20 X 3/4" FH MS. TOP STRIKE WITH (3) 1/4"-20P X 3/4" FH MS.

### OPTION 5.B

#### **ACTIVE LEAF/INACTIVE LEAF:**

DESIGN HARDWARE 1000 SERIES HEAVY DUTY (GRADE 1) SVR SURFACE MOUNT METALLIC PANIC DEVICE WITH (2) 14-20" PH MS AND (4) 14 X 1/4" FH SMS, VERTICAL ROD AT TOP AND BOTTOM (2) 14 X 1 1/2" FH SDS. TOP STRIKE WITH (3) 1/4"-20P X 3/4" FH MS.

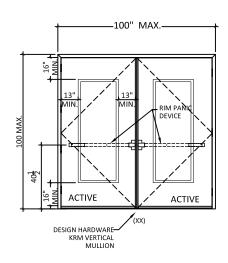

## **OPTION 3**

#### **OPTION 3.A**

#### **ACTIVE LEAF/INACTIVE LEAF:**

DESIGN HARDWARE 2000 SERIES STANDARD DUTY SURFACE MOUNT METALLIC RIM PANIC DEVICE WITH (6) 14 X 1 1/2" FH SDS, RIM PANIC LATCH AT LOCKS = 5/8" THROW. ROLLER STRIKE WITH 5/8" PROJECTION & 1/8" SHIM.

WITH 2" X 3" X 1/8" THICK STEEL VERTICAL TUBE MULLION, FY = 36 KSI MIN.

#### **OPTION 3.B**

#### ACTIVE LEAF/INACTIVE LEAF:

DESIGN HARDWARE 1000 SERIES HEAVY DUTY SURFACE MOUNT METALLIC PANIC DEVICE WITH (5) 14 X 1 1/2" FH SDS, ROLLER STRIKE WITH 5/8" PROJECTION & 1/8" SHIM.

WITH 2" X 3" X 1/8" THICK STEEL VERTICAL TUBE MULLION, FY = 36 KSI MIN.

#### NOTE:

CONTINUOUS HINGE OR BB5 HINGE ACCEPTABLE ON ALL OPTIONS. FOR PANEL HINGE OPTIONS, SEE SHEET 5.


FOR DOOR EDGE AND EDGE SEAM OPTIONS SEE SHEET 4.

# PRODUCT REVISED as complying with the Florida Building Code NOA-No. 20-0708.04


Expiration Date 07/16/2025

y Ishaq I. Chands

Miami-Dade Product Control

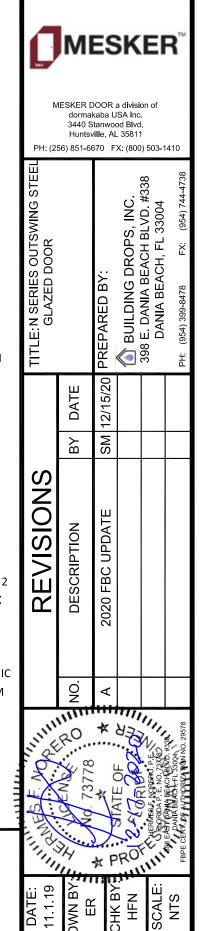

**DOR010** 

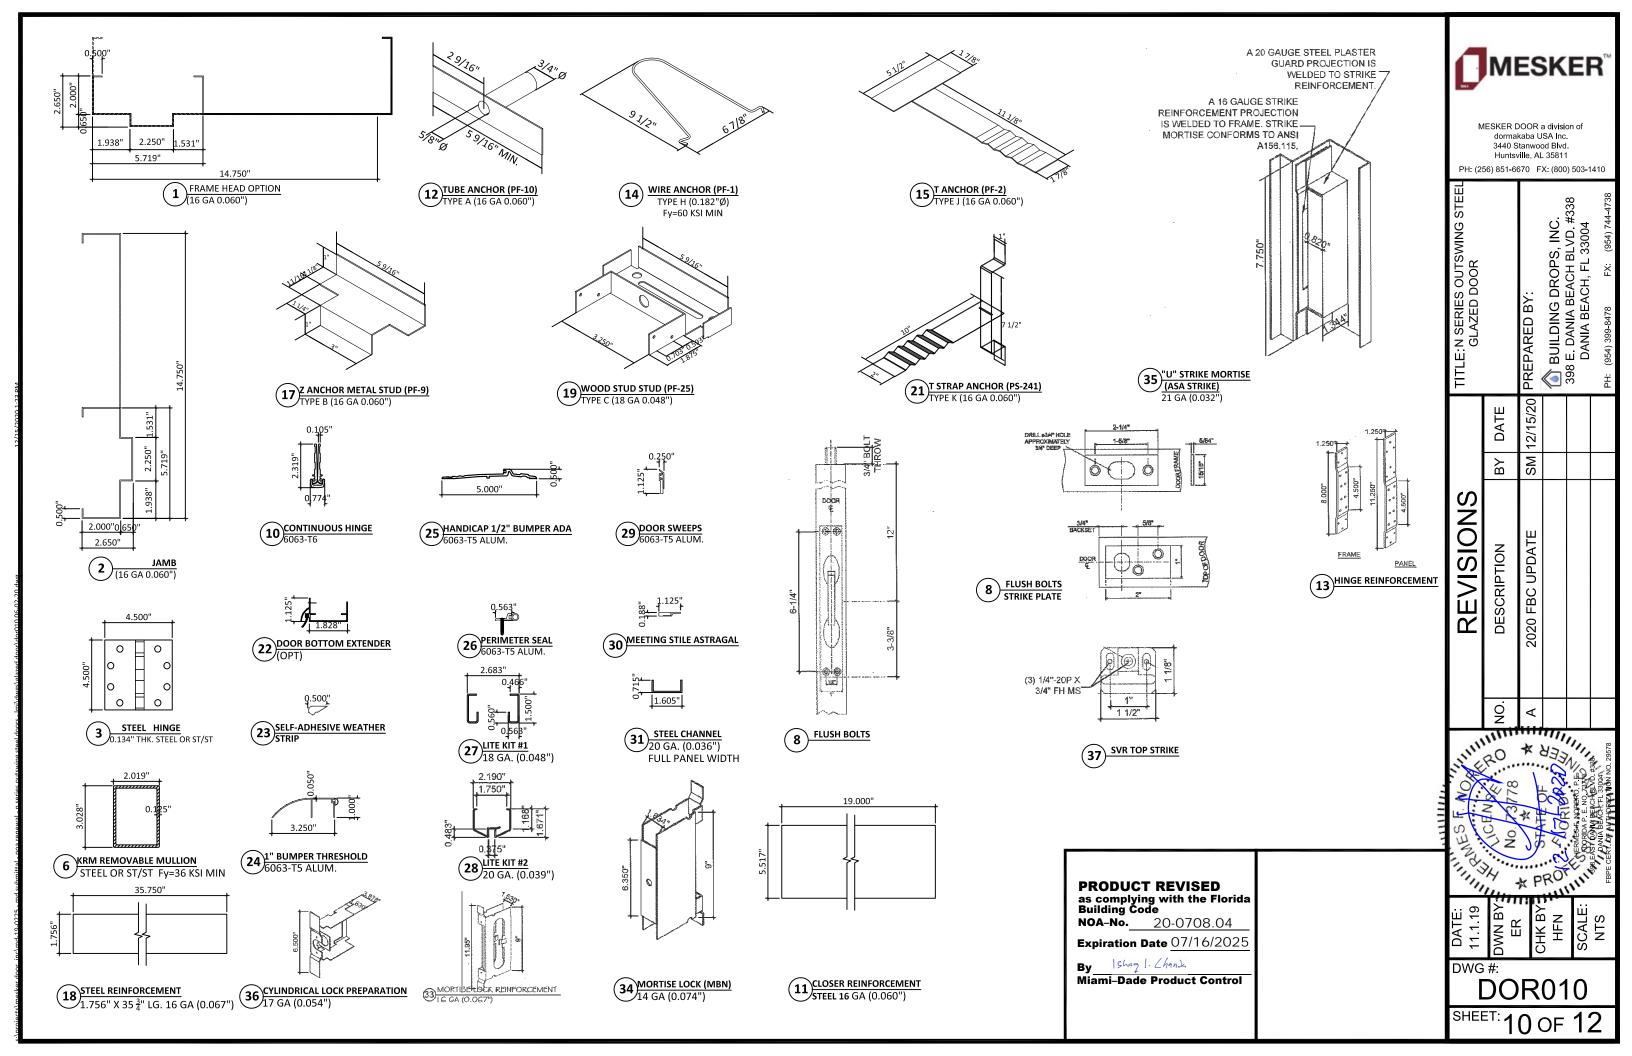

BILL OF MATERIALS					
ITEM	PART NO.	MATERIAL	QTY	DESCRIPTION	MANUFACTURER
1	-	STEEL OR ST/ST	AS REQD.	FRAME JAMB/ HEAD (5 3/4" X 2" OR 5 3/4" X 4" UP TO 14 3/4" DEEP)	MESKER DOOR 16 GA (0.06" MIN) Fy=40.8 KSI MIN.
2	-	STEEL OR ST/ST	AS REQD.	JAMB	MESKER DOOR 16 GA (0.06" MIN) Fy= 40.8 KSI MIN.
3	BB5	STEEL OR ST/ST	AS REQD.	STANDARD WEIGHT BALL BEARING HINGES	DESIGN HARDWARE
4	-	POLYSTYRENE	AS REQD.	POLYSTYRENE CORE PER CURRENT NOA	CELLOFOAM, BONDED TO INSIDE OF PANEL
5	2000, 1000	STEEL OR ST/ST	AS REQD.	2000 RM PANIC DEVIES 1000 SERIES OPTIONAL	DESIGN HARDWARE
6	KRM	STEEL OR ST/ST	1	KEY REMOVABLE MULLION	DESIGN HARDWARE
7	-	STEEL	1	X SERIES LOCK (1/2" OR 3/4")	DESIGN HARDWARE
8	UL-MFB-M	CAST BRASS	2	MANUAL FLUSH BOLT	DESIGN HARDWARE
9	2000, 1000	STEEL OR ST/ST	AS REQD.	2000-V EXIT DEVICES 1000-V SERIES OPTIONAL	DESIGN HARDWARE
10	-	ALUM. 6063-T6	AS REQD.	CONTINUOUS GEARED HINGE	DESIGN HARDWARE
11	-	STEEL	-	FRAME REINFORCEMENT	MESKER DOOR 16 GA (0.060" MIN.) HOT MELT PUR GLUE
12	TYPE A, PF-10	STEEL	AS REQD.	TUBE ANCHORS	MESKER DOOR 16 GA (0.060" MIN.) SPOT WELDED TO FRAME
13	-	STEEL OR ST/ST	AS REQD.	HINGE REINFORCEMENT	MESKER DOOR 7 GA (0.170" MIN.)
14	TYPE H, PF-1	STEEL	AS REQD.	WIRE ANCHORS	MESKER DOOR 0.182Ø
15	TYPE J, PF-2	STEEL	AS REQD	T ANCHORS	MESKER DOOR 16 GA (0.060" MIN.) TWISTED INTO FRAME
16	-	STEEL OR ST/ST	AS REQD.	13/16" X 1 3/4" X .118" THK. STEEL PLATE	MESKER DOOR
17	TYPE C, PF-9	STEEL	AS REQD.	Z ANCHORS (METAL STUD)	MESKER DOOR 16 GA (0.060" MIN.) SPOT WELDED TO FRAME
18	-	STEEL OR ST/ST	AS REQD.	STEEL REINFORCEMENT 1.756" X 35 3/4"	MESKER DOOR 16 GA (0.060" MIN.) SPOT WELDED 14" O.C.
19	TYPE D, PF-6	STEEL	AS REQD.	WOOD STUD ANCHORS	MESKER DOOR 18 GA. (0.048" MIN)
20	-	STEEL	AS REQD.	M SERIES MORTISE LOCK W/ DEADBOLT	DESIGN HARDWARE
21	TYPE K, PS-241	STEEL	AS REQD.	T STRAP ANCHOR	MESKER DOOR 16 GA (0.060" MIN.) SPOT WELDED TO FRAME
22	95WH	ALUM. 6063-T5	AS REQD.	DOOR BOTTOM EXTENDER	NATIONAL GUARD PRODUCTS
23	SS-S	RUBBER	AS REQD.	SELF ADHESIVE WEATHERSTRIP	DESIGN HARDWARE
24	646	ALUM. 6063-T5	1	1" BUMPER THRESHOLD	DESIGN HARDWARE
25	#TH5P-ADA-MF-96	ALUM. 6063-T5	1	HANDICAP 1/2" BUMPER THRESHOLD	DESIGN HARDWARE
26	PS-V	ALUM. 6063-T5	AS REQ.D	PERIMETER SEAL- VINYL BULB	DESIGN HARDWARE
20	VLFIG-HRC	STEEL OR ST/ST	•	LITE KIT #1	ACTIVAR CONSTRUCTION PRODUCTS GROUP INC. (AIR LOUVERS/JL INDUSTRIES) 18
27			AS REQ.D		GA (0.048" MIN.) Fy=52.0 KSI MIN Fu=51.3 KSI MIN.
28	VLFEZ-HRC	STEEL OR ST/ST	AS REQ.D	LITE KIT #2	ACTIVAR CONSTRUCTION PRODUCTS GROUP INC. (AIR LOUVERS/JL INDUSTRIES) 20 GA (0.039" MIN.) Fy=43.4 KSI MIN Fu=58.0 KSI MIN.
29	SW-R	ALUM. 6063-T5	AS REQ.D	DOOR SWEEPS	DESIGN HARDWARE
30	-	-	AS REQ.D	WEATHER STRIP AT MEETING STILE ASTRAGAL - OPTIONAL	DESIGN HARDWARE
31	-	STEEL OR ST/ST	AS REQ.D	0.715" X 1.605" X 0.715 STEEL CHANNEL (DOOR PANEL WIDTH)	MESKER DOOR 20 GA (0.036" MIN) SINGLE ROW OF SPOT WELDS 2" O.C.
32	-	STEEL OR ST/ST	AS REQ.D	DOOR PANEL	MESKER DOOR 18 GA (0.048" MIN.) SPOT WELDED AT EACH END
33	DP-29	STEEL OR ST/ST	AS REQ.D	MORTISE LOCK REINFORCEMENT	MESKER DOOR 16 GA (0.060" MIN.) SPOT WELDED AT EACH END
34	DP-22	STEEL OR ST/ST	AS REQ.D	MORTISE LOCK (MBN) REINFORCEMENT	MESKER DOOR 14 GA (0.074" MIN.) SPOT WELDED TO EACH END
35	FP-9	STEEL OR ST/ST	AS REQ.D	"U" STRIKE MORTISE (ASA STRIKE)	MESKER DOOR 21 GA (0.032" MIN)
36	DP-23	STEEL OR ST/ST	AS REQ.D	CYLINDRICAL LOCK PREPARATION	MESKER DOOR 17 GA (0.054" MIN.) SPOT WELDED AT EACH END
37	-	STEEL OR ST/ST	AS REQ.D	SVR TOP STIKE	DESIGN HARDWARE
38	-	POLYSULFIDE	AS REQ.D	POLYSULFIDE SEAL 0.25" X 0.625"	-
39	-	PLASTIC	AS REQ.D	TPS-THERMO PLASTIC SPACER 0.3125" X 0.625"	KODISPACE

PRODUCT REVISED as complying with the Florida Building Code **NOA-No.** 20-0708.04

Expiration Date 07/16/2025

By Shang I. Chank
Miami-Dade Product Control





dormakaba USA Inc. 3440 Stanwood Blvd. Huntsville, AL 35811 PH: (256) 851-6670 FX: (800) 503-1410 BUILDING DROPS, INC. 398 E. DANIA BEACH BLVD. #338 DANIA BEACH, FL 33004 TITLE: N SERIES OUTSWING STEE GLAZED DOOR PREPARED BY: 12/15/20 DATE SM ВҮ REVISIONS 2020 FBC UPDATE DESCRIPTION Š ⋖ Tanana Y # PROF. DWN BY:
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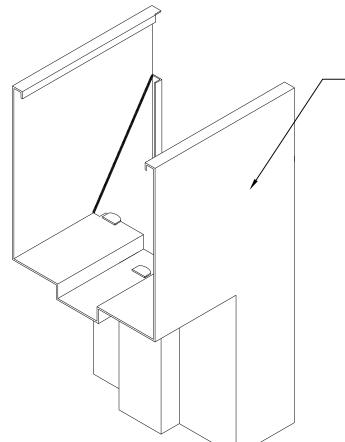
DWG #:

**DOR010** 

SHEET: 11 OF 12



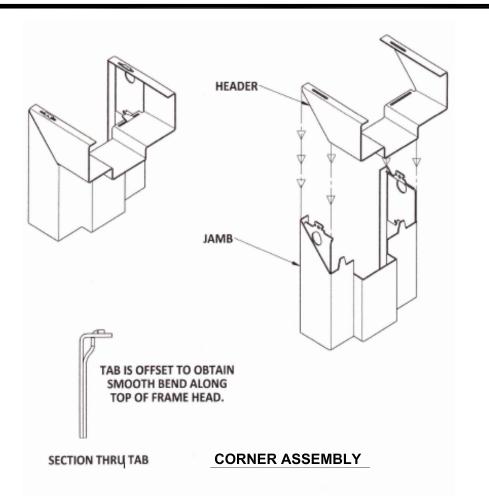

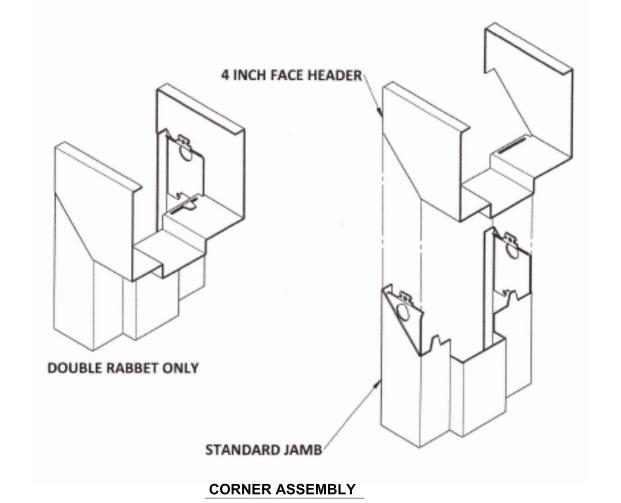

**CORNER ASSEMBLY** 

CONTINUOUS SPOT WELD FACE SEAM GRIND, SMOOTH, PRIME, AND PAINT

**CORNER ASSEMBLY** 

CONTINUOUS SPOT WELD FACE SEAM GRIND, SMOOTH, PRIME, AND PAINT

> PRODUCT REVISED
> as complying with the Florida
> Building Code **NOA-No.** 20-0708.04

Expiration Date 07/16/2025

By Shag I. Chank
Miami-Dade Product Control



MESKER DOOR a division of dormakaba USA Inc. 3440 Stanwood Blvd. Huntsville, AL 35811

PH: (256) 851-6670 FX: (800) 503-1410

BUILDING DROPS, INC. 398 E. DANIA BEACH BLVD. #338 DANIA BEACH, FL 33004

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ВҮ REVISIONS 2020 FBC UPDATE DESCRIPTION

Š No. 73778 ★ STATE OF CENSE.

CHK BY HFN SCALE: NTS

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