

## MIAMI-DADE COUNTY PRODUCT CONTROL SECTION

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www.miamidade.gov/economy

# DEPARTMENT OF REGULATORY AND ECONOMIC RESOURCES (RER) BOARD AND CODE ADMINISTRATION DIVISION

#### **NOTICE OF ACCEPTANCE (NOA)**

Ultimate Door of Palm Beach, Inc. 2800 2<sup>nd</sup> Avenue North Lake Worth, FL 33461

#### SCOPE:

This NOA is being issued under the applicable rules and regulations governing the use of construction materials. The documentation submitted has been reviewed and accepted by Miami-Dade County RER - Product Control Section to be used in Miami Dade County and other areas where allowed by the Authority Having Jurisdiction (AHJ).

This NOA shall not be valid after the expiration date stated below. The Miami-Dade County Product Control Section (In Miami-Dade County) and/ or the AHJ (in areas other than Miami-Dade County) reserve the right to have this product or material tested for quality assurance purposes. If this product or material fails to perform in the accepted manner, the manufacturer will incur the expense of such testing and the AHJ may immediately revoke, modify, or suspend the use of such product or material within their jurisdiction. RER reserves the right to revoke this acceptance, if it is determined by Miami-Dade County Product Control Section that this product or material fails to meet the requirements of the applicable building code.

This product is approved as described herein, and has been designed to comply with the Florida Building Code, including the High Velocity Hurricane Zone.

#### **DESCRIPTION:** Series "Direct Set" Aluminum Clad Wood Fixed Window – L.M.I.

**APPROVAL DOCUMENT:** Drawing No. **1749**, titled "Aluminum Clad Wood Impact Direct Glazed Fixed Window", sheets 1 through 5 of 5, dated 04/17/12, with revision A1 dated 11/30/16, prepared by W. W. Schaefer Engineering & Consultant, P.A., signed and sealed by Warren W. Schaefer, P.E., bearing the Miami-Dade County Product Control Revision stamp with the Notice of Acceptance number and expiration date by the Miami-Dade County Product Control Section.

### MISSILE IMPACT RATING: Large and Small Missile Impact Resistant

**LABELING:** Each unit shall bear a permanent label with the manufacturer's name or logo, city, state, series, and following statement: "Miami-Dade County Product Control Approved", unless otherwise noted herein

**RENEWAL** of this NOA shall be considered after a renewal application has been filed and there has been no change in the applicable building code negatively affecting the performance of this product.

**TERMINATION** of this NOA will occur after the expiration date or if there has been a revision or change in the materials, use, and/ or manufacture of the product or process. Misuse of this NOA as an endorsement of any product, for sales, advertising or any other purposes shall automatically terminate this NOA. Failure to comply with any section of this NOA shall be cause for termination and removal of NOA.

**ADVERTISEMENT:** The NOA number preceded by the words Miami-Dade County, Florida, and followed by the expiration date may be displayed in advertising literature. If any portion of the NOA is displayed, then it shall be done in its entirety.

**INSPECTION:** A copy of this entire NOA shall be provided to the user by the manufacturer or its distributors and shall be available for inspection at the job site at the request of the Building Official.

This NOA renews NOA No. 20-0623.18 and consists of this page 1 and evidence pages E-1, E-2 and E-3, as well as approval document mentioned above.

The submitted documentation was reviewed by Sifang Zhao, P.E.

MIAMI-DADE COUNTY
APPROVED

6.2.

12/16/2021

NOA No. 21-1013.03 Expiration Date: April 16, 2027 Approval Date: December 16, 2021

Page 1

#### Ultimate Door of Palm Beach, Inc.

#### NOTICE OF ACCEPTANCE: EVIDENCE SUBMITTED

#### 1. EVIDENCE SUBMITTED UNDER PREVIOUS NOA's

#### A. DRAWINGS

- 1. Manufacturer's die drawings and sections. (Submitted under NOA No. 12-0410.12)
- 2. Drawing No. 1749, titled "Aluminum Clad Wood Impact Direct Glazed Fixed Window", sheets 1 through 5 of 5, dated 04/17/12, with revision A1 dated 11/30/16, prepared by W.W. Schaefer Engineering & Consulting, P.A., signed and sealed by Warren W. Schaefer, P.E.

#### B. TESTS

- 1. Test reports on: 1) Air Infiltration Test, per FBC, TAS 202-94.
  - 2) Uniform Static Air Pressure Test Loading, per FBC, TAS 202-94.
  - 3) Water Resistance Test, per FBC, TAS 202-94.
  - 4) Large Missile Impact Test, per FBC, TAS 201-94.
  - 5) Cyclic Wind Pressure Loading, per FBC, TAS 203-94.

along with marked—up drawings and installation diagram of four (rectangular and curved-top) direct set wood fixed windows, and one rectangular mulled configuration, prepared by Architectural Testing, Test Report No. **B5667.01-450-18A**, dated 05/03/12, signed and sealed by Vinu J. Abraham, P.E.

(Submitted under NOA# 12-0410.12)

#### C. CALCULATIONS

- 1. Anchor verification calculations and structural analysis, complying with FBC-5<sup>th</sup> Edition (2014), dated 05/27/11 and updated on 11/30/16, prepared by W. W. Schaefer Engineering & Consultant, P.A., signed and sealed by Warren W. Schaefer, P.E.
- 2. Glazing complies with ASTM E1300-04

#### D. OUALITY ASSURANCE

1. Miami-Dade Department of Regulatory and Economic Resources (RER).

#### E. MATERIAL CERTIFICATIONS

1. Notice of Acceptance No. 14-0916.11 issued to Kuraray America, Inc. for their "SentryGlas® (Clear and White) Glass Interlayers" dated 06/25/15, expiring on 07/04/18.

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Sifang Zhao, P.E.
Product Control Examiner
NOA No. 21-1013.03
Expiration Date: April 16, 2027
Approval Date: December 16, 2021

#### **Ultimate Door of Palm Beach, Inc.**

#### NOTICE OF ACCEPTANCE: EVIDENCE SUBMITTED

#### F. STATEMENTS

- 1. Statement letter of conformance, complying with the FBC 5<sup>th</sup> Edition (2014) dated 11/30/16, with FBC 6<sup>th</sup> Edition (2017) dated 07/21/17 and with FBC 7<sup>th</sup> Edition (2020) dated 06/05/2020, issued by W. W. Schaefer Engineering & Consultant, P.A., signed and sealed by Warren W. Schaefer, P.E.
- 2. Statement letter of independence and of no financial interest, dated 11/30/16, 07/21/17 and 06/05/20, issued by W. W. Schaefer Engineering & Consultant, P.A., signed and sealed by Warren W. Schaefer, P.E.
- 3. Laboratory compliance letter for Test Report No. **B5667.01-450-18A**, issued by Architectural Testing, dated 05/03/12, signed and sealed by Vinu J. Abraham, P.E. (Submitted under NOA# 12-0410.12)

#### G. OTHERS

1. Notice of Acceptance No. 17-0803.04, issued to Ultimate Door of Palm Beach, Inc. for their Series "Direct Set" Aluminum Clad Wood Fixed Window – L.M.I., approved on 10/26/17 and expiring on 04/16/22.

#### 2. NEW EVIDENCE SUBMITTED

- A. DRAWINGS
  - 1. None.
- B. TESTS
  - 1. None.
- C. CALCULATIONS
  - 1. None.
- D. QUALITY ASSURANCE
  - 1. Miami-Dade Department of Regulatory and Economic Resources (RER).

#### E. MATERIAL CERTIFICATIONS

1. Notice of Acceptance No. 21-0324.06 issued to Kuraray America, Inc. for their "SentryGlas® Xtra<sup>TM</sup> (SGX<sup>TM</sup>) Clear Glass Interlayers" dated 06/03/2021, expiring on 05/23/2024.

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Sifang Zhao, P.E. Product Control Examiner NOA No. 21-1013.03 Expiration Date: April 16, 2027

Approval Date: December 16, 2021

#### Ultimate Door of Palm Beach, Inc.

#### NOTICE OF ACCEPTANCE: EVIDENCE SUBMITTED

#### F. STATEMENTS

- 1. Statement letter of conformance to **FBC** 7<sup>th</sup> **Edition (2020)** dated 10/06/2021, issued by W. W. Schaefer Engineering & Consultant, P.A., signed and sealed by Warren W. Schaefer, P.E.
- 2. Statement letter of independence and of no financial interest, dated 10/06/21, issued by W. W. Schaefer Engineering & Consultant, P.A., signed and sealed by Warren W. Schaefer, P.E.

#### G. OTHERS

1. This NOA renews NOA #20-0623.18, expiring on 04/16/2022.

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#### **GENERAL NOTES:**

 THIS PRODUCT HAS BEEN TESTED, ANALYZED & APPROVED FOR DESIGN PRESSURES NOT TO EXCEED THOSE SHOWN IN THE "ALLOWABLE DESIGN PRESSURE

2. OPENINGS, BUCKING & BUCKING FASTENERS MUST BE PROPERLY DESIGNED &

INSTALLED TO TRANSFER WIND LOADS TO THE STRUCTURE.

3. ALL HARDWARE & FASTENERS SHALL BE IN ACCORDANCE WITH THESE DRAWINGS & SHALL NOT VARY UNLESS SPECIFICALLY MENTIONED ON THE DRAWINGS. SPECIFIED ANCHOR EMBED TO BASE MATERIAL SHALL BE BEYOND WALL

4. THE DETAILS & SPECIFICATIONS SHOWN HEREIN REPRESENT THE PRODUCTS TESTED & PROPOSED FOR CONFORMANCE WITH THE FLORIDA BUILDING CODE PROTOCOLS TAS-201, 202 & 203 FOR LARGE MISSILE IMPACT PRODUCTS.

5. THIS PRODUCT HAS BEEN DESIGNED IN ACCORDANCE WITH AND MEETS THE REQUIREMENTS OF THE FLORIDA BUILDING CODE (FBC) INCLUDING HIGH VELOCITY HURRICANE ZONES (HVHZ).

6. IMPACT SHUTTERS ARE NOT REQUIRED WITH THIS PRODUCT.

7. ALL ANCHORS SECURING PRODUCT FRAMES TO PRESSURE TREATED BUCKS OR WOOD FRAMING SHALL BE CAPABLE OF RESISTING CORROSION CAUSED BY THE

PRESSURE TREATING CHEMICALS IN THE WOOD.

8. DETERMINE THE POSITIVE & NEGATIVE DESIGN LOADS TO USE WHEN REFERENCING THESE DOCUMENTS IN ACCORDANCE WITH THE GOVERNING CODE AND GOVERNING WIND VELOCITY. FOR WIND LOAD CALCULATIONS IN ACCORDANCE WITH THE FLORIDA BUILDING CODE, A DIRECTIONALITY FACTOR OF Kd = 0.85 MAY BE APPLIED PER THE ASCE-7 STANDARD.

9. NO INCREASE IN ALLOWABLE STRESS HAS BEEN USED IN THE CERTIFICATION OF THIS PRODUCT. WIND LOAD DURATION FACTOR Cd = 1.6 WAS USED FOR

WOOD SCREW ANALYSIS ONLY.

OPENING TYPE

(SUBSTRATE)

MIN. 2X4 WOOD FRAME OR BUCK

(MIN. GR. 3 & G=0.55)

MIN. 16 GA. 33 KSI METAL STUD

MIN. 1/8" THK A36 STEEL

MIN. 1/8" THK 6063-T5 ALUM.

MIN. C-90 CMU OR 2500 PSI CONCRETE

MIN. 2X4 WOOD FRAME OR BUCK

(MIN. GR. 3 & G=0.55)

MIN. 1/8" THK A36 STEEL

KWIK-CON II (C.S OR S.S.).

10. MATERIALS, INCLUDING BUT NOT LIMITED TO STEEL SCREWS, THAT COME INTO CONTACT WITH OTHER DISSIMILAR MATERIALS SHALL MEET THE REQUIREMENTS OF FLORIDA BUILDING CODE.

11. All WOOD MEMBERS OF THIS PRODUCT THAT MAY POSSIBLY COME INTO CONTACT WITH MASONRY OR CONCRETE SUBSTRATES, ARE SUBJECT TO MOISTURE &/OR ARE SUBJECT TO THE OUTSIDE ENVIRONMENT SHALL BE OF AN APPROVED DURABLE SPECIES OR BE TREATED IN AN APPROVED METHOD WITH AN APPROVED PRESERVATIVE PER FBC REQUIREMENTS.

FRAME ANCHOR REQUIREMENTS TABLE

FRAME SCREWS

NAILING FIN FASTENERS

FRAME/FIN TO OPENING FASTENER

TYPE

NO. 12 SMS OR WOOD SCREW

NO. 12 GR. 5 SELF TAP/DRILL SCREW

NO. 12 GR. 5 SELF TAP/DRILL SCREW

NO. 12 GR. 5 SELF TAP/DRILL SCREW


NO. 8 SMS SCREW

NO. 8 GR. 5 SELF TAP/DRILL SCREW

(1) 1/4" CONCRETE SCREW

#### CORNER CONSTRUCTION:

WOOD FRAME: MEMBERS ARE COPED, BUTTED AND JOINED WITH (1)ONE NO. 10 X 3 1/2" GALVANIZED WOOD SCREW THROUGH THE HORIZONTAL FRAME MEMBERS INTO THE VERTICAL MEMBERS & (2)TWO NO. 8 X 2 1/2" GALVANIZED WOOD SCREWS THROUGH THE VERTICAL MEMBER INTO THE HORIZONTAL MEMBERS. CORNERS SEALED WITH DOW 795. FRAME CLAD: MEMBERS ARE MITERED AND JOINED WITH (2)TWO NO. 6 X 2" SMS SCREWS INTO THE SCREW SPLINE. CORNERS ARE SEALED WITH DOW 795 SILICONE SEALANT.

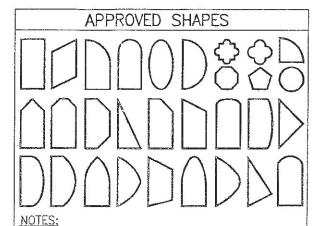

. OTHER SHAPES MAY APPLY PROVIDING THEY ARE SIMILAR TO

THOSE SHOWN & HAVE CORNER CONSTRUCTION AS DESCRIBED

ALLOWABLE PRESSURE OF THE RESPECTIVE RECTANGULAR UNIT.

2. ALL SHAPED UNITS MUST FIT INSCRIBED INTO THE

ALLOWABLE RECTANGULAR UNITS & BE GOVERNED BY THE

MAY BE 1/2" MIN. WHEN SCREW IS ANGLED INTO BUCK AS SHOWN IN SECTION A2/4.

**PRODUCT REVISED** as complying with the Florida **Building Code** NOA-No. 20-0623.18

Expiration Date: 04/16/2022

Miami-Dade Product Control

PRODUCT REVISED as complying with the Florida Building Code 17-0803.04 NOA-No.

Expiration Date 04/16/2022

Miami-Dade Product Control

**PRODUCT REVISED** as complying with the Florida Building Code NOA-No. 21-1013.03

Expiration Date 04/16/2027

Miami-Dade Product Control

PRODUCT REVISED

\* 833/1/1 44135 as complying with the Florida Acceptance No 16-1205.01 Expiration Date April 16, 2022

By Wantel Disparent Manual Date Product Control

THESE DRAWINGS ARE APPLICABLE ONLY TO THE PRODUCT DRAWN BY: SPECIFIED, THEY MAY NOT BE USED FOR THE ASSEMBLY WR.M.

AND/OR INSTALLATION OF ANY OTHER PRODUCT NOR MAY

THEY BE USED FOR RATIONAL AND/OR LOCAL APPROVAL

OF ANY PRODUCT NOT PRODUCED BY THE MANUFACTURES

R ENGINEERING P,A. (CA 6809) UNIT NORTH ENS, 133418 WOOD CLAD ALUMINUM SULTANTS

W. SCHAEFER

CONSULTING, P
7480 150TH COUR
PALM BEACH GARDENS
PHONE: S61-74-74 S ≥ 3 2016 NOV. 30 1749 SHEET NO. OF

04/17/12

1=24

S.

- PALM BEACH, AVE. NORTH H, FL 33461 42-2828

TE DOOR OF P. 2800 2ND AVI LAKE WORTH, 561-642-

ULTIMATE

WINDOW

FIXED

GLAZED

DIRECT

IMPACT

MIN. 1/8" THK 6063-T5 ALUM.	NO. 8 GR. 5 SELF TAP/DRILL SCREW	FULL	1/2"
(1) CONCRETE SCREWS SHALL BE ELCO U	ILTRACONS (C.S.), ELCO CRETE-FLEX (S.S.	S.) OR HIL	Tì

MINIMUM

EMBED

1 1/4"

FULL

FULL

FULL

1 1/4"

1 1/8"

FULL

MINIMUM

EDGE DIST

7/8"

1/2"

1/2"

1/2"

2"

1/2"

1/2"

#### SIZE/PRESSURE TABLE (GLASS OPTIONS 1 & 3) MAXIMUM MAXIMUM **ALLOWABLE** FRAME FRAME **PRESSURE** LONG SHORT (PSF) DIMENSION DIMENSION (IN.) (IN.)POS. NEG. 32 65.0 65.0 30 65.0 69.3 144 27 65.0 75.0 65.0 34 66.7 132 30 65.0 75.0 38 65.0 | 65.7 65.0 36 69.3 120 33 65.0 75.0 65.0 42 66.0 108 37 65.0 75.0 45 63.8 | 63.8 65.0 70.5 42 100 38 65.0 75.0 65.0 | 65.0 48 42 65.0 71.3 96 39 65.0 75.0 65.0 | 66.5 48 65.0 72.7 90 42 40 65.0 75.0 65.0 68.3 48 65.0 74.3 84 42 65.0 75.0 41 48 65.0 70.4 78 42 65.0 75.0 65.0 73.1 48 72 45 65.0 75.0 66 48 65.0 75.0

ALLOWABLE SINGLE WINDOW

1. WINDOW SIZES SHOWN ARE MAXIMUM SIZES. SMALLER SIZES SHALL APPLY TO LOADS EQUAL TO THE NEAREST LARGER SIZE SHOWN IN TABLE.

2. LONG DIMENSION MAY BE HORIZONTAL OR VERTICAL 3. DIMENSIONS SHOWN ARE

+/-1/2".

## ALLOWABLE SINGLE WINDOW SIZE/PRESSURE TABLE

(GLASS OPTIONS 2 & 4) MAXIMUM ALLOWABLE MAXIMUM FRAME **PRESSURE** FRAME LONG SHORT (PSF) DIMENSION DIMENSION **GLASS** (IN.) (IN.) **OPTIONS** 2 & 4 POS. NEG. 50 75.0 | 75.0 144 44 75.0 85.0 54 1/2 75.0 75.0 132 48 75.0 | 85.0 60 75.0 75.0 120 52 75.0 85.0 75.0 75.0 66 3/4 108 52 75.0 85.0 72 75.0 75.0 100 52 75.0 B5.0 WINDOW SIZES SHOWN ARE

MAXIMUM SIZES. SMALLER

2. LONG DIMENSION MAY BE

SIZE SHOWN IN TABLE.

HORIZONTAL OR VERTICAL

SIZES SHALL APPLY TO LOADS

EQUAL TO THE NEAREST LARGER

CONSTRUCTION TABLES ON THIS SHEET DESCRIPTIONS  $\binom{A1}{4}$ ON SHEET 1 SEE SINGLE THIS SHEET #6); (ITEM #7) A1 4 D.L.O. = FRAME HEIGHT - 5 SMALL GLAZING BEAD (ITEM # " FOR LARGE GLAZING BEAD ( FIN FASTENER WITHIN 3" DIMENSION, STABLES ON OF CORNERS & 9" MAX. O.C. SEE "FRAME ANCHOR REQUIREMENTS TABLE" ON THIS SHEET FOR REQUIREMENTS. MAX. D.LO. = FRAME WIDTH - 5 1/4" FOR SMALL GLAZING BEAD (ITEM #6); - 6 1/4" FOR LARGE GLAZING BEAD Ø (ITEM #7)

SEE CORNER

FOR MAX. FRAME SHORT

DIMENSION, SEE SINGLE

WINDOW SIZE/PRESSURE

EXTERIOR ELEVATION:

SINGLE FIXED WINDOW

SCALE: 1/2" = 1'-0"

(NAIL FIN MOUNT CONDITION)

SIMILAR

 $\begin{pmatrix} A1\\ 4 \end{pmatrix}$ 

DIMENSION, SEE SINGLE WINDOW SIZE/PRESSURE TABLES ON THIS SHEET 4 V 6" MAX. SINGLE #7) #6); (ITEM 4 SEE S THIS = FRAME HEIGHT - 5 1 L GLAZING BEAD (ITEM #1 LARGE GLAZING BEAD (IT -FRAME SCREWS WHERE SIDES) SHOWN. SEE "FRAME ANCHOR REQUIREMENTS TABLE" ON THIS SHEET (ALL FOR REQUIREMENTS. 0.C. FOR MAX, FRAME LONG WINDOW SIZE/PRESSURE MAX. D.L.O. = FRAME D,L,O, = WIDTH - 5 1/4" FOR SMALL GLAZING ຳດ BEAD (ITEM #6); - 6 1/4" FOR LARGE GLAZING BEAD 9 (ITEM #7) 6" MAX. 6" 6" MAX. MAX. EXTERIOR ELEVATION: SINGLE FIXED WINDOW SCALE: 1/2" = 1'-0"ALUMINUM (FRAME SCREW MOUNT CONDITION)

FOR MAX. FRAME SHORT

RECTANGULAR WINDOWS SHOWN. SHAPED WINDOWS ALSO APPLY, SEE "APPROVED SHAPES TABLE ON SHEET 1". ANCHORING OF SHAPED WINDOWS IS THE SAME WITH REQUIRED ANCHOR SPACING ALONG THE FRAME CIRCUMFERENCE BEING THE SAME AS SPECIFIED FOR A STRAIGHT FRAME.

PRODUCT REVISED

Building Code

as complying with the First a

**PRODUCT REVISED** as complying with the Florida Building Code NOA-No. <u>21-1013.03</u>

Miami-Dade Product Control

**PRODUCT REVISED** as complying with the Florida Building Code NOA-No. 20-0623.18

Expiration Date: 04/16/2022

By: Manuel Peres Miami-Dade Product Control

**PRODUCT REVISED** as complying with the Florida Building Code 17-0803.04 NOA-No.

Expiration Date 04/16/2022

Miami-Dade Product Control

STATE STATE OF THE 9 Acceptance No 16-1205.01 Expiration Date April 16,2022

2016 SCHAEFER NO. 44135 00 DRAWING NO. 1749

04/17/12

1=24

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TE DOOR OF PALM BEACH, II 2800 2ND AVE, NORTH LAKE WORTH, FL 33461 561-642-2828

WINDOW

FIXED

GLAZED

DIRECT

IMPACT

MOOD

CLAD

FACTUREN ULTIMATE

R. CA 6809)
P.A. (CA 6809)
DURI NORTH
ENS. FL 33418

W. SCHAEFER
CONSULTING, P
7480 150TH COUR
PALM BEACH CARDENS
PHONE: 561-744


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SHEET NO. 2 of

Expiration Date 04/16/2027

MULLION ALLOWABLE					
DESIG	DESIGN PRESSURE				
MAXIMUM	MAXIMUM		WABLE SURE		
MULLION SPAN	LOAD WIDTH		SF)		
(IN.)	(IN.)	POS.	<del></del>		
()	60	45.5	45.5		
120	54	49.8	49.8		
	48	55.0	55.0		
	42	62.2	62.2		
	40	65.0	65.0		
	36	65.0	70.8		
	33	3200000 70	75.0		
		65.0 52.5			
	66		52.5 55.6		
	60	55.6	1		
108	54	59.4	59.4		
	48	64.5	64.5		
	42	65.0	71.2		
	. 39	65.0	75.0		
102	70	55.4	55.4		
	66	57.1	57.1		
	60	60.2	60.2		
	54	64.2	64.2		
	48	65.0	69.4		
	43	65.0	75.0		
	72	60.2	60.2		
96	66	62.5	62.5		
	60	65.0	65.7		
	54	65.0	69.8		
	48	65.0	75.0		
90	72	65.0	66.9		
	66	65.0	69.1		
	60	65.0	72.2		
	55	65.0	75.0		
84	72	65.0	75.0		
NOTES:					
1. SEE ELEVATIONS FOR DIMENSIONING OF LOAD WIDTH, 2. ALLOWABLE UNIT PRESSURE					
SHALL BE THE LESSER OF THE					

PRESSURE SHOWN IN THIS TABLE & THAT SPECIFIED FOR THE INDIVIDUAL WINDOW

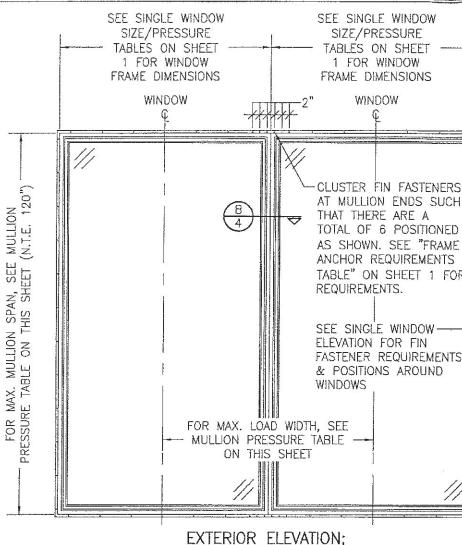

MULTIPLE FIXED WINDOWS

SCALE: 1/2" = 1'-0"

(NAIL FIN MOUNT CONDITION)

AT MULLION ENDS SUCH TOTAL OF 6 POSITIONED AS SHOWN. SEE "FRAME ANCHOR REQUIREMENTS TABLE" ON SHEET 1 FOR FASTENER REQUIREMENTS & POSITIONS AROUND

SEE SINGLE WINDOW SEE SINGLE WINDOW SIZE/PRESSURE SIZE/PRESSURE TABLES ON SHEET TABLES ON SHEET 1 FOR WINDOW 1 FOR WINDOW FRAME DIMENSIONS FRAME DIMENSIONS WINDOW WINDOW MULLION (N.T.E. 120") ADDITIONAL FRAME SCREWS WHERE SHOWN AT MULLION ENDS. SEE "FRAME ANCHOR REQUIREMENTS TABLE" ON SHEET 1 FOR N SPAN, SEE THIS SHEET REQUIREMENTS. NOTE: OUTERMOST ANCHOR AT EACH SIDE IS NOT SEE SINGLE WINDOW REQUIRED WHEN LOAD ELEVATION FOR FRAME WIDTH IS 35" OR LESS ANCHOR REQUIREMENTS FOR MAX. MULLION PRESSURE TABLE ON T & POSITIONS AROUND WINDOWS FOR MAX. LOAD WIDTH, SEE MULLION PRESSURE TABLE ON THIS SHEET AAA AAA

## EXTERIOR ELEVATION: MULTIPLE FIXED WINDOWS

SCALE: 1/2" = 1'-0"(FRAME SCREW MOUNT CONDITION)

### MULTIPLE UNIT NOTES:

- 1. FOR ALL DETAIL NOT SHOWN, SEE SINGLE WINDOW ELEVATIONS.
- 2. MULLION MAY BE HORIZONTAL OR VERTICAL PROVIDING UNIT SIZES ARE RESTRICTED AS SHOWN IN THIS ELEVATION.
- 3. WINDOWS MAY BE STACKED HORIZONTAL OR VERTICAL. TO INSURE THAT THE DEAD WEIGHT OF THE ABOVE WINDOW(S) WILL NOT CAUSE UNDO STRESS ON THE BELOW WINDOW, WHEN VERTICALLY STACKED, THE MANUFACTURER/INSTALLER SHALL LIMIT THE SAG OF THE HORIZONTAL MULLION TO MAX. 1/8".
- 4. THERE IS NO LIMIT ON THE NUMBER OF WINDOWS THAT MAY BE COMBINED IN ONE DIRECTION INTO ONE OPENING PROVIDING THE OPENING IS DESIGNED TO SUPPORT ALL LOADS TRANSFERRED FROM THE WINDOWS & THEIR MULLIONS.
- 5. INDIVIDUAL WINDOW SIZES SHALL BE RESTRICTED AS SPECIFIED IN THE SINGLE WINDOW ELEVATIONS. 6. RECTANGULAR WINDOWS SHOWN. SHAPED WINDOWS ALSO APPLY UNDER THE SAME CONDITIONS SHOWN

FOR RECTANGULAR.

**PRODUCT REVISED** as complying with the Florida Building Code NOA-No. 20-0623.18

**Expiration Date: 04/16/2022** 

By: Manuel Peres Miami-Dade Product Control PRODUCT REVISED as complying with the Florida **Building Code** 17-0803.04 NOA-No.

Expiration Date 04/16/2022

Miami-Dade Product Control

Building Code
Asceptioned No. 16-1205.01
Expiration Date April 16, 2022

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ULTIMATE DOOR OF PALM BEACH, 2800 2ND AVE. NORTH LAKE WORTH, FL 33461 561-642-2828 IMPACT P.A. (CA 6809) WOOD CLAD SCHAEFER
W. SCHAEFER
CONSULTING, P ALUMINUM PALM \$ **₹** 8 28-18 9 SSO. NOV DRAWING NO. 1749 Α

SHEET NO.

3 OF

CHECKED BY

DATE: 04/17/12

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WINDOW

FIXED

GLAZED

DIRECT

Expiration Date 04/16/2027 Miami-Dade Product Control


**PRODUCT REVISED** 

as complying with the Florida Building Code

NOA-No. 21-1013.03


PRODUCT REVISED as complying with the Florida Building Code

By Waruel Deroz Miami Dade Product Contro

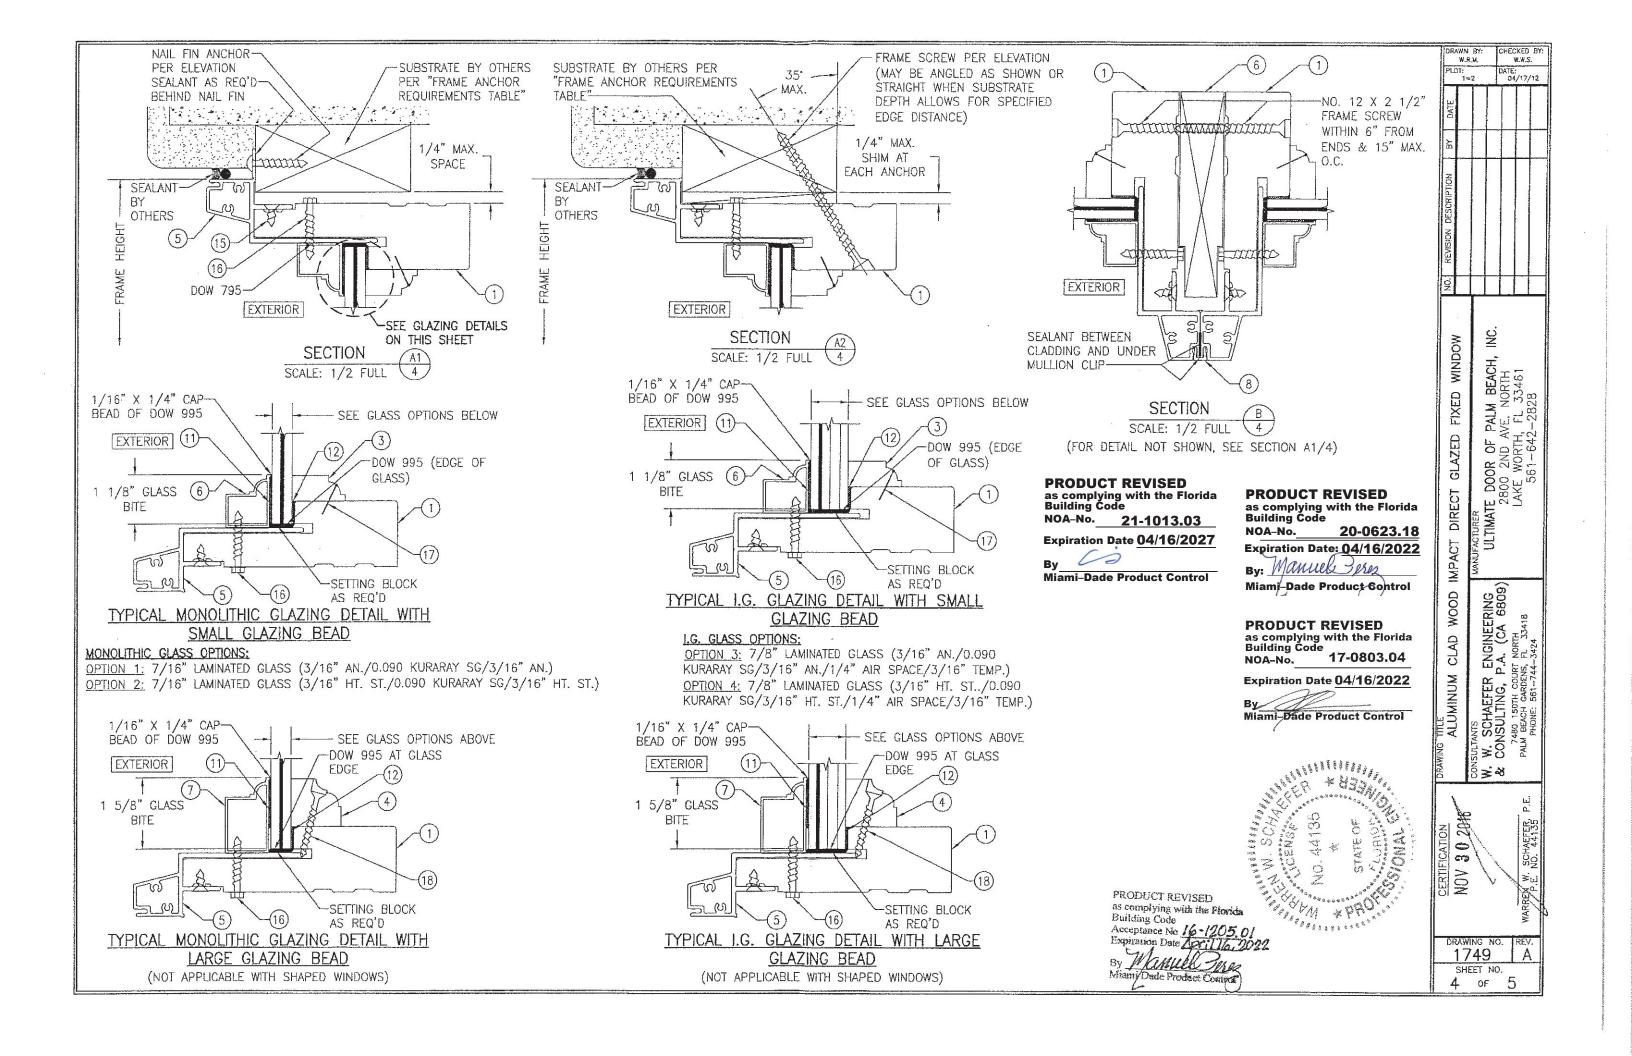

ITEM #	ITEM DESCRIPTION	MANUFACTURER/NOTES		
PARTS				
1	JAMB	WOOD		
2	MULLION	WOOD		
3	INTERIOR SMALL GLAZING BEAD	WOOD		
4	INTERIOR LARGE GLAZING BEAD	WOOD		
5	JAMB CLADDING	6063-T5 ALUMINUM		
6	EXTERIOR SMALL GLAZING BEAD	6063-T5 ALUMINUM		
7	EXTERIOR LARGE GLAZING BEAD	6063-T5 ALUMINUM		
8	MULLION CLIP	6063-T5 ALUMINUM		
SEALS & SEALANTS				
11	GLAZING TAPE 1/16" X 7/8"	SAINT GOBIAN V2862		
12	GLAZING TAPE 1/16" X 1/2"	SAINT GOBIAN V2862		
. FASTENERS				
15	NO. 6 X 3/4" SMS	WITHN 2" FROM CORNERS & 12" MAX. O.C.		
16	NO. 10 X 1 1/4" HEX HEAD TEK SCREW	WITHN 2" FROM ENDS & 9" MAX. O.C.		
17	18 GA. X 3/4" BRAD NAIL	WITHIN 2" FROM CORNERS & 9" MAX. O.C.		
18	NO. 7 X 1 5/8" TRIM SCREW	WITHIN 2" FROM CORNERS & 9" MAX. O.C.		

NOTE: WOOD USED IN TESTING WAS PONDEROSA PINE WITH A SPECIFIC GRAVITY OF G = 0.43 AND A MODULUS OF ELASTICITY OF E = 1,200,000 PSI. OTHER WOOD SPECIES APPLICABLE FOR USE WITH THIS PRODUCT ARE THOSE WITH A SPECIFIC GRAVITY OF 0.43 AND MODULUS OF ELASTICITY OF 1,200,000 PSI OR GREATER. ALL WOOD IS MINIMUM GRADE 2 MILLED BY ULTIMATE DOOR TO SELECT.

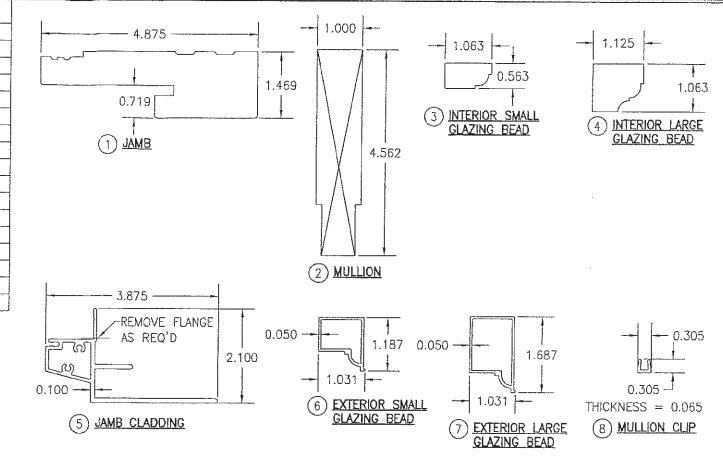

PRODUCT REVISED
as complying with the Florida
Building Code
NOA-No. 21-1013.03

Expiration Date <u>04/16/2027</u>

Miami-Dade Product Control

PRODUCT REVISED
as complying with the Florida
Building Code
NOA-No. 20-0623.18

Expiration Date: 04/16/2022

By: Manuel Pres

Miami-Dade Product Control

PRODUCT REVISED
as complying with the Florida
Building Code
NOA-No. 17-0803.04

Expiration Date 04/16/2022

Miami-Dade Product Control

PRODUCT REVISED
as complying with the Finrida
Building Code
Acceptance No 16-1205.01
Expiration Date Sprille, 7022
By Manuel July

Mianti Dade Product Contr

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CERTIFICATION

CERTIFICATION

CONSULTANTS

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W. W. SCHAEFER ENGINEERING

& CONSULTING, P.A. (CA 6809)

TARO 150TH COURT

WARREN W. SCHAEFER, P.E. PALM BEACH CARBENS, FL. 33418

PHONE: 561-744-3424

CHECKED BY:

ULTIMATE DOOR OF PALM BEACH, INC. 2800 2ND AVE. NORTH LAKE WORTH, FL 33461 561-642-2828

IMPACT DIRECT GLAZED FIXED WINDOW